

SITE PLAN 100 DUCHAINE BOULEVARD ASSESSORS MAP #134 LOT #5 NEW BEDFORD, MASSACHUSETTS

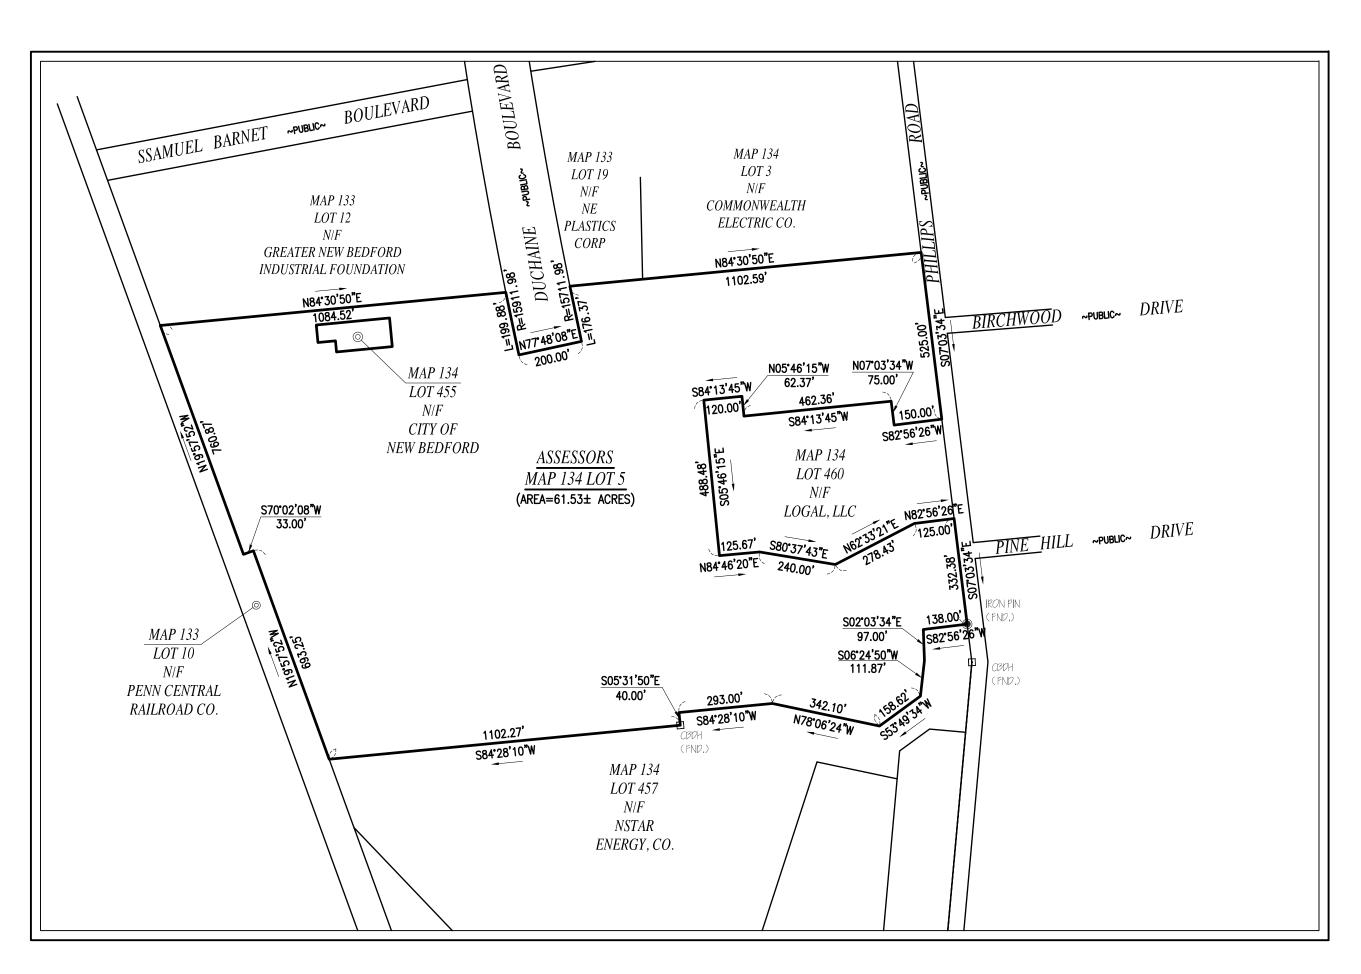

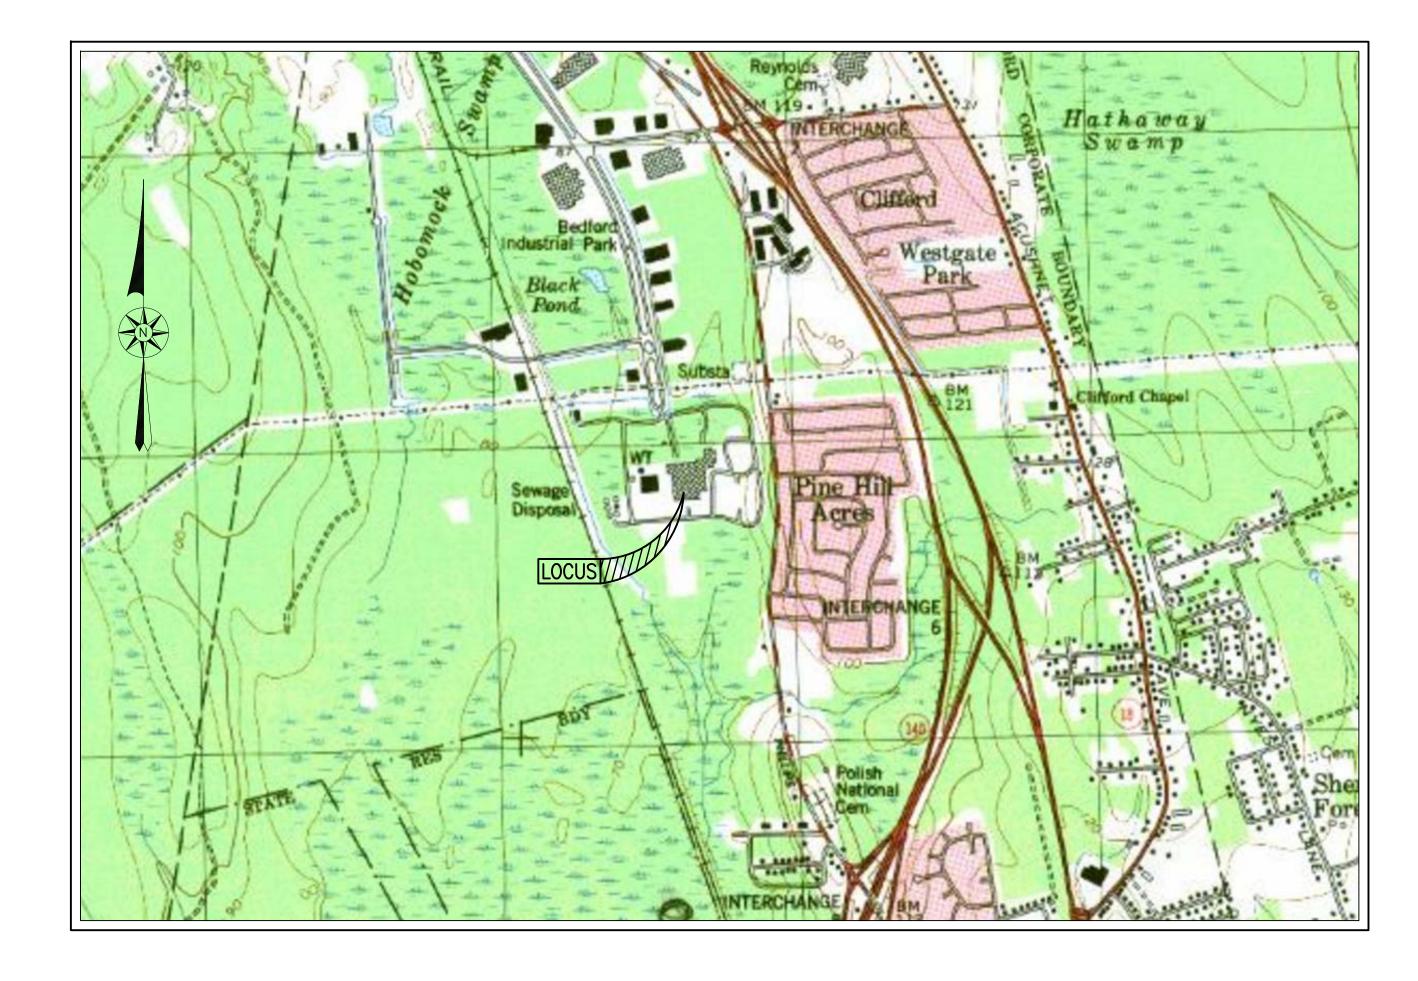

— OVERALL SITE MAP — SCALE: 1"=300"

_	ZONING DATA	A —		
<u>DISTRICT:</u> INDUSTRIAL C				
<u>DESCRIPTION</u>	<u>REQUIR</u>	<u>EXISTING</u>	<u>PROVIDED</u>	
LOT AREA	0	S.F. 65.1± AC	65.1± AC	
LOT FRONTAGE	0	FT 576.17 FT	576.17 FT	
FRONT SETBACK	25	FT 843,6± FT	843.6± FT	
SIDE SETBACK	25	FT 192,3± FT	1923± FT	
REAR SETBACK	25	FT 828,9± FT	828,9± FT	
BUILDING HEIGHT (MAXIMUM)	100	FT <100 F1	<100 FT	
BUILDING COVERAGE (MAXIMUM)	50	% 3,4± %	3.8± %	
LOT COVERAGE (MAXIMUM)	80	% <50 %	<50 %	
- PARKING & LOADING REQUIREMENTS - PRINCIPAL USE: RECYCLING FACILITY				
(FOR PARKING REGULATION PURPOSES: BUSINESS ENGAGED IN WAREHOUSING & DISTRIBUTION)				

1 SPACE PER 1,500 S.F. OF G.F.A. UP TO 15,000 S.F.
THEREAFTER, ONE ADDITIONAL SPACE FOR EACH 5,000 S.F. OR
PORTION THEREOF IN EXCESS OF 15,000 S.F., PLUS ONE SPACE
FOR EACH VEHICLE UTILIZED IN THE BUSINESS.

WHEN 26-50 TOTAL PARKING SPACES ARE PROVIDED, 2 MUST BE
ACCESSIBLE SPACES. ONE IN EVERY EIGHT ACCESSIBLE SPACES,
BUT NOT LESS THAN ONE, SHALL BE VAN ACCESSIBLE

142 TOTAL
PARKING
SPACES
SPACES

2 TOTAL
SPACES
(1 VAN)

TWO (2) LOADING SPACES FOR EACH BUILDING CONTAINING 10,000 S.F. OF GROSS FLOOR AREA. THEREAFTER, ONE (1) ADDITIONAL LOADING SPACE SHALL BE REQUIRED FOR EACH FIFTEEN (15) FEET OF DOCK, PLATFORM, OR OPENING IN THE BUILDING WHERE THE LOADING OR UNLOADING OF COMMODITIES IS INTENDED TO OCCUR.

REQUIREMENT

17 LOADING 20 LOADING SPACES SPACES

<u>PROVIDED</u>

—AREA MAP—

SCALE: 1"=1,000'±

- IN DEX
SHEET DESCRIPTION

1 COVER

2 NOTES & LEGEND

3 EXISTING CONDITIONS

4 LAYOUT

- IN DEX
SHEET DESCRIPTION

5 UTILITIES & GRADING

6 LIGHTING

7-8 DETAILS

9-10 ARCHITECTURALS

RECORD OWNER:
ASSESSORS MAP 134 LOT 5
SM REAL ESTATE, LLC
401 INDUSTRY ROAD
LOUISVILLE, KY 40208
LC CERT# 23339
LC PLAN# 36318C

WAIVERS REQUESTED

<u>CODE OF ORDINANCES - CH. 9 COMPREHENSIVE ZONING</u>

1. SECTION 5350 - DEVELOPMENT IMPACT STATEMENT

SITE PLAN REVIEW CHECKLIST

SECTION 3G. LANDSCAPE PLAN
 SECTION 8. TRAFFIC IMPACT & ACCESS STUDY

REVISIONS

/17 | CONSERVATION COMMENT:

CHRISTIAN
ALBERT
FARLAND
No. 47544
CIVIL



01 COUNTY STREET EW BEDFORD, MA 0274 508.717.3479 FFICES IN: TAUNTON

DRAWN BY: MJW

DESIGNED BY: JKM

CHECKED BY: CAE

CHAINE BOULEVARD ——ORS MAP 134 LOT 5
FORD, MASSACHUSETTS

PREPARED FOR:

AUGUST 10, 2017

SCALE: AS NOTED

JOB NO. 15-500.2

LATEST REVISION:

OCTOBER 23, 2017

COVER

SHEET 1 OF 10

GENERAL CONSTRUCTION NOTES

THE PROPOSED IMPROVEMENTS SHOWN ON THE PLAN.

- 1. THE CONTRACTOR IS SPECIFICALLY CAUTIONED THAT THE LOCATION AND/OR ELEVATION OF EXISTING UTILITIES AND STRUCTURES AS SHOWN ON THESE PLANS IS BASED ON RECORDS OF VARIOUS UTILITY COMPANIES AND WHERE POSSIBLE, MEASUREMENTS TAKEN IN THE FIELD. THIS INFORMATION IS NOT TO BE RELIED ON AS BEING EXACT OR COMPLETE. THE LOCATION OF ALL UNDERGROUND UTILITIES AND STRUCTURES SHALL BE VERIFIED IN THE FIELD BY THE CONTRACTOR PRIOR TO THE START OF CONSTRUCTION. THE CONTRACTOR MUST CONTACT THE APPROPRIATE UTILITY COMPANY. ANY GOVERNING PERMITTING AUTHORITY. AND "DIG SAFE" AT LEAST 72 HOURS PRIOR TO ANY EXCAVATION WORK TO REQUEST EXACT FIELD LOCATION OF UTILITIES INTERFERING WITH THE PROPOSED CONSTRUCTION AND APPROPRIATE REMEDIAL ACTION TAKEN BEFORE PROCEEDING WITH THE WORK. IT SHALL BE THE RESPONSIBILITY OF THE CONTRACTOR TO RELOCATE ALL EXISTING UTILITIES WHICH CONFLICT WITH
- TOPOGRAPHIC AND PROPERTY LINE SURVEY PERFORMED BY FARLAND CORP. IN SEPTEMBER OF 2015.
- 3. VERTICAL ELEVATIONS REFER TO THE NORTH AMERICAN VERTICAL DATUM (NAVD) OF 1988 AND HORIZONTAL LOCATIONS REFER TO THE NORTH AMERICAN DATUM (NAD) OF 1983.
- 4. ALL CONSTRUCTION SHALL BE IN ACCORDANCE WITH ALL APPLICABLE STATE AND LOCAL STANDARDS AND
- 5. THE CONTRACTOR SHALL BE RESPONSIBLE FOR ESTABLISHING AND MAINTAINING ALL CONTROL POINTS AND BENCH
- MARKS NECESSARY FOR THE WORK. 6. ALL BENCHMARKS SHOWN ON THIS PLAN ARE TO BE CHECKED FOR CONSISTENCY BY THE CONTRACTOR. ANY
- DISCREPANCIES MUST BE RESOLVED BY THIS OFFICE PRIOR TO CONSTRUCTION. 7. WHERE PROPOSED PAVEMENT AND WALKS ARE TO MEET EXISTING. THE CONTRACTOR SHALL SAWCUT A NEAT LINE
- AND MATCH GRADE. SEAL ALL JOINTS WITH HOT BITUMINOUS ASPHALT JOINT SEALER. 8. CURBING TO BE AS INDICATED ON THE PLANS.
- 9. ALL EXISTING TREES. SHRUBS AND GROUND COVER WHERE NATURAL GRADE IS TO BE RETAINED SHALL BE KEPT IN THEIR EXISTING STATE UNLESS REMOVAL IS REQUIRED FOR CONSTRUCTION PURPOSES.
- 10. ALL AREAS DISTURBED BY CONSTRUCTION AND NOT TO BE PAVED OR OTHERWISE TREATED AS NOTED ON PLAN
- SHALL BE TREATED WITH 4" OF LOAM, SEEDED AND HAY MULCHED FOR EROSION CONTROL 11. SITE IMPROVEMENTS SHALL CONFORM TO A.D.A. SPECIFICATIONS.
- 12. ALL HANDICAP PARKING, RAMPS AND ACCESS SHALL CONFORM TO AAB & MAAB REQUIREMENTS.
- 13. ALL PAVEMENT MARKINGS AND SIGNS SHALL CONFORM TO MUTCD REQUIREMENTS. LIGHTING SHALL BE DIRECTED ON SITE AND AWAY FROM TRAFFIC INTERFERENCE.
- 15. TEST PITS AND/OR BORINGS WERE TAKEN FOR THE PURPOSE OF DESIGN AND SHOW CONDITIONS AT BORING POINTS ONLY. THEY DO NOT NECESSARILY SHOW THE NATURE OF ALL MATERIALS TO BE ENCOUNTERED DURING
- 16. THE CONTRACTOR SHALL PROTECT AND/OR CAP OFF ALL EXISTING ON-SITE UTILITY SERVICES ACCORDING TO THE LOCAL AUTHORITY'S SPECIFICATIONS. SERVICES SHALL BE CAPPED OFF WHERE SAME ENTER THE PERIMETER OF
- THE PROPERTY LINE. 17. ANY WORK AND MATERIAL WITHIN THE CITY RIGHT-OF-WAY SHALL CONFORM TO THE CITY OF NEW BEDFORD
- REQUIREMENTS. 18. CONTRACTOR SHALL THOROUGHLY FAMILIARIZE THEMSELVES WITH ALL CONSTRUCTION DOCUMENTS, SPECIFICATIONS
- AND SITE CONDITIONS PRIOR TO BIDDING AND PRIOR TO CONSTRUCTION. 19. ANY DISCREPANCIES BETWEEN DRAWINGS, SPECIFICATIONS AND SITE CONDITIONS SHALL BE REPORTED IMMEDIATELY
- TO THE OWNER'S REPRESENTATIVE FOR CLARIFICATION AND RESOLUTION PRIOR TO BIDDING OR CONSTRUCTION. 20. ANY MINOR MODIFICATIONS (AS DETERMINED BY THE CITY ENGINEER) TO THE INFORMATION SHOWN ON THE APPROVED SITE PLANS SHALL BE SUBMITTED TO THE CITY ENGINEER AS A MINOR PLAN REVISION FOR APPROVAL
- PRIOR TO THE WORK BEING PERFORMED. 21. THESE PLANS ARE PERMITTING PLANS AND SHALL NOT TO BE USED FOR CONSTRUCTION. A FINAL SET OF STAMPED PLANS FOR CONSTRUCTION WILL BE ISSUED AFTER RECEIVING FINAL APPROVAL FROM THE LOCAL AND/OR STATE DEPARTMENTS.

CONSTRUCTION SEQUENCING NOTES

CONSTRUCTION.

- ALL BMP EROSION CONTROL MEASURES SHALL BE IN PLACE PRIOR TO DEMOLITION OR ANY SITE WORK.
- 2. EROSION CONTROL BMPS SHALL CONFORM TO US EPA, NPDES, MA DEP AND MASSACHUSETTS EROSION AND
- SEDIMENTATION CONTROL GUIDELINES FOR URBAN AND SUBURBAN AREAS.
- 3. CONSTRUCT TEMPORARY AND PERMANENT EROSION CONTROL FACILITIES. EROSION CONTROL FACILITIES SHALL BE INSTALLED PRIOR TO ANY EARTH MOVING.
- 4. ALL EROSION CONTROL MEASURES SHALL BE IN PLACE PRIOR TO CONSTRUCTION. EROSION CONTROL SHALL CONFORM TO THE CITY OF NEW BEDFORD CONSERVATION COMMISSION REQUIREMENTS AS STATED IN THE ORDER
- 5. TREE PROTECTION FENCE SHALL BE INSTALLED AND APPROVED BY THE OWNER REPRESENTATIVE PRIOR TO ANY FARTH MOVING.
- 6. ALL PERMANENT DITCHES AND SWALES ARE TO BE STABILIZED WITH VEGETATION OR RIP RAP PRIOR TO DIRECTING
- 7. CLEAR CUT, DEMOLISH AND DISPOSE OF EXISTING SITE ELEMENTS NOT TO REMAIN.
- 8. STORMWATER SHALL NOT BE DIRECTED TOWARDS THE INFILTRATION BASINS UNTIL THE ENTIRE CONTRIBUTING DRAINAGE AREA HAS BEEN STABILIZED.
- 9. GRADE AND GRAVEL ALL PAVED AREAS. ALL PROPOSED PAVED AREAS SHALL BE STABILIZED IMMEDIATELY AFTER
- 10. BEGIN ALL PERMANENT AND TEMPORARY SEEDING AND MULCHING. ALL CUT AND FILL SLOPES SHALL BE SEEDED
- AND MULCHED IMMEDIATELY AFTER THEIR CONSTRUCTION. 11. DAILY, OR AS REQUIRED, CONSTRUCT TEMPORARY BERMS, DRAINS, DITCHES, SILT FENCES AND MULCH AND SEED
- 12. FINISH PAVING ALL HARD SURFACE AREAS.
- 13. INSPECT AND MAINTAIN ALL EROSION AND SEDIMENT CONTROL MEASURES.
- 14. COMPLETE PERMANENT SEEDING AND LANDSCAPING.
- 15. REMOVE TEMPORARY EROSION CONTROL MEASURES.
- 16. THE CONSTRUCTION SEQUENCE SHALL BE CONFINED TO THE LIMIT OF WORK AS SHOWN ON THE DRAWINGS.

18. MAINTENANCE SPECIFICATIONS SHALL BE PROVIDED FOR ALL PROPOSED EROSION AND SEDIMENTATION CONTROLS.

17. UPON COMPLETION OF CONSTRUCTION THE OWNER SHALL AGREE TO MAINTAIN AND CLEAN ALL DRAINAGE

UTILITY AND GRADING NOTES

- 1. THE CONTRACTOR SHALL OBTAIN A STREET DISTURBANCE AND OBSTRUCTION PERMIT PRIOR TO ANY CONSTRUCTION WITHIN THE RIGHT-OF-WAY.
- ALL WATER AND SEWER MATERIAL AND CONSTRUCTION SHALL CONFORM TO THE CITY OF NEW BEDFORD REQUIREMENTS.
- 3. ALL WATER AND SEWER CONSTRUCTION SHALL BE INSPECTED BY THE CITY OF NEW BEDFORD BEFORE BEING BACKFILLED.
- 4. THE CITY SHALL BE NOTIFIED AT LEAST 24 HOURS PRIOR TO THE REQUIRED INSPECTIONS. ALL ON-SITE STORM DRAINAGE PIPES SHALL BE HIGH DENSITY POLYETHYLENE PIPE (HDPE) OR RCP, UNLESS NOTED OTHERWISE.
- HDPE PIPE SHALL CONFORM WITH AASHTO DESIGNATIONS M294 AND M252, SHALL BE MANUFACTURED WITH HIGH DENSITY POLYETHYLENE PLASTIC AND SHALL BE ADS N-12 PIPE AS MANUFACTURED BY ADVANCE DRAINAGE SYSTEM, INC. OR HANCOR HI Q PIPE AS MANUFACTURED BY HANCOR, INC. OR APPROVED EQUAL UNLESS OTHERWISE NOTED OR DETAILED.
- 7. A MINIMUM OF 18" VERTICAL CLEARANCE SHALL BE MAINTAINED WHERE WATER SERVICES CROSS STORM DRAIN
- ALL SERVICE CONNECTIONS SHALL BE INSTALLED TO A POINT OF 10 FEET FROM THE BUILDING WALL UNLESS OTHERWISE NOTED OR DETAILED.
- BEFORE THE DEVELOPMENT SITE IS GRADED, THE AREA OF THE DRAINAGE BASINS SHOULD BE FENCED OFF TO PREVENT HEAVY EQUIPMENT FROM COMPACTING THE UNDERLYING SOIL.
- 10. WHERE PROPOSED GRADES MEET EXISTING GRADES, CONTRACTOR SHALL BLEND GRADES TO PROVIDE A SMOOTH TRANSITION BETWEEN EXISTING AND NEW WORK. PONDING AT TRANSITION AREAS WILL NOT BE ALLOWED. CONTRACTOR SHALL MAINTAIN POSITIVE DRAINAGE AWAY FROM ALL BUILDING FOUNDATIONS AND STRUCTURES.
- 12. MAXIMUM SLOPE IN DISTURBED AREAS SHALL NOT EXCEED 3:1, UNLESS OTHERWISE NOTED.
- 13. CONTRACTOR SHALL VERIFY EXISTING GRADES AND NOTIFY OWNER'S REPRESENTATIVE OF ANY DISCREPANCIES. 14. CONTRACTOR SHALL ADJUST UTILITY ELEMENT MEANT TO BE FLUSH WITH GRADE THAT IS AFFECTED BY SITE WORK
- OR GRADE CHANGES, WHETHER SPECIFICALLY NOTED ON PLANS OR NOT. 15. WHERE AN EXISTING UTILITY IS FOUND TO CONFLICT WITH THE PROPOSED WORK, THE LOCATION, ELEVATION AND
- SIZE OF THE UTILITY SHALL BE ACCURATELY DETERMINED WITHOUT DELAY BY THE CONTRACTOR, AND THE INFORMATION FURNISHED TO THE OWNER'S REPRESENTATIVE FOR RESOLUTION OF THE CONFLICT. 16. THE CONTRACTOR SHALL MAKE ALL ARRANGEMENTS FOR THE ALTERATION AND ADJUSTMENT OF ALL GAS. ELECTRIC.
- TELEPHONE AND ANY OTHER PRIVATE UTILITIES BY THE UTILITY COMPANIES. 17. ELECTRICAL DUCT BANK LOCATION IS SHOWN FOR COORDINATION PURPOSES, REFER TO ELECTRICAL PLANS FOR SECTIONS AND DETAILS OF THE UTILITY DUCT BANK.
- 18. THE LOCATION, SIZE, DEPTH AND SPECIFICATIONS FOR CONSTRUCTION OF PRIVATE UTILITY SERVICES SHALL BE INSTALLED ACCORDING TO THE REQUIREMENTS PROVIDED BY AND APPROVED BY THE RESPECTIVE UTILITY COMPANY (GAS, TELEPHONE AND ELECTRICAL). FINAL DESIGN AND LOCATIONS AT THE BUILDING WILL BE PROVIDED BY THE ARCHITECT. THE CONTRACTOR SHALL COORDINATE THE INSTALLATION OF THE UTILITY CONNECTIONS WITH THE RESPECTIVE COMPANIES PRIOR TO ANY UTILITY CONSTRUCTION.

LAYOUT AND MATERIAL NOTES

- CONTRACTOR SHALL THOROUGHLY FAMILIARIZE THEMSELVES WITH ALL CONSTRUCTION DOCUMENTS, SPECIFICATIONS AND SITE CONDITIONS PRIOR TO BIDDING AND PRIOR TO CONSTRUCTION.
- ANY DISCREPANCIES BETWEEN DRAWINGS, SPECIFICATIONS AND SITE CONDITIONS SHALL BE REPORTED IMMEDIATELY
- TO THE OWNER'S REPRESENTATTIVE FOR CLARIFICATION AND RESOLUTION PRIOR TO BIDDING OR CONSTRUCTION. SEE ARCHITECTURAL DRAWINGS FOR EXACT BUILDING DIMENSIONS AND ALL DETAILS CONTIGUOUS TO THE BUILDING
- INCLUDING SIDEWALKS, RAMPS, UTILITY ENTRANCE LOCATIONS, WALL PACKS, CONCRETE DOOR PADS, ROOF DRAINS, ETC. ACCESSIBLE CURB RAMPS SHALL BE PER THE MASSACHUSETTS ARCHITECTURAL ACCESS BOARD AND THE
- AMERICANS WITH DISABILITIES ACT ACCESSIBLITY GUIDELINES, WHICHER IS MORE STRINGENT. THE FOLLOWING LAYOUT CRITERIA SHALL CONTROL UNLESS OTHERWISE NOTED ON THE PLAN:
- ALL DIMENSIONS ARE TO OUTSIDE FACE OF BUILDING.
- ALL DIMENSIONS ARE TO FACE OF CURB AT GUTTER LINE. ALL DIMENSIONS ARE TO CENTER OF PAVEMENT MARKINGS.
- ALL TIES TO PROPERTY LINES ARE PERPENDICULAR TO THE PROPERTY LINE UNLESS OTHERWISE NOTED.

SOIL EROSION AND SEDIMENT CONTROL NOTES

- 1. THE CONSERVATION COMMISSION SHALL BE NOTIFIED, AT LEAST 72 HOURS PRIOR TO ANY LAND DISTURBANCE. 2. A COPY OF THE SOIL EROSION AND SEDIMENT CONTROL PLAN MUST BE MAINTAINED ON THE PROJECT SITE DURING CONSTRUCTION.
- 3. SOIL EROSION AND SEDIMENT CONTROL PRACTICES IN THE PLAN SHALL BE CONSTRUCTED IN ACCORDANCE WITH THE PLANS AND SPECIFICATIONS.
- 4. ALL APPLICABLE SOIL EROSION AND SEDIMENT CONTROL PRACTICES SHALL BE IN PLACE PRIOR TO ANY DEMOLITION GRADING OPERATIONS AND/OR INSTALLATION OF PROPOSED STRUCTURES OR UTILITIES.
- 5. ALL APPLICABLE SOIL EROSION AND SEDIMENT CONTROL PRACTICES SHALL BE LEFT IN PLACE UNTIL CONSTRUCTION IS COMPLETED AND/OR THE AREA IS STABILIZED.
- 6. ALL SOIL EROSION AND SEDIMENT CONTROL STRUCTURES SHALL BE INSPECTED AND MAINTAINED ON A REGULAR
- BASIS AND AFTER EVERY STORM EVENT. 7. THE MAINTENANCE OF SOIL EROSION AND SEDIMENT CONTROL MEASURES AND FACILITIES DURING AND IMMEDIATELY AFTER CONSTRUCTION RESTS WITH THE GENERAL CONTRACTOR. UPON ACCEPTANCE OF THE PROJECT. THE OWNER SHALL BECOME RESPONSIBLE FOR MAINTENANCE OF ANY REMAINING MEASURES AND FACILITIES.
- 8. OFF SITE SEDIMENT DISTURBANCE MAY REQUIRE ADDITIONAL CONTROL MEASURES TO BE DETERMINED BY THE
- 9. THE CONSERVATION COMMISSION AND/OR ENGINEER MAY REQUIRE ADDITIONAL SOIL EROSION MEASURES TO BE INSTALLED, AS DIRECTED BY THE DISTRICT INSPECTOR.
- 10. ADJOINING PROPERTIES SHALL BE PROTECTED FROM EXCAVATION AND FILLING OPERATIONS AT ALL TIMES. 11. THE CONTRACTOR SHALL UTILIZE ALL METHODS NECESSARY TO PREVENT BLOWING AND MOVEMENT OF DUST FROM
- THE EXPOSED SOIL SURFACES. 12. PAVED ROADWAYS MUST BE KEPT CLEAN AT ALL TIMES.
- 13. A CRUSHED STONE TIRE CLEANING PAD WILL BE INSTALLED WHEREVER A CONSTRUCTION ENTRANCE EXISTS. SEE LOCATION DETAIL ON PLAN.
- 14. ALL CATCH BASIN INLETS SHALL BE PROTECTED DURING CONSTRUCTION AS DETAILED ON THE PLAN, IF APPLICABLE.
- 15. ALL STORM DRAINAGE OUTLETS SHALL BE PROTECTED AS REQUIRED HEREON BEFORE DISCHARGE POINTS BECOME OPERATIONAL.
- 16. THE SITE SHALL AT ALL TIMES BE GRADED AND MAINTAINED SUCH THAT ALL STORMWATER RUNOFF IS DIVERTED TO SOIL EROSION AND SEDIMENT CONTROL FACILITIES.
- 17. LAND AREAS EXPOSED AT ANY ONE TIME AND THE LENGTH OF EXPOSURE SHALL BE KEPT TO A PRACTICAL MINIMUM. THEY SHALL BE LEFT IN A NEAT AND FINISHED APPEARANCE AND PROTECTED FROM EROSION. 18. ANY DISTURBED AREA THAT WILL BE LEFT EXPOSED FOR MORE THAN SIXTY (60) DAYS AND NOT SUBJECT TO
- CONSTRUCTION TRAFFIC SHALL IMMEDIATELY RECEIVE A TEMPORARY SEEDING AND FERTILIZATION. IF THE SEASON PROHIBITS TEMPORARY SEEDING. THE DISTRIBUTED AREAS SHALL BE MULCHED. 19. ALL CRITICAL AREAS SUBJECT TO EROSION SHALL RECEIVE A TEMPORARY SEEDING AND BE MULCHED IN
- ACCORDANCE WITH THE SPECIFICATIONS IMMEDIATELY FOLLOWING ROUGH GRADING. 20. IMMEDIATELY AFTER COMPLETION OF STRIPPING AND STOCKPILING OF TOPSOIL. SEED THE STOCKPILE WITH ANNUAL RYE GRASS. STABILIZE TOPSOIL STOCKPILES WITH STRAW MULCH FOR PROTECTION IF THE SEASON DOES NOT PERMIT THE APPLICATION AND ESTABLISHMENT OF TEMPORARY SEEDING.
- 21. SOIL STOCKPILES ARE NOT TO BE LOCATED WITHIN FIFTY (50) FEET OF WETLANDS, THE FLOODPLAIN, SLOPE, ROADWAY OR DRAINAGE FACILITIES. THE BASE OF ALL STOCKPILES SHALL BE PROTECTED BY A HAY BALE BARRIER OR SEDIMENT FENCE. LOCATIONS ARE DELINEATED ON THE PLAN.
- 22. MAXIMUM SIDE SLOPES OF ALL EXPOSED SURFACES SHALL NOT BE CONSTRUCTED STEEPER THAN 3:1 UNLESS OTHERWISE APPROVED BY THE DISTRICT.
- 23. ALL AREAS NOT STABILIZED BY CONSTRUCTION, SODDING OR LANDSCAPING SHALL BE SEEDED AND STABILIZED IN ACCORDANCE WITH THE SEEDING AND MULCHING SPECIFICATIONS.
- 24. MULCHING IS REQUIRED ON ALL SEEDED AREAS TO INSURE AGAINST EROSION BEFORE GRASS IS ESTABLISHED TO PROMOTE EARLIER VEGETATIVE COVER.
- 25. ALL DEWATERING OPERATIONS MUST DISCHARGE DIRECTLY INTO A SEDIMENT FILTRATION DEVICE. THE SEDIMENT FILTER MUST BE CAPABLE OF FILTERING THE SEDIMENT AND BE PLACED SO AS NOT TO CAUSE EROSION OF THE DOWNSTREAM AREA.

LEGEND

CONTOUR LINE

EXISTING

— OHW — — OHW — —

PROPOSED

	CONTOUR LINE		
x O ,	SPOT GRADE	+101.1	
EOP	EDGE OF PAVEMENT	EOP	
VGC	VERTICAL GRANITE CURB	VGC	
SAC	SLOPED GRANITE CURB	SGC	
VCC	VERTICAL CONCRETE CURB	VCC	
ВСС	BITUMINOUS CONCRETE CURB	BCC	
ССВ	CAPE COD BERM	CCB	
- >>>>>>>>	STONE WALL	- >>>>>>	
X	CHAIN LINK FENCE	XX	
	IRON FENCE	Δ	
	POST & RAIL FENCE		
	STOCKADE FENCE		
	GUARD RAIL		
	HAY BALES		
-W	WATER LINE	-w	
(<u>O</u>)	FIRE HYDRANT	•	
	POST INDICATOR VALVE		
\bowtie	WATER GATE	\bowtie	
	WATER METER PIT		
	IRRIGATION HAND HOLE		
0	WELL		
	SEWER LINE		
o	SEWER MANHOLE		
	OAC LINE		


GAS LINE GAS METER GAS GATE

DRAIN LINE

DRAIN MANHOLE

CATCH BASIN OVERHEAD WIRES ELECTRIC, TELEPHONE & CABLE UTILITY POLE

GUY WIRE

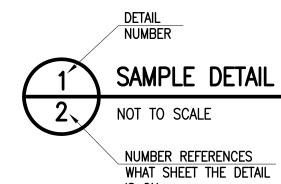

ALBERT FARLAND No. 47544

REVISIONS

| 9/29/17 | CONSERVATION COMMENTS

CONSERVATION COMMENTS



401 COUNTY STREET NEW BEDFORD, MA 02740 P.508.717.3479 OFFICES IN: TAUNTON MARLBOROUGH

DRAWN BY: MJW

DESIGNED BY: JKM CHECKED BY: CAF

WARWICK, RI

ARD BOULE SS SE DUCHA SSORS SEDFOF ROAD ROAD шш SE SE


> AUGUST 10, 2017 SCALE: AS NOTED

LATEST REVISION: OCTOBER 23, 2017


JOB NO. 15-500.2

SHEET 2 OF 10

NOTES & LEGEND

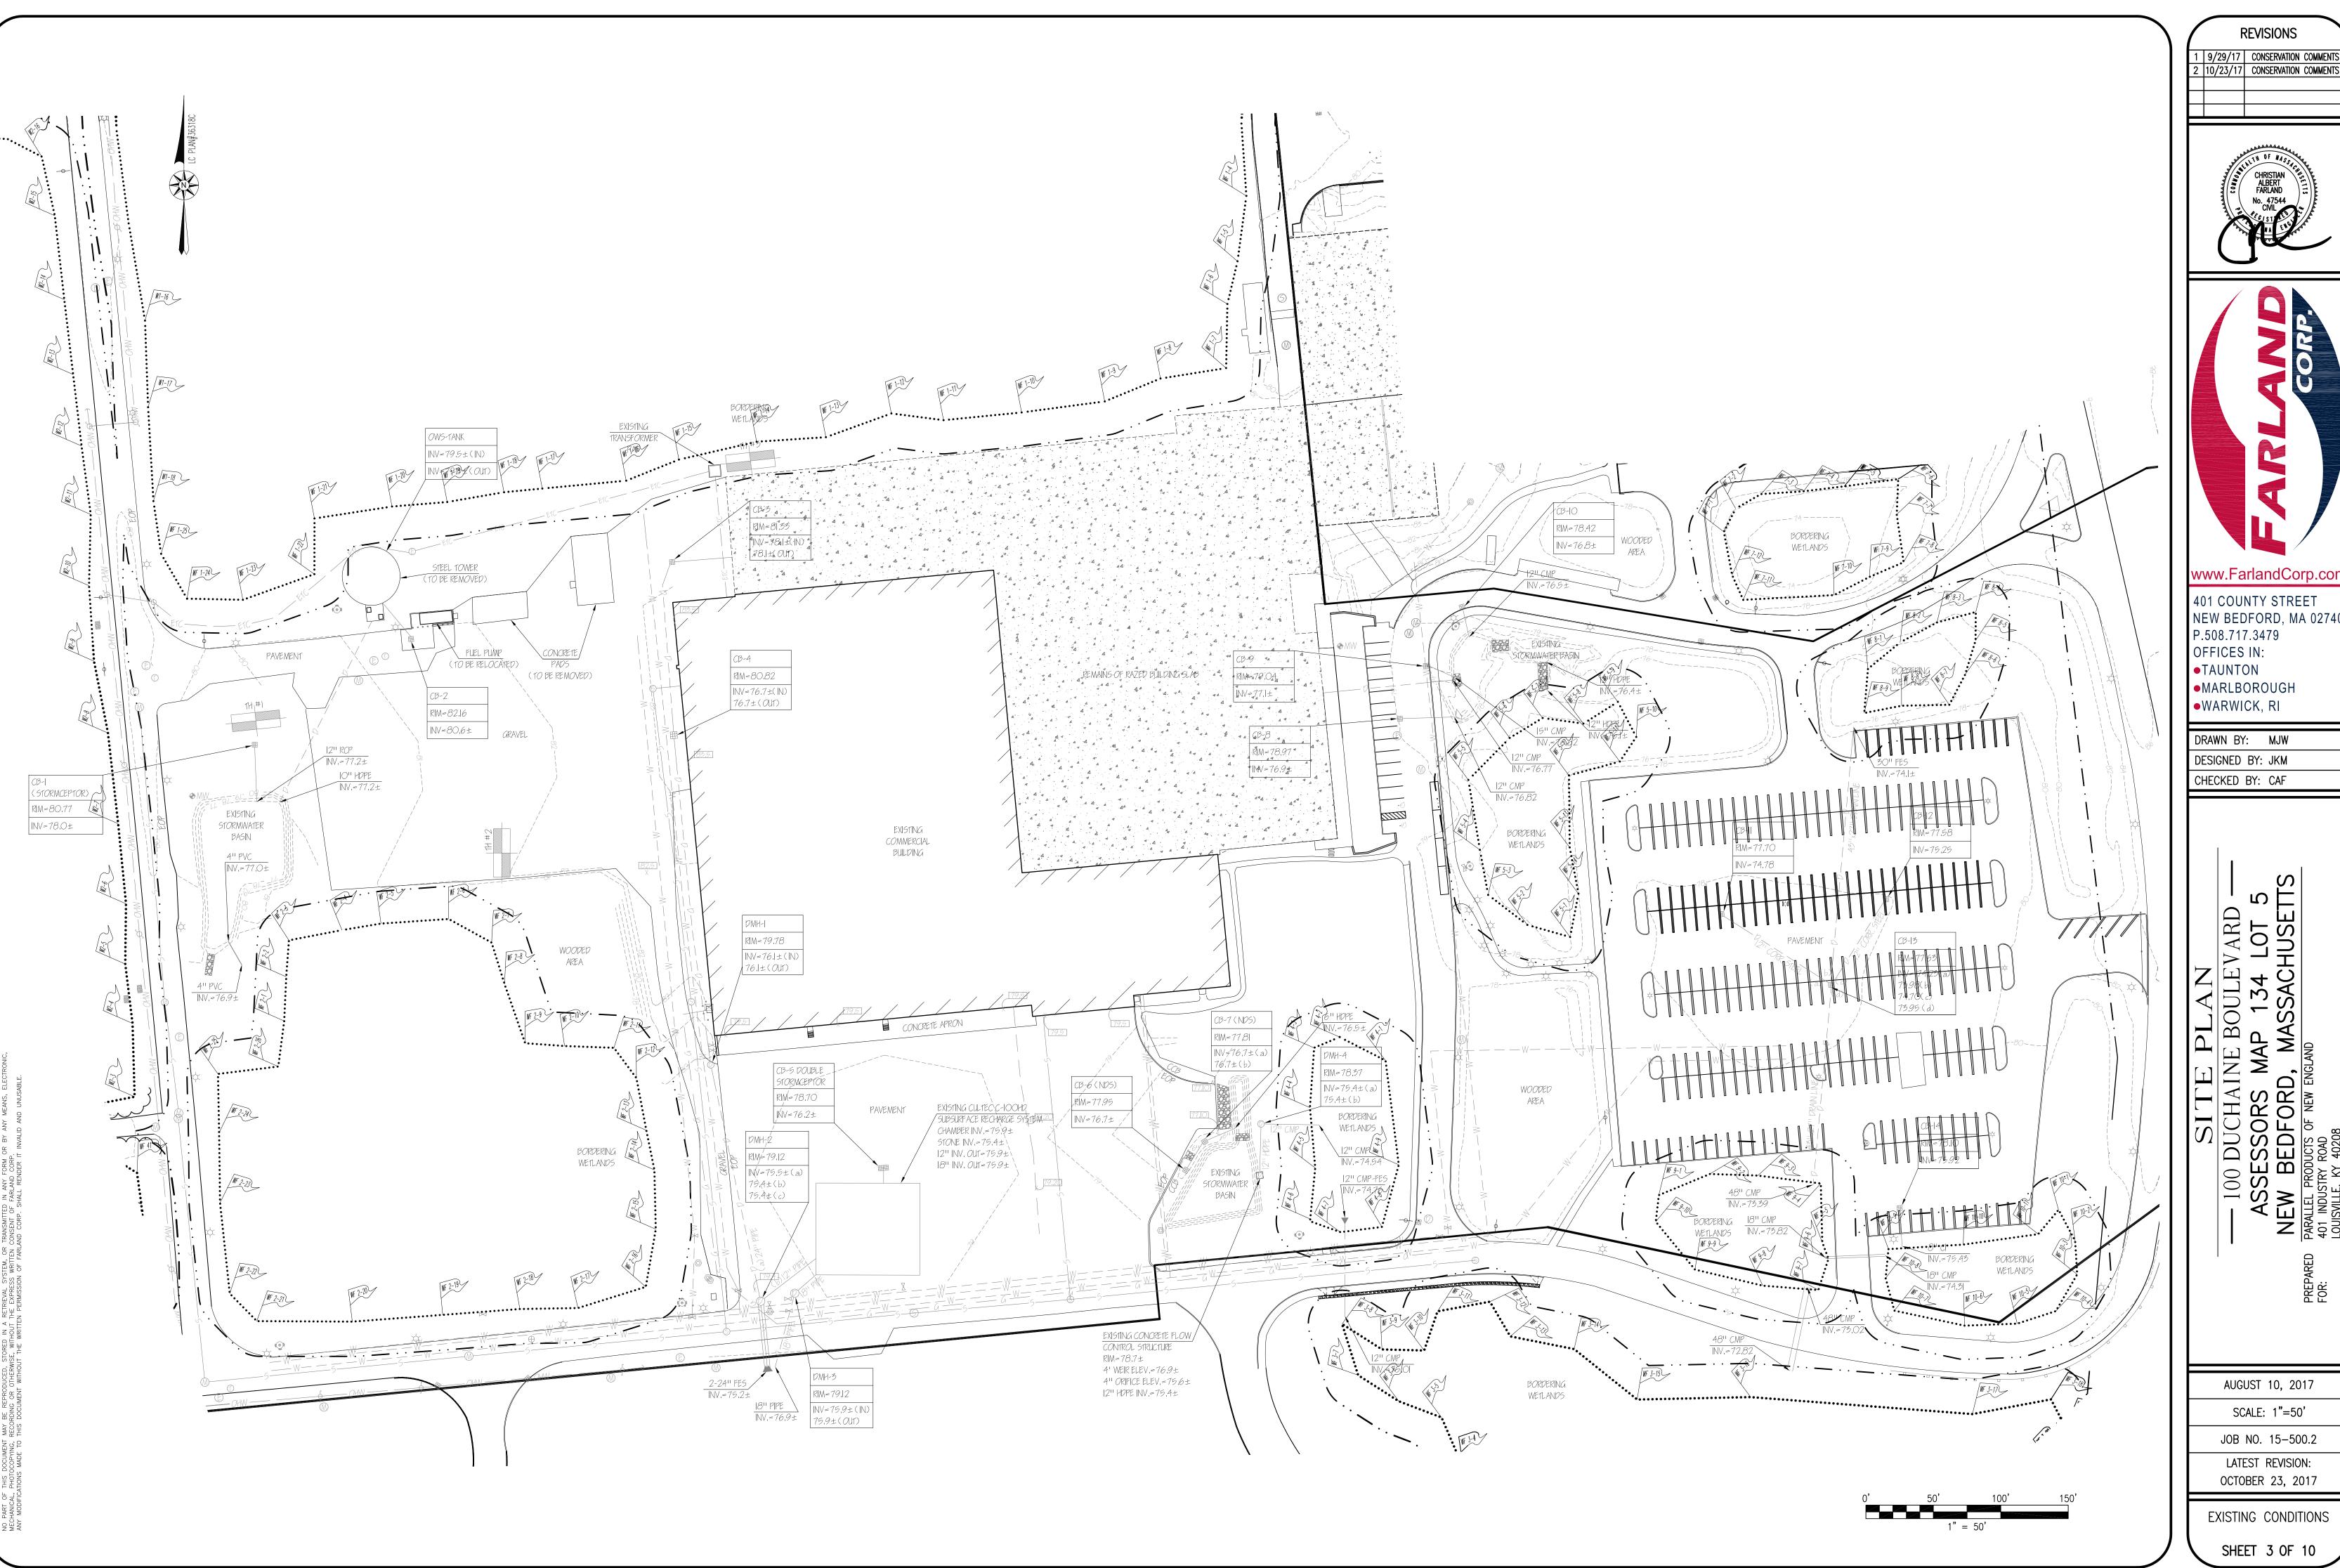

9/29/17 CONSERVATION COMMENTS 10/23/17 CONSERVATION COMMENTS

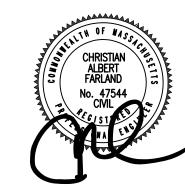



401 COUNTY STREET NEW BEDFORD, MA 02740 P.508.717.3479 OFFICES IN: TAUNTON •MARLBOROUGH

DRAWN BY: MJW

DESIGNED BY: JKM CHECKED BY: CAF

SITE PLAN

— 100 DUCHAINE BOULEVARD —

ASSESSORS MAP 134 LOT 5

NEW BEDFORD, MASSACHUSETTS


401 INDUSTRY ROAD
LOUISVILLE, KY 40208

AUGUST 10, 2017

SCALE: 1"=50' JOB NO. 15-500.2


LATEST REVISION: OCTOBER 23, 2017


EXISTING CONDITIONS SHEET 3 OF 10

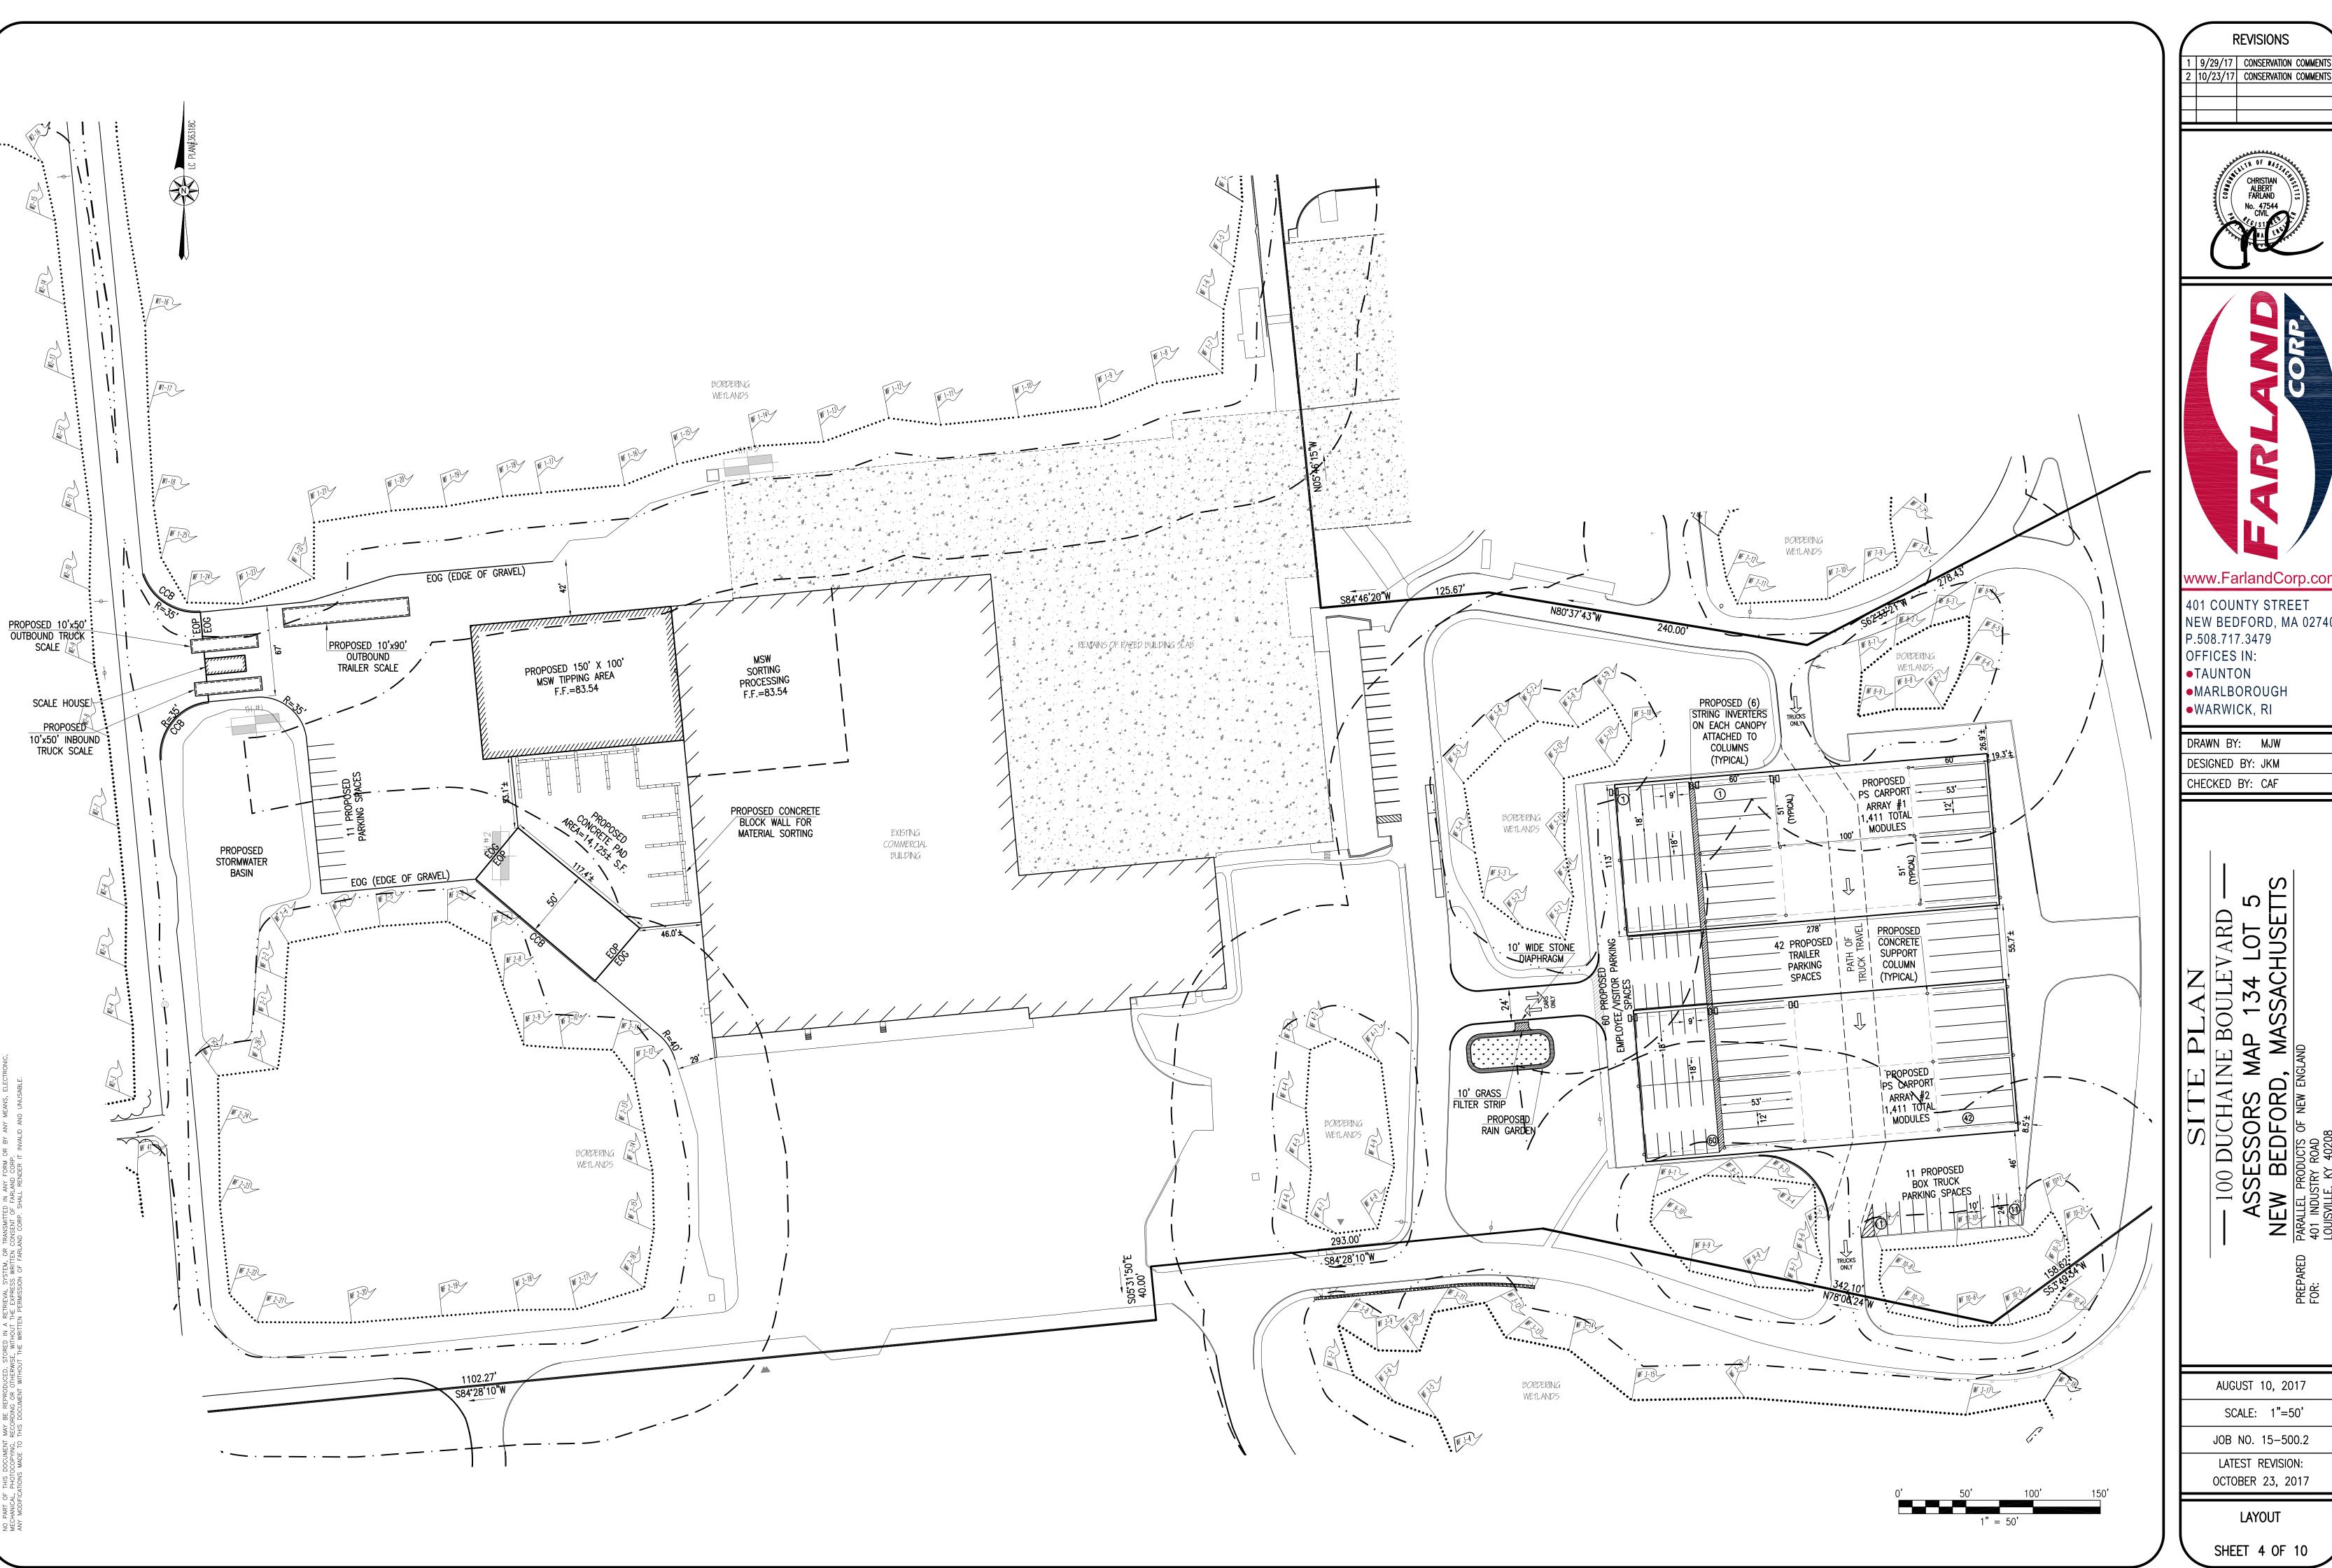

REVISIONS

1 9/29/17 CONSERVATION COMMENTS 2 10/23/17 CONSERVATION COMMENTS

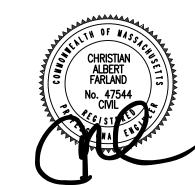

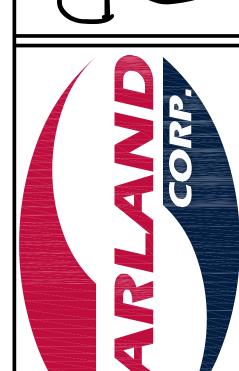

401 COUNTY STREET NEW BEDFORD, MA 02740 P.508.717.3479 OFFICES IN: TAUNTON MARLBOROUGH

DESIGNED BY: JKM CHECKED BY: CAF

DRAWN BY: MJW

SITE PLAN

— 100 DUCHAINE BOULEVARD —

ASSESSORS MAP 134 LOT 5

NEW BEDFORD, MASSACHUSETTS

PARALLEL PRODUCTS OF NEW ENGLAND


401 INDUSTRY ROAD

LOUISVILLE. KY ARRAGO

AUGUST 10, 2017 SCALE: 1"=50'


JOB NO. 15-500.2 LATEST REVISION: OCTOBER 23, 2017

LAYOUT

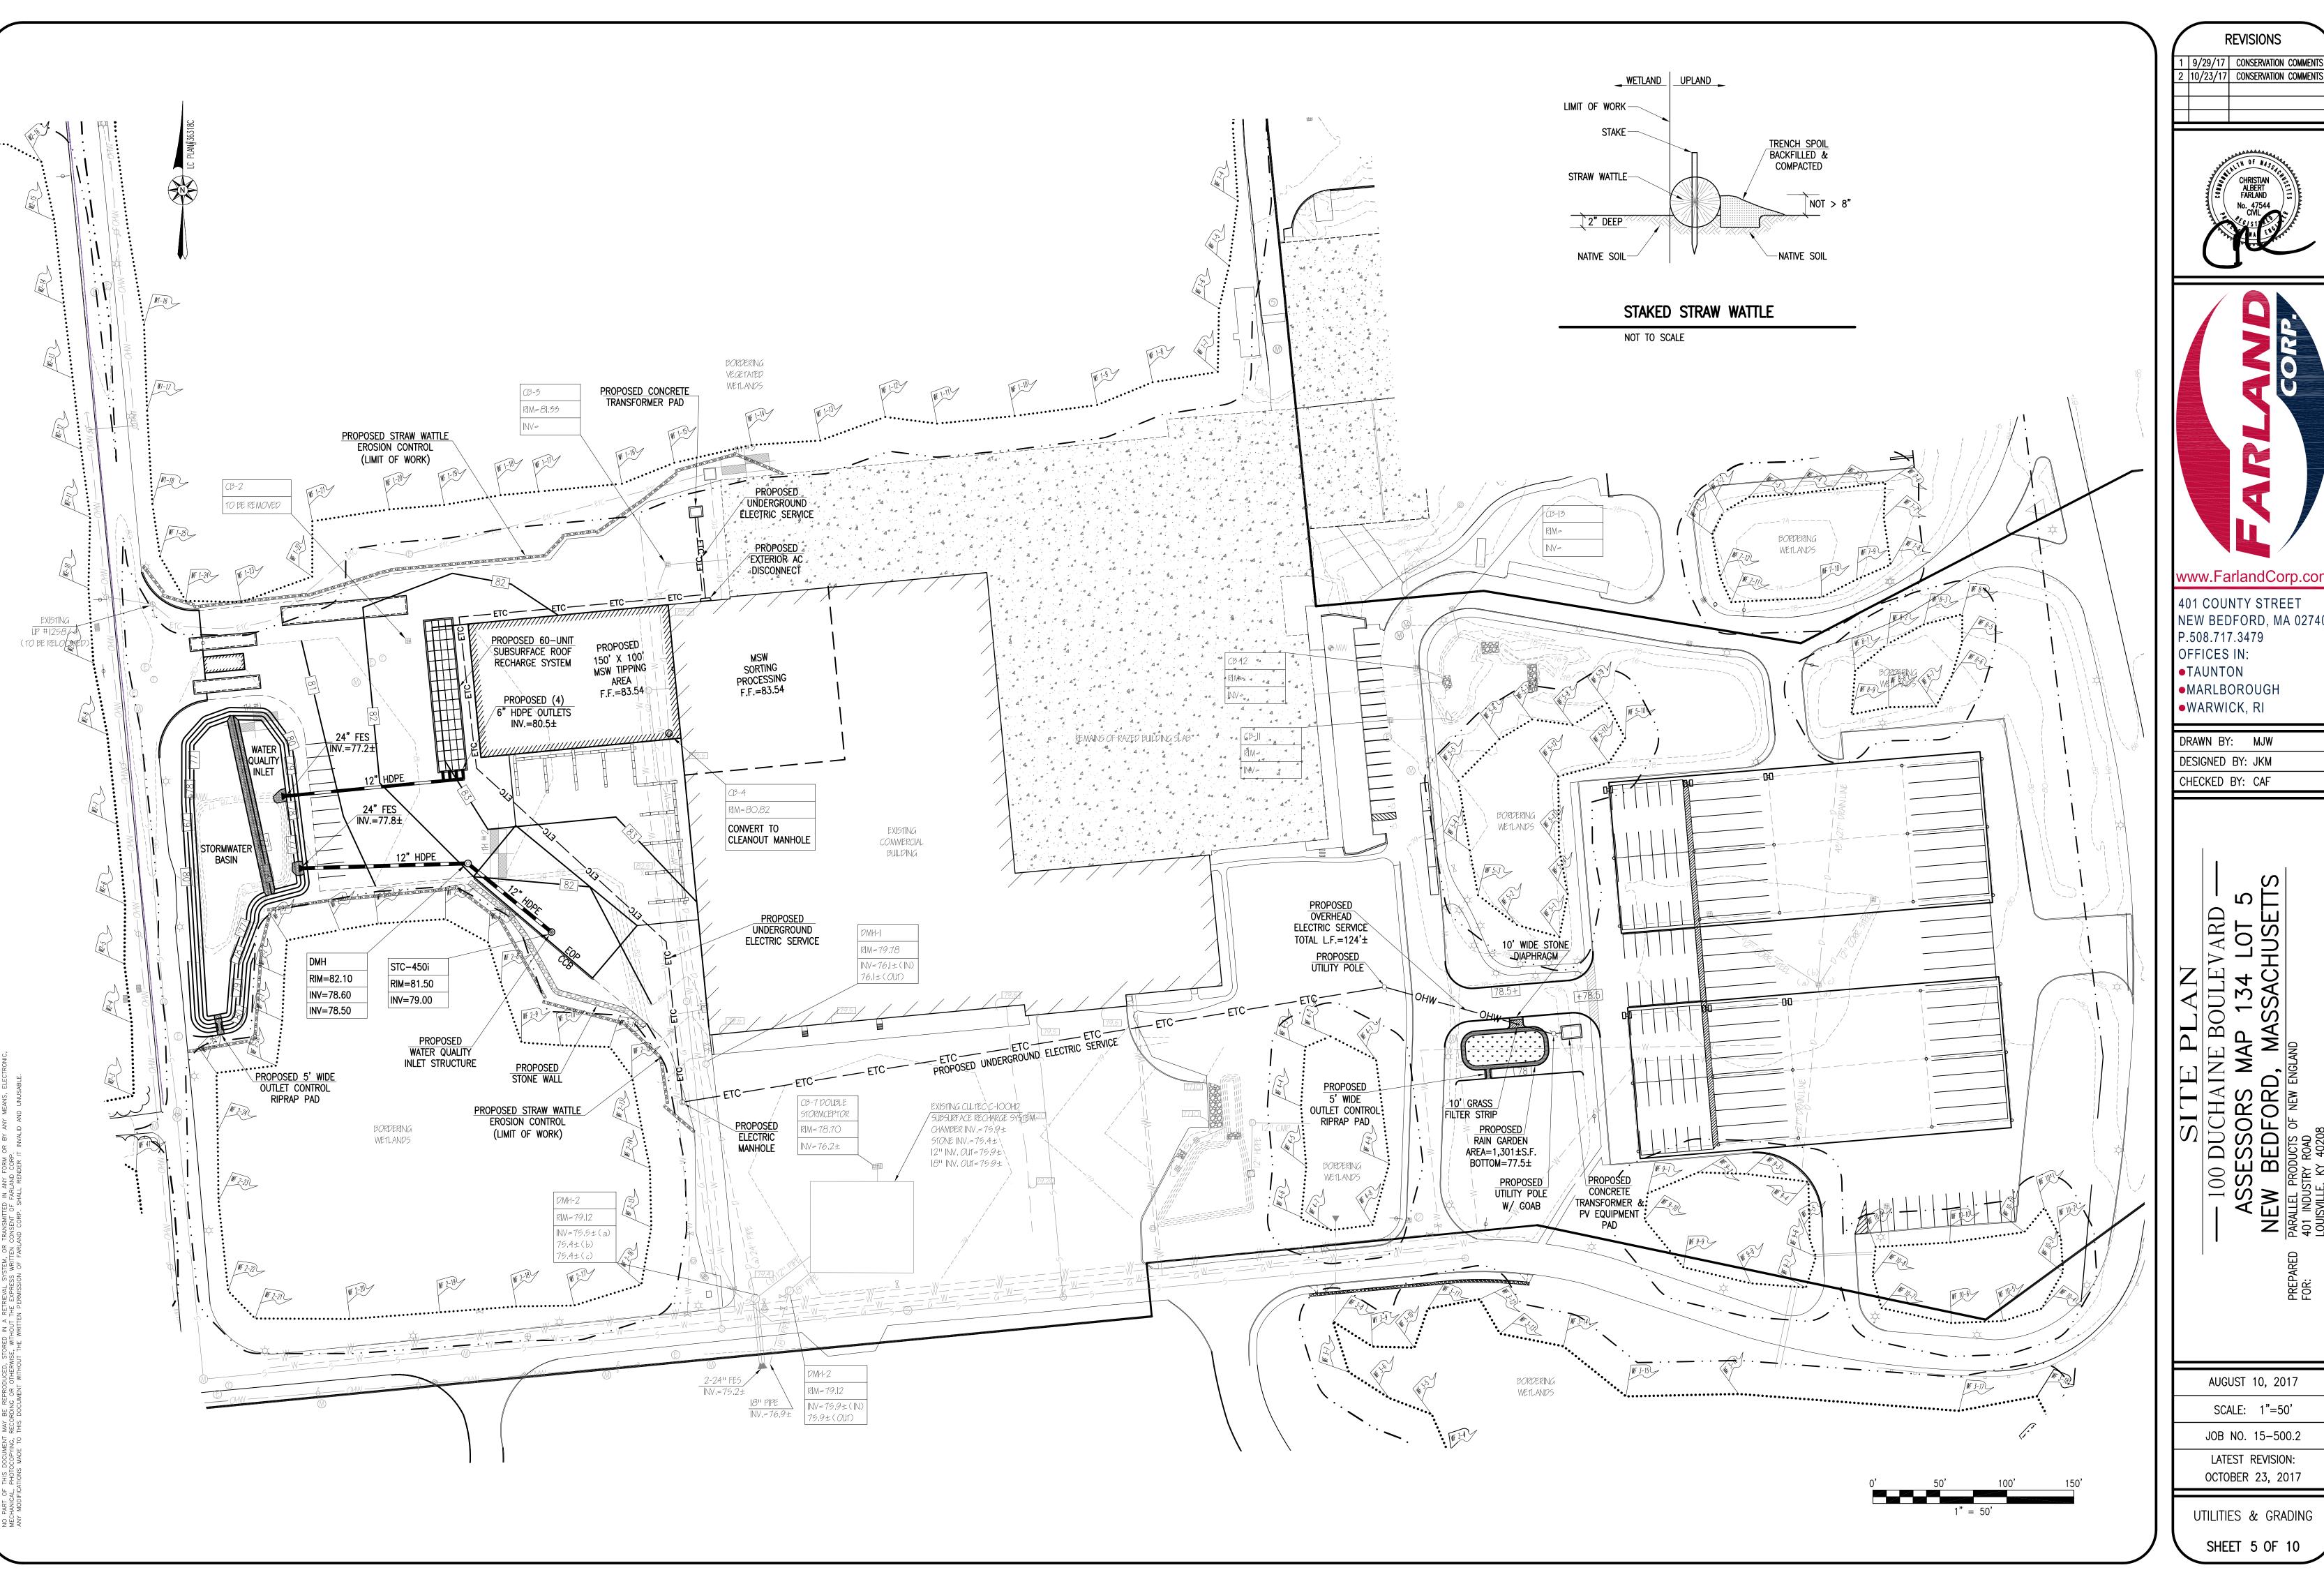

REVISIONS

9/29/17 | CONSERVATION COMMENTS 10/23/17 CONSERVATION COMMENTS

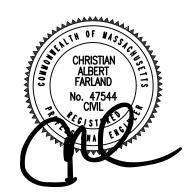



NEW BEDFORD, MA 02740 P.508.717.3479 OFFICES IN: TAUNTON •MARLBOROUGH •WARWICK, RI

DRAWN BY: MJW

DESIGNED BY: JKM CHECKED BY: CAF

SITE PLAN

— 100 DUCHAINE BOULEVARD —

ASSESSORS MAP 134 LOT 5

NEW BEDFORD, MASSACHUSETTS

PARALLEL PRODUCTS OF NEW ENGLAND


LOUISVILLE. KY ACCOUNTY ROAD

LOUISVILLE. KY ACCOUNTY ROAD

AUGUST 10, 2017 SCALE: 1"=50'


JOB NO. 15-500.2 LATEST REVISION: OCTOBER 23, 2017


UTILITIES & GRADING

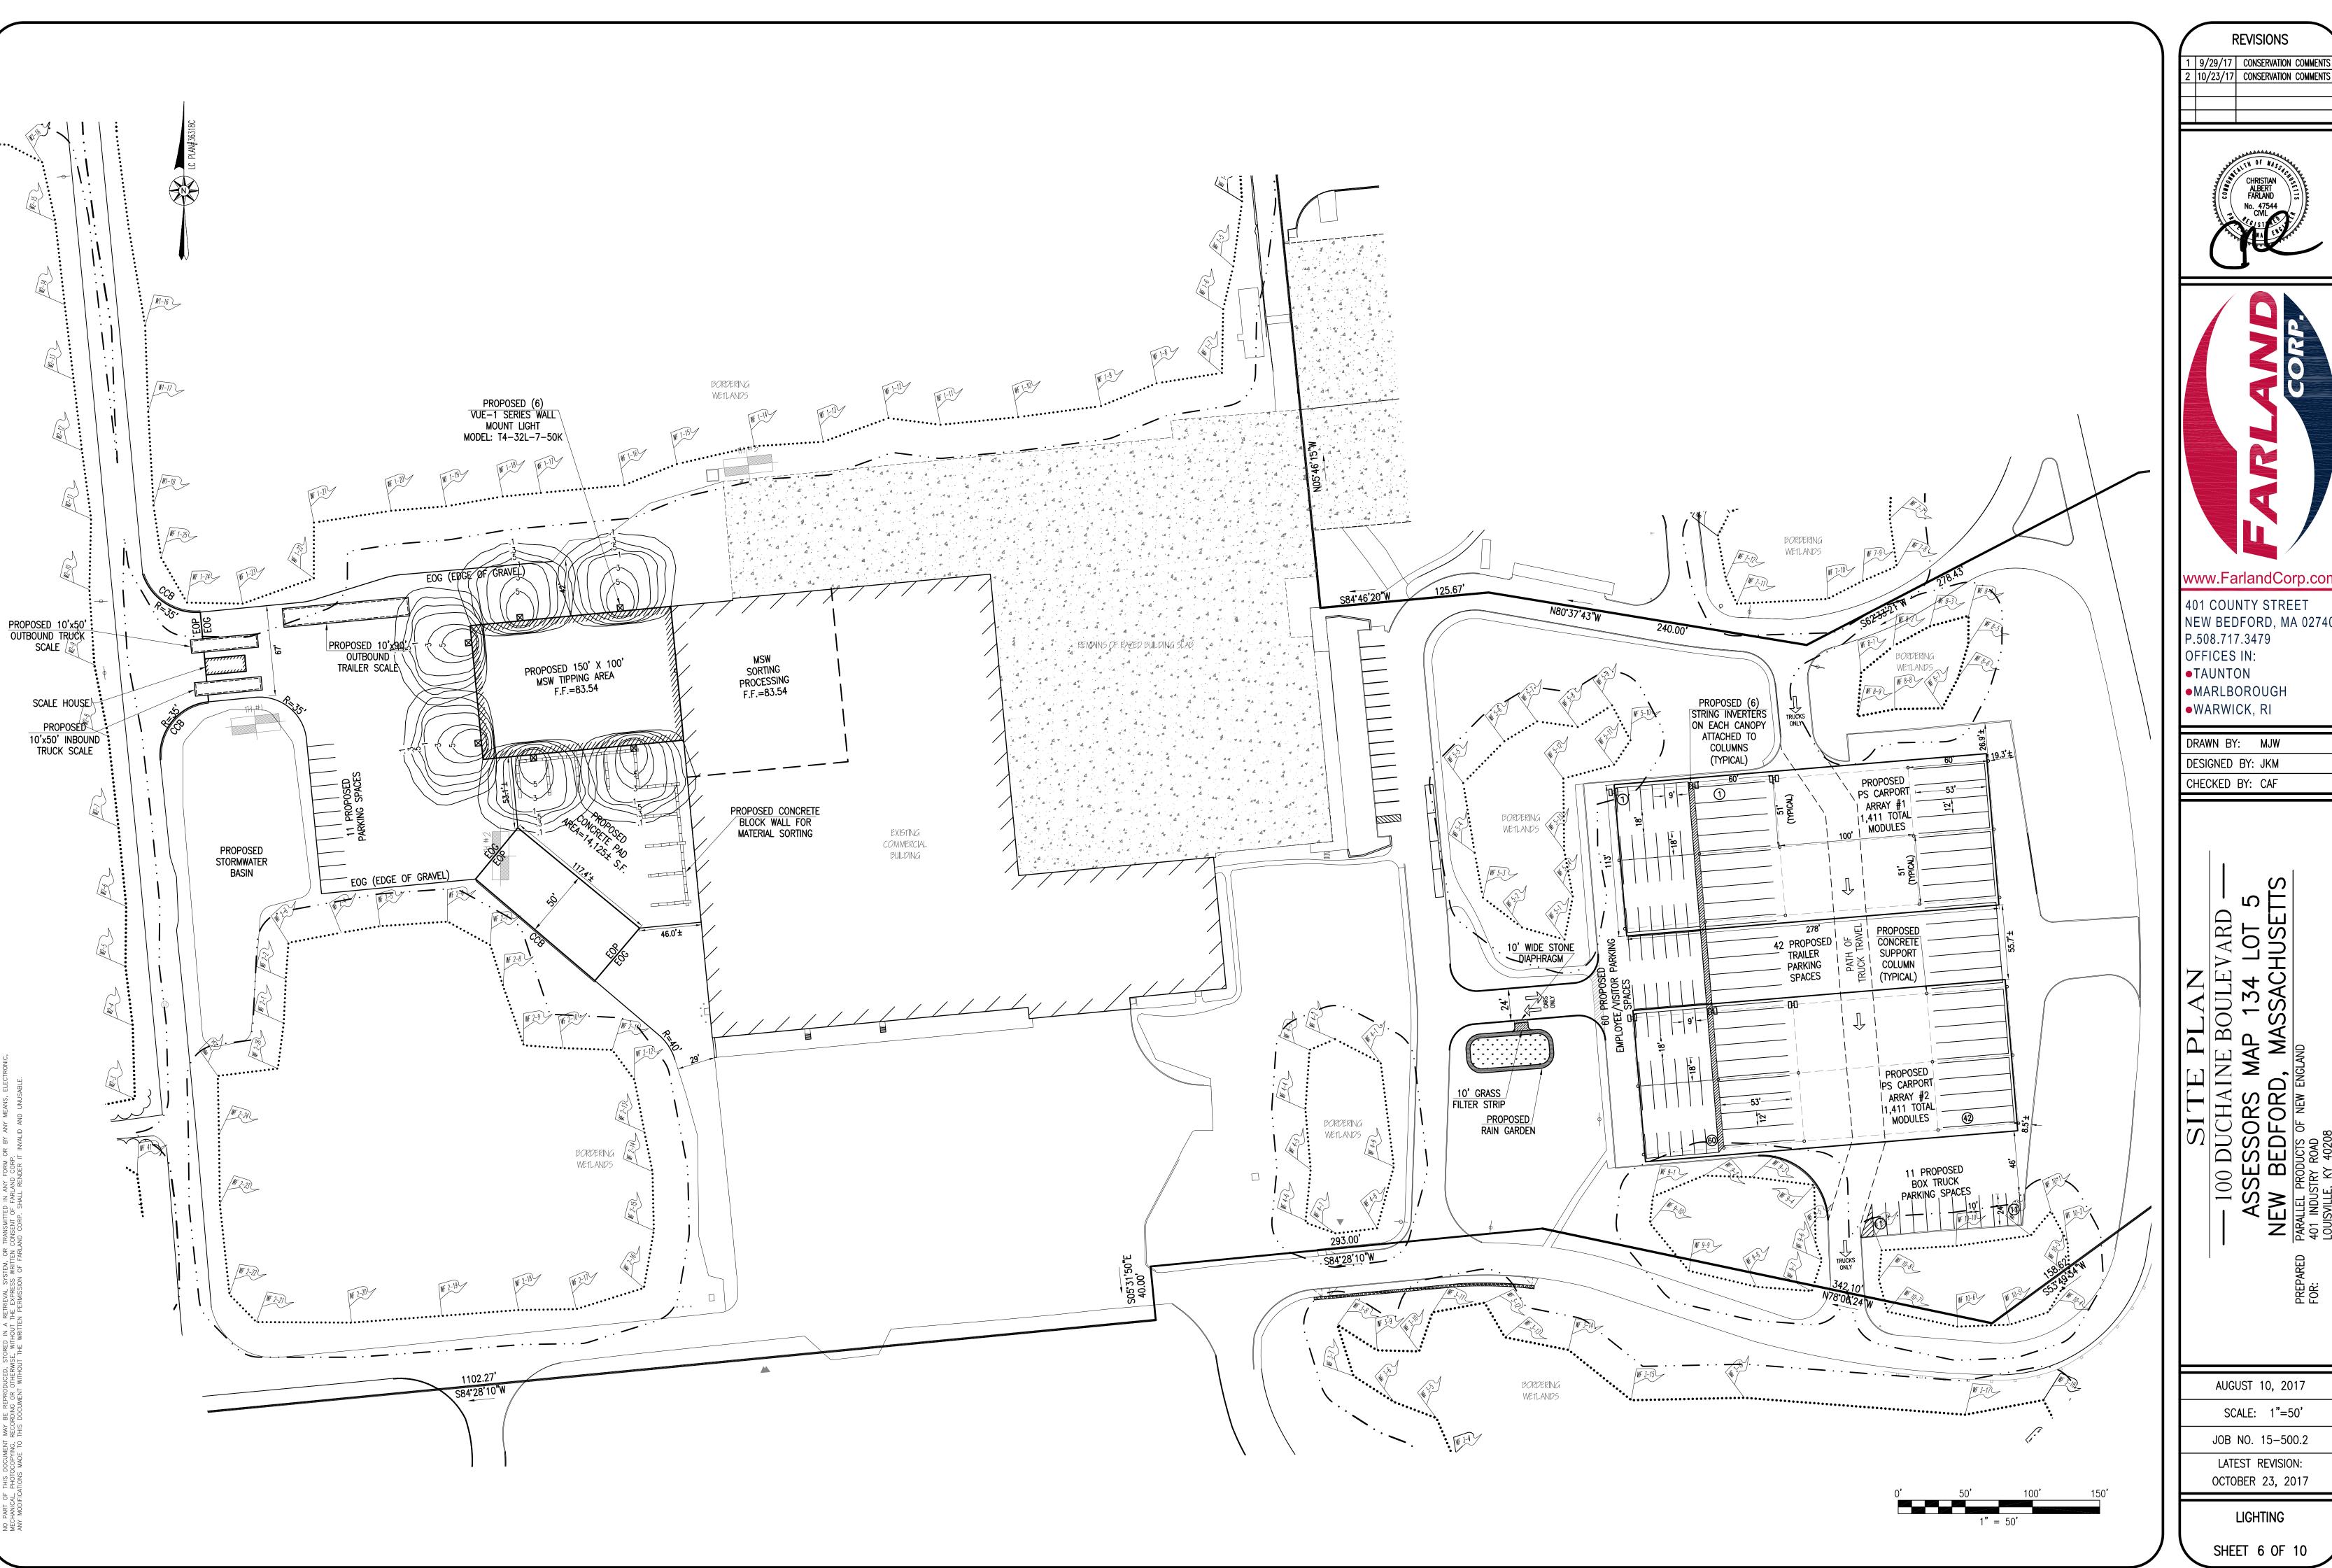

REVISIONS

9/29/17 CONSERVATION COMMENTS 2 10/23/17 CONSERVATION COMMENTS

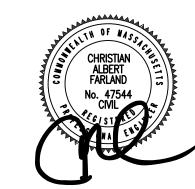

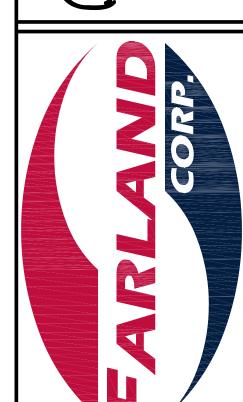

401 COUNTY STREET NEW BEDFORD, MA 02740 P.508.717.3479 OFFICES IN: TAUNTON MARLBOROUGH WARWICK, RI

DESIGNED BY: JKM CHECKED BY: CAF

DRAWN BY: MJW

SITE PLAN

— 100 DUCHAINE BOULEVARD —

ASSESSORS MAP 134 LOT 5

NEW BEDFORD, MASSACHUSETTS

PARALLEL PRODUCTS OF NEW ENGLAND


401 INDUSTRY ROAD

LOUISVILLE. KY ARRAGO

AUGUST 10, 2017 SCALE: 1"=50'

JOB NO. 15-500.2 LATEST REVISION: OCTOBER 23, 2017

LIGHTING

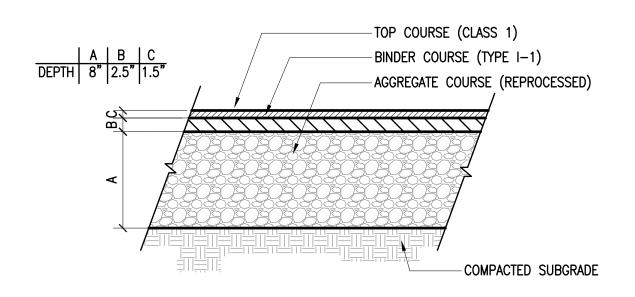

BITUMINOUS CONCRETE PAVEMENT

CONCRETE PAD 8" 6" TOOLED CONTROL JOINT 1/4" TIMES THE DEPTH OF THE SLAB, WITH 2" WIDE SMOOTH STRIP ON EACH SIDE. LAYOUT AS INDICATED ON PLAN. - CONCRETE PAVEMENT 4,000 PSI 6"x6" #10 WELDED WIRE MESH REINFORCING 3" MINIMUM COVER - AGGREGATE BASE COURSE - COMPACTED SUBGRADE

PROVIDE LIGHT BROOM FINISH PERPENDICULAR TO THE TRAFFIC FLOW UNLESS OTHERWISE NOTED.

CONCRETE PAVEMENT PAD


NOT TO SCALE

NOT TO SCALE


BITUMINIOUS CONCRETE CAPE COD BERM

NOT TO SCALE

NOT TO SCALE

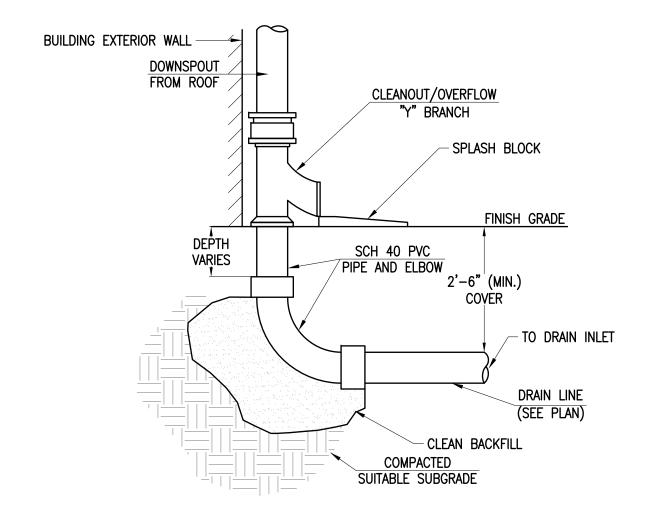

DOWNSPOUT FROM ROOF 2-CULTEC RECHARGER V8HD CLEANOUT/OVERFLOW HEAVY DUTY CHAMBERS BUILDING "Y" BRANCH EXTERIOR WALL <u>1"-2" DIA. WASHED,</u> - SPLASH BLOCK CRUSHED STONE 4 OZ. NON-WOVEN FILTER FABRIC AROUND STONE FINISH GRADE 12" OF CLEAN FILL/ 12" OF CLEAN FILL 17.0'

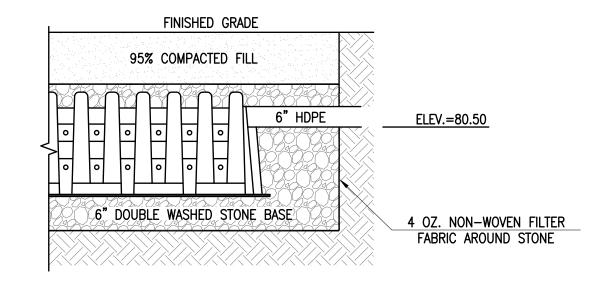

TYPICAL CONNECTION OF OVERFLOW DISCHARGE MANIFOLD

NOT TO SCALE

ROOF RECHARGE SYSTEM

CULTEC F110x2 FEED CONNECTOR RECHARGER HVLV V8SHD HEAVY-DUTY CHAMBER 4 OZ. NON-WOVEN FILTER FABRIC AROUND STONE PAVEMENT PAVEMENT ELEV.=82.83 95% COMPACTED FILL 95% COMPACTED FILL ELEV.=81.83 ELEV.=81.33 ELEV.=80.50 ELEV.=78.00

5' WIDE BROAD-CRESTED WEIR TOP OF BERM ELEV.=80.00 100 YR STORM EL=79.04 INFLOW FROM GRASS CHANNEL EL=79.00 $\frac{\text{STAKED}}{\text{HAY BALES}} \setminus$ LOAM & SEED SIDE SLOPES OF INFILTRATION BASIN (3:1 MAX) 10 YR STORM EL=78.26 2 YR STORM EL=77.74 BOTTOM OF INFILTRATION BASIN EL=77.00 ESTIMATED SEASONAL HIGH GROUND WATER EL=75.6±

INFILITRATION BASIN

NOT TO SCALE

CULTEC RECHARGER V8HD HEAVY DUTY CROSS SECTION

DOWNSPOUT CONNECTION FROM ROOF

NOT TO SCALE

NOT TO SCALE

DRAWN BY: MJW DESIGNED BY: JKM CHECKED BY: CAF

MARLBOROUGH

WARWICK, RI

www.FarlandCorp.com

NEW BEDFORD, MA 02740

401 COUNTY STREET

P.508.717.3479

OFFICES IN:

TAUNTON

REVISIONS

1 9/29/17 CONSERVATION COMMENTS

2 10/23/17 CONSERVATION COMMENTS

AUGUST 10, 2017 SCALE: N.T.S.

LATEST REVISION: OCTOBER 23, 2017

JOB NO. 15-500.2

DETAILS

SHEET 7 OF 10

WATER QUALITY INLET STRUCTURE - STORMCEPTOR STC 450i

NOT TO SCALE

1. ALL SECTIONS SHALL BE DESIGNED 2'-0" Di<u>ā</u>. Acceşs FOR HS-20 LOADING. - SEE NOTE #5 2. PROVIDE "V" KNOCKOUTS FOR PIPES WITH 1" MAX. CLEARANCE TO OUTSIDE OF FINISH GRADE PIPE. MORTAR ALL PIPE CONNECTIONS. 3. COPOLYMER MANHOLE STEPS SHALL - SEE NOTE #3 BE INSTALLED AT 12" O.C. FOR THE FULL DEPTH OF THE STRUCTURE -see note #4 4. JOINT SEALANT BETWEEN PRECAST SECTIONS SHALL BE 4'-0" PREFORMED BUTYL RUBBER. DIA. MANHOLE -NON-SHRINK GROUT 5. DRAIN MANHOLE FRAME SHALL BE SET IN FULL MORTAR BED. ADJUST TO GRADE WITH CLAY BRICK AND MORTAR. (2 BRICK COURSES MIN. 5 BRICK COURSES -12" COMPACTED GRAVEL DIA. COMPACTED SUBGRADE - CEMENT CONCRETE INVERT DIA. MANHOLE SHELF TO BE FORMED AT 1 PER FOOT (FOR PIPE 18" ALTERNATE TOP SLAB AND LARGER) (STEEL REINFORCED FOR HS-20 LOADING)

NOTES:


DRAIN MANHOLE

NOT TO SCALE

T.H. #3 T.H. #1 T.H. #2 EL. 80.5± EL. 81.4± EL. 80.9± 0"-69" 0"-68" 0"-66" FILL C LAYER UNEXCAVATED 68"-100" C LAYER C LAYER SAND WEEPING @ 60" (75.5) WEEPING @ 60" (75.9) STANDING @ 68" (74.8) STANDING @ 66" (75.4) MOTTLES @ 70" (75.6) WEEPING @ 94" (73.6) STANDING @ 100" (73.1)

SOIL PROFILES

NOT TO SCALE

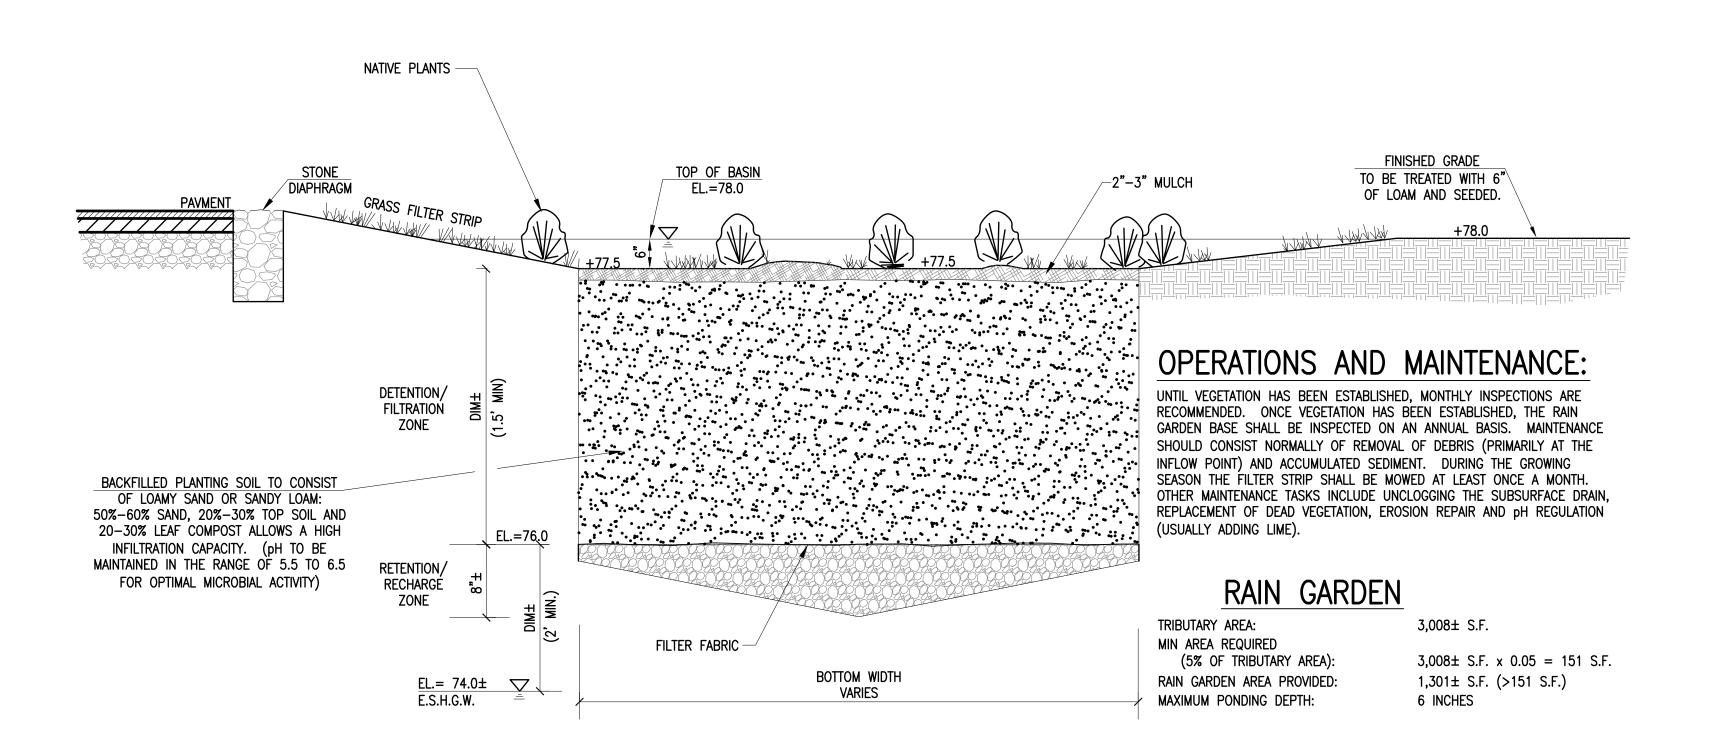

RAIN GARDEN (PROFILE)

NOT TO SCALE

REVISIONS 1 9/29/17 CONSERVATION COMMENTS 2 10/23/17 CONSERVATION COMMENTS





401 COUNTY STREET NEW BEDFORD, MA 02740 P.508.717.3479 OFFICES IN: TAUNTON MARLBOROUGH WARWICK, RI

DRAWN BY: MJW DESIGNED BY: JKM

CHECKED BY: CAF

SITE PLAN

O DUCHAINE BOULEVARD

ESSORS MAP 134 LOT 5

BEDFORD, MASSACHUSETI ASSES
NEW BE
PARALLEL PROF

> AUGUST 10, 2017 SCALE: N.T.S.

JOB NO. 15-500.2

LATEST REVISION: OCTOBER 23, 2017

DETAILS

SHEET 8 OF 10