



9/27/2016 9:57:09 AM P:\ASG Data\Projects\MA - New Bedford\032 Design Only - Reconstruct Terminal Aprons\CADD\Preliminary Submittal\103-032 SHEET DETAILS.dwg (MKO)

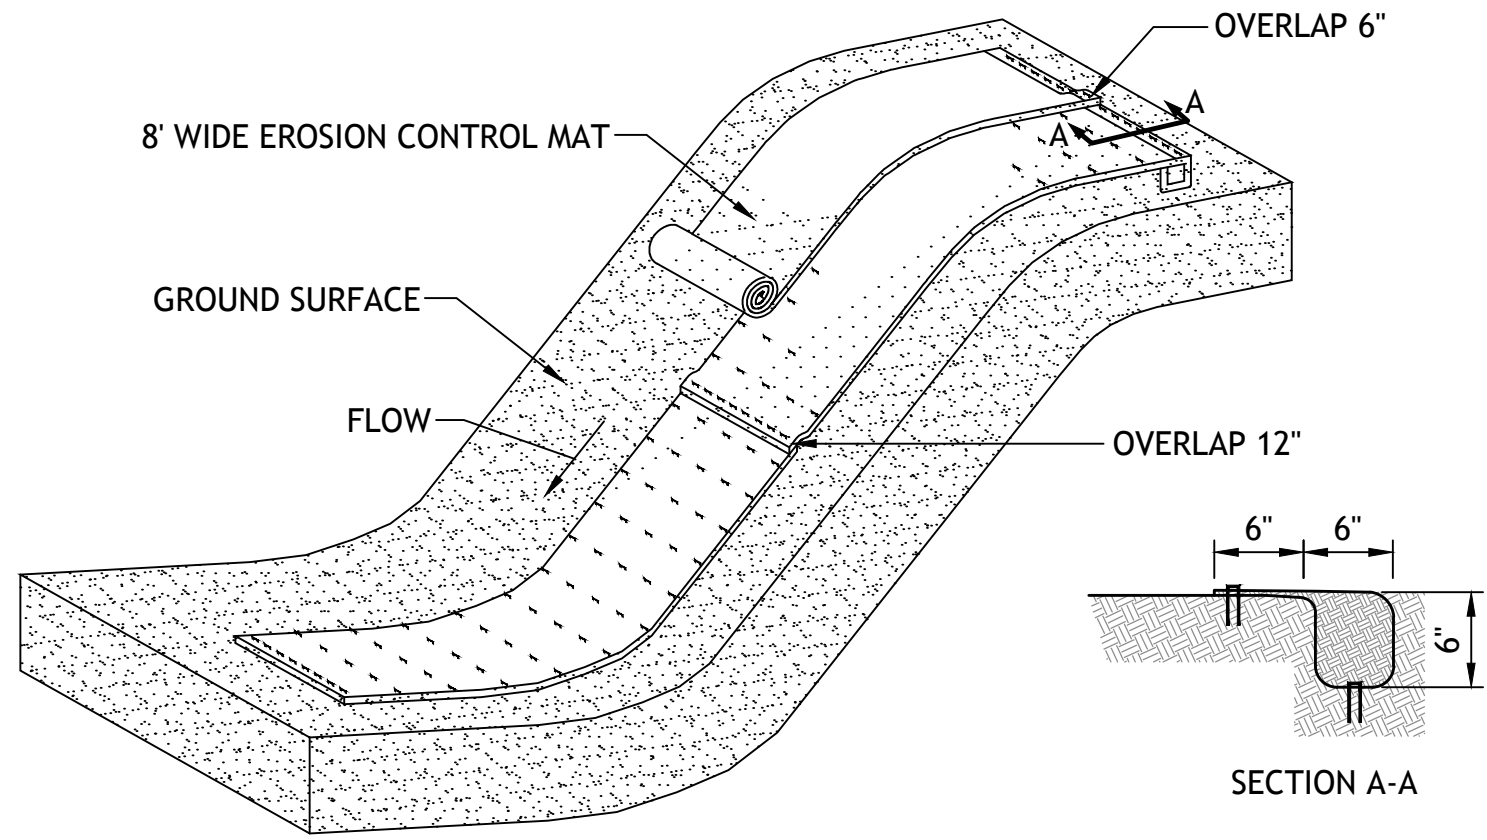


- EROSION CONTROL MATTING NOTES:**
1. PRIOR TO PLACING EROSION CONTROL MATTING, PREPARE THE SOIL BY RAKING AREA FREE OF CLODS AND LARGE STONES.
  2. SEED, MULCH AND FERTILIZER SHALL BE DISTRIBUTED AS SPECIFIED OVER THE PREPARED SOIL PRIOR TO PLACING THE EROSION CONTROL MATTING.
  3. ALL SEAMS SHALL BE OVERLAPPED A MINIMUM OF 12" AND SECURED WITH STAPLES 18" ON CENTER.
  4. TO SECURE MAT TO GROUND, STAPLE RANDOMLY AT 24" INTERVALS THROUGHOUT, OR AT 12" AT ENDS
  5. APPROXIMATELY 200 STAPLES PER ROLL
  6. PLACE EROSION CONTROL MATTING AS DIRECTED BY THE ENGINEER, ON SLOPES GREATER THAN 5:1, AND AS SHOWN ON THESE C4.1 AND W1.1.


**EROSION CONTROL MATTING DETAIL**  
SCALE: N.T.S.

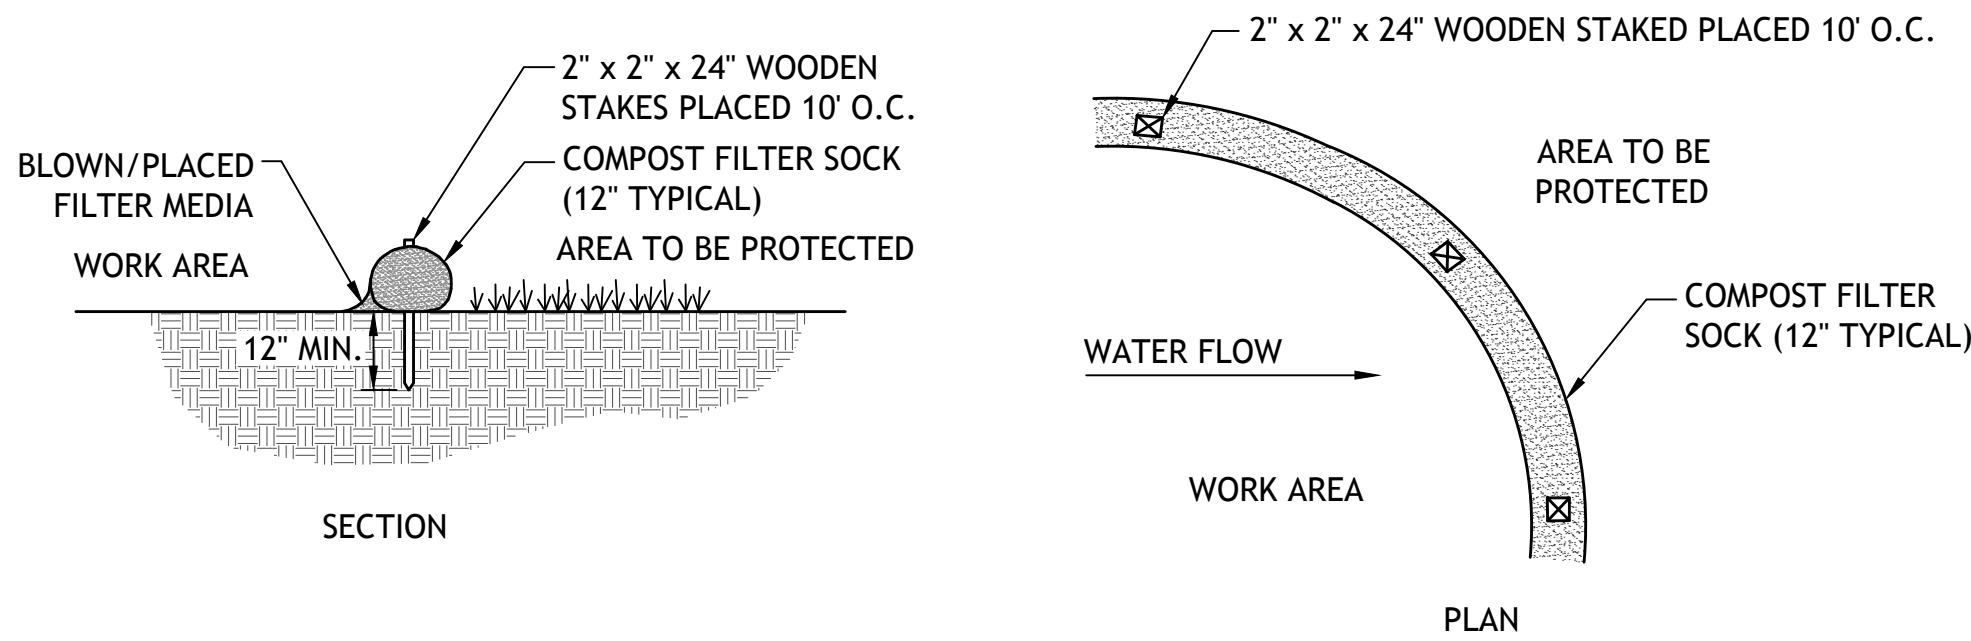

**COMPOST FILTER SOCK DETAIL**  
SCALE: N.T.S.

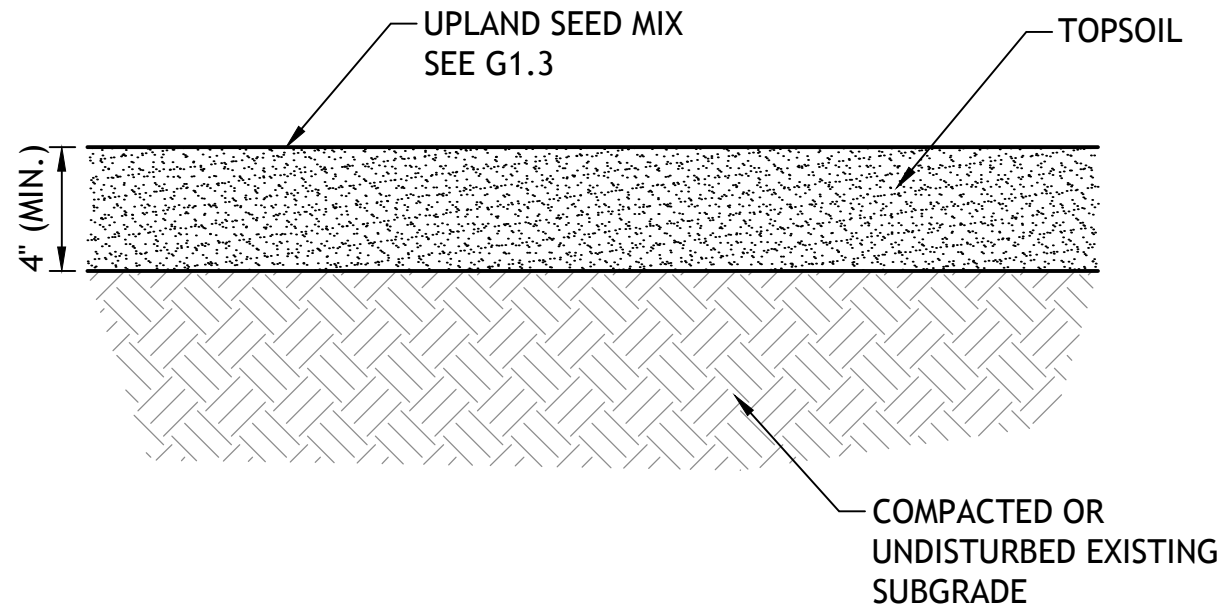


**TOPSOIL AND SEED DETAIL**  
SCALE: N.T.S.

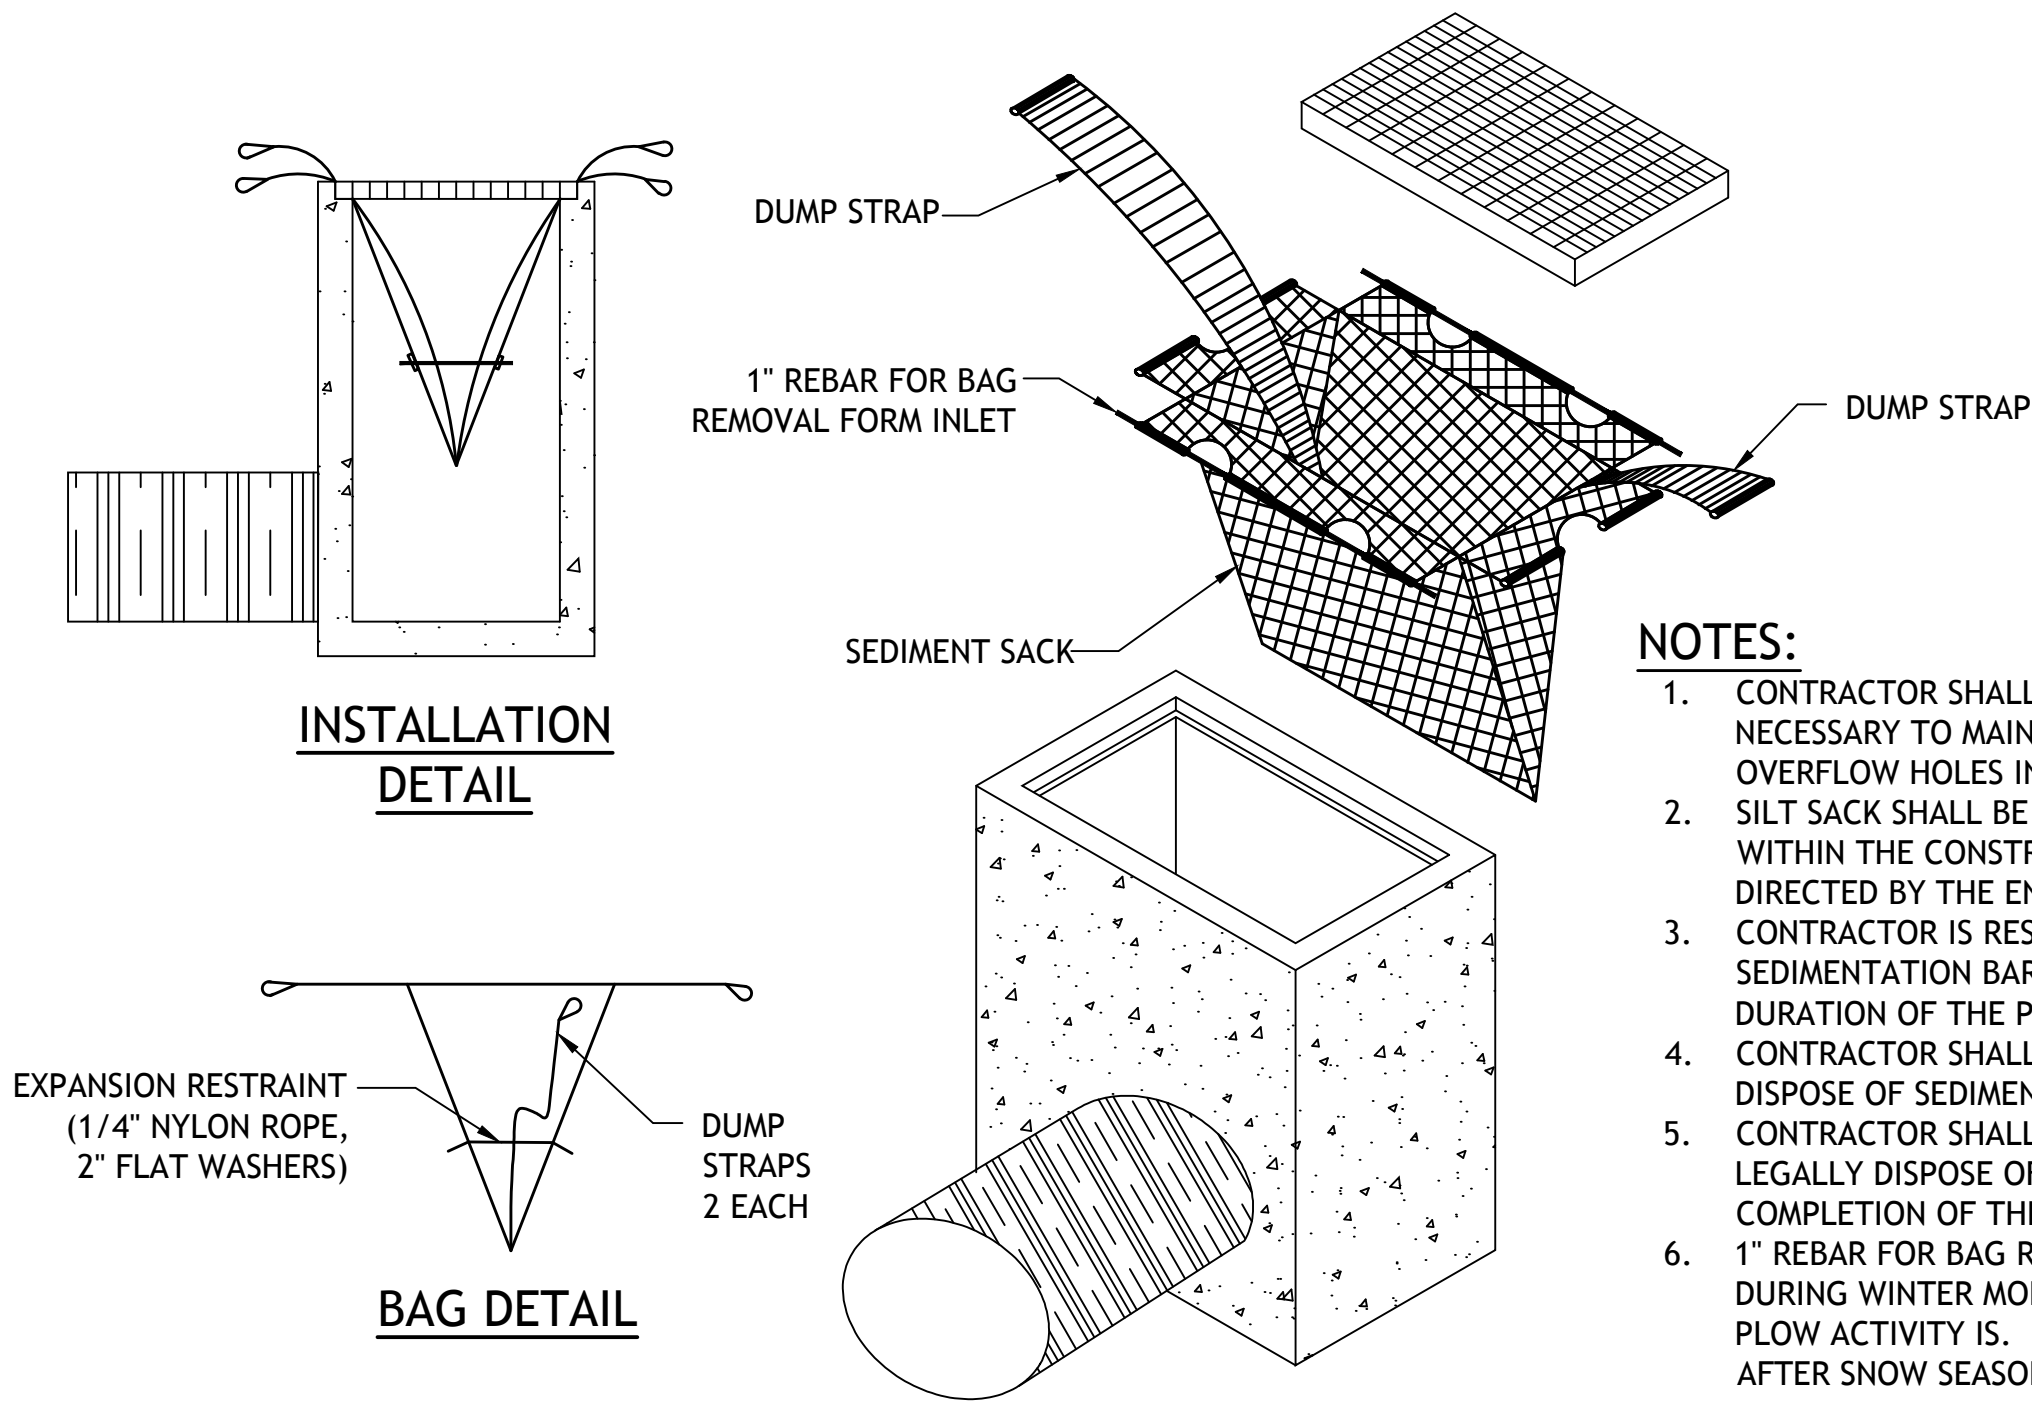

- NOTES:**
1. CONTRACTOR SHALL REMOVE SEDIMENT AS NECESSARY TO MAINTAIN LEVEL BELOW OVERFLOW HOLES IN SILT SACK.
  2. SILT SACK SHALL BE USED ON ALL CATCH BASINS WITHIN THE CONSTRUCTION ZONE OR AS DIRECTED BY THE ENGINEER.
  3. CONTRACTOR IS RESPONSIBLE FOR MAINTAINING SEDIMENTATION BARRIERS THROUGHOUT THE DURATION OF THE PROJECT.
  4. CONTRACTOR SHALL REMOVE AND LEGALLY DISPOSE OF SEDIMENT AS REQUIRED.
  5. CONTRACTOR SHALL REMOVE SILT SACKS AND LEGALLY DISPOSE OF THEM OFF-SITE, UPON COMPLETION OF THE PROJECT AND AS REQUIRED.
  6. 1" REBAR FOR BAG REMOVAL SHALL BE REMOVED DURING WINTER MONTHS AT LOCATIONS WHERE PLOW ACTIVITY IS. BARS SHALL BE REINSTALLED AFTER SNOW SEASON IS COMPLETE.

**CATCH BASIN INLET PROTECTION DETAIL**  
SCALE: N.T.S.

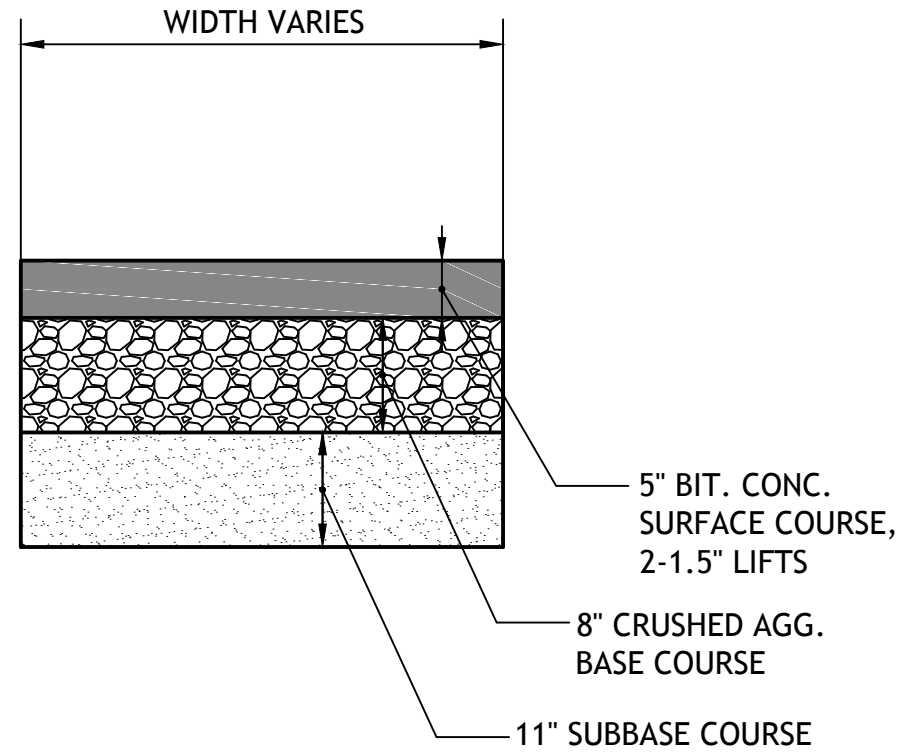

**APRON TYPICAL SECTION**  
SCALE: N.T.S.



NO.	DATE	DESCRIPTION	BY
1	12/2016	ADDED PAVEMENT SECTION MKO	

PROJECT	OWNER
RECONSTRUCT TERMINAL APRONS PHASE I	NEW BEDFORD AIRPORT COMMISSION NEW BEDFORD REGIONAL AIRPORT NEW BEDFORD, MASSACHUSETTS

PROJECT NO.	103-032
CADD FILE	SHEET_DETAILS
DESIGNED BY	MKO
DRAWN BY	MKO
CHECKED BY	RAL
DATE	SEPTEMBER 2016
DRAWING SCALE	N.T.S.

SHEET TITLE	GRAPHIC SCALE
DRAINAGE DETAILS (1 OF 2)	NOT TO SCALE

DRAWING NO.
C2.1
6 OF 8