STS Comments 12-8-2021

# Stormwater Drainage Overflow Shoreline Resources, LLC

26 North Front Street New Bedford, Massachusetts

#### WNFR/APPLICANT

SHORELINE RESOURCES, LLC 137 POPE'S ISLAND NEW BEDFORD, MA 02740

#### CIVII ENGINEER



PARE CORPORATION
NGINEERS - SCIENTISTS - PLANNER
8 BLACKSTONE VALLEY PLACE
LINCOLN, RI 02865
401-334-4100



#### SCALE: N.T.S.

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CITY OF NEW BEDFORD ENGINEERING AND DEPARTMENT OF PUBLIC INFRASTRUCTURE SUBMISSION NOVEMBER 4, 2021

#### <u>REFERENCE</u>

- PROJECT LOCATION: SHORELINE RESOURCES, LLC, 26 NORTH FRONT STREET, NEW BEDFORD, MA 02746.
- EXISTING CONDITIONS MAPPING TAKEN FROM AERIAL AND GPS SURVEY PERFORMED BY CIVILVIEW, INC, A PROFESSIONAL LAND SURVEYOR LICENSED IN THE STATE OF MASSACHUSETTS.
- FORMER FACILITY PIPING PLAN TAKEN FROM 1972 DRAWING TITLED: REVERE COPPER AND BRASS, MILL PIPING, UNDERGROUND DRAIN LINES"; SCALE 1"=40', PREPARED BY REVERE COPPER PRODUCTS, DATED 2-22-72.
- 4. LIMITED EXISTING CONDITIONS INFORMATION OBTAINED BY PARE CORPORATION DURING FIELD VISIT ON JANUARY 12, 2021.

ELEVATIONS ARE PROVIDED BY CIVILVIEW, INC. AND BASED UPON THE NORTH AMERICAN VERTICAL DATUM (NAVD88).

- HORIZONTAL DATUM IS BASED UPON THE MASSACHUSETTS STATE PLANE COORDINATE SYSTEM (NAD83), MAINLAND ZONE PER GPS OBSERVATIONS.
- ACCORDING TO THE FEMA FLOOD INSURANCE RATE MAP (FIRM) FOR BRISTOL COUNTY, MASSACHUSETTS, PANEL 393 OF 550, MAP NO. 25005C0393G, THE SUBJECT PROPERTY IS LOCATED WITHIN THE 100-YEAR FLOODPLAIN, ZONE AE, WITH A DETERMINED ELEVATION OF 6 FEET BASED UPON THE NORTH
- PROPERTY LINES SHOWN ARE APPROXIMATE ONLY, BASED UPON AVAILABLE GIS INFORMATION.

AMERICAN VERTICAL DATUM (NAVD88).

- THE COMMONWEALTH OF MASSACHUSETTS STANDARD SPECIFICATIONS FOR HIGHWAYS AND BRIDGE CONSTRUCTION, 2020 EDITION OR LATEST REVISION, THE MASSACHUSETTS DEPARTMENT OF TRANSPORTATION CONSTRUCTION STANDARD DETAILS AND THE CITY OF NEW BEDFORD DEPARTMENT OF PUBLIC INFRASTRUCTURE (DPI) CONSTRUCTION STANDARDS AND SPECIFICATIONS ARE MADE A PART HEREOF AS FULLY AND COMPLETELY AS IF ATTACHED HERETO. ALL WORK SHALL MEET OR EXCEED THE MASSACHUSETTS AND CITY OF NEW BEDFORD DPI STANDARD SPECIFICATIONS, STANDARDS AND DETAILS, WITH LATEST REVISIONS. THE LATEST REVISION OF THE STANDARD SPECIFICATIONS MAY BE OBTAINED AT THE MASSACHUSETTS DEPARTMENT OF TRANSPORTATION OR THE CITY OF NEW BEDFORD DPI.
- 2. THE CONTRACTOR SHALL MAKE ALL NECESSARY CONSTRUCTION NOTIFICATIONS AND APPLY FOR AND OBTAIN ALL NECESSARY CONSTRUCTION PERMITS, PAY ALL FEES AND POST ALL BONDS ASSOCIATED WITH THE SAME, AND COORDINATE WITH THE ENGINEER AND OWNER'S REPRESENTATIVE AS REQUIRED.
- THE CONTRACTOR SHALL BE SOLELY RESPONSIBLE FOR JOB SITE SAFETY. THE CONTRACTOR SHALL PROVIDE TEMPORARY FENCING AND/OR BARRIERS AROUND ALL OPEN EXCAVATED AREAS IN ACCORDANCE WITH OSHA FEDERAL, STATE, AND LOCAL REQUIREMENTS.
- THE CONTRACTOR SHALL BE RESPONSIBLE FOR VERIFYING THAT THE PROPOSED IMPROVEMENTS SHOWN ON THE PLANS DO NOT CONFLICT WITH ANY KNOWN EXISTING OR OTHER PROPOSED IMPROVEMENTS. IF ANY CONFLICTS ARE DISCOVERED, THE CONTRACTOR SHALL NOTIFY THE OWNER AND THE ENGINEER PRIOR TO INSTALLATION OF ANY PORTION OF THE SITE WORK WHICH WOULD BE AFFECTED. NO FIELD ADJUSTMENTS IN THE LOCATION OF SITE ELEMENTS SHALL BE MADE WITHOUT THE ENGINEERS APPROVAL.
- IF ANY DEVIATION OR ALTERATION OF THE WORK PROPOSED ON THESE DRAWINGS IS REQUIRED, THE CONTRACTOR SHALL IMMEDIATELY CONTACT AND COORDINATE ANY DEVIATIONS WITH THE ENGINEER AND OWNER.
- 6. ANY AREA OUTSIDE OF THE LIMIT OF WORK THAT IS DISTURBED SHALL BE RESTORED TO ITS ORIGINAL CONDITION AT NO ADDITIONAL COST TO THE OWNER.
- ALL SITE WORK SHALL MEET OR EXCEED THE SITE WORK SPECIFICATIONS PREPARED FOR THIS PROJECT.
- 8. ALL SIGNS SHALL BE REFLECTORIZED TYPE III SHEETING AND CONFORM WITH THE MANUAL OF UNIFORM TRAFFIC CONTROL DEVICES, LATEST REVISION.
- 9. ALL UTILITIES (LOCATION AND ELEVATION) DEPICTED SHALL BE CONSIDERED APPROXIMATE ONLY. BEFORE COMMENCING SITE WORK IN ANY AREA, CONTACT "DIG SAFE" AT 1-888-DIG-SAFE (1-888-344-7233) TO ACCURATELY LOCATE UNDERGROUND UTILITIES. ALL DAMAGE TO EXISTING UTILITIES OR STRUCTURES, AND THE COST TO REPAIR THE DAMAGES TO INITIAL CONDITIONS, AS SHOWN ON THE PLANS SHALL BE THE CONTRACTOR'S RESPONSIBILITY.
- 10. NO EXCAVATION SHALL BE DONE UNTIL COMPANIES ARE PROPERLY NOTIFIED IN ADVANCE. NOTE THAT NOT ALL EXISTING UNDERGROUND UTILITIES ARE SHOWN. IT IS THE CONTRACTOR'S RESPONSIBILITY TO CONTACT ALL RESPECTIVE UTILITY COMPANIES TO VERIFY AND LOCATE EXISTING UTILITIES.

- 1. ALL LINES ARE PERPENDICULAR OR PARALLEL TO THE LINES FROM WHICH THEY ARE MEASURED UNLESS OTHERWISE INDICATED.
- PRIOR TO COMMENCING WORK, THE CONTRACTOR SHALL PERFORM BENCHMARK FIELD LEVEL VERIFICATION AND COORDINATE LAYOUT CHECK. THE CONTRACTOR SHALL CONTACT PARE CORPORATION IF ANY DISCREPANCIES ARE FOUND.
- DIMENSIONS OF PARKING SPACES AND DRIVEWAYS ARE FROM FACE OF CURB TO FACE OF CURB. DIMENSIONS FROM BUILDING ARE FROM FACE OF BUILDING
- ALIGN WALKWAYS ON DOORWAYS THEY SERVE TO PROVIDE MINIMUM REQUIRED MANEUVERING CLEARANCE IN ACCORDANCE WITH THE AMERICAN WITH DISABILITIES ACT (ADA) ACCESSIBILITY GUIDELINES AND CODE OF MASSACHUSETTS REGULATIONS (CMR) TITLE 521 OF THE ARCHITECTURAL ACCESS BOARD

#### **DEMOLITION NOTES**

- THE CONTRACTOR SHALL COORDINATE ALL DEMOLITION OF STRUCTURES, PAVEMENT AND CONCRETE MATERIALS, AND UTILITIES WITH APPROPRIATE PROPOSED SITE GENERAL, GRADING, UTILITY, AND LANDSCAPING DRAWINGS.
- ALL NOTED UTILITIES TO BE REMOVED AND DISPOSED OF, RELOCATED OR CAPPED REPRESENT ALL KNOWN SITE CONDITIONS TO BE DEMOLISHED. THE CONTRACTOR SHALL COORDINATE ALL UNFORESEEN CONDITIONS WITH THE PROJECT ENGINEER, OWNER AND/OR RESPECTIVE UTILITY COMPANIES PRIOR TO
- WATER, SEWER, DRAINAGE, GAS, AND OTHER SITE UTILITIES SERVICING THE EXISTING FACILITIES ARE TO REMAIN ACTIVE THROUGHOUT CONSTRUCTION.
- 4. THERE SHALL BE NO INTERRUPTION OF UTILITY SERVICES DURING THE CONSTRUCTION OPERATION WITHOUT APPROVAL OF THE OWNER.

#### GRADING AND UTILITY NOTES

- UNDERGROUND UTILITIES DEPICTED WERE COMPILED FROM AVAILABLE RECORD PLANS AND SHALL BE CONSIDERED APPROXIMATE ONLY. BEFORE COMMENCING SITE WORK IN ANY AREA, CONTACT "DIG SAFE" AT 1-888-DIG-SAFE (1-888-344-7233) TO ACCURATELY LOCATE UNDERGROUND UTILITIES. ANY DAMAGE TO EXISTING UTILITIES OR STRUCTURES DEPICTED OR NOT DEPICTED ON THE PLANS SHALL BE THE CONTRACTOR'S RESPONSIBILITY. COSTS TO REPAIR SUCH DAMAGES SHALL BE THE CONTRACTOR'S RESPONSIBILITY. NO EXCAVATION SHALL BE DONE UNTIL UTILITY COMPANIES ARE PROPERLY NOTIFIED.
- ALL WORK PERFORMED AND ALL MATERIALS FURNISHED SHALL CONFORM WITH THE LINES AND GRADES ON THE PLANS AND SITE WORK SPECIFICATIONS.
- AT ALL LOCATIONS WHERE EXISTING CURBING OR PAVEMENT ABUT NEW CONSTRUCTION, THE EDGE OF THE EXISTING CURB OR PAVEMENT SHALL BE SAW CUT TO A CLEAN, SMOOTH EDGE. BLEND NEW PAVEMENT AND CURBS SMOOTHLY INTO EXISTING BY MATCHING LINES, GRADES AND JOINTS.
- ALL UTILITY COVERS, GRATES, ETC. SHALL BE ADJUSTED TO BE FLUSH WITH THE SURROUNDING SURFACE OR PAVEMENT FINISH GRADE. RIM ELEVATIONS OF
- STRUCTURES AND MANHOLES ARE APPROXIMATE. FINAL ELEVATIONS ARE TO BE SET FLUSH AND CONSISTENT WITH THE GRADING PLANS. 5. THE CONTRACTOR SHALL MAKE ALL ARRANGEMENTS FOR THE ALTERATION OF PRIVATE UTILITIES BY THE UTILITY COMPANIES, AS REQUIRED.
- WHERE AN EXISTING UTILITY IS FOUND TO CONFLICT WITH THE PROPOSED WORK, THE LOCATION, ELEVATION AND SIZE OF THE UTILITY SHALL BE
- ACCURATELY DETERMINED WITHOUT DELAY BY THE CONTRACTOR AND THE INFORMATION SHALL BE PROVIDED ON A SKETCH TO SCALE OF THE EXISTING UTILITY WITH TIES TO KNOWN POINTS, PHOTOS AND FURNISHED TO THE ENGINEER FOR RESOLUTION.
- THE CONTRACTOR SHALL PROTECT ALL UNDERGROUND DRAINAGE, SEWER AND UTILITY FACILITIES FROM EXCESSIVE VEHICULAR LOADS DURING CONSTRUCTION. ANY DAMAGE TO THESE FACILITIES RESULTING FROM CONSTRUCTION LOADS SHALL BE RESTORED TO ORIGINAL CONDITION.
- GAS, ELECTRIC, AND COMMUNICATIONS ROUTING ARE SUBJECT TO REVIEW AND APPROVAL BY APPROPRIATE UTILITY COMPANIES.
- DURING CONSTRUCTION OPERATIONS, THE CONTRACTOR SHALL PROTECT EXISTING UTILITIES BY PROVIDING TEMPORARY SUPPORTS OR SHEETING AS REQUIRED AT NO ADDITIONAL COST TO THE OWNER.
- 10. ALL WATER LINE BENDS AND TEES SHALL BE REINFORCED WITH THREST BLOCKS. ALL WATER DISTRIBUTION PIPING AND FITTINGS MUST ADHERE TO THE CITY OF NEW BEDFORD WATER SPECIFICATIONS AND SHALL BE INSPECTED BEFORE, DURING, AND AFTER CONSTRUCTION PRIOR TO TAPPING THE SERVICE
- 11. EXCAVATION REQUIRED WITHIN THE PROXIMITY OF EXISTING UTILITY LINES SHALL BE DONE BY HAND. CONTRACTOR SHALL REPAIR ANY DAMAGE TO EXISTING UTILITY LINES OR STRUCTURES INCURRED DURING CONSTRUCTION OPERATIONS AT NO COST TO THE OWNER.
- 12. PITCH EVENLY BETWEEN SPOT GRADES. ALL PAVED AREAS MUST PITCH TO DRAIN AT A MIN. OF 1/8" PER FOOT UNLESS SPECIFIED.

**Restrained Joints** 

#### EROSION AND SEDIMENTATION CONTROL NOTES - MASSACHUSETTES

- 1. THE CONTRACTOR SHALL BE RESPONSIBLE FOR ESTABLISHING AND MAINTAINING ALL TEMPORARY SOIL EROSION AND SEDIMENT CONTROLS IN ACCORDANCE WITH THE ENVIRONMENTAL PROTECTION AGENCY'S (EPA) NATIONAL POLLUTANT DISCHARGE ELIMINATION SYSTEM (NPDES) CONSTRUCTION GENERAL PERMIT
- 2. THE CONTRACTOR SHALL ADHERE TO THE REQUIREMENTS OF THE PROJECT ORDER OF CONDITIONS PURSUANT TO MASSDEP FILE NO SE 049-0867 ISSUED MAY 6, 2021 AND THE CITY OF NEW BEDFORD SPECIAL CONDITIONS 21 THROUGH 51.
- 3. SOIL EROSION AND SEDIMENTATION CONTROLS SHALL BE PROVIDED IN ACCORDANCE WITH THE "MASSACHUSETTS EROSION AND SEDIMENT CONTROL GUIDELINES FOR URBAN AND SUBURBAN AREAS" AND THE NOTES AND DETAILS SHOWN IN THIS PLAN SET.
- THE EROSION AND SEDIMENTATION CONTROLS SHOWN ON THE PLANS ARE INTENDED TO REPRESENT THE MINIMUM CONTROLS NECESSARY TO MEET ANTICIPATED SITE CONDITIONS. ADDITIONAL MEASURES SHALL BE IMPLEMENTED AS CONDITIONS WARRANT OR AS DIRECTED BY THE OWNER OR OWNER'S
- REQUIRED PERIMETER CONTROL SHALL BE PROPERLY ESTABLISHED, CLEARLY VISIBLE AND IN OPERATION PRIOR TO INITIATING ANY LAND CLEARING ACTIVITY AND/OR OTHER CONSTRUCTION RELATED WORK. SUCH FACILITIES SHALL REPRESENT THE LIMIT OF WORK. WORKERS SHALL BE INFORMED THAT NO CONSTRUCTION ACTIVITY IS TO OCCUR BEYOND THE LIMIT OF WORK AT ANY TIME THROUGHOUT THE CONSTRUCTION PERIOD.
- 6. AS FEASIBLE, CONSTRUCTION SHALL BE PHASED TO LIMIT THE AREA OF EXPOSED SOIL AND THE DURATION OF EXPOSURE. ALL DISTURBED AREAS SHALL BE TEMPORARILY AND/OR PERMANENTLY STABILIZED WITHIN 14 DAYS FOLLOWING COMPLETION OF GRADING ACTIVITIES.
- THE CONTRACTOR SHALL INSPECT AND MAINTAIN ALL EROSION AND SEDIMENTATION CONTROL MEASURES FOR THE DURATION OF THE SUBJECT WORK CONTAINED HEREIN AND UNTIL SUCH TIME A CERTIFICATE OF COMPLIANCE IS RENDERED BY THE LOCAL CONSERVATION COMMISSION.
- EROSION AND SEDIMENTATION CONTROL MEASURES SHALL BE INSPECTED AND MAINTAINED ON A WEEKLY BASIS AND AFTER EACH STORM EVENT OF 0.25 INCH OR GREATER DURING CONSTRUCTION TO ENSURE THAT THE EROSION CONTROL BARRIERS ARE INTACT.
- 9. CLEAN AND MAINTAIN SEDIMENTATION CONTROL BARRIERS WHEN SEDIMENT ACCUMULATES TO ONE HALF THE HEIGHT OF THE BARRIER. MATERIAL COLLECTED FROM THE SEDIMENTATION BARRIER SHALL BE REMOVED AS NECESSARY AND DISPOSED IN AN UPLAND AREA.

10. THE CONTRACTOR SHALL MAINTAIN A SUFFICIENT RESERVE OF VARIOUS EROSION CONTROL MATERIALS ONSITE AT ALL TIMES FOR EMERGENCY PURPOSES OR

- 11. THE CONTRACTOR SHALL SCHEDULE HIS WORK TO ALLOW THE FINISHED SUB GRADE ELEVATIONS TO DRAIN PROPERLY WITHOUT PUDDLING. SPECIFICALLY, ALLOW WATER TO ESCAPE WHERE PROPOSED CURB MAY RETAIN RUNOFF PRIOR TO PAVING. PROVIDE TEMPORARY POSITIVE DRAINAGE, AS REQUIRED, TO
- 12. SOIL AND OTHER MATERIALS RESULTING FROM SITE CLEARING MAY BE RECYCLED AND/OR REUSED ON THE SITE AS APPROPRIATE. WASTE MATERIALS SHALL
- BE REMOVED FROM THE SITE. AND DISPOSED OF IN ACCORDANCE WITH ALL LOCAL, STATE AND FEDERAL REQUIREMENTS T3. DUST SHALL BE CONTROLLED BY SPRINKLING OR OTHER APPROVED METHODS AS NECESSARY, OR AS DIRECTED BY THE OWNER OR OWNER'S

REPRESENTATIVE. DPI MAY DIRECT OWNER/CONTRACTOR TO CONDUCT STREET SWEEPING AS REQUIRED

- 14. CATCH BASINS AND STORM DRAINS SHALL BE PROTECTED WITH HAY BALES OR SEDIMENT BAGS IN PAVED AREAS UNTIL CONTRIBUTING AREA IS
- 15. DEWATERING WASTEWATER PUMPED FROM EXCAVATIONS SHALL BE CONVEYED BY HOSE TO AN UPLAND AREA AND DISCHARGED INTO A DEWATERING BASIN OR HAY BALE CORRALS. DEWATERING FLUIDS CONTAINING ANY OILS MUST BE DISCHARGED THROUGH AN OIL-WATER SEPARATION BAG OR SYSTEM PRIOR TO DISCHARGE INTO THE AFOREMENTIONED BASINS OR CORRALS. ALL DEWATERING OPERATIONS SHALL BE DONE SO IN
- 16. CONSTRUCTION SITE WASTE MATERIALS SHALL BE PROPERLY CONTAINED ONSITE AND BISPOSED OF LITEPAT ROUGE FOR THE MICHAILE SHALL BE PROPERLY CONTAINED ON SITE AND BISPOSED OF LITERAL WASTE MATERIALS SHALL BE PROPERLY CONTAINED ON SITE AND BISPOSED OF LITERAL WASTE MATERIALS SHALL BE PROPERLY CONTAINED ON SITE AND BISPOSED OF LITERAL WASTE MATERIALS. AND STATE REGULATIONS.
- 17. RIPRAP OR OTHER ENERGY DISSIPATERS SHALL BE USED WHERE NECESSARY TO CONTROL EROSION. 18. ANY EQUIPMENT THAT IS NOT READILY MOBILE (TRACK MACHINERY) SHALL BE PARKED WITHIN THE PROJECT LIMIT OF DISTURBANCE. LARGE AND/OR BULKY
- MATERIALS SHALL BE STORED SUCH THAT THEY DO NOT INTERFERE WITH THE ONGOING CONSTRUCTION ACTIVITIES OR EROSION CONTROL MEASURES. 19. THE CONTRACTOR SHALL NOT REMOVE ANY COMPOST FILTER SOCKS OR OTHER EROSION CONTROLS UNTIL THE CONTRIBUTING AREA IS PERMANENTLY
- STABILIZED AND A CERTIFICATE OF COMPLIANCE IS RECEIVED FROM THE LOCAL CONSERVATION COMMISSION. 20. CRUSHED STONE CONSTRUCTION ENTRANCE AS DETAILED SHALL BE INSTALLED AND MAINTAINED AT ALL SITE

#### STORMWATER-MANAGEMENT SYSTEM INSPECTION AND MAINTENANCE NOTES

#### THE CONTRACTOR SHALL REMOVE SEDIMENT AND DEBRIS FROM ALL CATCH BASINS, MANHOLES, AND THE DRAINAGE SYSTEM ON A ROUTHEE BASIS, IMMEDIATELY FOLLOWING SITE STABILIZATION, AND PRIOR TO PROJECT COMPLETION AND ACCEPTANCE.

- THE CLOSED DRAINAGE SYSTEM AND ASSOCIATED STRUCTURES SHALL BE CLEANED AND FLUSHED BY THE CONTRACTOR AT THE COMPLETION OF CONSTRUCTION, AND THE CONTRACTOR SHALL BE RESPONSIBLE FOR INSPECTION AND MAINTENANCE OF THE DRAINAGE SYSTEM UNTIL ACCEPTANCE OF THE SYSTEM BY THE ENGINEER AND THE CITY OF NEW BEDFORD. FOLLOWING ACCEPTANCE OF THE PROPOSED DRAINAGE SYSTEM, THE OWNER OF THE SITE SHALL BE RESPONSIBLE FOR THE LONG-TERM INSPECTION AND MAINTENANCE OF THE DRAINAGE SYSTEM.
- ANY ACCUMULATION OF PONDING WATER IN AREAS WITHIN THE LIMITS OF DISTURBANCE, OTHER THAN DESIGNATED AREAS, SHALL BE REMOVED ACCORDINGLY AND PREVENTED IN THE FUTURE.

#### POST CONSTRUCTION (OWNER'S RESPONSIBILITY)

DURING CONSTRUCTION (CONTRACTOR'S RESPONSIBILITY)

- TRASH, LITTER, SEDIMENT AND OTHER DEBRIS SHALL BE REMOVED FROM ANY STORMWATER MANAGEMENT SYSTEM FACILITY (INCLUDING BUT NOT LIMITED TO CATCH BASINS, MANHOLES, INLET, OUTLET AND DIVERSION STRUCTURES, AND STORMWATER BEST MANAGEMENT PRACTICES (BMPs)) A MINIMUM OF TWO TIMES PER YEAR. PREFERABLY IN THE SPRING AND FALL.
- 2. THE PARKING LOT AND ENTRY DRIVE SHALL BE SWEPT BY THE OWNER AS EARLY AS POSSIBLE EVERY SPRING AND ONCE IN THE FALL TO REMOVE
- 3. ALL CLEANING AND MAINTENANCE OF STORMWATER MANAGEMENT SYSTEMS POST-CONSTRUCTION SHALL BE THE RESPONSIBILITY OF THE OWNER.

#### General Comments:

- 1. Isn't there an approved O&M plan through the NOI and the City's SMRR for these assets?
- 2. This drain line is owned by the City. There needs to be an easement in
- place for this pipeline so that the City can access it in the future. Refer to the SMRR for specific requirements. Coordinate with DPI.

#### Define what this is.

owner.

This statement doesn't make sense. The City owns the drains, outfall, manholes and — \*\* — \*\* — \*\* tide gate. Any catch basins are under the ownership and

# (ATG) = ADJUST TO GRADECLF = CHAIN LINK FENCE

CC ) = CUT AND CAPCM ) = SAWCUT AND MATCH (CTE) = CONNECT TO EXISTING

DAC = REMOVE AND DISPOSE ASPHALT CURB DCLF = REMOVE CHAIN LINK FENCE

DCP = REMOVE AND DISPOSE CONCRETE PAD DD ) = REMOVE AND DISPOSE DRAINAGE

DS ) = REMOVE AND DISPOSE SEWER

HMA ) = HOT MIXED ASPHALT PAVEMENT (SEE DETAIL) R&D = REMOVE AND DISPOSE

responsibility of the property

CFS = COMPOST FILTER SOCK (SEE DETAIL)

NO. OF PARKING SPACES

DFP = REMOVE AND DISPOSE FLEXIBLE PAVEMENT

TIP = TEMPORARY INLET PROTECTION

WETLAND EDGE 50' PERIMETER WETLAND 200' RIVERBANK UTILITY DEMOLITION

**LEGEND** 

PROPERTY LINE

SETBACKS

EASEMENT LINE

CONTOUR

SPOT ELEVATION

DRAINAGE LINE

WATER LINE

FIRE WATER LINE

SANITARY SEWER LINE

GAS LINE

ELECTRIC

TELEPHONE LINE

OVERHEAD ELECTRIC LINE

LIMIT OF DISTURBANCE

CATCH BASIN

HYDRANT

DRAINAGE MANHOLE

SEWER MANHOLE

UTILITY POLE

WATER VALVE

GAS GATE

LIGHT POLE

TREE LINE

STONE WALL

CHAIN LINK FENCE

CURBING

EDGE OF PAVEMEN

SAWCUT LINE

SIGN

COMPOST FILTER SOCK

EXISTING

X 407.5

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GG 🔘

— OHW —

PROPOSED

× (261.5)

\_\_\_\_D \_\_\_\_D \_\_\_\_D \_\_\_

ADA = AMERICANS WITH DISABILITIES ACT ASSF = AREA SUBJECT TO STORM FLOWAGE BM = BENCHMARK BMP = BEST MANAGEMENT PRACTICE BIT. = BITUMINOUS

BOT. = BOTTOMCI = CAST IRONCB = CATCH BASIN, 4' DIA. UNLESS OTHERWISE NOTED CL. = CLASSCMR = CODE OF MASSACHUSETTS REGULATIONS

HDPE = HIGH DENSITY POLYETHYLENE PIPE

CONC. = CONCRETE DEMO = DEMOLITION DIA = DIAMETER DIP = DUCTILE IRON PIPE DMH = DRAIN MANHOLE

EOP = EDGE OF PAVEMENT  $ELEV_{,EL} = ELEVATION$ EX, EXIST. = EXISTINGFFE = FINISH FLOOR ELEVATION FT = FOOT

GTD = GRADE TO DRAIN

HYD = HYDRANTI.D. = INNER DIAMETER INV. = INVERT LOD = LIMIT OF DISTURBANCE

LP = LOW POINT MUTCD = MANUAL OF UNIFORM TRAFFIC CONTROL DEVICES. LATEST EDITION MAX. = MAXIMUMMIN. = MINIMUM

NTS, N.T.S. = NOT TO SCALE OWS = OIL WATER SEPARATOR PERF. = PERFORATED PE = POLYETHYLENE PVC = POLYVINYL CHLORIDE

> R=X'=RADIUSRCP = REINFORCED CONCRETE PIPE MASSDEP = MASSACHUSETTS DEPARTMENT OF ENVIRONMENTAL PROTECTION MASSDOT = MASSACHUSETTS DEPARTMENT OF TRANSPORTATION

M.A. STD. = MASSACHUSETTS STANDARD SMH = SEWER MANHOLE SESC = SOIL EROSION AND SEDIMENT CONTROL TP = TEST PITTYP. = TYPICAL

UP = UTILITY POLE VC = VITRIFIED CLAY w/ = WITH



**OWNER/APPLICANT:** 

SCALE ADJUSTMENT GUIDE BAR IS ONE INCH ON ORIGINAL DRAWING

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**\$** 0

REVISIONS:


PROJECT NO.: 20109 NOVEMBER 2021 SCALE: AS NOTED DESIGNED BY: ACT CHECKED BY: DL DRAWN BY: APPROVED BY: ADH


LEGEND & **ABBREVIATIONS** 


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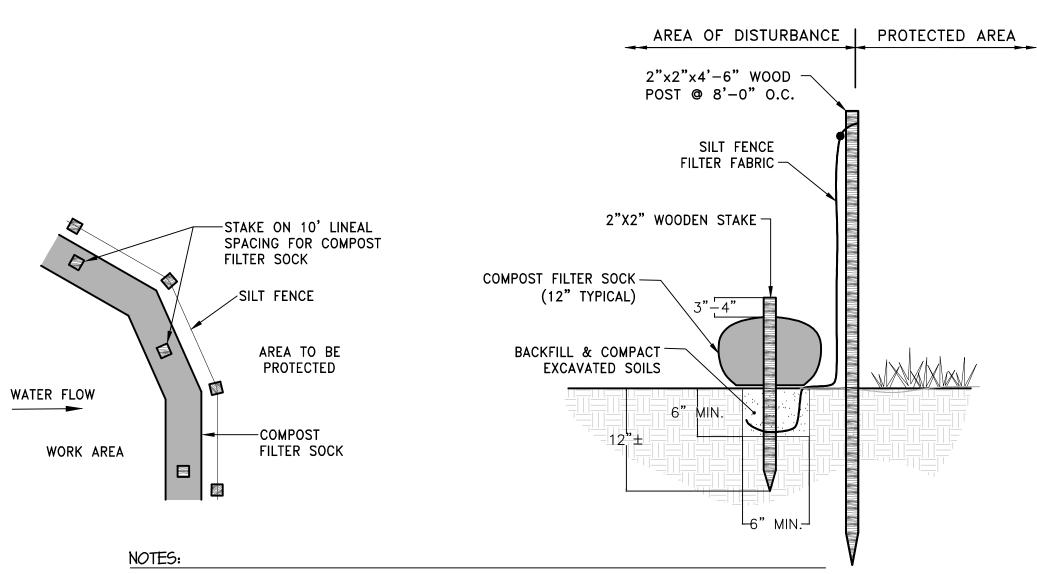
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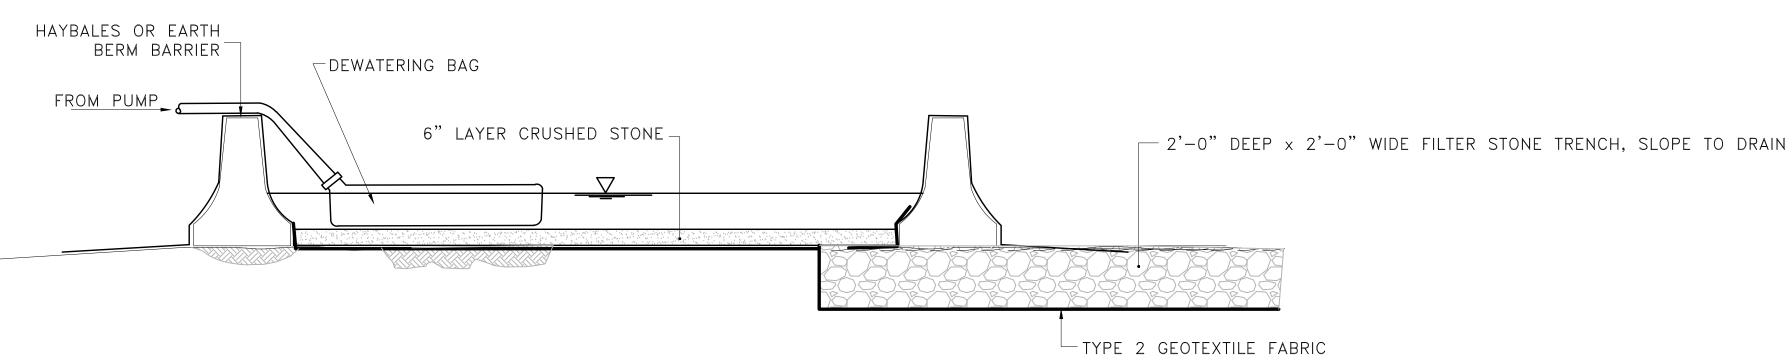




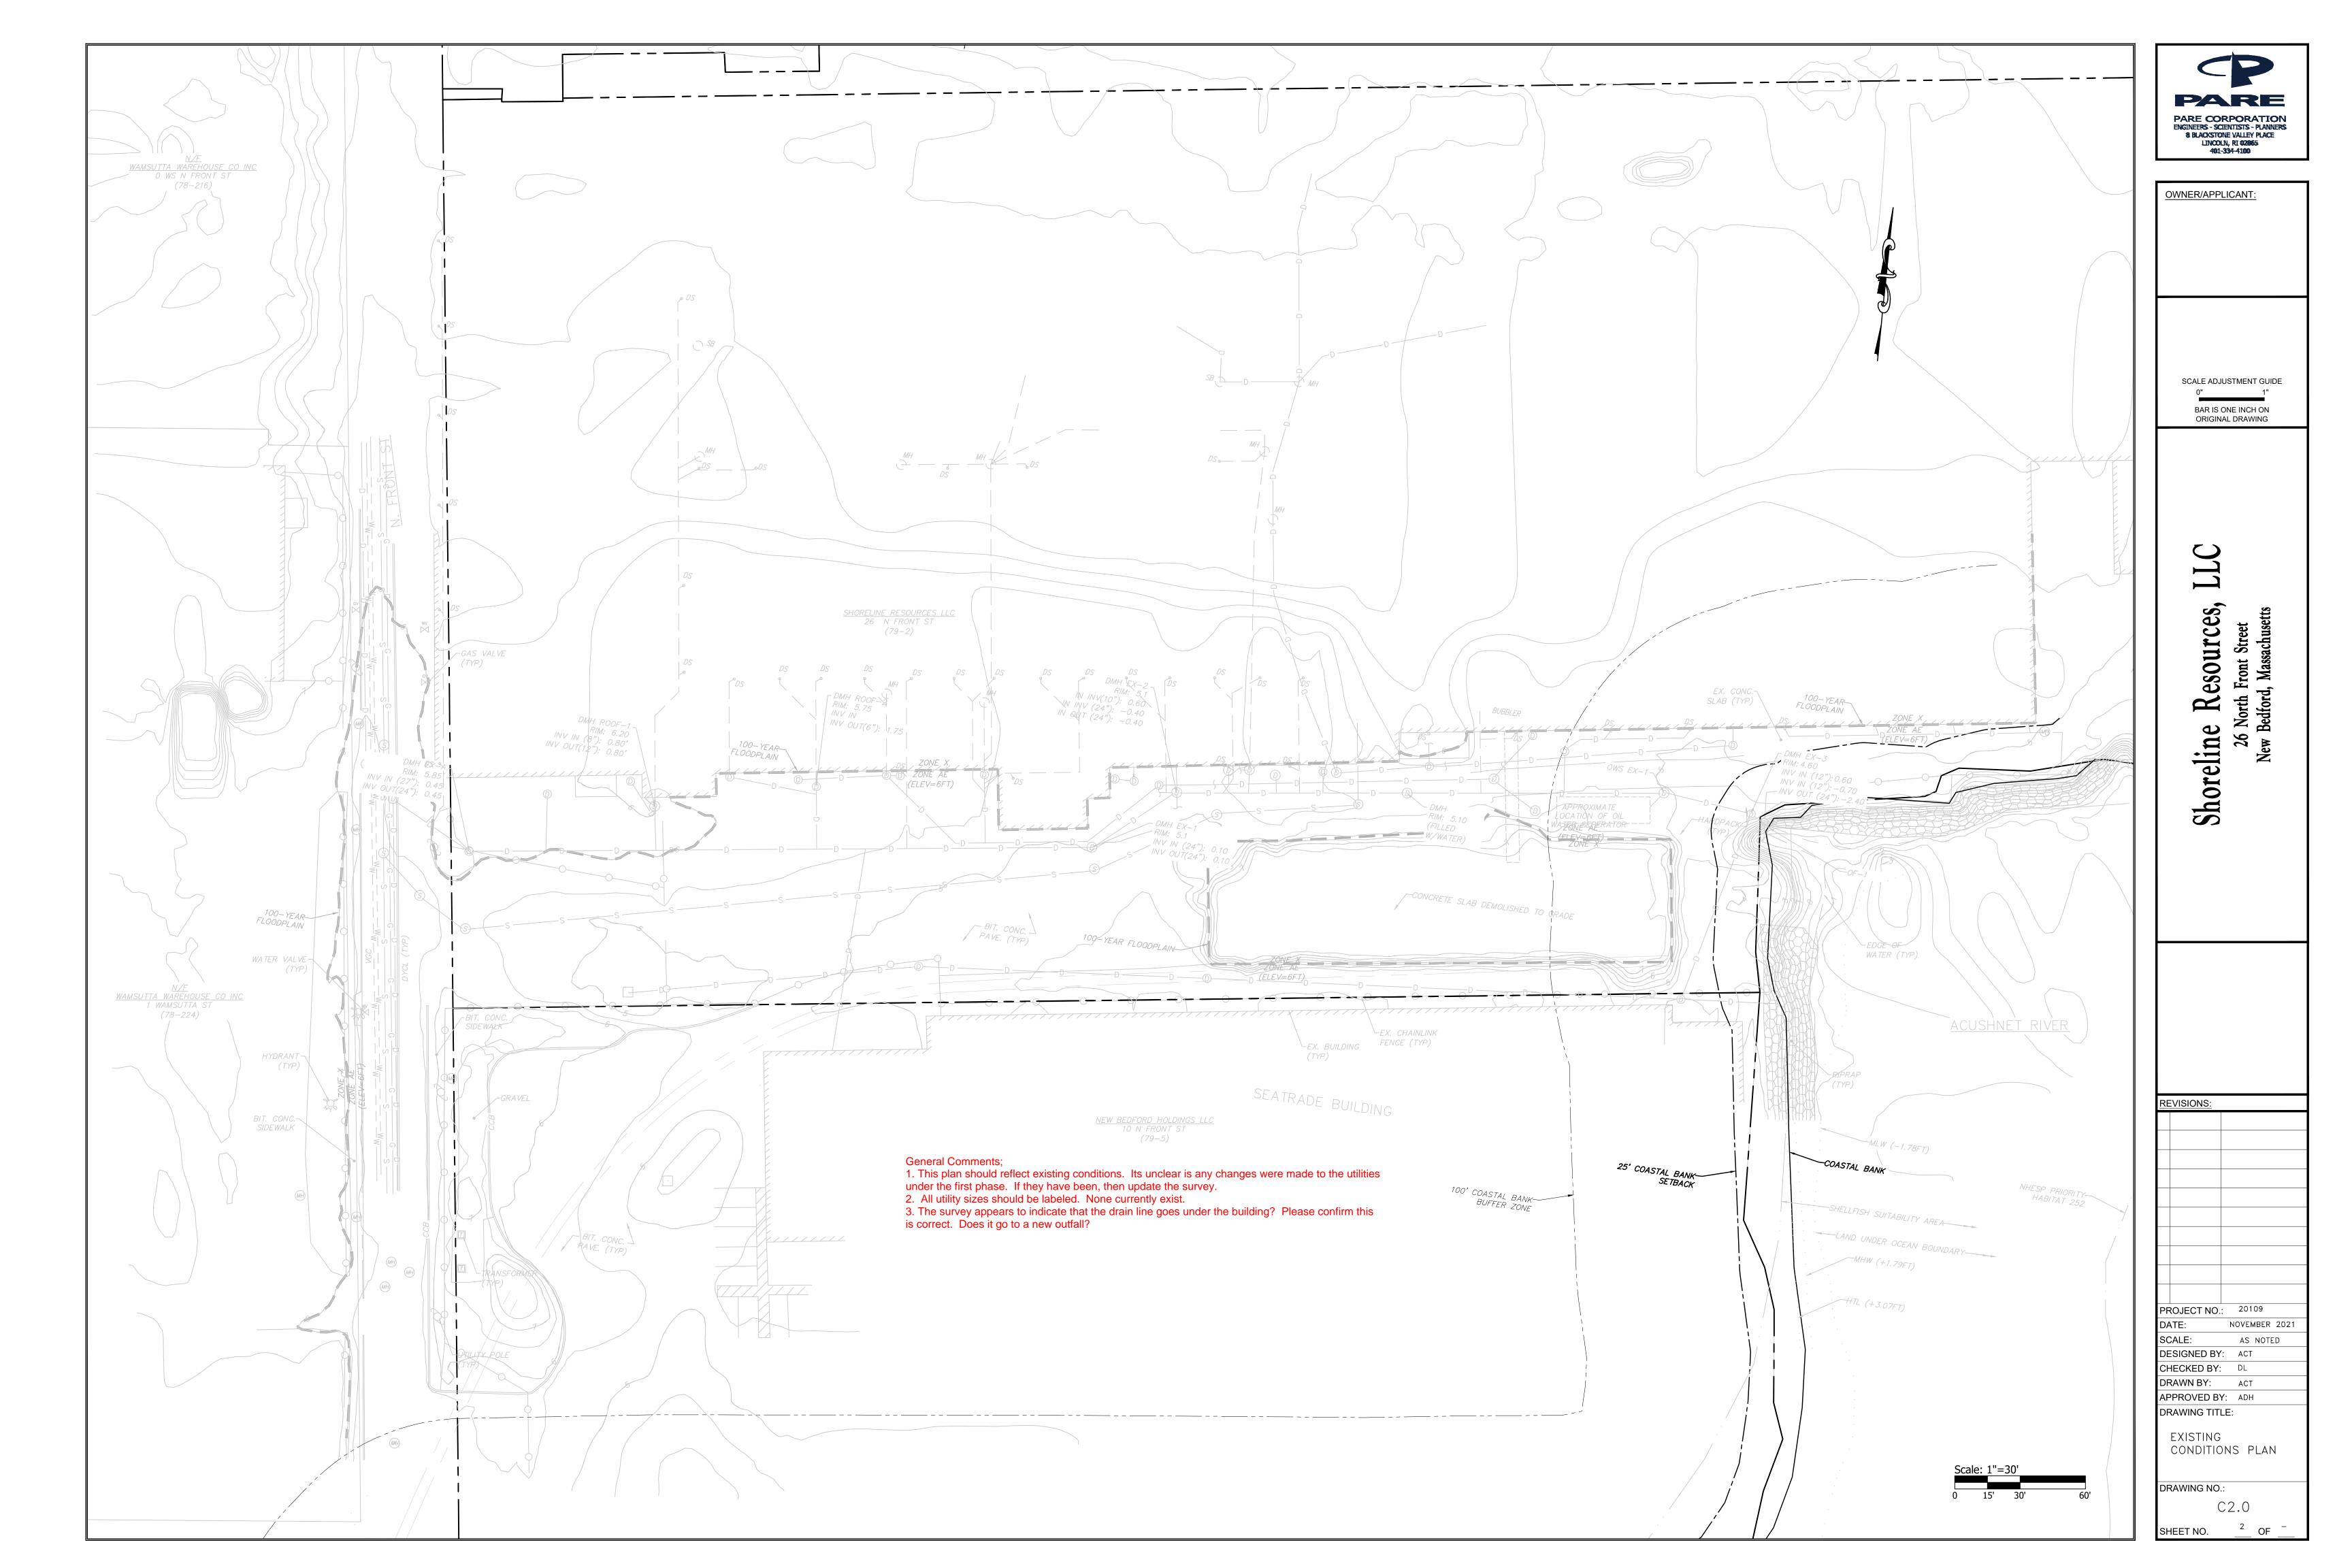

- 1. COMPOST/ SOIL/ ROCK/ SEED FILL TO MEET APPLICATION REQUIREMENTS.
- 2. COMPOST MATERIAL TO BE REMOVED OR DISPERSED ON SITE AS DETERMINED BY ENGINEER.
- 3. IF SOCK NETTING MUST BE JOINED, FIT BEGINNING OF NEW SOCK OVER END OF OLD SOCK, OVERLAPPING BY 2 FEET AND STACK OVERLAP. IF SOCK NETTING IS NOT JOINED, OVERLAP OLD SOCK WITH NEW ONE BY A MINIMUM OF 2 FEET.
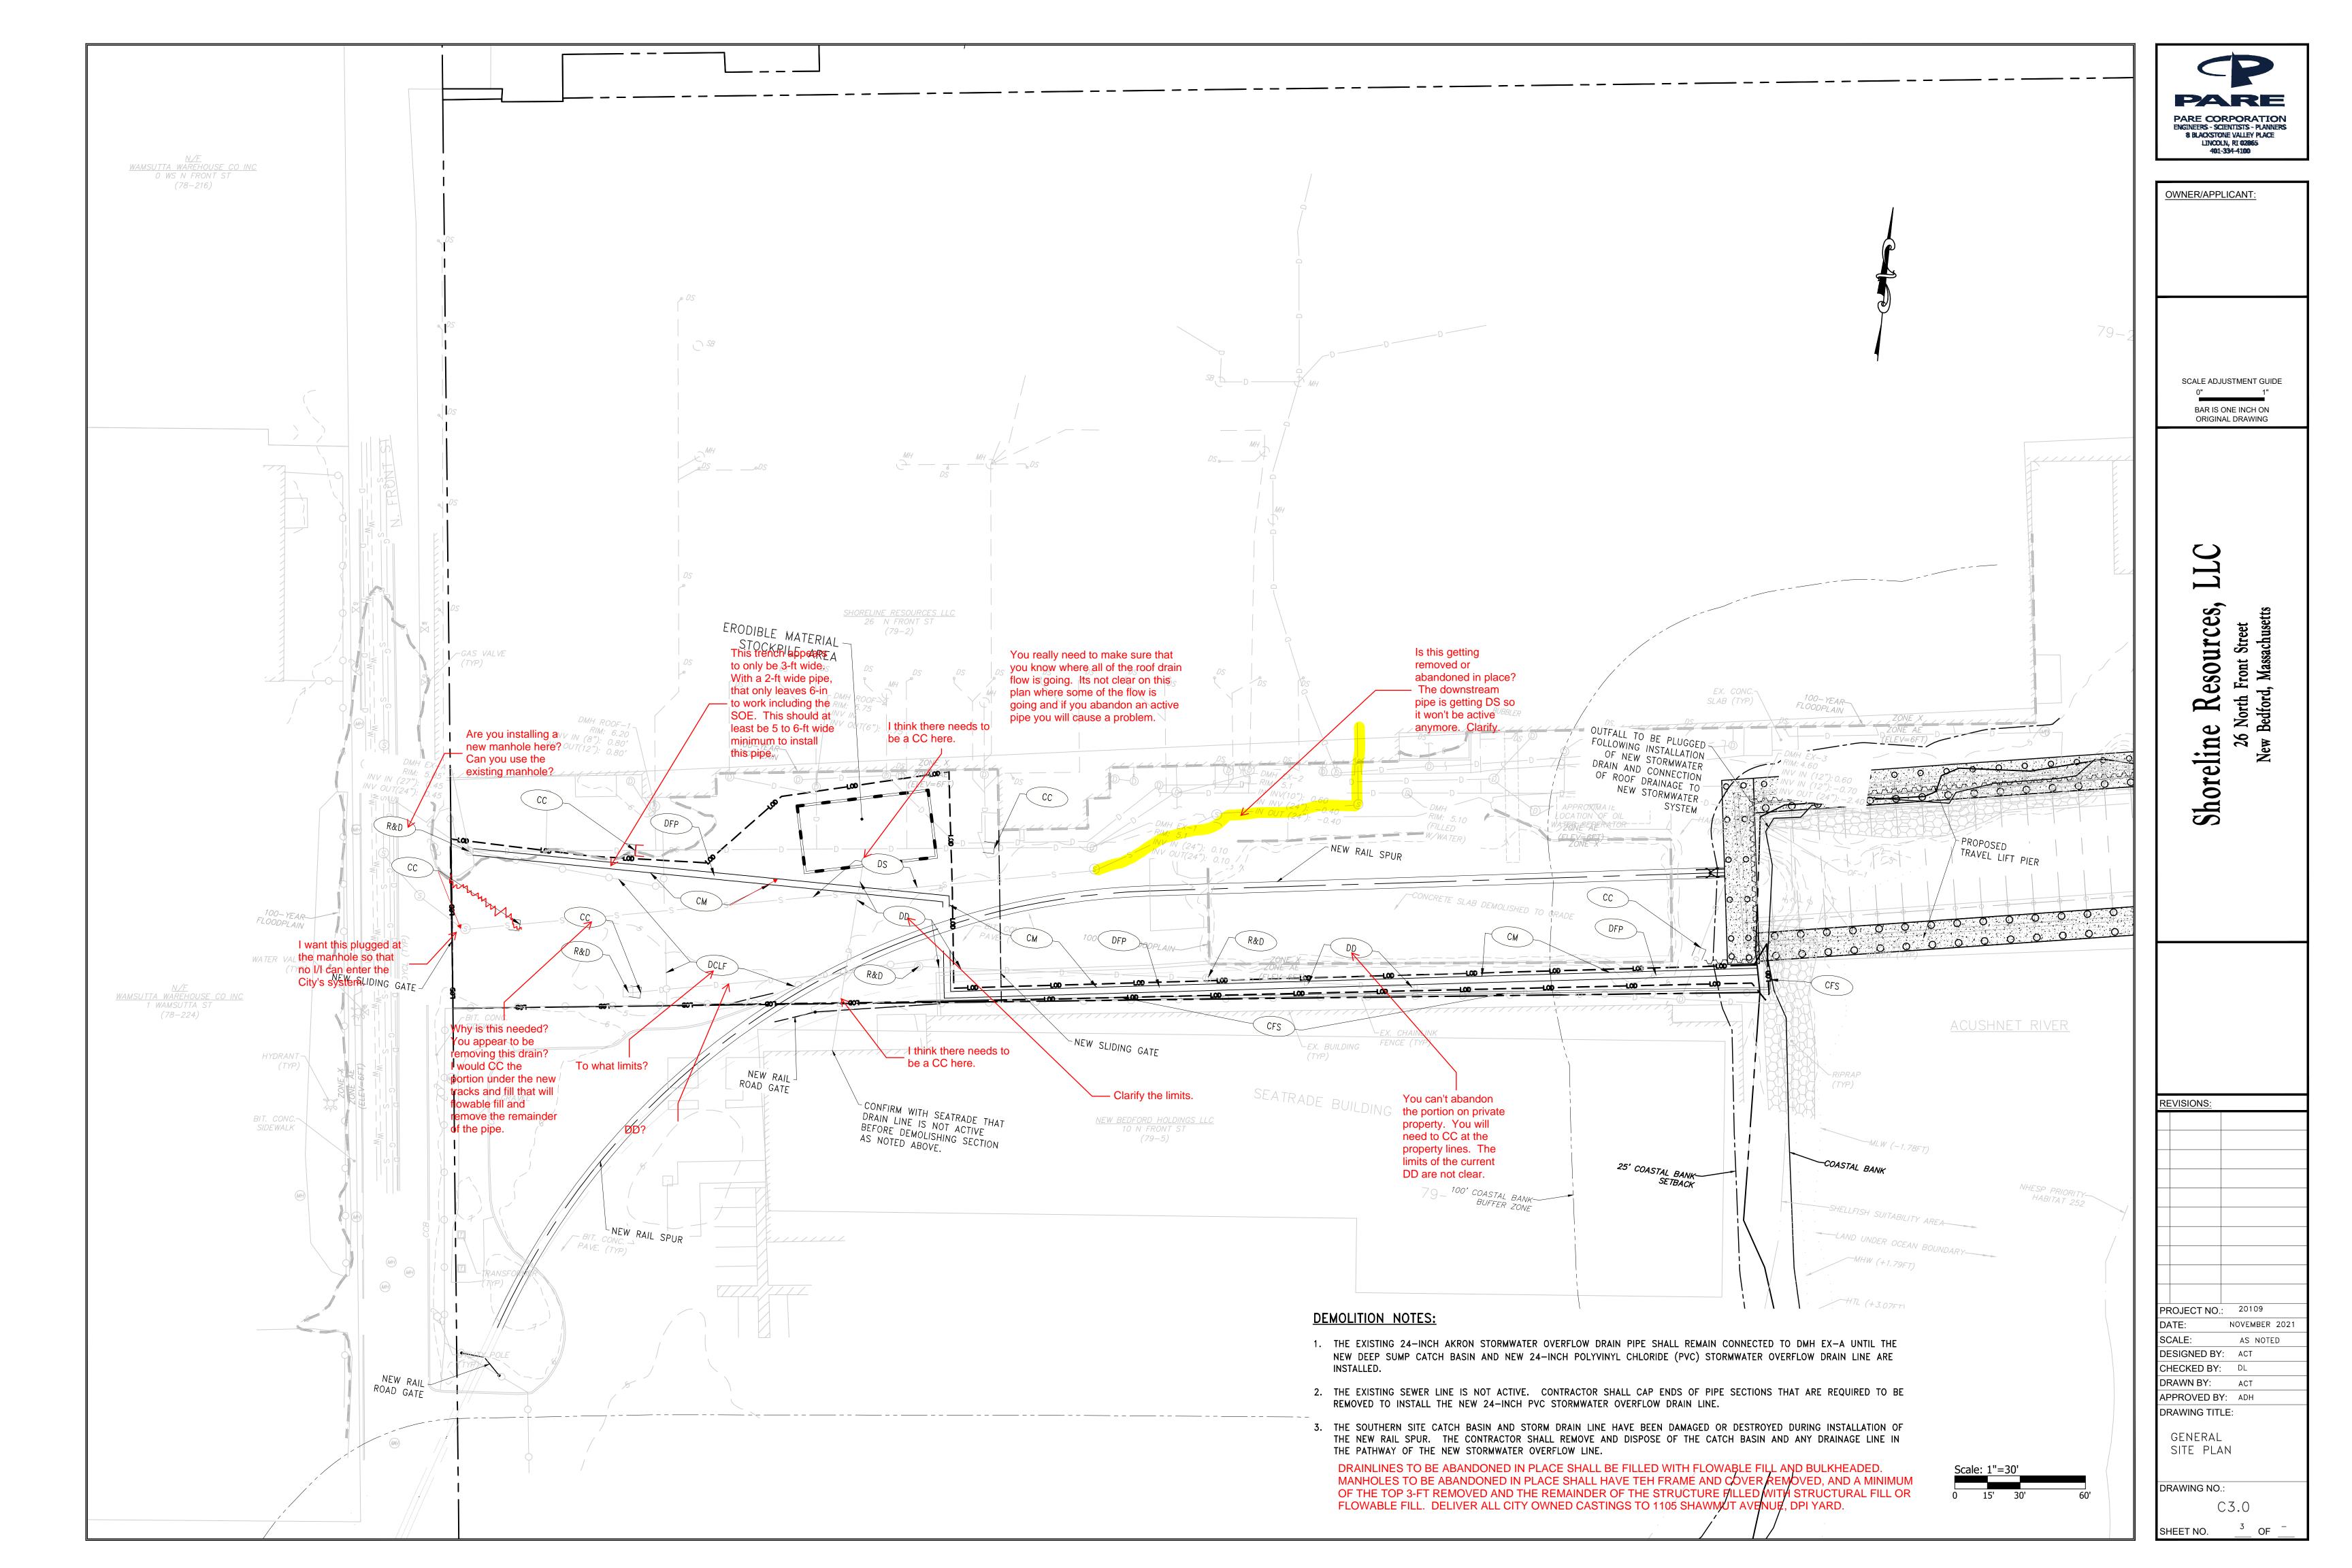
# COMPOST FILTER SOCK WITH SILT FENCE DETAIL NOT TO SCALE

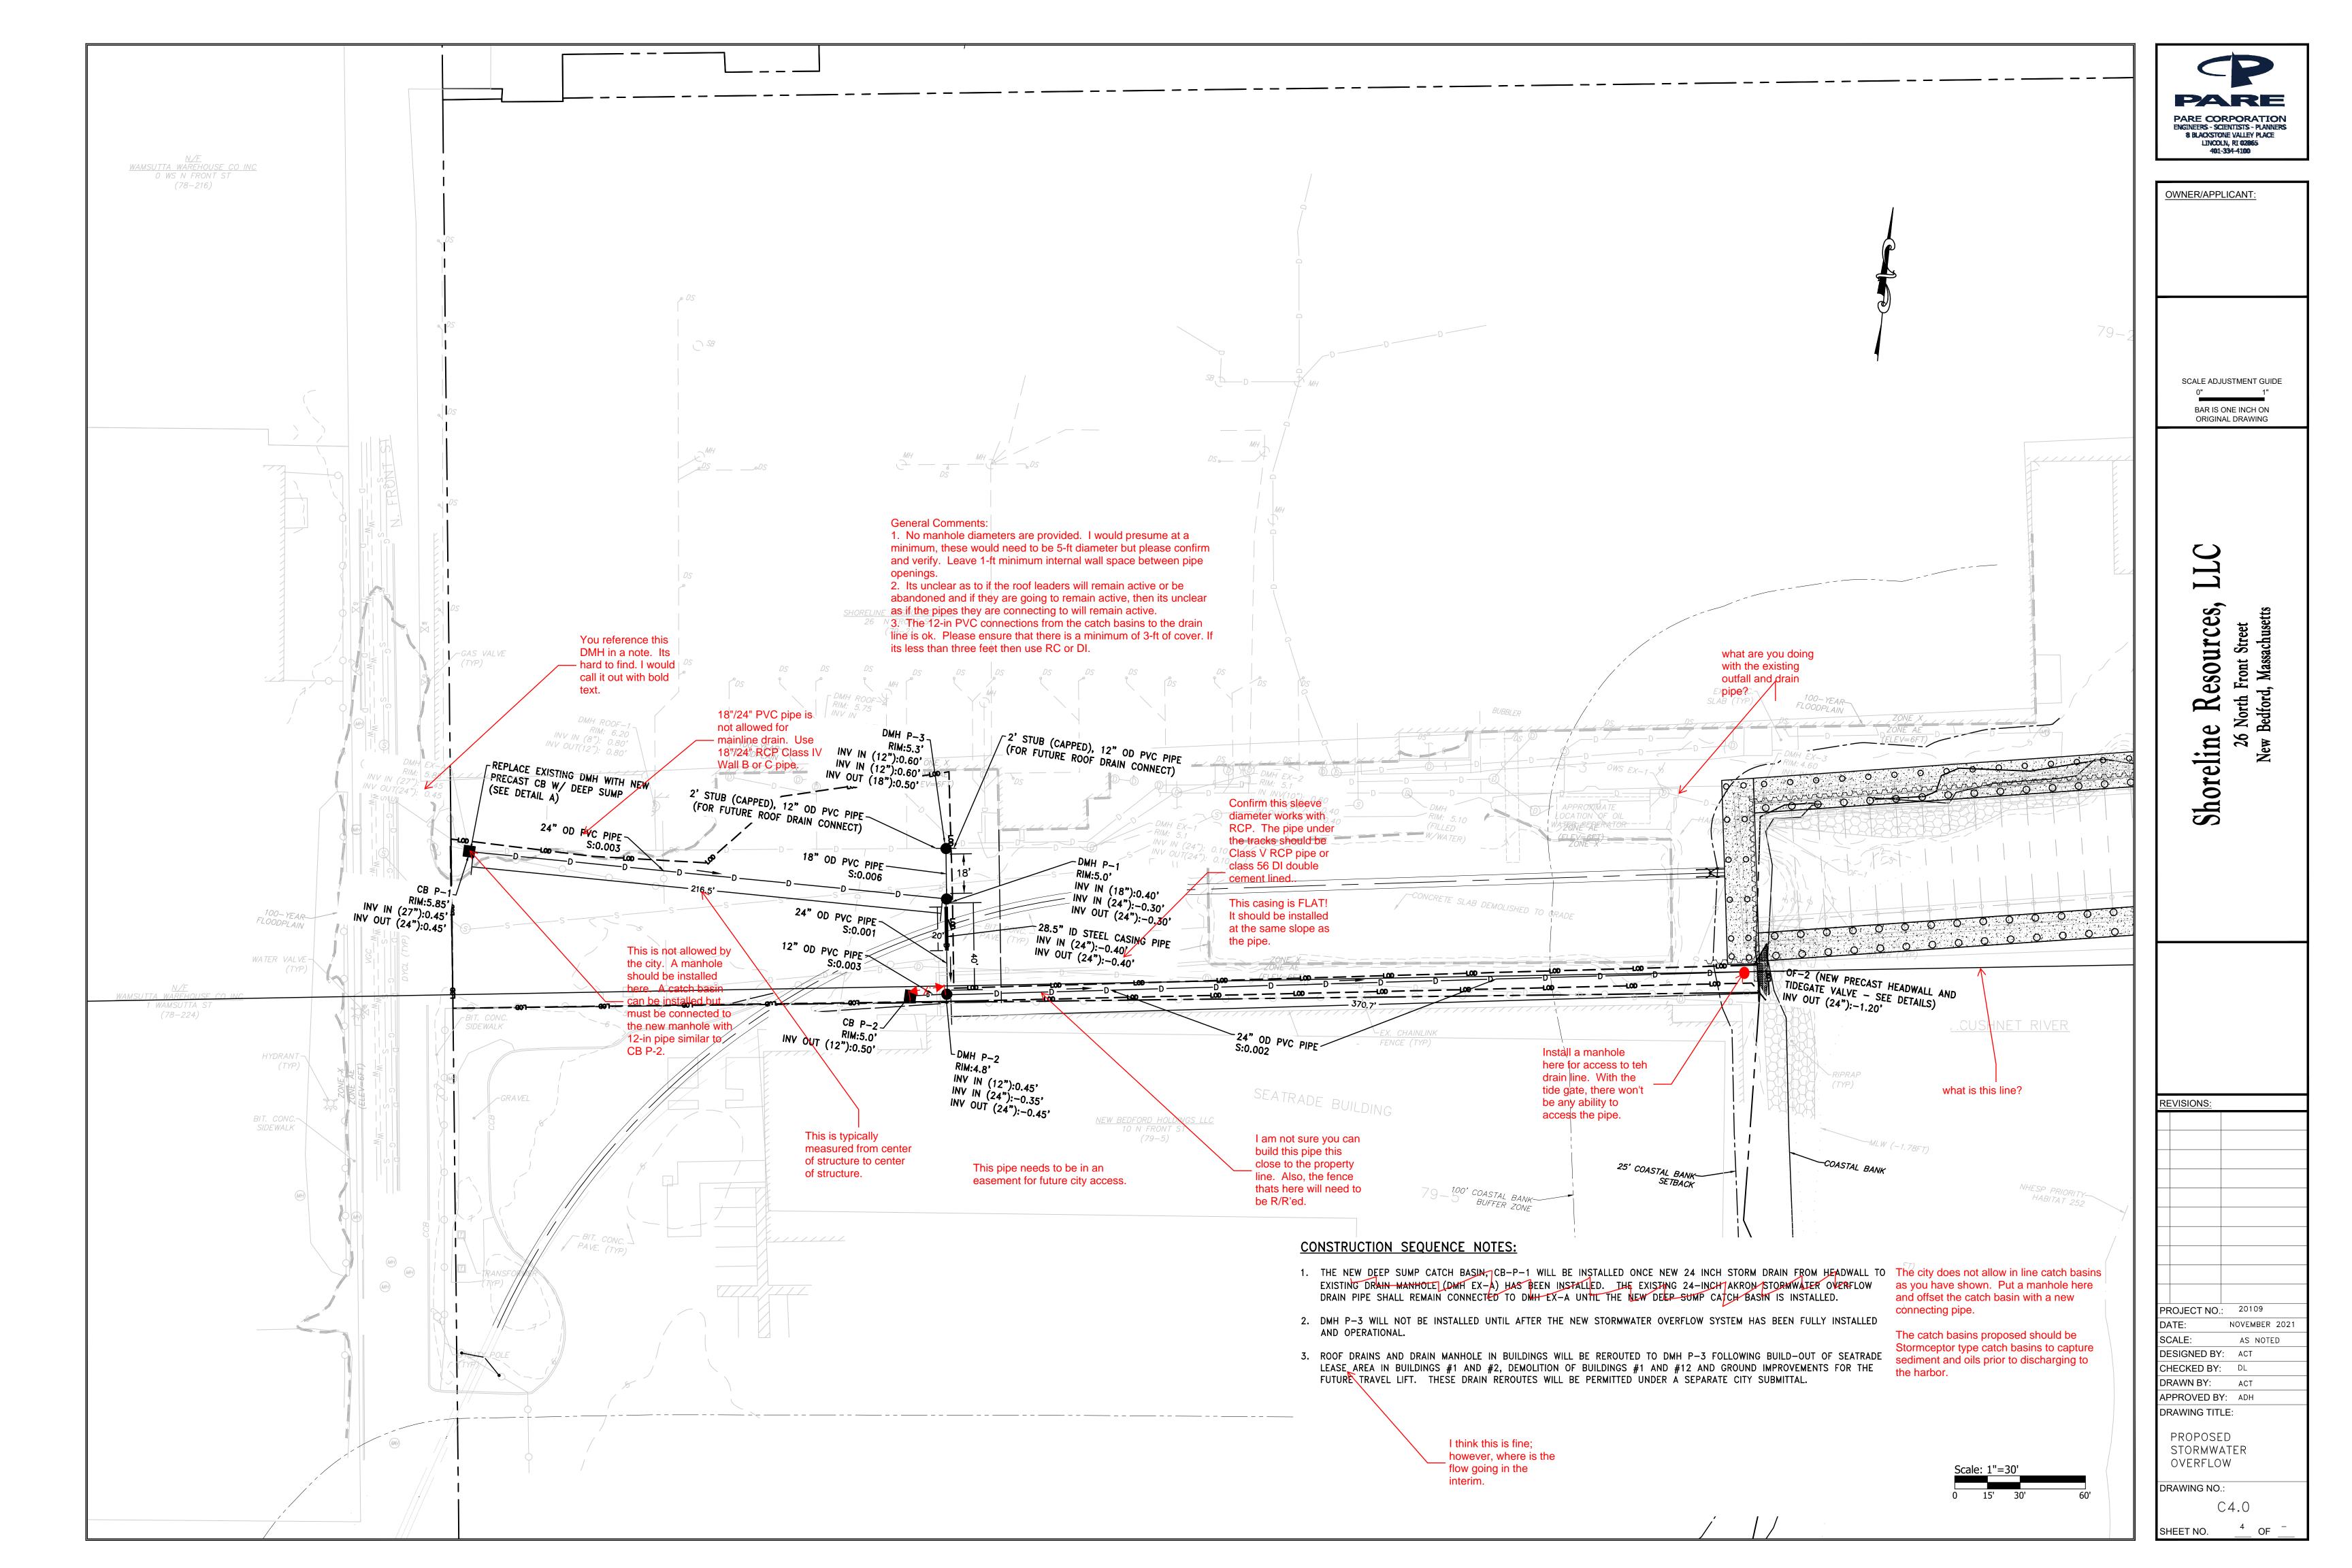


NOTE:

CONTRACTOR TO PERIODICALLY REMOVE SILT AND STONE AT TRENCH DRAIN TO PROMOTE FLOW OF WATER FROM BASIN. ALTERNATIVELY AN OUTFLOW WEIR MAY BE SUBMITTED FOR APPROVAL.


#### FILTER FABRIC DEWATERING BASIN DETAIL

NOT TO SCALE

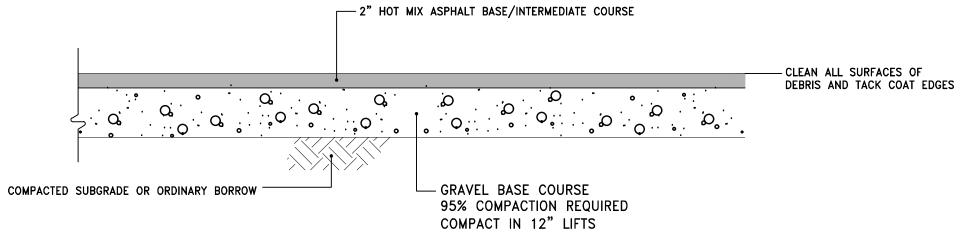


HOT MIX ASPHALT PAVEMENT DETAIL

NOT TO SCALE

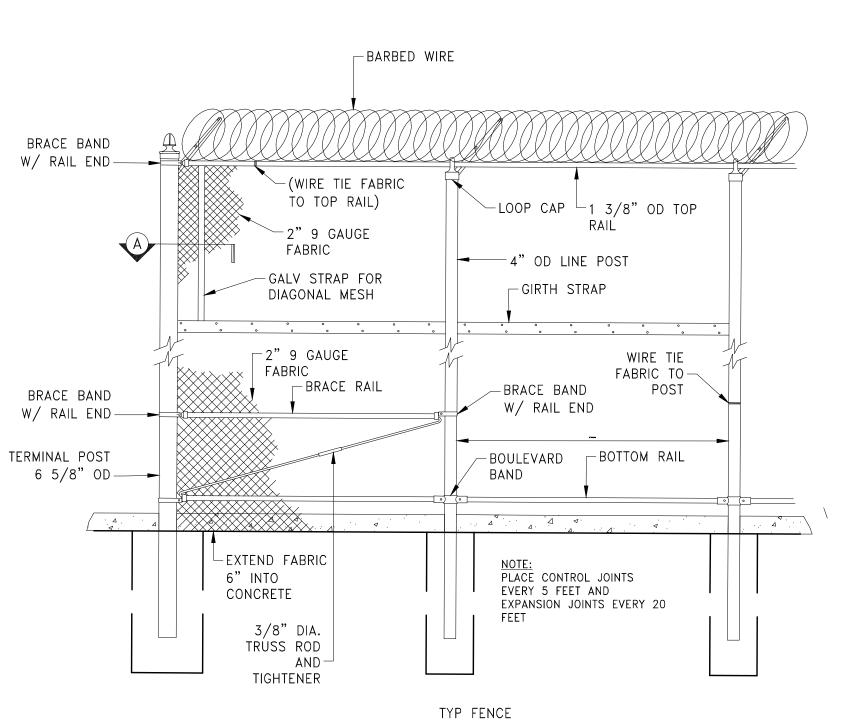

ELEVATION (NOT TO

SCALÈ)

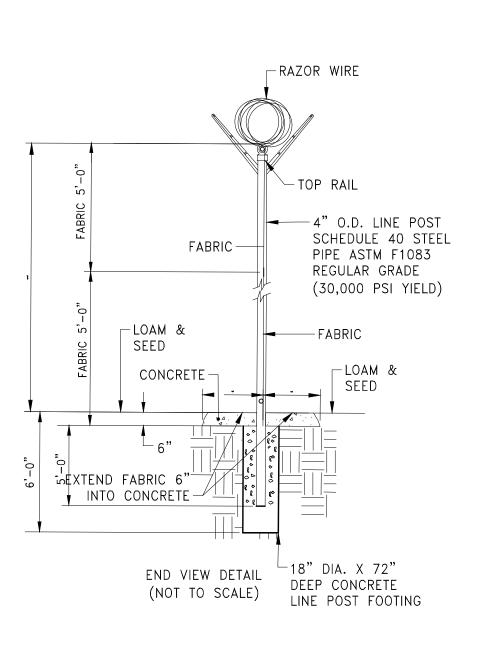

CHAIN LINK FENCE & GATE

NOT TO SCALE

-PROVIDE TEMPORARY SEED (SEE NOTE 3)

−60' MAX.−

ERODIBLE MATERIAL STOCKPILE

NOT TO SCALE

ALL STOCKPILE AREAS.

1. PRIOR TO CONSTRUCTION THE CONTRACTOR SHALL PREPARE A PLAN SHOWING THE PROPOSED LOCATION OF

3. STOCKPILED ERODIBLE MATERIAL THAT WILL NOT BE USED FOR GREATER THAN 14 DAYS SHALL BE STABILIZED WITH TEMPORARY SEED IMMEDIATELY FOLLOWING PLACEMENT. USE MASSDOT STD. M6.03.1 EROSION SEED).

2. STOCKPILE AREA SHALL NOT EXCEED SPECIFIED DIMENSIONS WITHOUT APPROVAL FROM ENGINEER.

COMPOST FILTER SOCK

ENCIRCLING TOE

PARE CORPORATION
ENGINEERS - SCIENTISTS - PLANNERS
8 BLACKSTONE VALLEY PLACE
LINCOLN, RI 92865
401-334-4100

OWNER/APPLICANT:

SCALE ADJUSTMENT GUIDE
0" 1"

0" 1"
BAR IS ONE INCH ON
ORIGINAL DRAWING

Shoreline Resources, I

REVISIONS:

PROJECT NO.: 20109

DATE: NOVEMBER 2021

SCALE: AS NOTED

DESIGNED BY: ACT

CHECKED BY: DL

DRAWN BY: ACT

APPROVED BY: ADH


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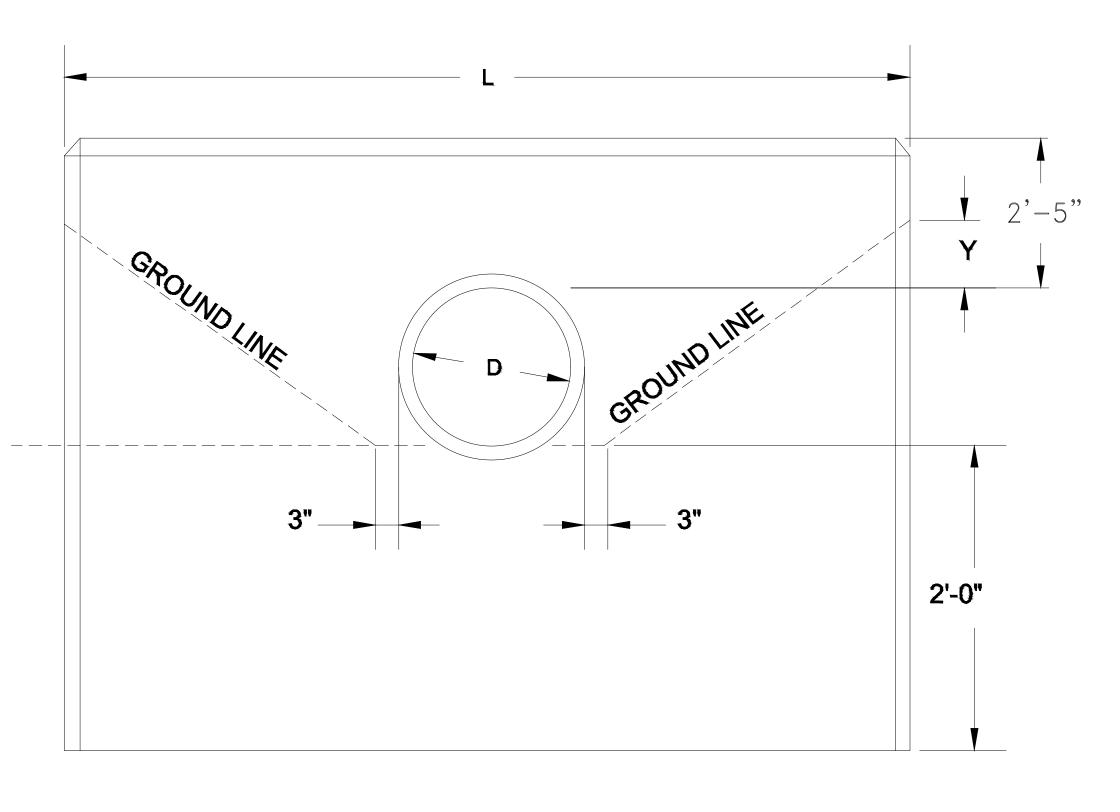
DETAIL 1


DRAWING NO.:

C5.1

SHEET NO. 5 OF -



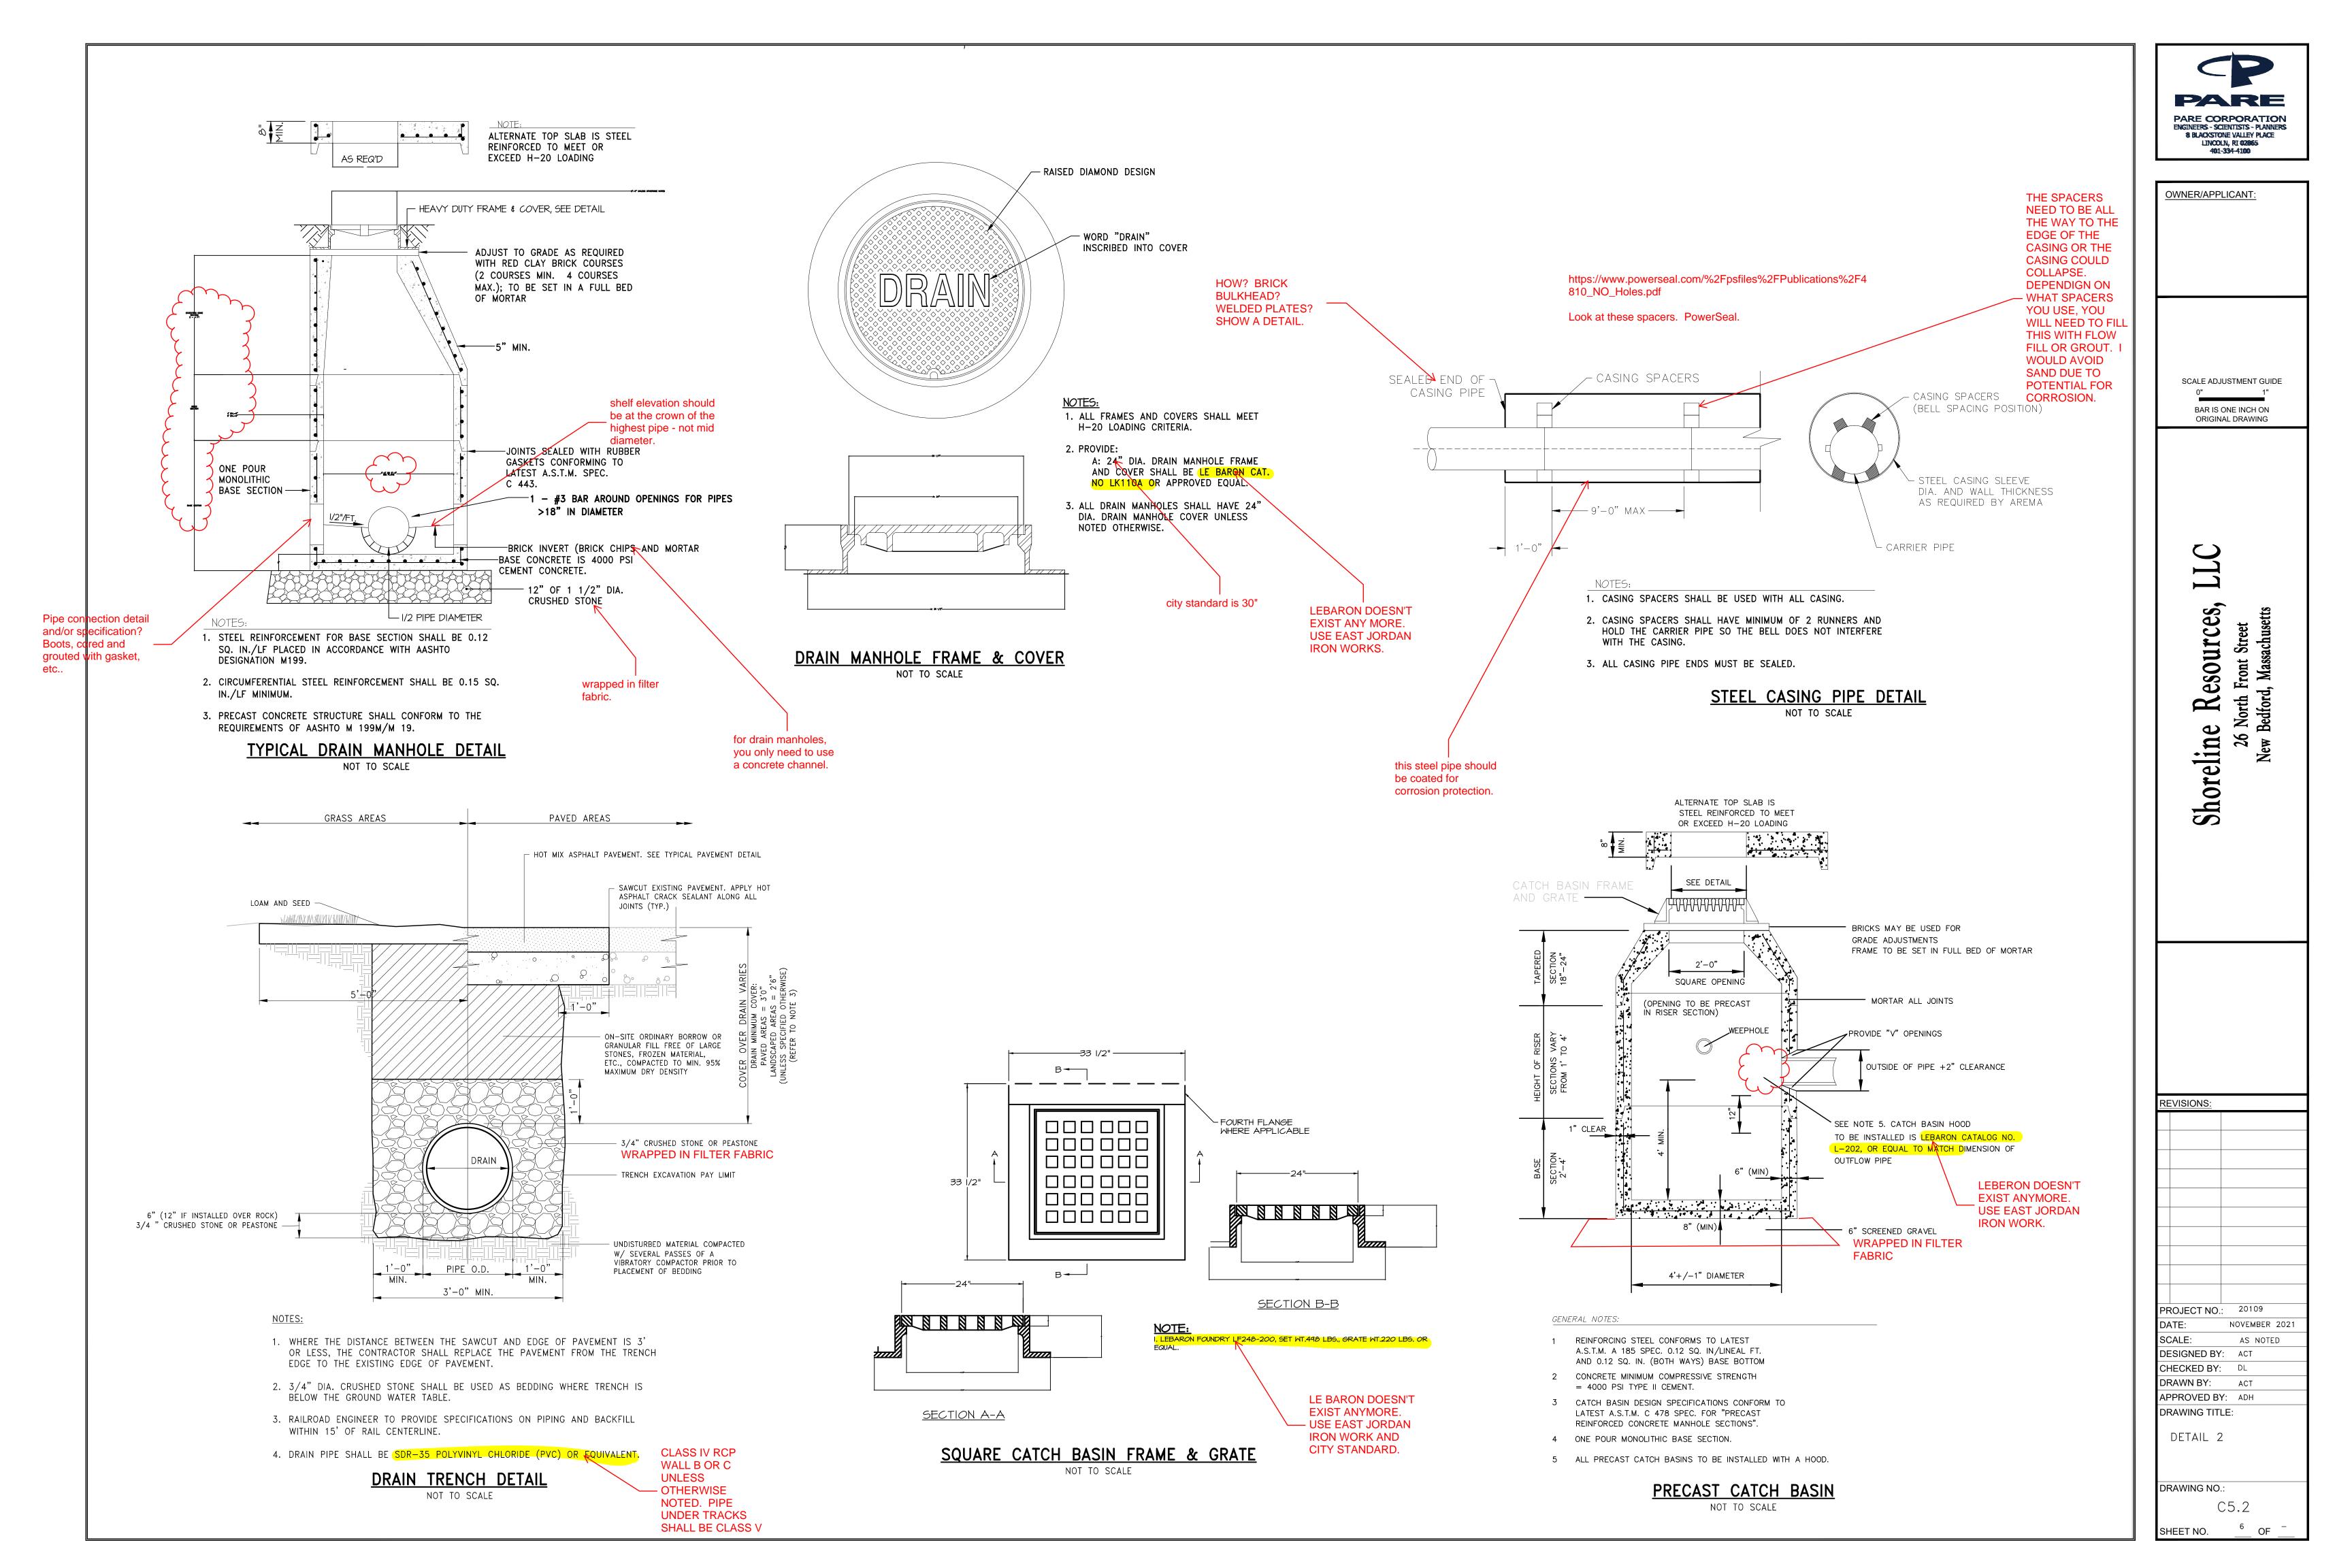

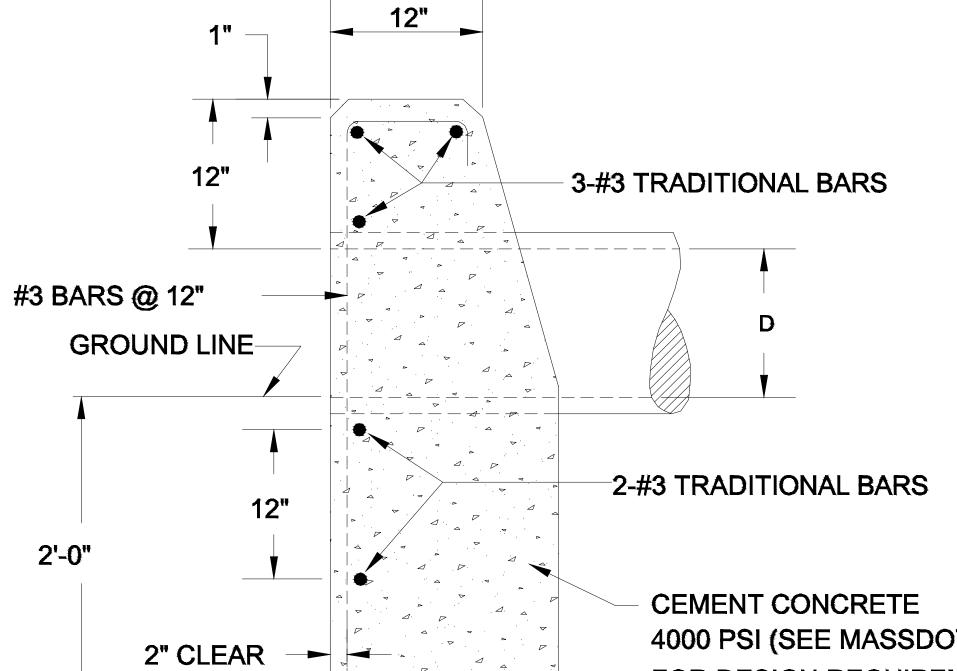


HOW ARE YOU GOING TO MOUNT THE TIDE FLEX VALVE? DO NOT USE THE IN LINE ONES. IT SHOULD BE INSTALLED ON THE PIPE EXTERIOR. I RECOMMEN USING THE TF-1 TYPE AND USING TEH STEEL BAND T CONNECT IT TO THE END OF THE RCP PIPE GOIGN THROUGH THE HEAD WALL.

CEMENT CONCRETE
4000 PSI (SEE MASSDOT SPECIFICATIONS
FOR DESIGN REQUIREMENTS)
ONLY TO BE USED WHERE SPECIFIED

## FRONT ELEVATION



18"

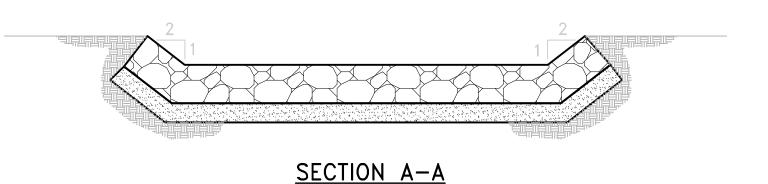


CEMENT CONCRETE
4000 PSI (SEE MASSDOT SPECIFICATIONS
FOR DESIGN REQUIREMENTS)
ONLY TO BE USED WHERE SPECIFIED


CONCRETE CRADLE FOR PIPE CULVERTS

NOTES:

- 1. FOR DESCRIPTIONS, MATERIALS AND CONSTRUCTION METHODS, SEE LATEST MASSDOT STANDARD SPECIFICATIONS.
- 2. CONCRETE DIMENSIONS SHOWN ARE MINIMUM.

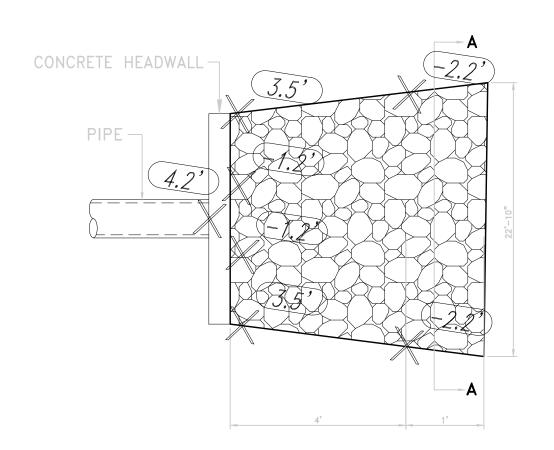

<u>PLAN</u>

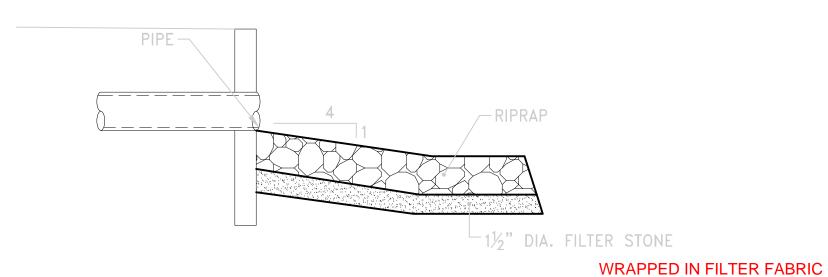

SIDE ELEVATION

PIPE OUTLET PROTECTION

PARE CORPORATION
ENGINEERS - SCIENTISTS - PLANNERS
8 BLACKSTONE VALLEY PLACE
LINCOLN, RI 92865
401-334-4190

OWNER/APPLICANT:

SCALE ADJUSTMENT GUIDE

0" 1"

BAR IS ONE INCH ON

ORIGINAL DRAWING

ine Resources, LL

REVISIONS:

ROJECT NO.: 20109
ATE: NOVEMBER 2021
CALE: AS NOTED

DESIGNED BY: ACT
CHECKED BY: DL
DRAWN BY: ACT
APPROVED BY: ADH
DRAWING TITLE:

DETAIL 3

DRAWING NO.: C5.3 SHEET NO.  $\frac{7}{2}$  OF  $\frac{7}{2}$ 

PIPE DIAMETER, D

1 1/2 : 1 SLOPE

L


Y

24"

9'-3"

4"

CONCRETE MASONRY HEADWALL FOR 24" PIPE

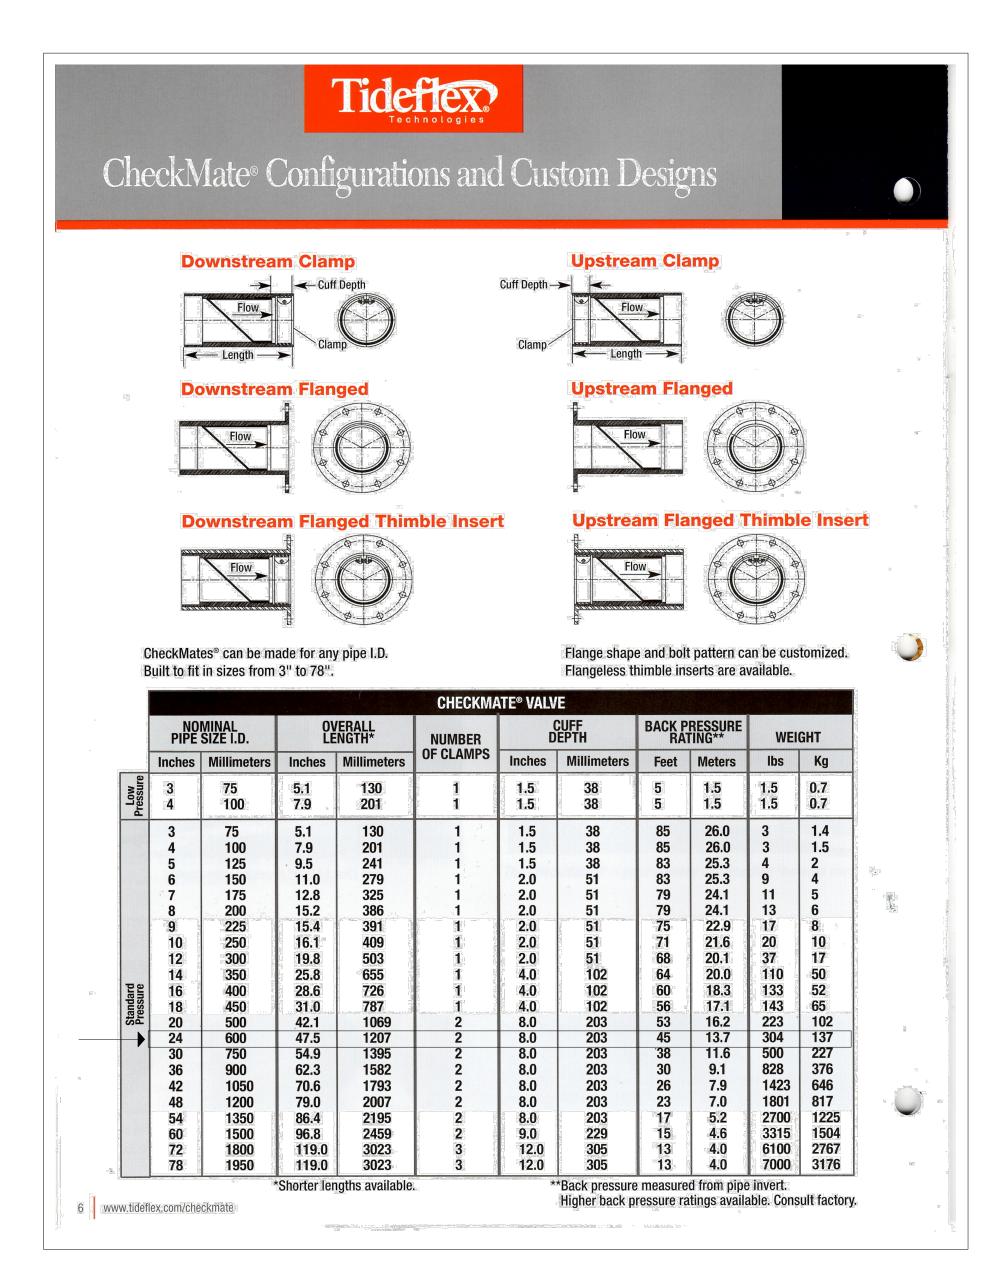

TIDEFLEX CHECKMATE GATE VALVE

NOT TO SCALE



OWNER/APPLICANT:

SCALE ADJUSTMENT GUIDE

BAR IS ONE INCH ON ORIGINAL DRAWING

Resources, Shoreline

PROJECT NO.: 20109 NOVEMBER 2021 SCALE: AS NOTED


DESIGNED BY: ACT CHECKED BY: DL

DRAWN BY: APPROVED BY: ADH DRAWING TITLE:

DETAIL 4

DRAWING NO.:

SHEET NO. \_\_\_\_8 OF \_\_

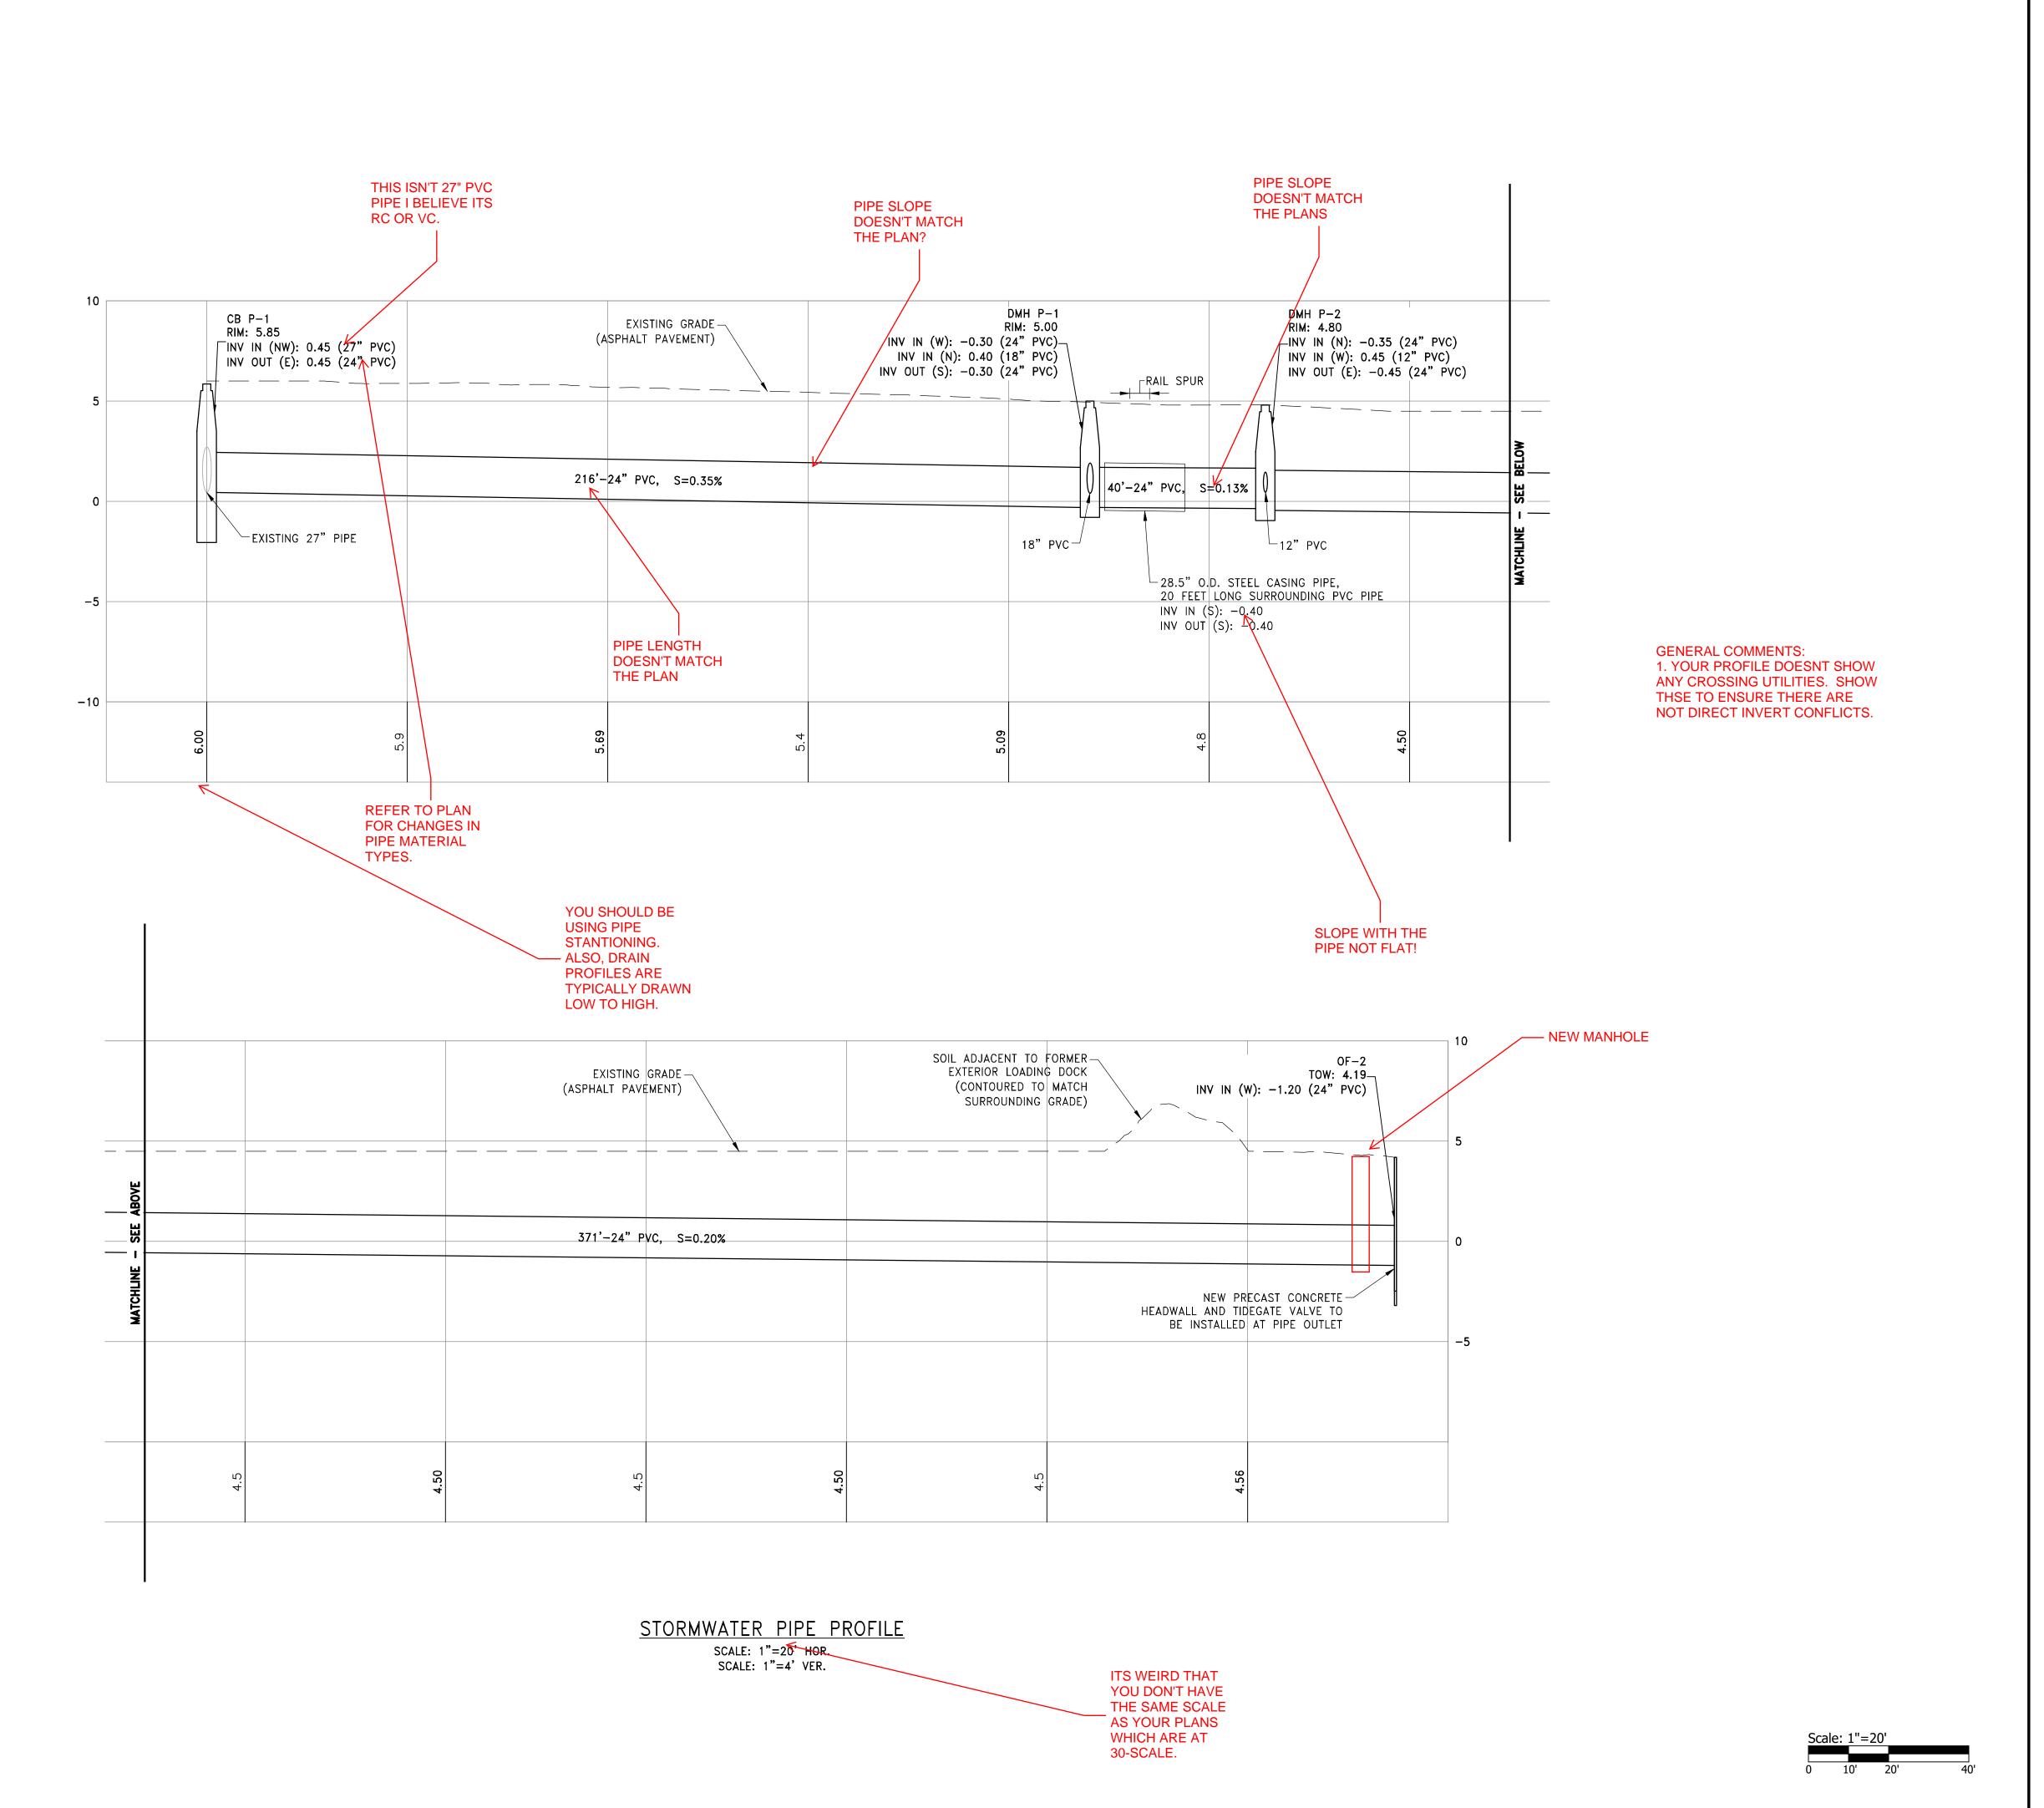

NOTE: ALL PVC PIPE IS SDR-35 OR EQUIVALENT

CLASS V.

ALL RCP SHALL CLASS IV WALL B OR C

UNLESS UNDER TRACKS WHICH SHALL BE



OWNER/APPLICANT:

SCALE ADJUSTMENT GUIDE
0" 1"

BAR IS ONE INCH ON ORIGINAL DRAWING

<u>ن</u>

Shoreline Resources, 26 North Front Street New Bedford, Massachusetts

REVISIONS:

PROJECT NO.: 20109

DATE: JULY 21, 2021
SCALE: AS NOTED
DESIGNED BY:
CHECKED BY: ACT

CHECKED BY: ACT
DRAWN BY: AL
APPROVED BY: ADH
DRAWING TITLE:

PROPOSED STORMWATER OVERFLOW PROFILE

DRAWING NO.:

C6.1

SHEET NO. \_ 7 OF 7