

LEGEND

	DESCRIPTION
	PROPERTY LINE
	CONTOUR LINE
×99.9	SPOT GRADE
EOP	EDGE OF PAVEMEN
ССВ	CAPE COD BERM
	WATER LINE
—— G —— · —— G —— · ——	GAS LINE
——p— — — p— — — —	DRAIN LINE
5	GRAVITY SEWER
	GRAVITY SEWER
\bowtie	WATER GATE
\oplus	GAS GATE
	SEWER CLEANOUT
-0-	UTILITY POLE
=	CATCH BASIN
<u> </u>	SEWER MANHOLE
	EROSION CONTRO
11-#1	SOIL TEST HOLE

ZONING DATA —
<u>DISTRICT:</u> RESIDENCE A (RA)
<u>DESCRIPTION</u> <u>REQUIRED</u>
LOT AREA 8,000 S.F.
LOT FRONTAGE 75 FT
FRONT SETBACK 20 FT
SIDE SETBACK 10/12 FT
REAR SETBACK 30 FT

E RECORD OWNER: ASSESSORS MAP 136A LOT 866 CALODESU, LLC 6 COSTA DRIVE FAIRHAVEN, MA 02719 DEED BOOK 14013 PAGE 88
EXCLUDING DEED BOOK 14310 PAGE 348 PLAN BOOK 184 PAGE 15


1. PROPERTY LINE SURVEY PERFORMED BY THOMPSON FARLAND, INC. IN JUNE OF 2015. TOPOGRAPHIC SURVEY PERFORMED BY FARLAND CORP. INC. IN MARCH OF 2022.


3. VERTICAL ELEVATIONS REFER TO AN ASSUMED DATUM. 4. BY GRAPHIC PLOTTING ONLY, THE PROPERTY DEPICTED ON THIS PLAN FALLS IN ZONE X, AS SHOWN ON THE FLOOD INSURANCE RATE MAP 25005C0377G, DATED JULY 6, 2021. THE WETLAND LINE WAS TAKEN FROM A PLAN PREPARED FOR P. DUFF, ENTITLED "EXISTING CONDITIONS PLAN OF LOTS, PEQUOT STREET, NEW BEDFORD, MASSACHUSETTS",

PREPARED BY SNB/LAND SURVEYORS, DATED APRIL 2019. ଅତିକ୍ଷ୍ୟ 6. CLEARED VEGETATION TO BE CHIPPED AND SPREAD WITHIN REMAINING WOODED AREAS

AND EROSION CONTROL TO BE SET IMMEDIATELY AFTER CLEARING.

SOIL TEST HOLE PERFORMED BY STEVIE CARVALHO, JUNE 1, 2022. $^{\mathbb{S}}$ 8. Existing debris piles on site, outside of the 25' wetland buffer to be REMOVED. TIRES WITHIN THE WETLANDS TO BE REMOVED BY HAND.

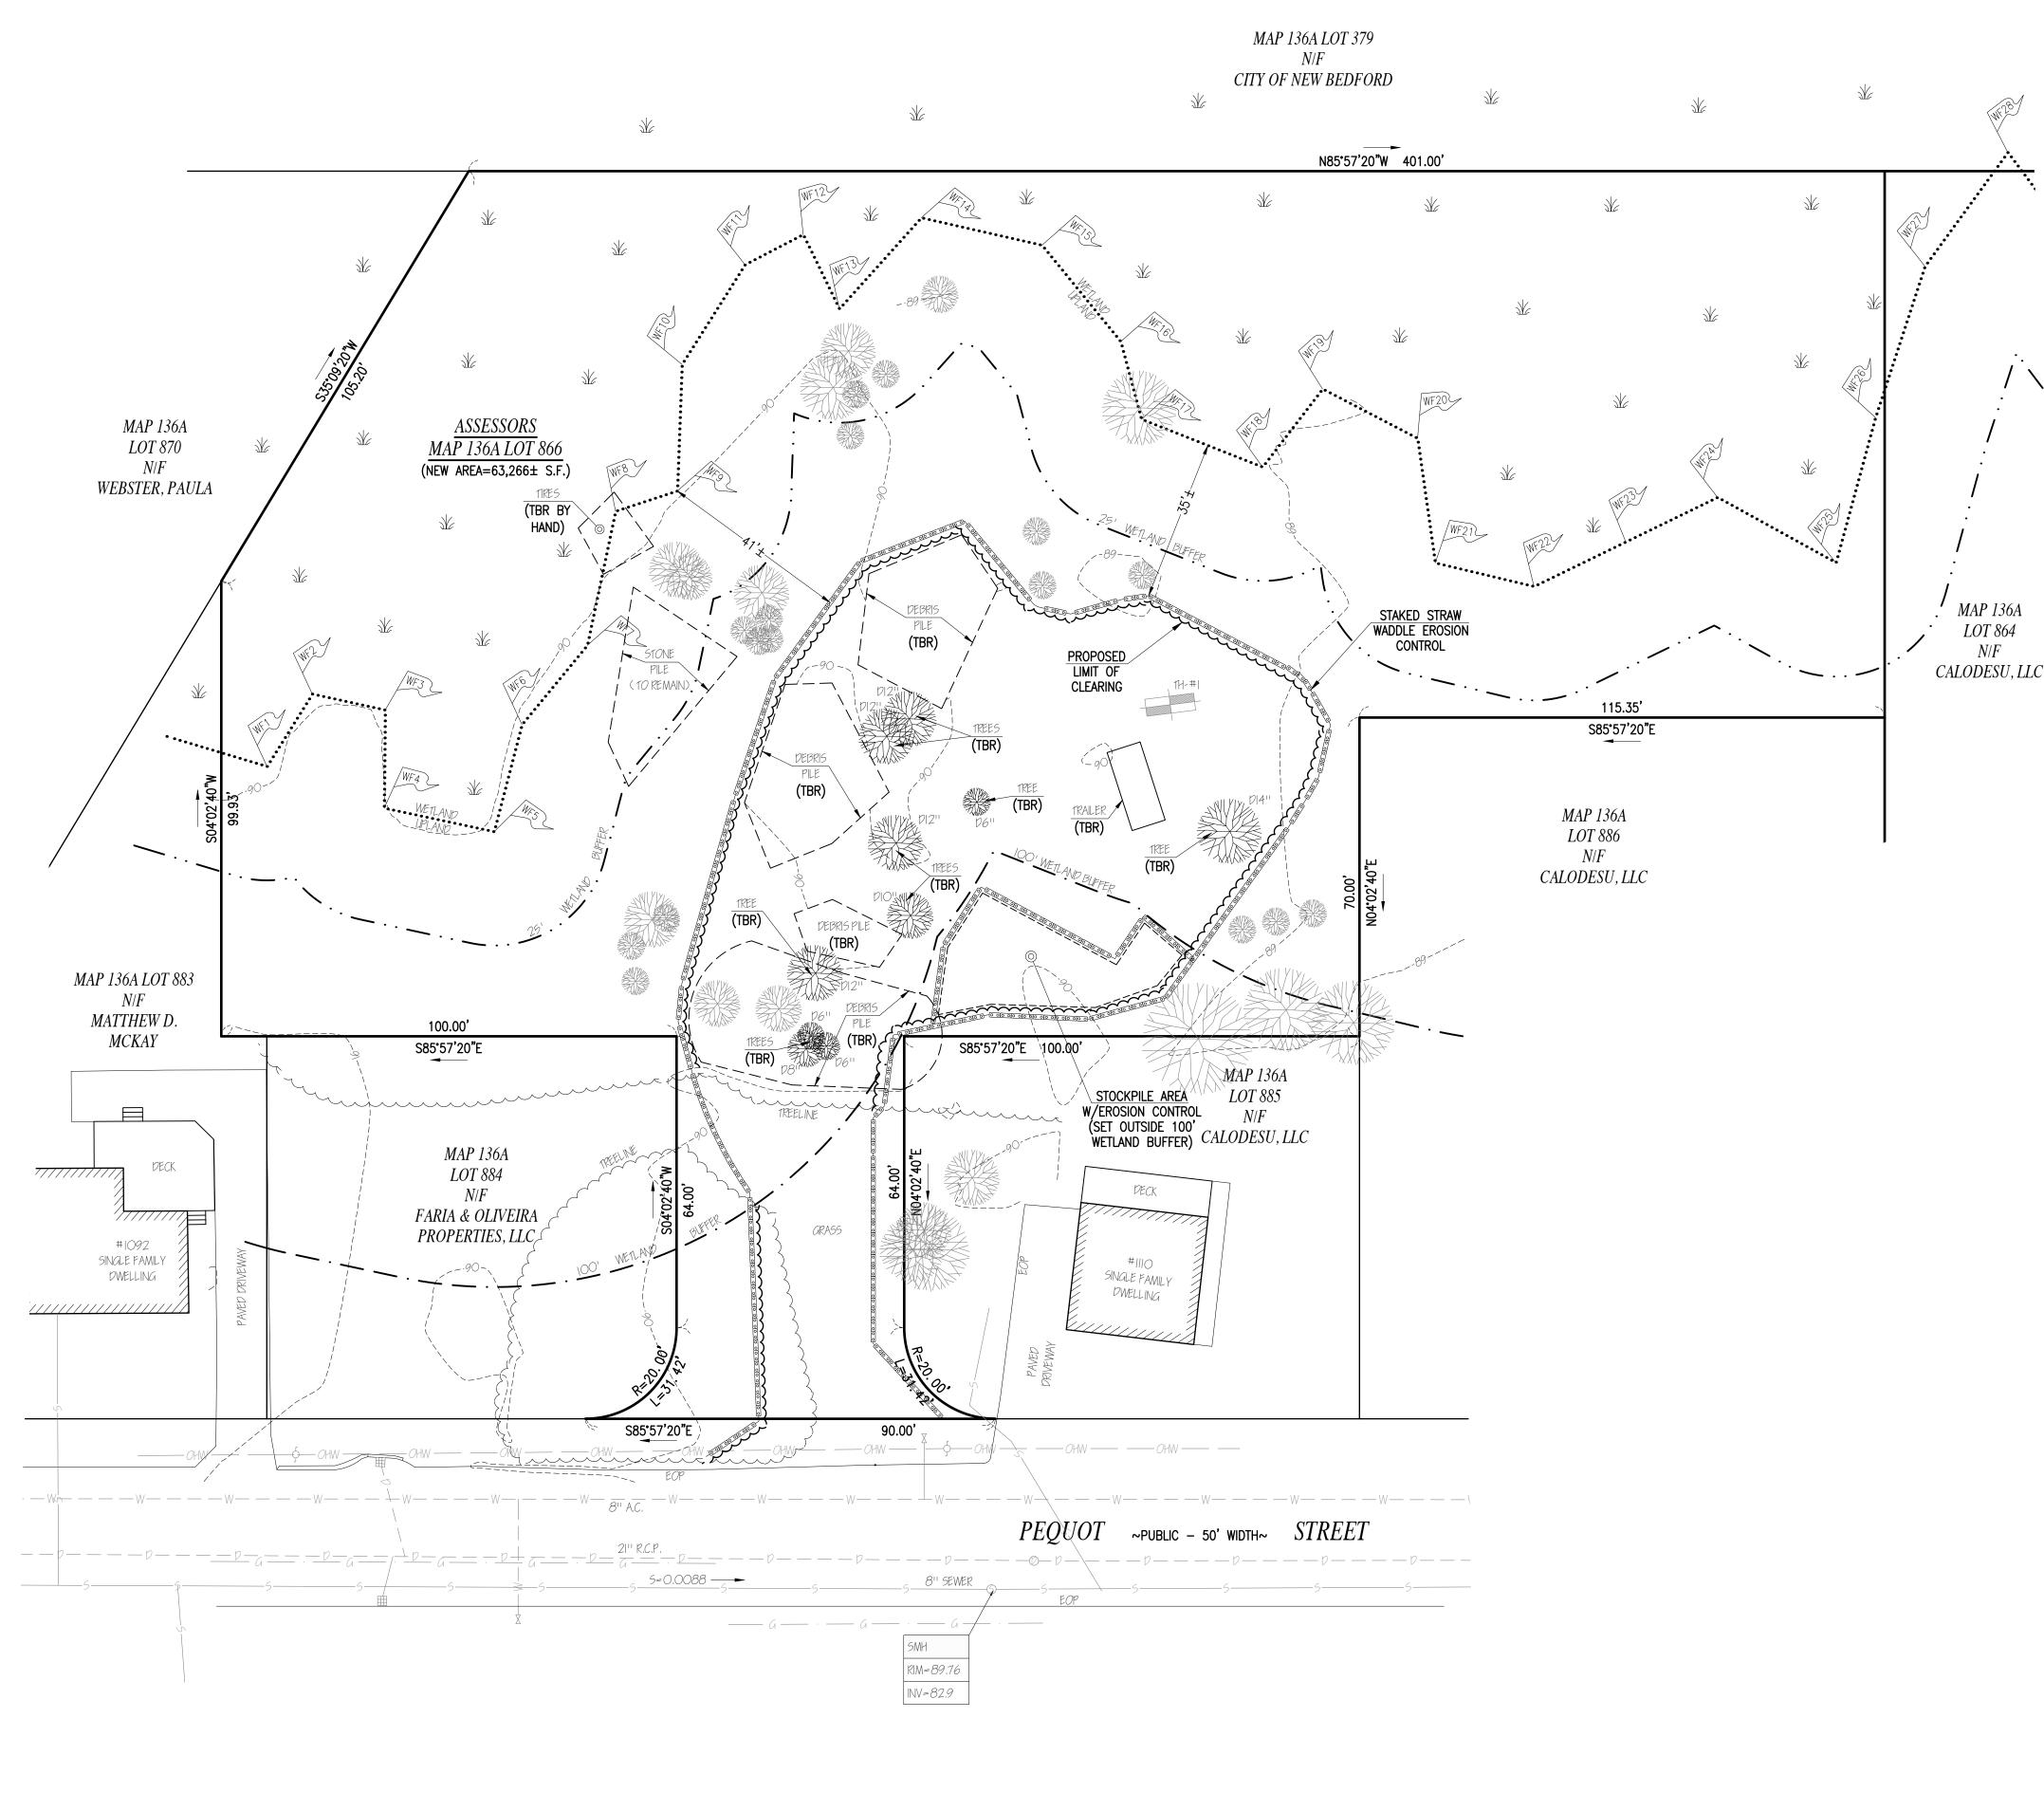

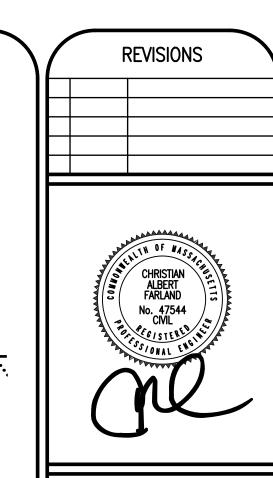



21 VENTURA DRIVE DARTMOUTH, MA 02747 P.508.717.3479 ENGINEERING


SITEWORK LAND SURVEYING DEVELOPMENT

DRAWN BY: CKG DESIGNED BY: CKG CHECKED BY: CAF

> 999 TS LOT HUS

> > MAY 24, 2022 SCALE: 1"=20' JOB NO. 22-145 LATEST REVISION:

DEMOLITION PLAN SHEET 1 OF 3

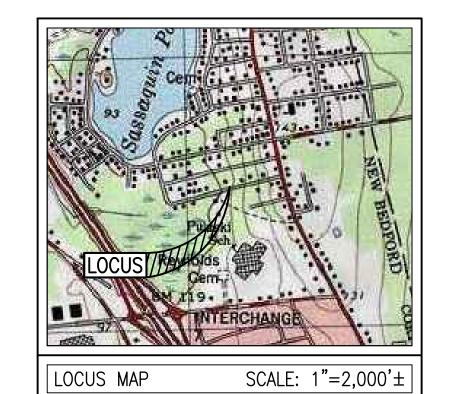

DESCRIPTION **EXISTING** PROPERTY LINE CONTOUR LINE -----|0|-----SPOT GRADE EDGE OF PAVEMENT CAPE COD BERM WATER LINE GAS LINE DRAIN LINE GRAVITY SEWER OVERHEAD WIRES WATER GATE GAS GATE SEWER CLEANOUT UTILITY POLE

LEGEND

CATCH BASIN

SEWER MANHOLE

TREE

EROSION CONTROL

PROPOSED
+100.0 EOP
— W— — — — — — — — — — — — — — — — — —

 ZONING DATA 	A –
<u>DISTRICT:</u> RESIDENCE A	(RA)
DESCRIPTION	<u>REQUIRED</u>
LOT AREA	8,000 S.F.
LOT FRONTAGE	75 FT
FRONT SETBACK	20 FT
SIDE SETBACK	10/12 FT
REAR SETBACK	30 FT

RECORD OWNER:

ASSESSORS MAP 136A LOT 866
CALODESU, LLC
6 COSTA DRIVE
FAIRHAVEN, MA 02719
DEED BOOK 14013 PAGE 88
EXCLUDING DEED BOOK 14310 PAGE 348
PLAN BOOK 184 PAGE 15

1. PROPERTY LINE SURVEY PERFORMED BY THOMPSON FARLAND, INC. IN JUNE OF 2015.
TOPOGRAPHIC SURVEY PERFORMED BY FARLAND CORP. INC. IN MARCH OF 2022.
VERTICAL ELEVATIONS REFER TO AN ASSUMED DATUM.

4. BY GRAPHIC PLOTTING ONLY, THE PROPERTY DEPICTED ON THIS PLAN FALLS IN ZONE X, AS SHOWN ON THE FLOOD INSURANCE RATE MAP 25005C0377G, DATED JULY 6, 2021.

5. THE WETLAND LINE WAS TAKEN FROM A PLAN PREPARED FOR P. DUFF, ENTITLED "EXISTING CONDITIONS PLAN OF LOTS, PEQUOT STREET, NEW BEDFORD, MASSACHUSETTS", PREPARED BY SNB/LAND SURVEYORS, DATED APRIL 2019.

6. CLEARED VEGETATION TO BE CHIPPED AND SPREAD WITHIN REMAINING WOODED AREAS AND EROSION CONTROL TO BE SET IMMEDIATELY AFTER CLEARING.


7. SOIL TEST HOLE PERFORMED BY STEVIE CARVALHO, JUNE 1, 2022.


8. FINAL LOCATION OF GAS AND ELECTRIC SERVICES TO BE DETERMINED BY SERVICE PROVIDERS.

ASSESSORS LOT 870 MAP 136A LOT 866 N/F(NEW AREA=63,266± S.F.) STAKED STRAW
WADDLE EROSION
CONTROL WEBSTER, PAULA 31.0'x10.33'
SUBSURFACE
RECHARGE SYSTEM
(TO BE TIED TO
ALL ROOF DRAINS N/FCALODESU, LLC MAP 136A INSPECTION PORT (TYP.) LOT 886 BITUMINOUS CONCRETE DRIVEWAY 17.5'x11.67'
SUBSURFACE
RECHARGE SYSTEM
(TO BE TIED TO
YARD DRAIN) N/FCALODESU, LLC MAP 136A LOT 883 N/FMATTHEW D. MCKAY CLEANOUT MAP 136A STOCKPILE AREA LOT 885 RIM=91.0 W/EROSION CONTROL N/F(SET OUTSIDE 100' CALODESU, LLC INV=89.5 MAP 136A DECK LOT 884 DECK N/FFARIA & OLIVEIRA PROPERTIES, LLC #1092 SINGLE FAMILY #1110 SINGLE FAMILY DWELLING DWELLING DRIVEWAY 1" TYPE "K" COPPER 6" SDR 35 SEWER 5=0,0088 ---INV=83.1±~ RIM=89.76

INV=82.9

MAP 136A LOT 379 N/F CITY OF NEW BEDFORD

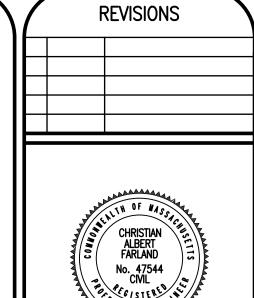

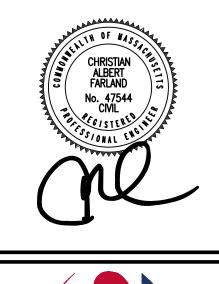



21 VENTURA DRIVE DARTMOUTH, MA 02747 P.508.717.3479

ENGINEERINGSITEWORK

LAND SURVEYINGDEVELOPMENT

DRAWN BY: CKG
DESIGNED BY: CKG
CHECKED BY: CAF

SITE PLAN
PEQUOT STREET
SSORS MAP 136A LOT 866
BEDFORD, MASSACHUSETTS

MAY 24, 2022

SCALE: 1"=20'

JOB NO. 22-145

LATEST REVISION:

SITE PLAN
SHEET 2 OF 3


ELEV.=89.4± 6/1/22 0"-6" A HORIZON SANDY LOAM 10YR 3/2 6"-23" B HORIZON SANDY LOAM 10YR 7/3 23"-34" C1 HORIZON LOAMY SAND 10YR 2/1 34"-40" C2 HORIZON LOAMY SAND 2.5Y 4/6 40"-96" C3 HORIZON SAND 2.5Y 5/1 REDOX @ 23**"** GROUNDWATER ELEV.=87.5±

GENERAL CONSTRUCTION NOTES:

- 1. THE CONTRACTOR IS SPECIFICALLY CAUTIONED THAT THE LOCATION AND/OR ELEVATION OF EXISTING UTILITIES AND STRUCTURES AS SHOWN ON THESE PLANS IS BASED ON RECORDS PROVIDED BY THE CITY OF NEW BEDFORD DPI AND WHERE POSSIBLE. MEASUREMENTS TAKEN IN THE FIELD. THIS INFORMATION IS NOT TO BE RELIED ON AS BEING EXACT OR COMPLETE. THE LOCATION OF ALL UNDERGROUND UTILITIES AND STRUCTURES SHALL BE VERIFIED IN THE FIELD BY THE CONTRACTOR PRIOR TO THE START OF CONSTRUCTION. THE CONTRACTOR MUST CONTACT THE APPROPRIATE UTILITY COMPANY, ANY GOVERNING PERMITTING AUTHORITY, AND "DIG SAFE" AT LEAST 72 HOURS PRIOR TO ANY EXCAVATION WORK TO REQUEST EXACT FIELD LOCATION OF UTILITIES INTERFERING WITH THE PROPOSED CONSTRUCTION AND APPROPRIATE REMEDIAL ACTION TAKEN BEFORE PROCEEDING WITH THE WORK. IT SHALL BE THE RESPONSIBILITY OF THE CONTRACTOR TO RELOCATE ALL EXISTING UTILITIES WHICH CONFLICT WITH THE PROPOSED IMPROVEMENTS SHOWN ON THE PLAN.
- 2. ALL CONSTRUCTION SHALL BE IN ACCORDANCE WITH ALL APPLICABLE STATE AND LOCAL STANDARDS AND REGULATIONS.
- 3. THE CONTRACTOR SHALL BE RESPONSIBLE FOR ESTABLISHING AND MAINTAINING ALL CONTROL POINTS AND BENCH MARKS NECESSARY FOR THE WORK.
- 4. ALL BENCHMARKS SHOWN ON THIS PLAN ARE TO BE CHECKED FOR CONSISTENCY BY THE CONTRACTOR. ANY DISCREPANCIES MUST BE RESOLVED BY THIS OFFICE PRIOR TO CONSTRUCTION.
- 5. WHERE PROPOSED PAVEMENT AND WALKS ARE TO MEET EXISTING, THE CONTRACTOR SHALL SAW-CUT A NEAT LINE AND MATCH GRADE. SEAL ALL JOINTS WITH HOT BITUMINOUS ASPHALT JOINT SEALER.
- 6. ALL EXISTING TREES, SHRUBS AND GROUND COVER WHERE NATURAL GRADE IS TO BE RETAINED SHALL BE KEPT IN THEIR EXISTING STATE UNLESS REMOVAL IS REQUIRED FOR CONSTRUCTION PURPOSES.
- 7. ALL AREAS DISTURBED BY CONSTRUCTION AND NOT TO BE PAVED OR OTHERWISE TREATED AS NOTED ON PLAN SHALL BE TREATED WITH 4" OF LOAM, SEEDED AND HAY MULCHED FOR EROSION CONTROL.
- DUE TO THE UNKNOWN LOCATION OF THE STRUCTURES DOWNSPOUTS IT SHALL BE THE CONTRACTORS RESPONSIBILITY TO ENSURE THAT ALL DOWNSPOUTS ARE CONNECTED TO A ROOF RECHARGE SYSTEM AND THAT THE FLOWS TO EACH SYSTEM ARE PROPORTIONATELY DISTRIBUTED.
- 9. CONTRACTOR SHALL THOROUGHLY FAMILIARIZE THEMSELVES WITH ALL CONSTRUCTION DOCUMENTS, SPECIFICATIONS AND SITE CONDITIONS PRIOR TO BIDDING AND PRIOR TO 10. ANY DISCREPANCIES BETWEEN DRAWINGS, SPECIFICATIONS AND SITE CONDITIONS SHALL
- BE REPORTED IMMEDIATELY TO THE OWNER'S REPRESENTATIVE FOR CLARIFICATION AND RESOLUTION PRIOR TO BIDDING OR CONSTRUCTION.
- 11. THESE PLANS ARE PERMITTING PLANS AND SHALL NOT TO BE USED FOR CONSTRUCTION. A FINAL SET OF STAMPED PLANS FOR CONSTRUCTION WILL BE ISSUED AFTER RECEIVING FINAL APPROVAL FROM THE LOCAL AND/OR STATE DEPARTMENTS.
- 12. SEWER SERVICE TO BE 10 FEET AWAY FROM WATER SERVICE.

SOIL EROSION AND SEDIMENT CONTROL NOTES:

- THE CONSERVATION COMMISSION SHALL BE NOTIFIED. AT LEAST 72 HOURS PRIOR TO ANY LAND DISTURBANCE.
- 2. A COPY OF THE SOIL EROSION AND SEDIMENT CONTROL PLAN MUST BE MAINTAINED ON THE PROJECT SITE DURING CONSTRUCTION.
- 3. SOIL EROSION AND SEDIMENT CONTROL PRACTICES IN THE PLAN SHALL BE CONSTRUCTED IN ACCORDANCE WITH THE PLANS AND SPECIFICATIONS. 4. ALL APPLICABLE SOIL EROSION AND SEDIMENT CONTROL PRACTICES SHALL BE IN
- PLACE PRIOR TO ANY DEMOLITION GRADING OPERATIONS AND/OR INSTALLATION OF PROPOSED STRUCTURES OR UTILITIES.
- 5. ALL APPLICABLE SOIL EROSION AND SEDIMENT CONTROL PRACTICES SHALL BE LEFT IN PLACE UNTIL CONSTRUCTION IS COMPLETED AND/OR THE AREA IS STABILIZED. 6. ALL SOIL EROSION AND SEDIMENT CONTROL STRUCTURES SHALL BE INSPECTED AND
- MAINTAINED ON A REGULAR BASIS AND AFTER EVERY STORM EVENT. THE MAINTENANCE OF SOIL EROSION AND SEDIMENT CONTROL MEASURES AND FACILITIES DURING AND IMMEDIATELY AFTER CONSTRUCTION RESTS WITH THE GENERAL
- CONTRACTOR. UPON ACCEPTANCE OF THE PROJECT, THE OWNER SHALL BECOME RESPONSIBLE FOR MAINTENANCE OF ANY REMAINING MEASURES AND FACILITIES. 8. OFF SITE SEDIMENT DISTURBANCE MAY REQUIRE ADDITIONAL CONTROL MEASURES TO
- BE DETERMINED BY THE ENGINEER. 9. THE CONSERVATION COMMISSION AND/OR ENGINEER MAY REQUIRE ADDITIONAL SOIL EROSION MEASURES TO BE INSTALLED, AS DIRECTED BY THE DISTRICT INSPECTOR.
- 10. THE CONTRACTOR SHALL UTILIZE ALL METHODS NECESSARY TO PREVENT BLOWING AND MOVEMENT OF DUST FROM THE EXPOSED SOIL SURFACES.
- 11. PAVED ROADWAYS MUST BE KEPT CLEAN AT ALL TIMES. 12. ALL CRITICAL AREAS SUBJECT TO EROSION SHALL RECEIVE A TEMPORARY SEEDING AND BE MULCHED IN ACCORDANCE WITH THE SPECIFICATIONS IMMEDIATELY FOLLOWING ROUGH GRADING.
- 13. MAXIMUM SIDE SLOPES OF ALL EXPOSED SURFACES SHALL NOT BE CONSTRUCTED STEEPER THAN 3:1 UNLESS OTHERWISE APPROVED BY THE DISTRICT.
- 14. ALL DEWATERING OPERATIONS MUST DISCHARGE DIRECTLY INTO A SEDIMENT FILTRATION DEVICE. THE SEDIMENT FILTER MUST BE CAPABLE OF FILTERING THE SEDIMENT AND
- BE PLACED SO AS NOT TO CAUSE EROSION OF THE DOWNSTREAM AREA. 15. ANY EXCAVATED MATERIAL NOT TO BE REUSED ON SITE SHALL BE REMOVED OFF SITE.

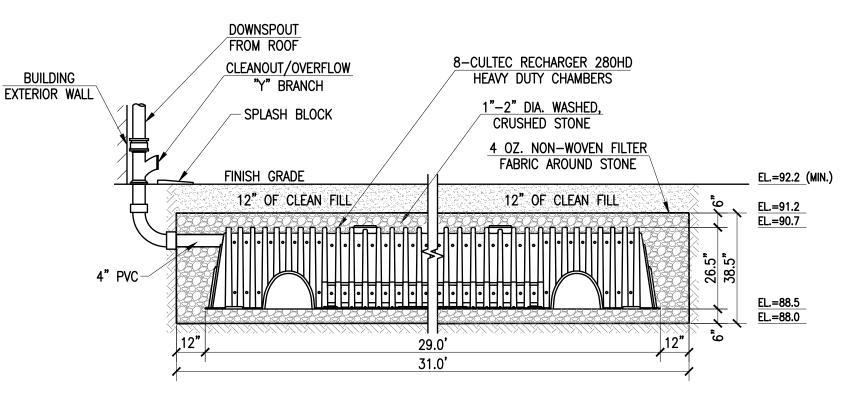

ROOF RECHARGE SYSTEM

NOT TO SCALE


SUBSURFACE ROOF RECHARGE UNIT SIZING CALCULATIONS:

INFLOW AREA	= 1,654 SF, 100	.00% IMPERVIOUS,		= 6.76 " F	OR 100-YEAR	STORM EVE
INFLOW	= 0.26 CFS @ 1	2.08 HRS,	VOLUME= 915 C	F		
OUTFLOW	= 0.01 CFS @ 9	.11 HRS,	VOLUME= 697 (CF, ATTEN:	= 97%, LAG=	0.0 MIN
DISCARDED	= 0.01 CFS @ 9	.11 HRS.	VOLUME= 697 (CF [*]	·	

ROUTING BY DYN-STOR-IND METHOD, TIME SPAN= 0.00-30.00 HRS, DT= 0.01 HRS / 3 PEAK ELEV= 90.47' @ 15.90 HRS SURF.AREA= 320 SF REQUIRED STORAGE= 524 CF


VOLUME #1	INVERT 88.00'	AVAIL.STORAGE 270 CF	STORAGE DESCRIPTION 10.33'W X 31.00'L X 3.21'H PRISMATOID X 1 1,028 CF OVERALL $-$ 352 CF EMBEDDED $=$ 676 CF X 40.0% VOID
#2	88.50'	352 CF	47.0"W X 26.5"H X 8.00'L PARABOLIC ARCH WITH 1' OVERLAP

TOTAL AVAILABLE STORAGE = 622 CF >>> 524 CF

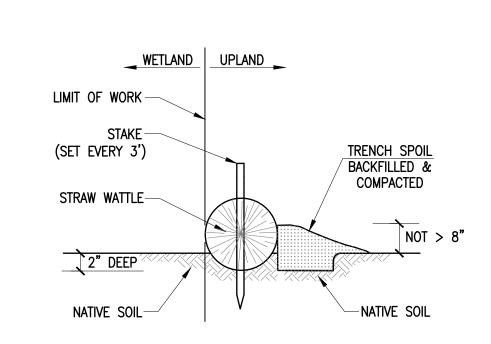


STAKED STRAW WATTLE

NOT TO SCALE

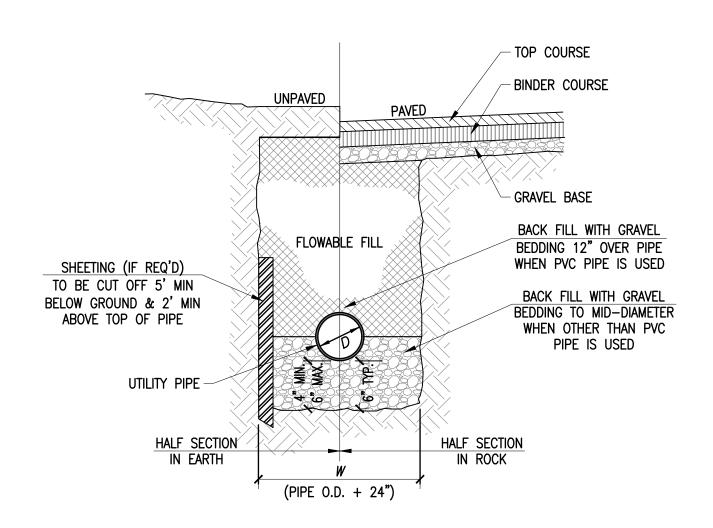

UTILITY TRENCH

NOT TO SCALE

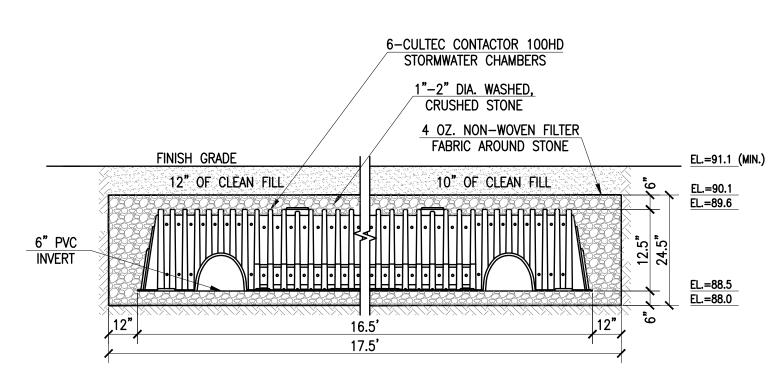

YARD DRAIN RECHARGE SYSTEM

NOT TO SCALE


SUBSURFACE YARD DRAIN RECHARGE UNIT SIZING CALCULATIONS:

INFLOW AREA	= 674 SF, 100.00% IMPERVIOUS,	INFLOW DEPTH = 6.76" FOR 100-YEAR STORM EVENT
INFLOW	= 0.11 CFS @ 12.08 HRS,	VOLUME= 392 CF
OUTFLOW	= 0.00 CFS @ 9.11 HRS,	VOLUME= 392 CF, ATTEN= 95%, LAG= 0.0 MIN
DISCARDED	= 0.00 CFS @ 9.11 HRS	VOLLIME 392 CF

ROUTING BY DYN-STOR-IND METHOD, TIME SPAN= 0.00-30.00 HRS, DT= 0.01 HRS / 3 PEAK ELEV= 89.51' @ 14.51 HRS SURF.AREA= 204 SF REQUIRED STORAGE= 175 CF


VOLUME #1	INVERT 88.00'	AVAIL.STORAGE 132 CF	STORAGE DESCRIPTION 11.67'W X 17.50'L X 2.04'H PRISMATOID X 1 417 CF OVERALL — 87 CF EMBEDDED = 330 CF X 40.0% VOID
#2	88.50'	87 CF	36.0"W X 12.5"H X 8.00'L PARABOLIC ARCH WITH 0.50' OVERLAP

TOTAL AVAILABLE STORAGE = 219 CF >>> 175 CF

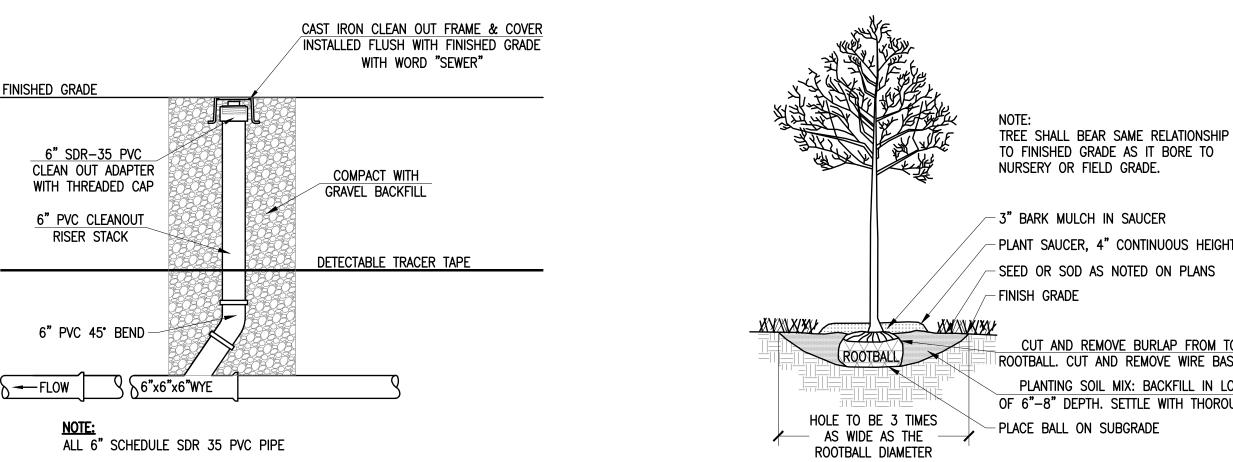

SEWER SERVICE CLEANOUT

NOT TO SCALE

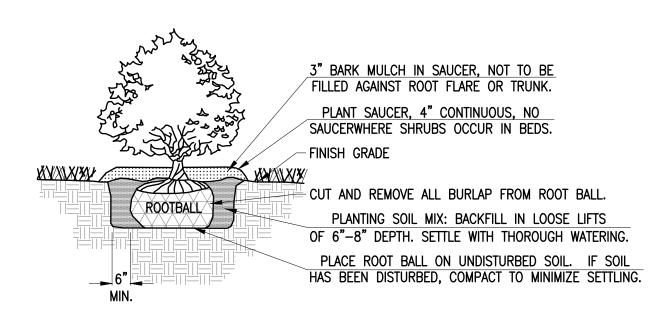


SHRUB SHALL BEAR SAME RELATIONSHIP TO FINISHED GRADE AS IT BORE TO NURSERY OR FIELD GRADE. 2. WHERE SHRUBS OCCUR IN GROUPINGS IN PLANT BEDS,

PROVIDE 2' DEEP CONTINUOUS LOAM BED.


SHRUB PLANTING

NOT TO SCALE

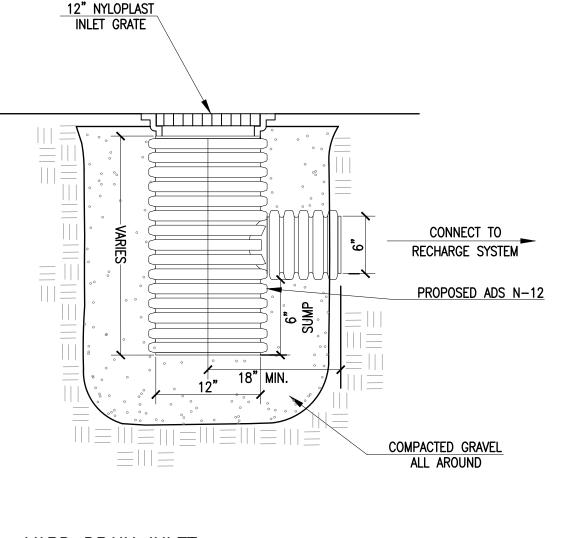

YARD DRAIN INLET

NOT TO SCALE

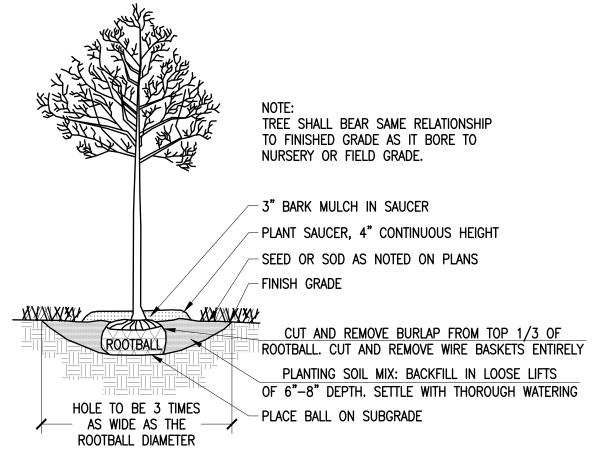

TREE PLANTING

NOT TO SCALE

LANDSCAPE TABLE							
SYMBOL	BOTANICAL NAME	COMMON NAME	CALIPER	QUANTITY			
TREES							
	TILIA	LINDEN	2.5–3"	5			
	ACER RUBRUM	RED MAPLE	2.5-3"	5			

MAY 24, 2022 SCALE: AS NOTED JOB NO. 22-145

LATEST REVISION:

REVISIONS

www.FarlandCorp.cor

DARTMOUTH, MA 02747

21 VENTURA DRIVE

LAND SURVEYING

DEVELOPMENT

DRAWN BY: CKG

DESIGNED BY: CKG

CHECKED BY: CAF

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36, SS/

SQUOT S S MAP ORD, N

PE ORG

P.508.717.3479

ENGINEERING

SITEWORK

CONSTRUCTION NOTES & DETAILS SHEET 3 OF 3