PROPOSED VEGETATION REMEDIATION PROGRAM

AFTER THE FACT NOTICE OF INTENT JOHN VERTENTE BOULEVARD IN NEW BEDFORD, MA

APPLICANT:

KEARSARGE ENERGY LE LLC 1380 SOLDIERS FIELD ROAD, SUITE 3-1 BOSTON, MA 02135

OWNERS:

DARTMOUTH ASSESSORS MAP 85

LOTS 8-3, 8-4 AND 9
KEARSARGE ENERGY LE LLC
1380 SOLDIERS FIELD ROAD, SUITE 3-1
BOSTON, MA 02135


NEW BEDFORD ASSESSORS MAP 135

LOTS 1, 3,15 & 47

KEARSARGE ENERGY LE LLC

1380 SOLDIERS FIELD ROAD, SUITE 3-1

BOSTON, MA 02135

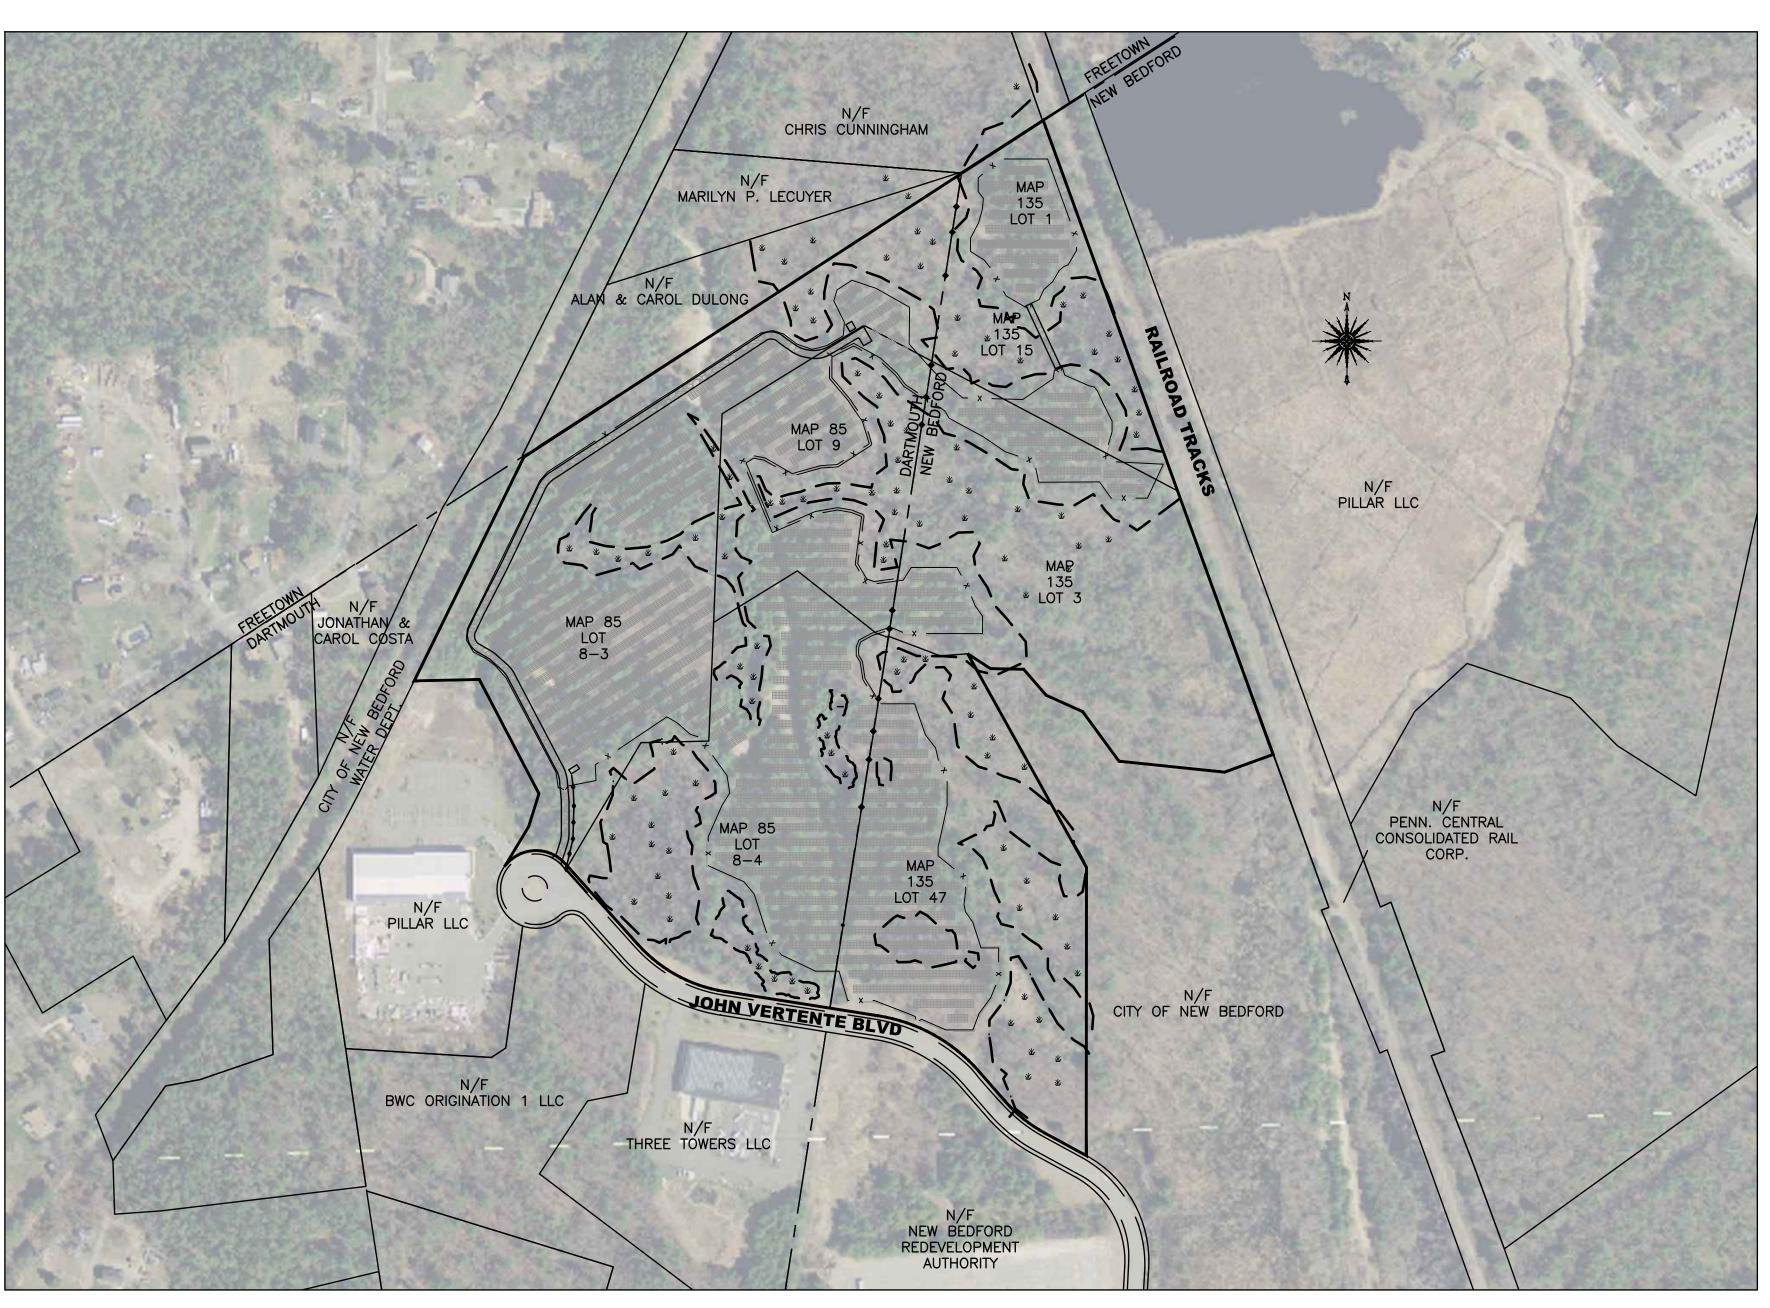

LOCUS SCALE: 1"=200'

JULY 7, 2022 REVISED AUGUST 26, 2022

SCHEDULE OF DRAWINGS

SHEET#

COVER SHEET VEGETATION DISTURBANCE MAP

SITE CLEAN UP PLAN PROPOSED VEGETATION REMEDIATION PLAN BUFFER ZONE ENHANCEMENT PLAN

THE PURPOSE OF THIS REMEDIATION PROGRAM IS TO:

1. CHIP THE FELLED TREES AND PLACE THE WOODCHIPS IN WINDROW AS SHOWN ON THESE PLANS. THIS IS TO BE COMPLETED PRIOR TO NOVEMBER 1,


PLAN TITLE

- PLANT THE TREES AND SHRUBS SHOWN ON SHEET 3 OF THIS PLAN SET. THIS
 IS TO BE COMPLETED BY JUNE 1, 2023.
- 3. COMPLETE THE BUFFER ZONE PLANTING SHOWN ON THE "BUFFER ZONE ENHANCEMENT PLAN" APPROVED IN THE ORIGINAL ORDER OF CONDITIONS AND ENCLOSED AS SHEET 4 IN THIS PLAN SET, THIS IS TO BE COMPLETED BY JUNE 1, 2023.
- 4. STABILIZE THE GROUND SURFACE THROUGHOUT THE PROJECT BY PLANTIN THE HERBACEOUS SPECIES PRESENTED ON SHEET 2 OF THIS PLAN SET, THI IS TO BE COMPLETED BY JUNE 1, 2023.
- THE REMEDIATION PROGRAM IS TO BE MONITORED BY A WETLAND SCIENTIST WHO WILL PERIODICALLY REPORT TO THE CONSERVATION COMMISSION.

PREPARED BY:



CIVIL ENGINEERING—LAND SURVEYING—ENVIRONMENTAL ASSESSMENT P.O. BOX 1088, 350 BEDFORD STREET, LAKEVILLE, MA 02347 TEL: 508.947.0050 FAX: 508.947.2004

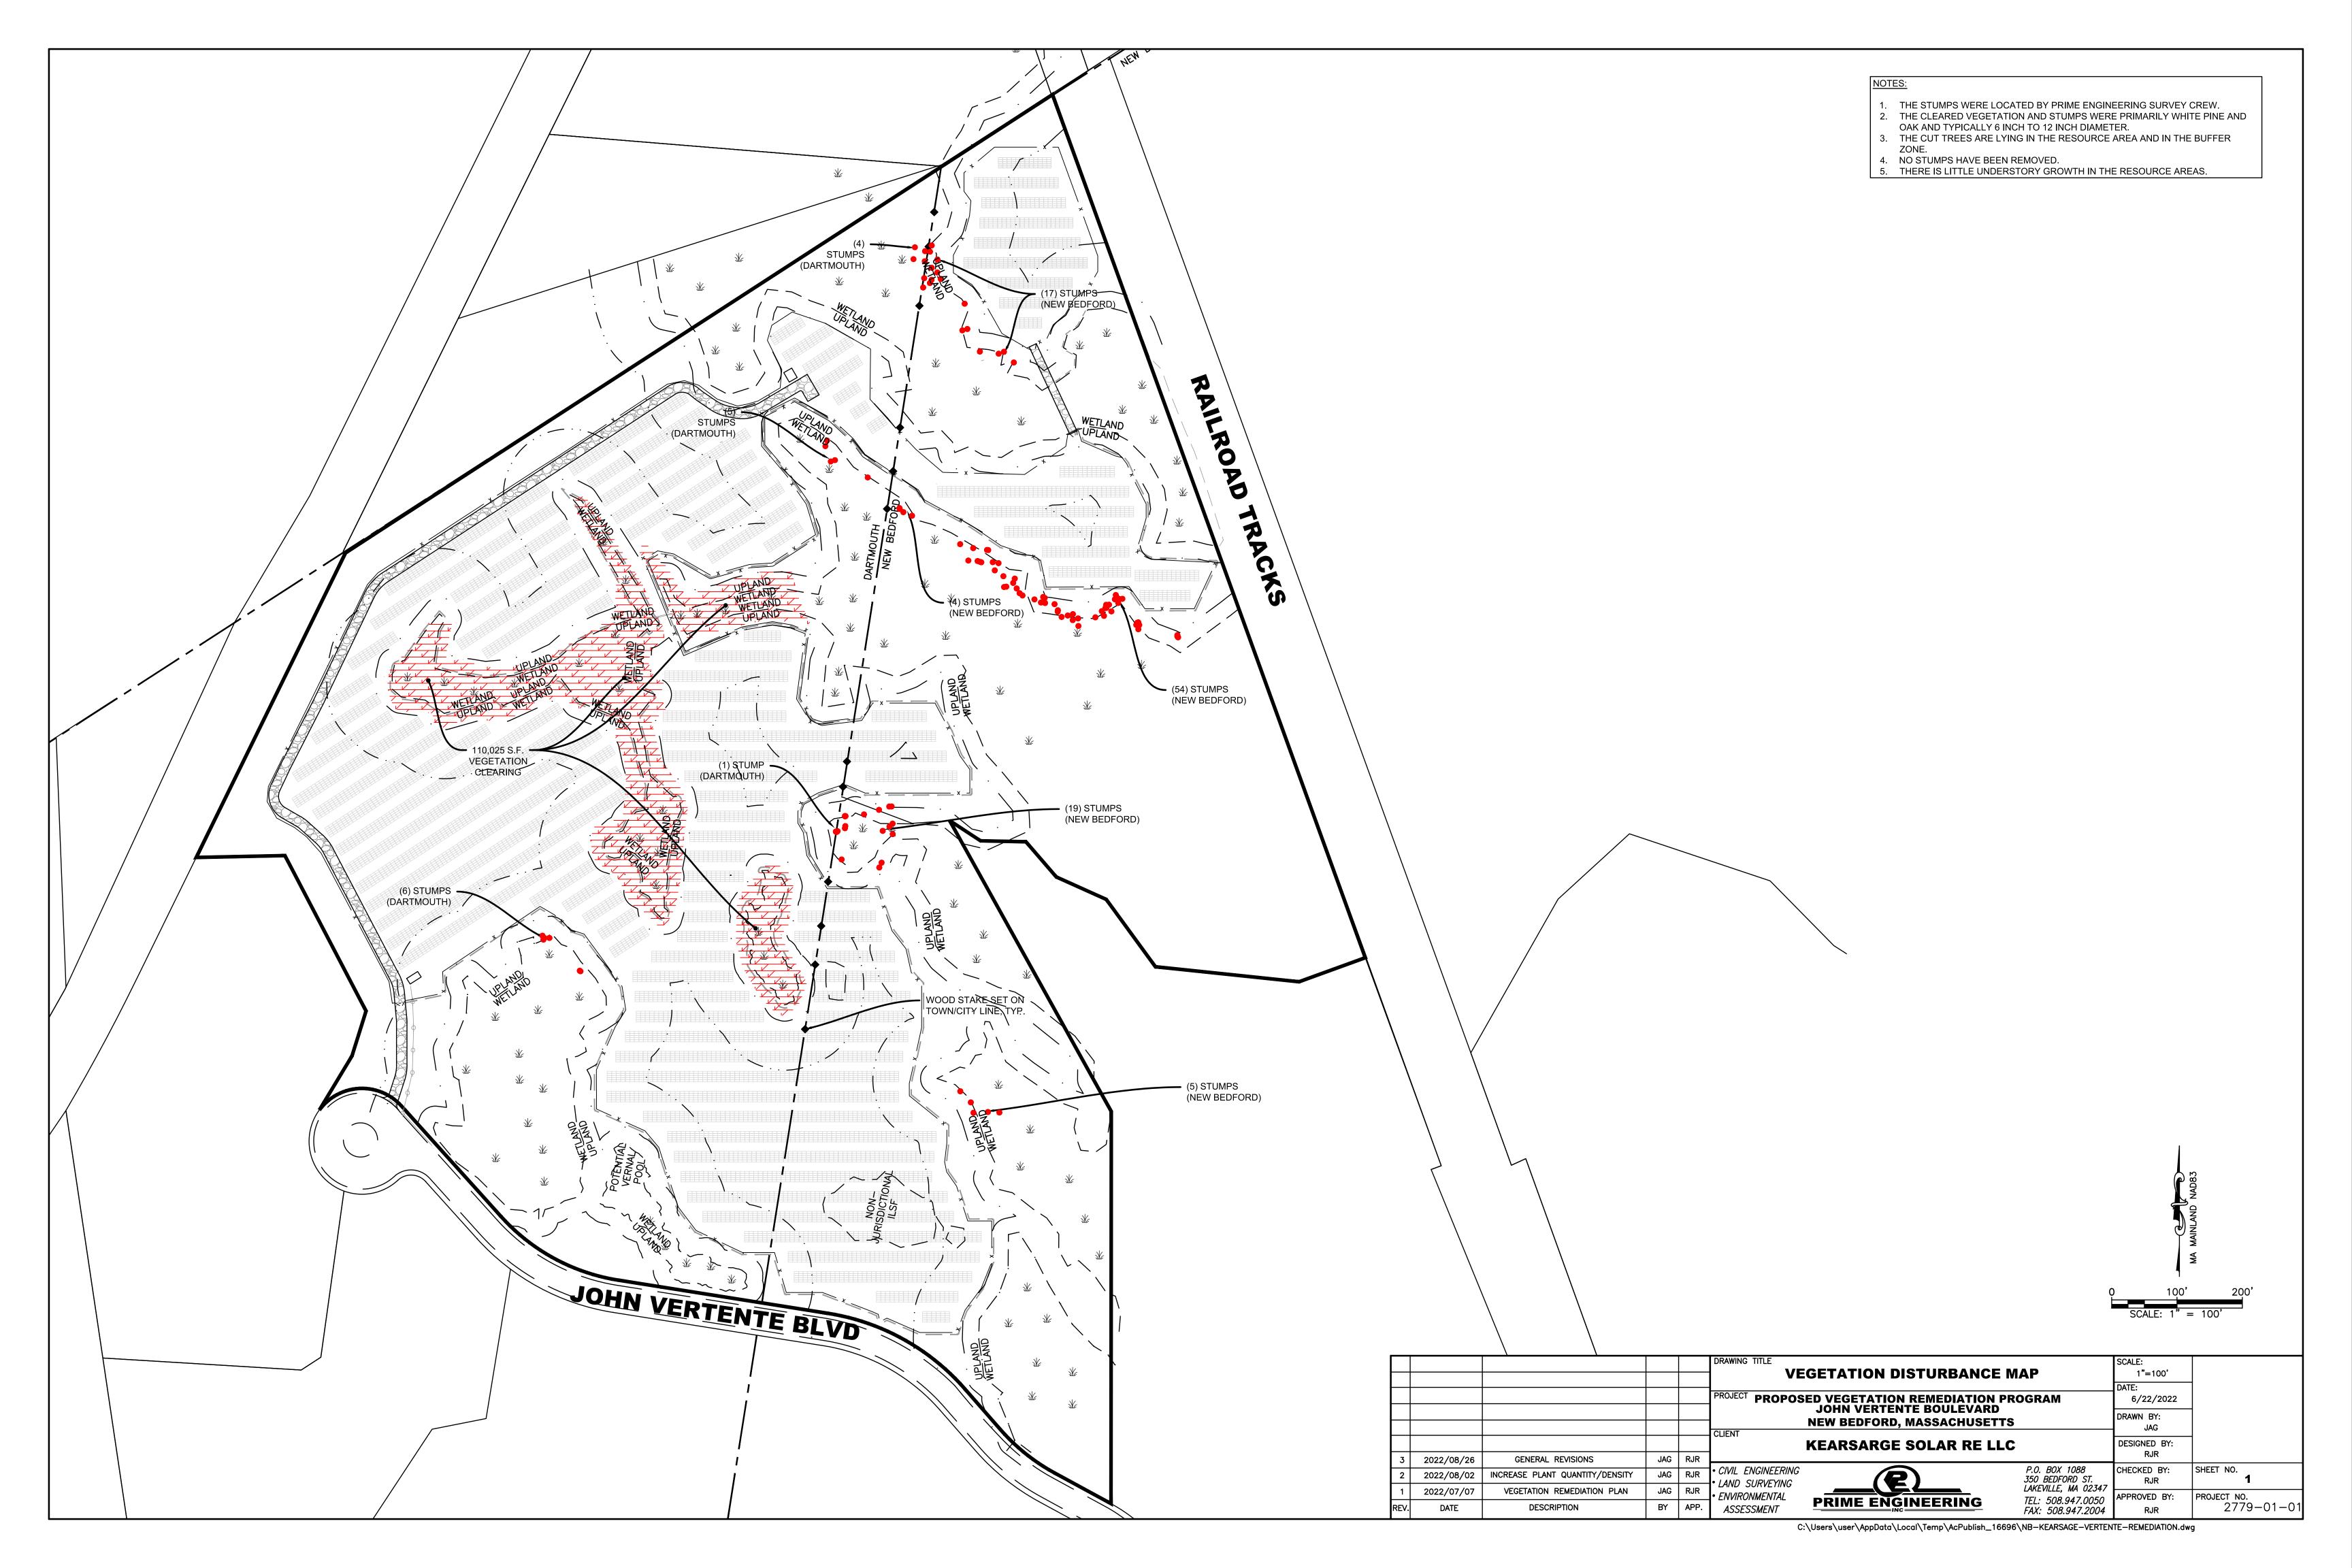

WETLAND SEE VIEW 3C UPLAND AREAS WITH SHEET 3 SPARSE VEGETATIVE COVER TO BE RESEEDED, TYP. RO PO - DARTMOUTH VEGETATION -REMEDIATION PLAN FILED UNDER SEPARATE NOI - DISTURBÈÐ WETLAND AREAS TO BE SEEDED WITH WETLAND SEED SEE VIEW 3A SHEET 3 PROPOSED WINDROW, FELLED TREES TO BE REMOVED OFFSITE OR CHIPPED AND USED FOR WINDROW. TREE STUMPS TO REMAIN AND NEW GROWTH LEFT TO REGENERATE INTO UNDERSTORY, TYP. SEE VIEW 3B

UPLAND SEED MIX:

DISTURBED HERBACEOUS UPLAND AREAS TO BE SEEDED WITH ONE POUND PER 1,250 SQUARE FEET OF NEW ENGLAND WETLAND PLANTS, INC. NEW ENGLAND EROSION CONTROL/RESTORATION MIX FOR DRY SITES SEED MIX, OR APPROVED EQUAL WHICH CONTAINS THE FOLLOWING SPECIMENS:

Botanical Name	Common Name	Indicator
Elymus canadensis	Canada Wild Rye	FACU+
Festuca rubra	Red Fescue	FACU
Lolium multiflorum	Annual Ryegrass	
Lolium perenne	Perrenial Ryegrass	
Schizachyrium scoparium	Little Bluestem	FACU
Panicum virgatum	Switch Grass	FAC
Sorghastrum nutans	Indian Grass	UPL

WETLAND SEED MIX:

DISTURBED HERBACEOUS WETLAND AREAS TO BE SEEDED WITH ONE POUND PER 2,500 SQUARE FEET OF NEW ENGLAND WETLAND PLANTS, INC. NEW ENGLAND WETMIX SEED MIX, OR APPROVED EQUAL WHICH CONTAINS THE FOLLOWING SPECIMENS:


Botanical Name	Common Name	Indicator
Carex vulpinoidea	Fox Sedge	OBL
Carex scoparia	Blunt Broom Sedge	FACW
Carex lurida	Lurid Sedge	OBL
Carex lupulina	Hop Sedge	OBL
Poa palustris	Fowl Bluegrass	FACW
Bidens frondosa	Beggar Ticks	FACW
Scirpus atrovirens	Green Bulrush	OBL
Asclepias incarnata	Swamp Milkweed	OBL
Carex crinita	Fringed Sedge	OBL
Vernonia noveboracensis	New York Ironweed	FACW+
Juncus effusus	Soft Rush	FACW+
Aster lateriflorus (Symphyotrichum lateriflorum)	Starved/Calico Aster	FACW
Iris versicolor	Blue Flag	OBL
Glyceria grandis	American Mannagrass	OBL
Mimulus ringens	Square Stemmed Monkey Flower	OBL
Eupatorium maculatum (Eutrochium maculatum)	Spotted Joe Pye Weed	OBL

GENERAL SITE WORK NOTES

- 1. CONTRACTOR TO ARRANGE ACCESS FOR NEW BEDFORD CONSERVATION COMMISSION AGENT TO CONDUCT SITE VISITS.
- 2. ALL FELLED TREES TO BE REMOVED OFFSITE OR CHIPPED AND USED FOR
- 3. TREE STUMPS TO REMAIN AND NEW GROWTH LEFT TO REGENERATE INTO
- 4. NO ADDITIONAL CUTTING OF STANDING TREES IS PERMITTED.


UNDERSTORY

- 5. NO ADDITIONAL DISTURBANCE TO WETLAND AREAS IS PERMITTED.
- 6. HEAVY MACHINERY SHOULD NOT BE USED WITHIN WETLAND AREA TO AVOID COMPACTION.
- 7. SECTIONS OF EXISTING CHAINLINK FENCE MAY NEED TO BE TEMPORARILY REMOVED TO COMPLETE CLEAN UP.
- 8. AREAS OF SPARSE HERBACEOUS VEGETATION SHOULD BE SEEDED. INCLUDING UPLAND AND WETLAND AREAS DISTURBED BY TREE REMOVAL/CLEAN UP WORK AND UPLAND AREAS THAT HAVE NOT YET ESTABLISHED A GROUND COVER OF OVER 75%.
- 9. ONCE THE FELLED TREE REMOVAL IS COMPLETE, A REPORT WITH PICTURES OF THE OUTCOME SHALL BE SUBMITTED TO THE CONSERVATION COMMISSION.

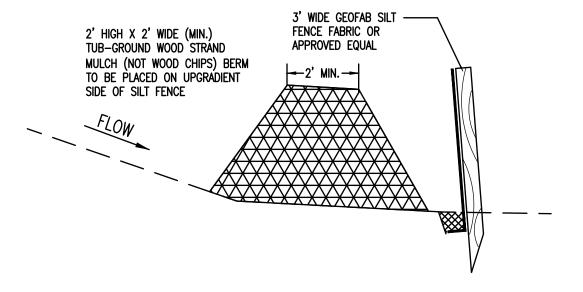

WOOD GRINDING WINDROW

SITE CLEAN UP PLAN 1"=80' PROJECT PROPOSED VEGETATION REMEDIATION PROGRAM JOHN VERTENTE BOULEVARD 6/22/2022 DRAWN BY: NEW BEDFORD, MASSACHUSETTS JAG **KEARSARGE SOLAR RE LLC** DESIGNED BY: 2022/08/26 GENERAL REVISIONS JAG RJR • CIVIL ENGINEERING P.O. BOX 1088 CHECKED BY: INCREASE PLANT QUANTITY/DENSITY 350 BEDFORD ST. JAG RJR • LAND SURVEYING
• ENVIRONMENTAL LAKEVILLE, MA 02347 VEGETATION REMEDIATION PLAN TEL: 508.947.0050 APPROVED BY: PROJECT NO. PRIME ENGINEERING 2779-01-01 DESCRIPTION **ASSESSMENT** FAX: 508.947.2004

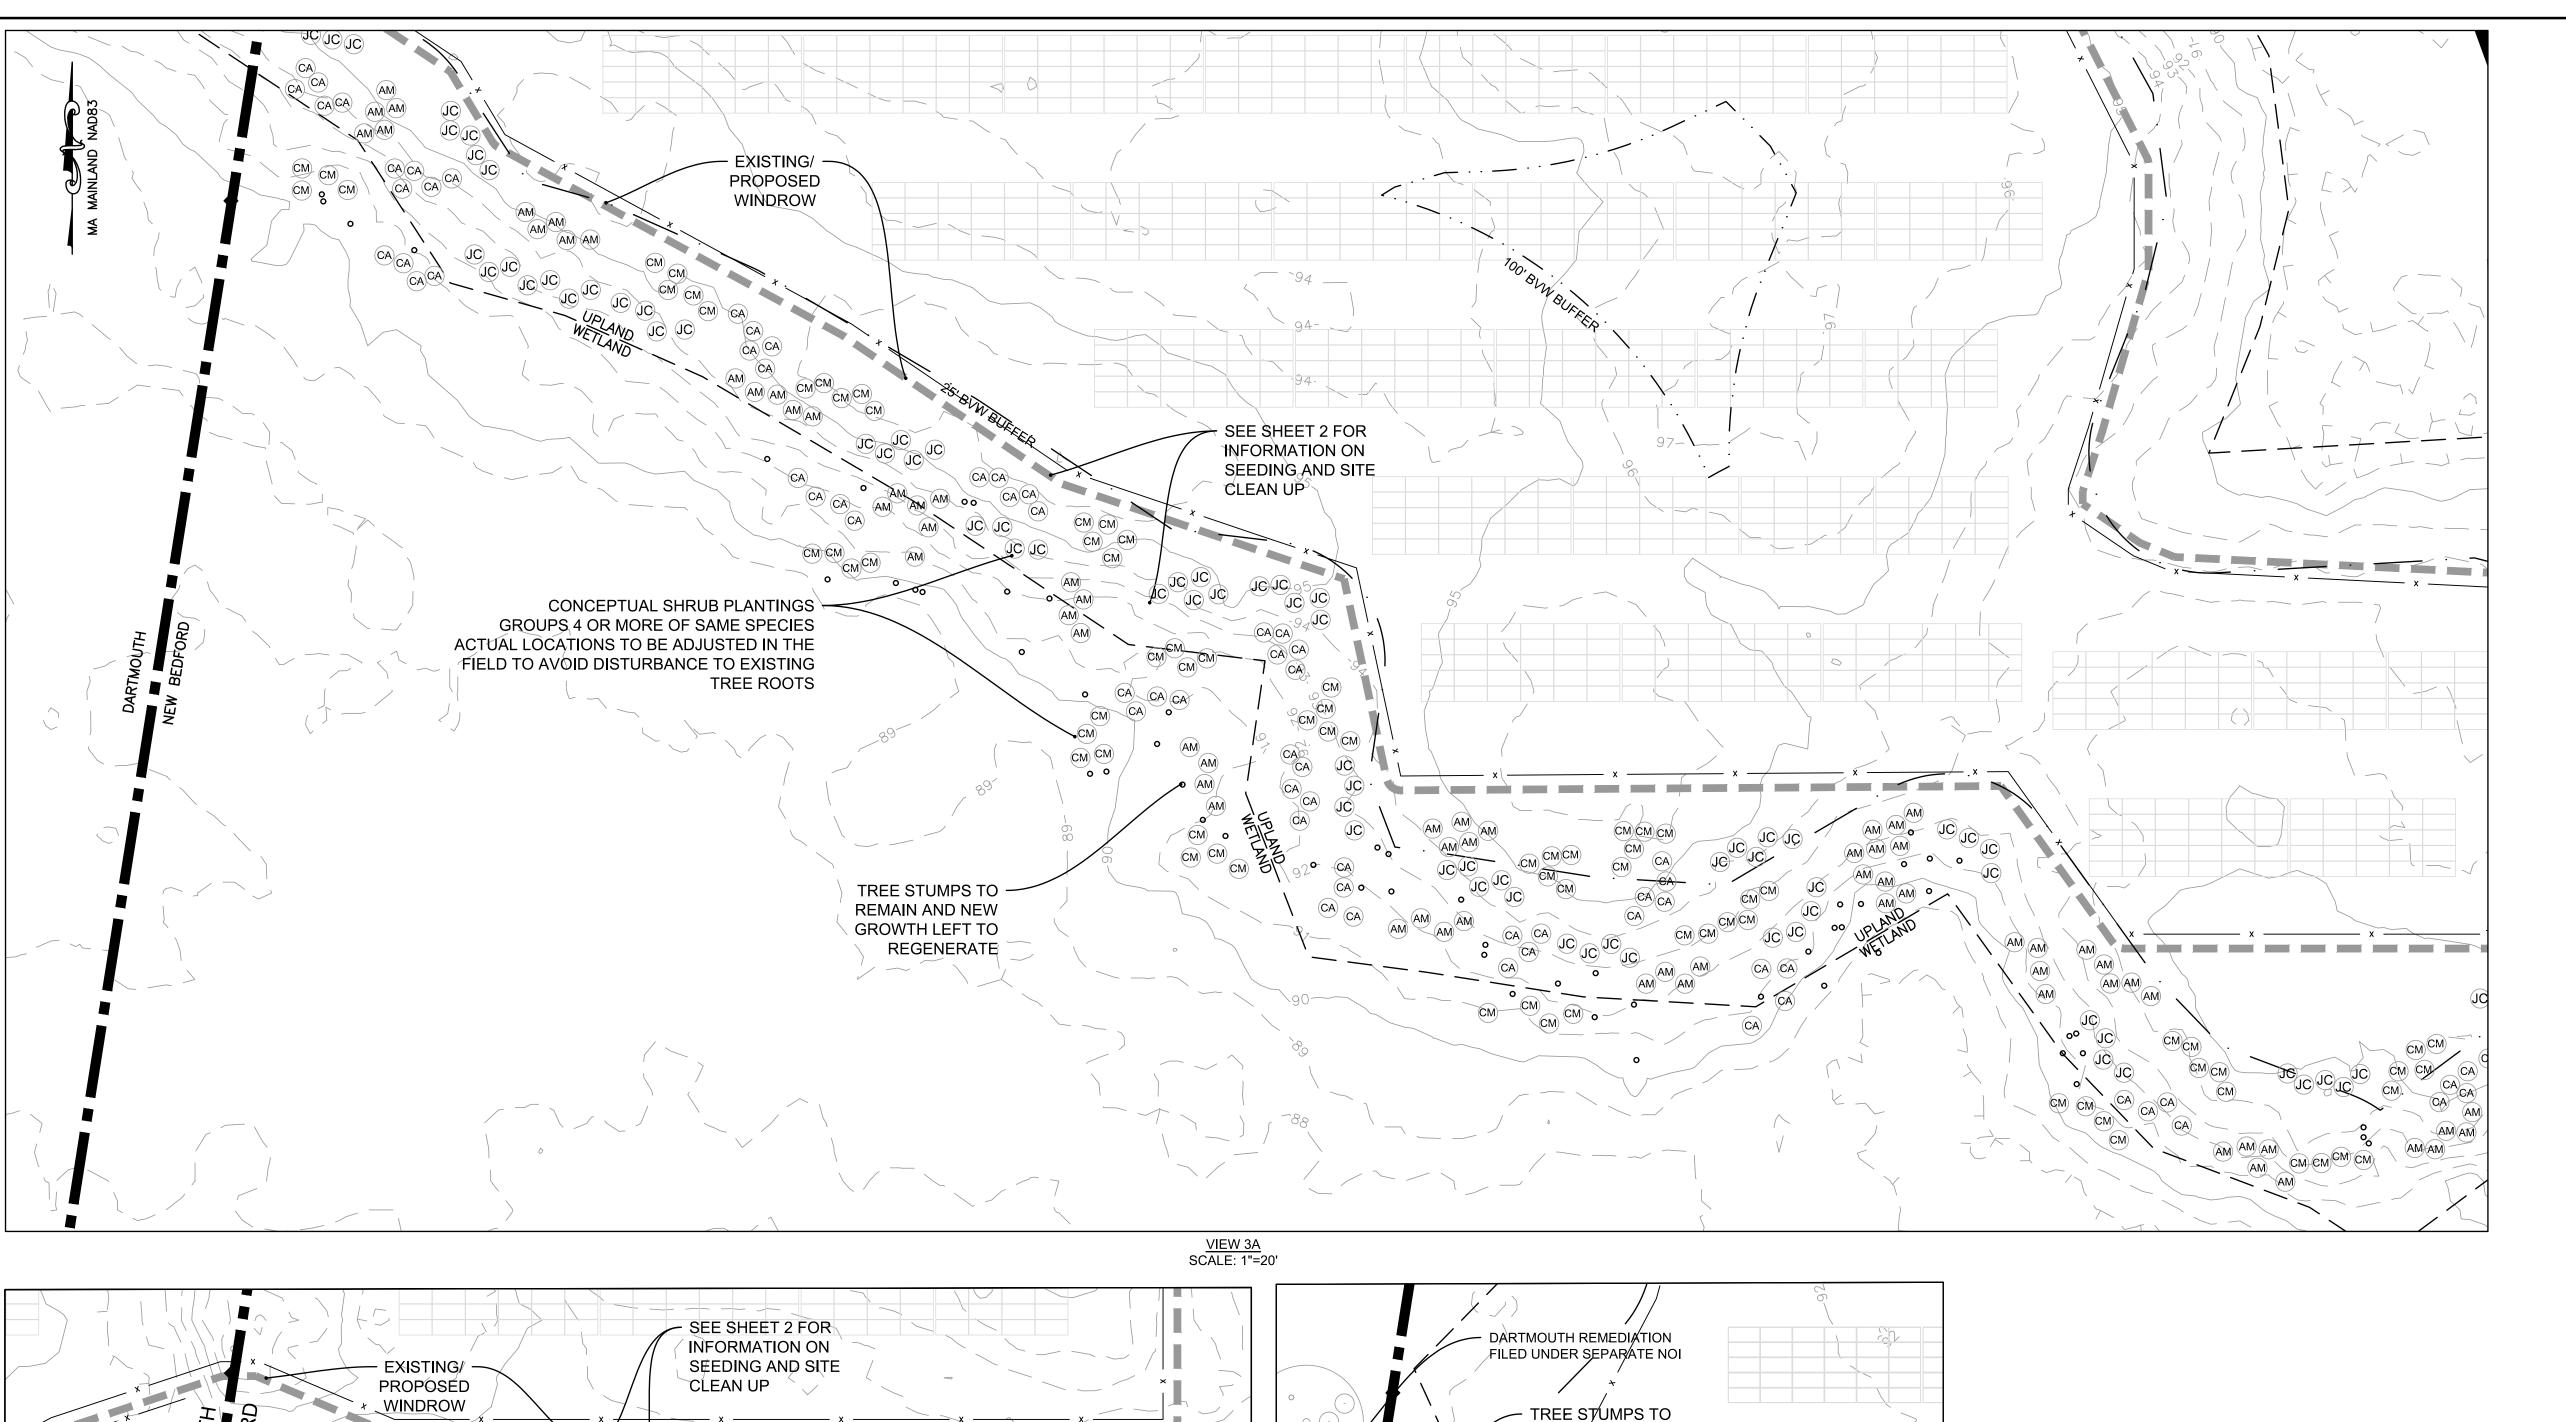

GROUPS 4 OR MORE OF SAME SPECIES

ACTUAL LOCATIONS TO BE ADJUSTED IN

AM FIELD TO AVOID DISTURBANCE TO EXIST

REMAIN AND NEW GROWTH LEFT TO

<u>VIEW 3B</u> SCALE: 1"=20'

DARAMOUTH

REMEDIATION · FILED UNDER SEPARATE NOI

REMAIN AND NEW GROWTH LEFT TO REGËNERATE CONCEPTUAL SHRUB PLANTINGS GROUPS 4 OR MORE OF SAME SPECIES ACTUAL LOCATIONS TO BE ADJUSTED IN THE FIELD TO AVOID DISTURBANCE TO EXISTING TREE ROOTS

<u>VIEW 3C</u> SCALE: 1"=20'

GENERAL VEGETATION REMEDIATION NOTES:

1. SEE WORK SCHEDULE BELOW. PLANTING WILL OCCUR DURING THE GROWING SEASON. THE GROWING SEASON FOR BRISTOL COUNTY (SOUTHERN) ACCORDING TO THE MASSACHUSETTS DEPARTMENT OF ENVIRONMENTAL PROTECTION INLAND WETLAND REPLICATION GUIDELINES IS APRIL 24TH TO OCTOBER 11TH.

2. ALL PLANTINGS SHALL COME FROM A REPUTABLE PLANT NURSERY OR GARDEN CENTER WITH RECEIPT OF RECEIVING ALL PLANT MATERIAL SPECIFIED IN THIS RESTORATION PLAN AND FOR THE RECEIPT TO BE SUBMITTED TO THE CONSERVATION

3. SEE PLANTING SCHEDULE FOR NUMBER OF SPECIES. THE LOCATIONS SHOWN ON THE PLAN ARE APPROXIMATE AND SHOULD BE ADJUSTED ON SITE, TO AVOID DAMAGE TO EXISTING TREE ROOTS AND INCREASE THE SUCCESSFUL ESTABLISHMENT OF PLANTINGS.

4. PRIOR TO SHRUB PLANTING, PLANTS SHALL BE "LAYED OUT" IN GROUPS OF THE SAME SPECIES (5 OR 10 PLANTS PER GROUP).

5. ONCE HOLES ARE DUG FOR EACH INDIVIDUAL TREE PLANTING, 1 PART ORGANIC COW MANURE AND 2 PARTS ORGANIC PEAT SHALL BE PLACED IN THE HOLE TO PROVIDE NUTRIENTS TO THE NEW PLANTS.

6. ALL BURLAP SHALL BE REMOVED FROM PLANT SPECIMENS AND ROOTS SHALL BE TEASED APART GENTLY. PLANTS CAN THEN BE PLACED IN THEIR HOLES AND COVERED WITH LOAM UP TO THE BASE OF THE PLANT.

7. ONCE ALL PLANTING IS DONE, A REPORT WITH PICTURES OF THE OUTCOME SHALL BE SUBMITTED TO THE CONSERVATION COMMISSION.

8. THROUGHOUT THE VEGETATION REMEDIATION PROCESS THE NUMBER AND PLACEMENT OF PLANTINGS AT THE REPLICATION LOCATION MAY BE MODIFIED DEPENDING ON UNANTICIPATED CONDITIONS, IF SO RECOMMENDED BY THE CONSERVATION AGENT.

9. THE VEGETATION REMEDIATION PROCESS SHALL BE MONITORED BY A WETLAND SCIENTIST RETAINED BY THE OWNER AND BY THE DARTMOUTH CONSERVATION AGENT. THE REMEDIATED AREA SHALL BE INSPECTED BY A WETLAND SCIENTIST IN THE SPRING OF 2023 AND THE SPRING OF 2024 AND THE CONDITION OF THE REMEDIATED AREAS SHALL BE REPORTED TO THE DARTMOUTH CONSERVATION COMMISSION.

PROPOSED CONSTRUCTION SCHEDULE

SUMMER 2022— FELLED TREES TO BE REMOVED OFFSITE OR CHIPPED AND USED FOR WINDROWS. DISTURBED OR SPARSE AREAS OF HERBACIOUS GROWTH TO BE SEEDED.

FALL 2022— PROPOSED PLANTINGS TO BE INSTALLED NO LATER THAN OCTOBER 11TH, 2022.

DISTURBED OR SPARSE AREAS OF HERBACIOUS GROWTH TO BE SEEDED.


<u>SPRING 2023-</u> FIRST MONITORING REPORT DUE.

COMMISSION.

FALL 2023-OCTOBER 11TH, 2023 IS THE DEADLINE FOR ANY PLANT REPLACEMENT OR RESEEDING IDENTIFIED IN THE SPRING 2023 MONITORING REPORT.

<u>SPRING 2024-</u> SECOND MONITORING REPORT DUE. CONSERVATION COMMISSION TO ISSUE AN

CERTIFICATE OF COMPLIANCE IF REQUIREMENTS HAVE BEEN MET.

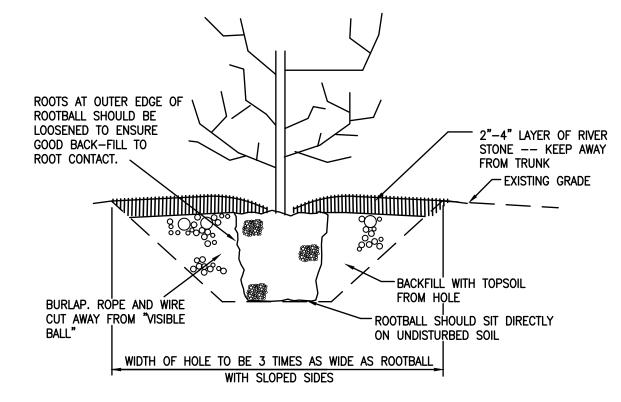

CONTAINER GROWN SHRUB AND TREE PLANTING DETAIL NOT TO SCALE

VEGETATION REMEDIATION PLANTING SCHEDULE						
SYMBOL	LATIN NAME	COMMON NAME	WETLAND INDICATOR STATUS	MIN. SIZE.	QUANTITY	
АМ	ARONIA MELANOCARPA	BLACK CHOKEBERRY	FAC	18"-24" HT.	100	
CA	CEANOTHUS AMERICANUS	NEW JERSEY TEA	FACU-	18"-24" HT.	100	
СМ	CORBYS AMOMUM	SILKY DOGWOOD	FACW	18"-24" HT.	100	
JC	JUNIPERUS COMMUNIS	COMMON JUNIPER	FAC	18"-24" HT.	100	

				DRAWING TITLE			SCALE:	
				PROPOSI	ED VEGETATION REMEDIATION	ON PLAN	1"=80'	
				DDO IFOT			DATE:	
				PROJECT PROPOS	ED VEGETATION REMEDIATION PRO JOHN VERTENTE BOULEVARD	GRAM	6/22/2022	
							DRAWN BY:	
				CLIENT	NEW BEDFORD, MASSACHUSETTS		JAG	
					KEARSARGE SOLAR RE LLC		DESIGNED BY:	
2022/08/26	GENERAL REVISIONS	JAG	RJR		REARGARGE GOLAR RE 110		RJR	
· ' '				• CIVIL ENGINEERING		P.O. BOX 1088	CHECKED BY:	SHEET NO.
2022/08/02	INCREASE PLANT QUANTITY/DENSITY	JAG	RJR	• LAND SURVEYING	<i>(</i> ?)	350 BEDFORD ST.	RJR	3
2022/07/07	VEGETATION REMEDIATION PLAN	JAG	RJR	• ENVIRONMENTAL		LAKEVILLE, MA 02347	APPROVED BY:	PROJECT NO.
DATE	DESCRIPTION	BY	APP.	ASSESSMENT		TEL: 508.947.0050 FAX: 508.947.2004	RJR	2779-01-01

