EIGHTEN & UNION

New Bedford, MA

11 & 13 COMMERCIAL STREET/ 10 FRONT STREET NEW BEDFORD, MA 02740

INTERIOR AND EXTERIOR RENOVATION



Lanagan & Co. Inc.

—REAL PROPERTY BROKER——



INDEX OF DRAWINGS G0.0 COVER SHEET

ARCHITECT OF RECORD

COMMIS


SITE

nca

Newport Collaborative Architects

2 Marlborough Street Newport, RI 02840 Phone: (401) 466-7900

Web Site: newportcollaborativearchitects.com

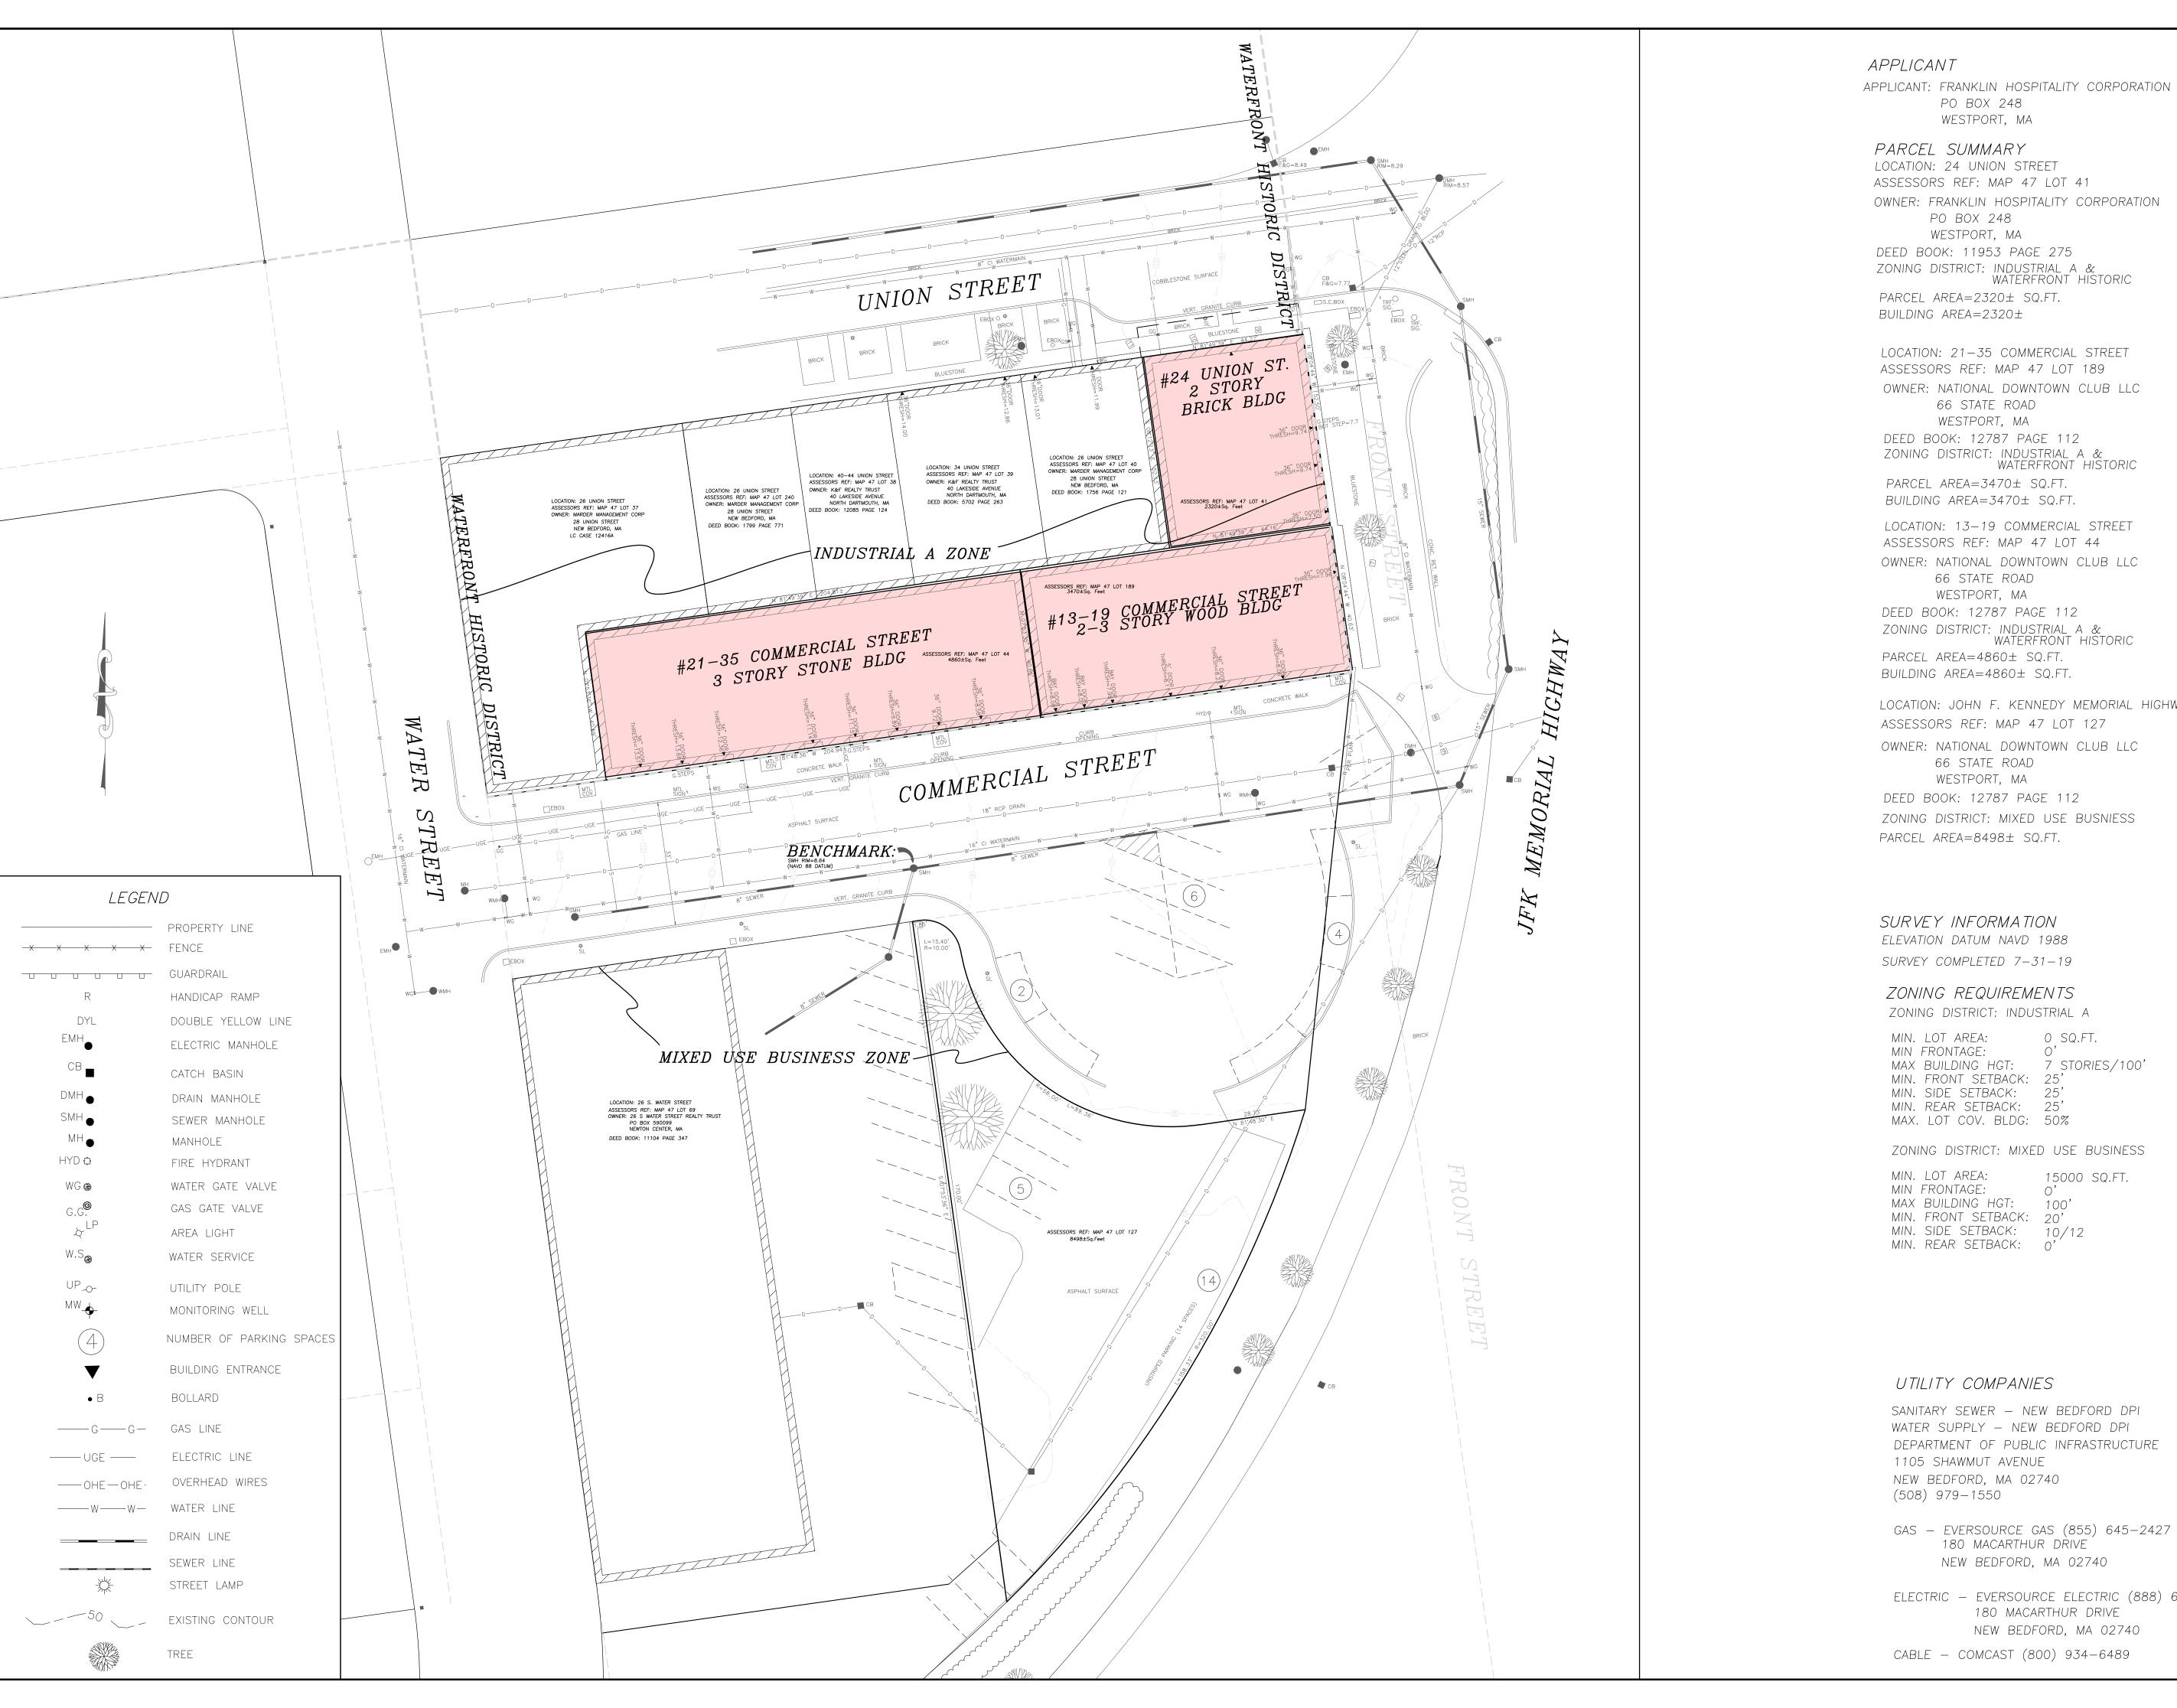

APPLICANT: FRANKLIN HOSPITALITY CORPORATION

OWNER: FRANKLIN HOSPITALITY CORPORATION

LOCATION: 21-35 COMMERCIAL STREET

ZONING DISTRICT: INDUSTRIAL A & WATERFRONT HISTORIC

OWNER: NATIONAL DOWNTOWN CLUB LLC

LOCATION: JOHN F. KENNEDY MEMORIAL HIGHWAY

OWNER: NATIONAL DOWNTOWN CLUB LLC

ZONING DISTRICT: MIXED USE BUSNIESS

MAX BUILDING HGT: 7 STORIES/100'

ZONING DISTRICT: MIXED USE BUSINESS

15000 SQ.FT.

SANITARY SEWER - NEW BEDFORD DPI WATER SUPPLY — NEW BEDFORD DPI DEPARTMENT OF PUBLIC INFRASTRUCTURE

ELECTRIC — EVERSOURCE ELECTRIC (888) 633—3797 180 MACARTHUR DRIVE NEW BEDFORD, MA 02740




λa									
D D									
2									
date: 1 = 20	61-00-01	drawn: DNA	checked:		approved: SDG	choot		,	1-77
13-19, 21-35 COMMERCIAL STREET, 24 UNION STREET	SW JFK MEMOKIAL HIGHWAY			- $+$ $+$ $+$ $+$ $+$ $+$ $+$ $+$ $+$ $+$		drawing title:		EXISTING CONDITIONS PLAN	
SITECTION	449 Faunce Corner Road	Dartmouth, Ma 02747	(508) 998-2125 FAY (508) 998-7554		769 Plain Street, Unit C	Marshileid, MA 02030 (781) 319-0100	FAX (781) 834-4783		

TE

File No. 19 - 7314

Acad No. 19-7314 EC

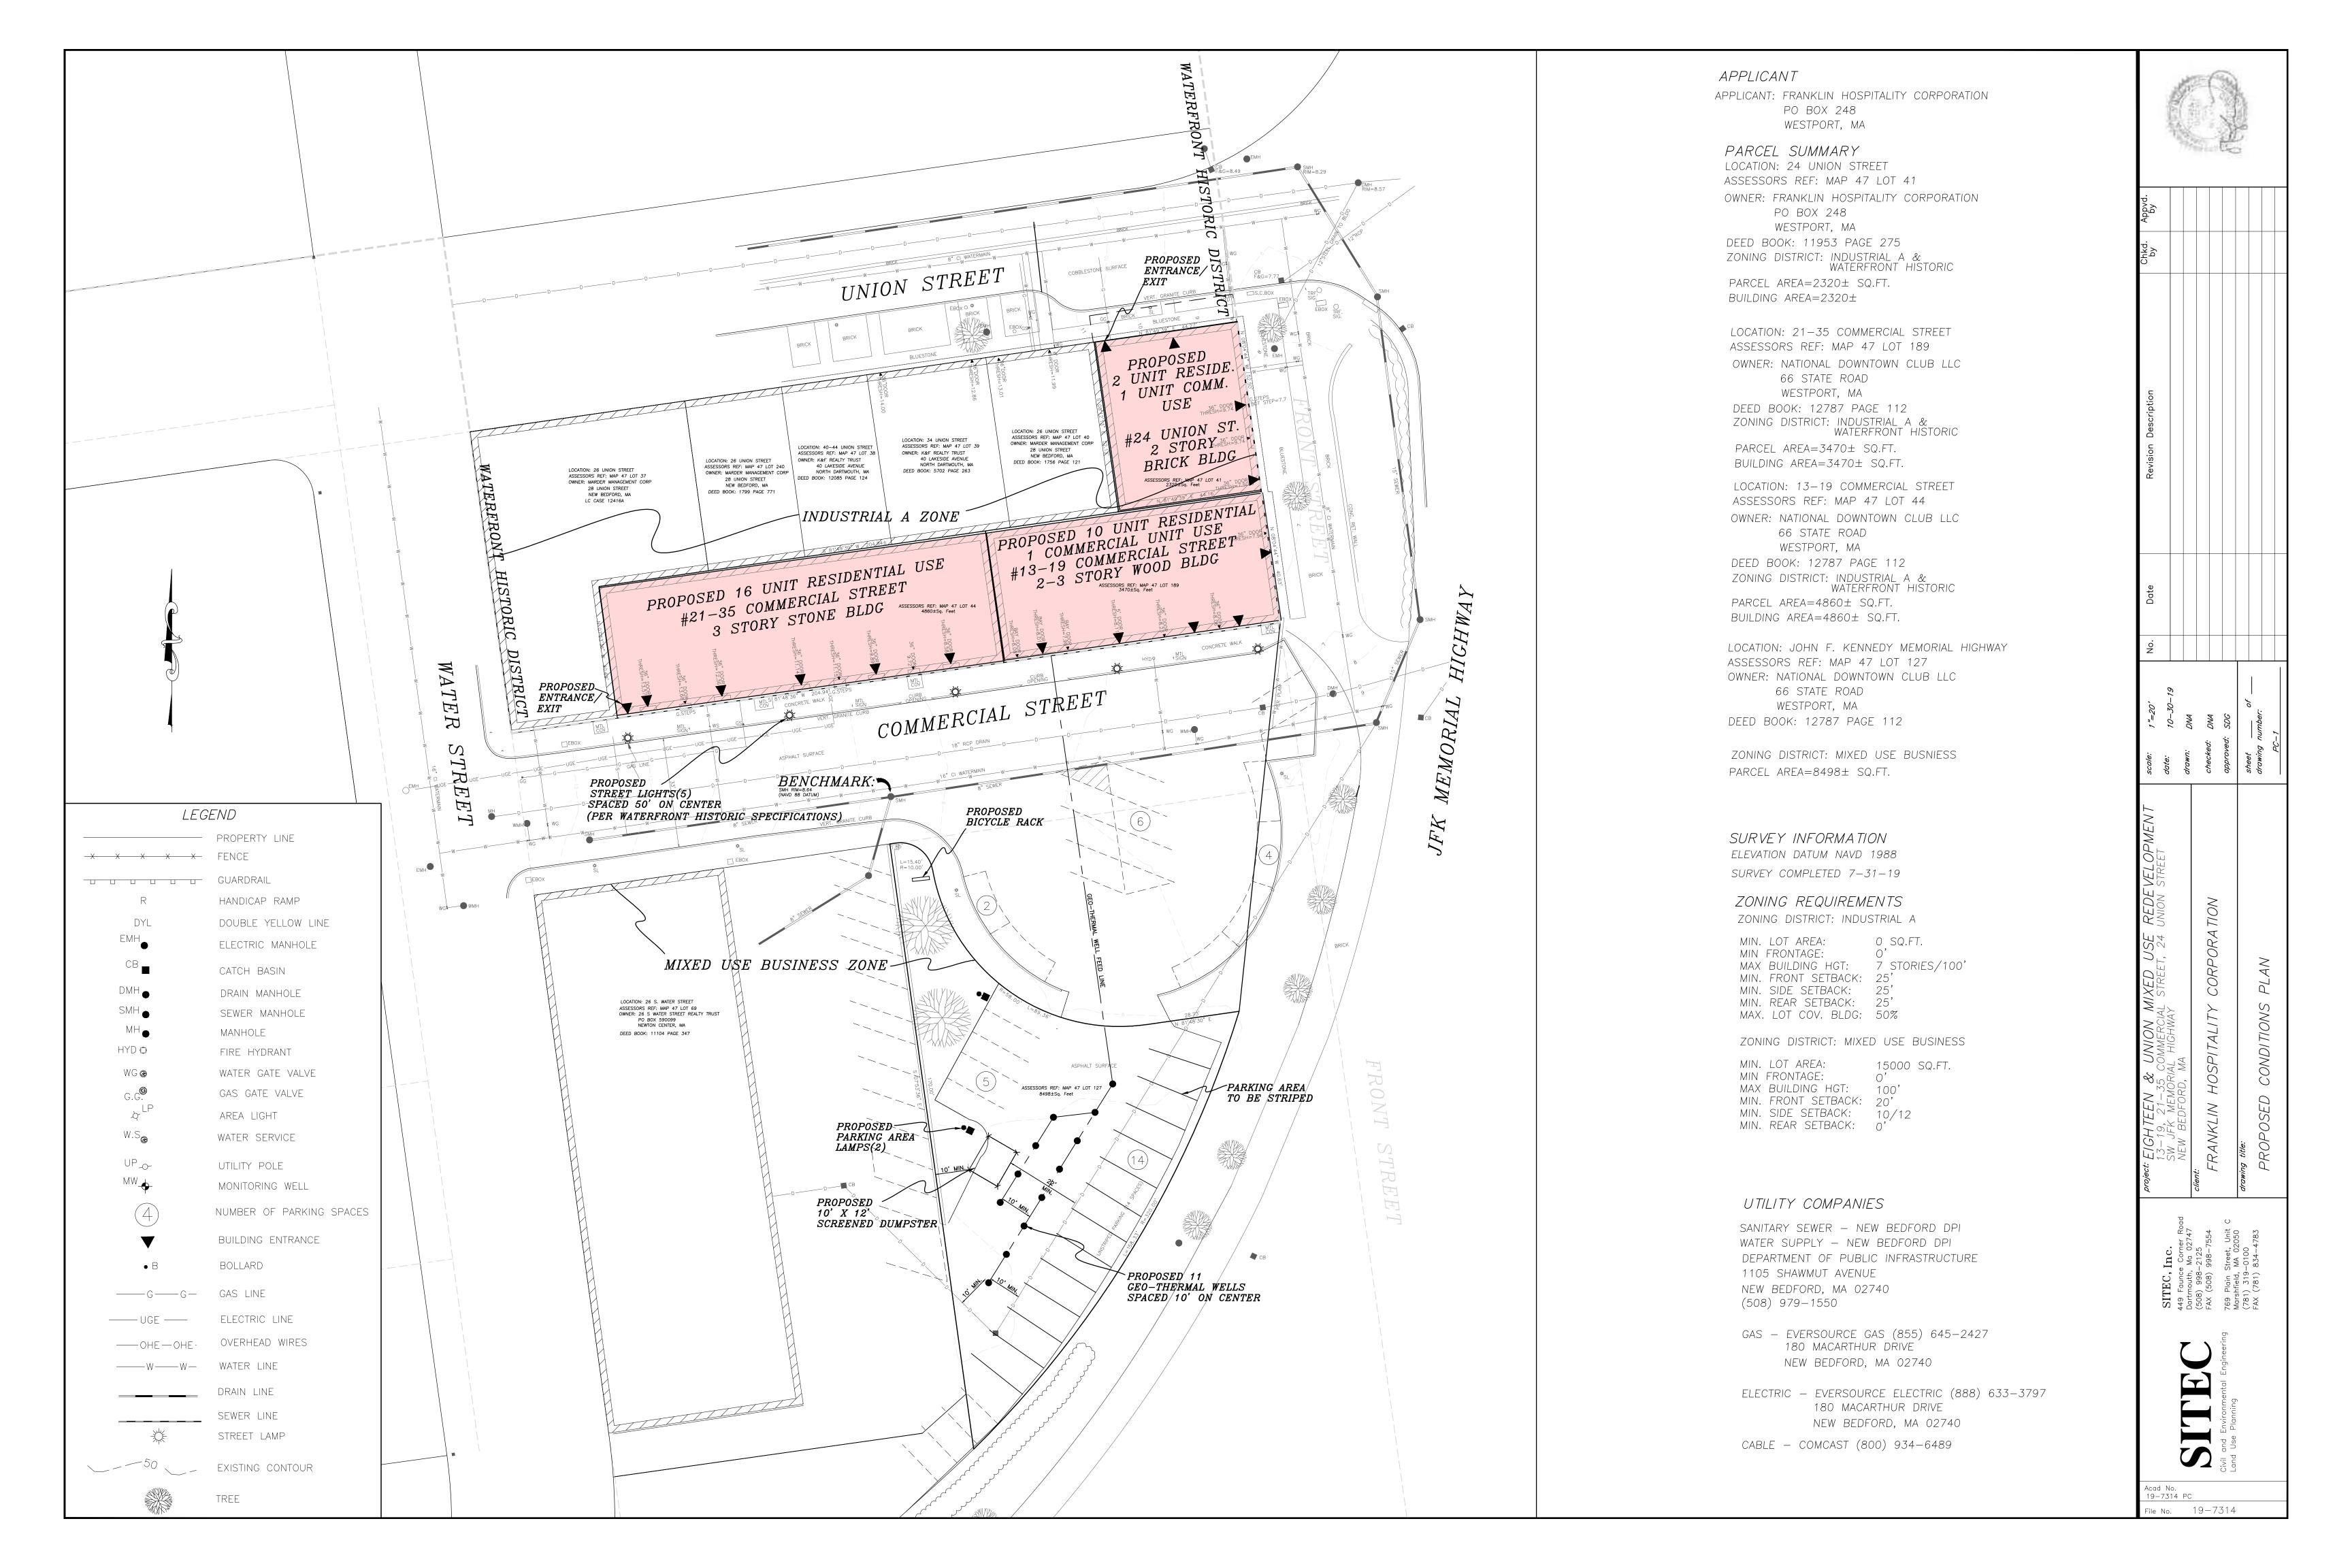

Floor	Unit	Description		sq. ft
1	RETAIL	ar were up a thirt t	一	563
1	101	2 BEDROOM/2 BATH		909
1	102	2 BEDROOM/2 BATH		882
1	LOBBY	Z BEDROOM/Z BATTI	┪	929
1	103	ADA 2 BEDROOM/2 BATH		875
1	103	ADA 2 BEDROOM/2 BATH		854
1	104	ADA 2 BEDROOM/2 BATH		825
1	105	2 BEDROOM/2 BATH	-	852
1	107	1 BEDROOM/1 BATH	\dashv	663
1		NATIONAL CLUB		
<u> </u>	COMMERCIAL	NATIONAL CLUB		2196
		DAID A DEDDOOM /A DATH	4	
_		BNB 2 BEDROOM/2 BATH		
2	201A	INTERCONNECT TO 201A	_	997
		BNB 2 BEDROOM/2 BATH		
2	201B	INTERCONNECT TO 201A	_	1218
		1 BEDROOM/1 BATH CONNECT		
2	202	TO 203	_	733
		1 BEDROOM/1 1/2 BATH		
2	203	CONNECT TO 202		677
2	204	1 BEDROOM/1 1/2 BATH		754
2	205	1 BEDROOM/1 BATH		600
2	206	1 BEDROOM/1 BATH		714
2	207	1 BEDROOM/ 1 DEN/1 BATH		733
2	208	1 BEDROOM/1 BATH		758
2	209	1 BEDROOM/ 1 DEN/1 BATH		746
2	210	1 BEDROOM/1 BATH		620
		TOWNHOUSE UNIT	2	
3 & 4	301	BEDROOM/ 2 BATH		1026
		TOWNHOUSE UNIT	2	
3 & 4	302	BEDROOM/ 2 BATH		908
		TOWNHOUSE UNIT		
3 & 4	303	1 BEDROOM/ 1 1/2 BATH		1006
-	333	TOWNHOUSE UNIT	_	
3 & 4	304	1 BEDROOM/ 1 BATH		778
~ w T	307	TOWNHOUSE UNIT	2	,,,
3 & 4	305	BEDROOM/ 1 1/2 BATH		1014
J 0X **	303	TOWNHOUSE UNIT	\dashv	1014
3 & 4	306	1 BEDROOM/ 1 BATH		996
J 04 4	300	·	2	330
304	207	TOWNHOUSE UNIT	4	905
3 & 4	307	BEDROOM/ 1 1/2 BATH	ᅴ	895
	222	TOWNHOUSE UNIT	2	,,,,,,
3 & 4	308	BEDROOM/ 2 1/2 BATH	4	1063
			إ_	
		TOWNHOUSE UNIT	2	
3 & 4	309	BEDROOM/ 2 1/2 BATH + DEN	_	1336
		TOWNHOUSE UNIT	2	
3 & 4	310	BEDROOM/ 2 1/2 BATH		1119
			1	

Newport Collaborative Architects 2 Marlborough Street Newport, RI 02840 Phone: (401) 466-7900

Web Site: newportcollaborativearchitects.com

Lanagan & Co. Inc.



EIGHTEEN & UNION New Bedford, MA

11 & 13 COMMERCIAL STREET/ 10 FRONT STREET NEW BEDFORD, MA 02740

FOR REVIEW ONLY NOT FOR CONSTRUCTION


INTERIOR AND EXTERIOR RENOVATION

G0.1

Project Number:
19002

Date Issued:
11/01/2019

ARCHITECTS

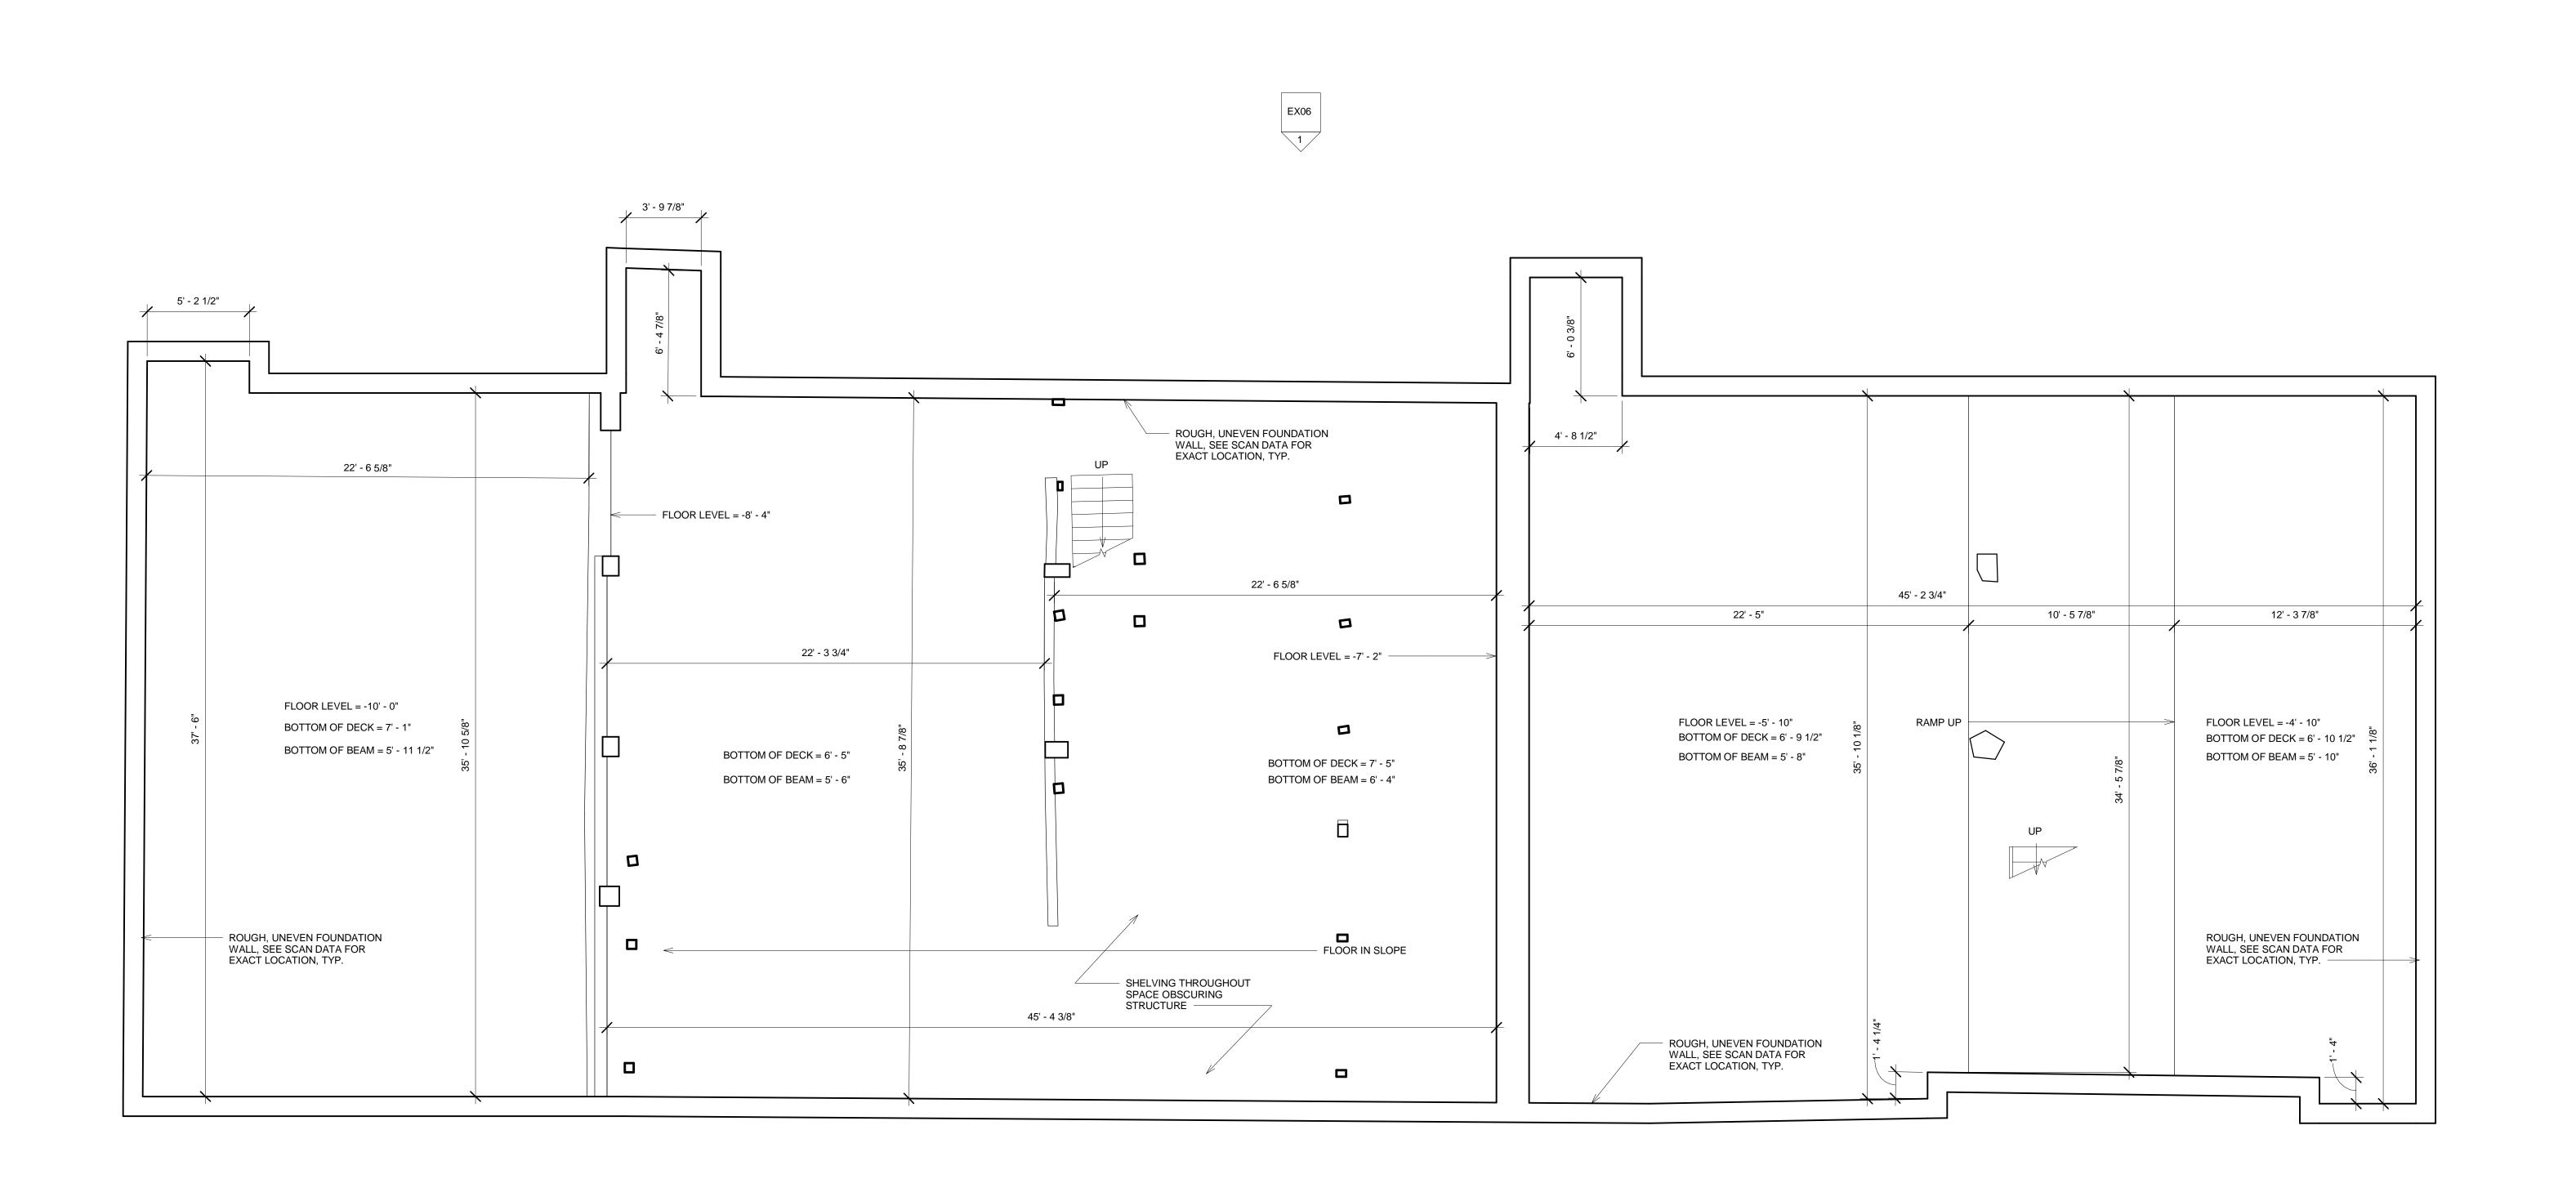

New Bedford, MA

Existing Conditions Surveys Inc. 398 Columbus Avenue #334

Boston, MA 02116 USA

T 617.247.9161 F 617.249.0746

E info@existingconditions.com www.existingconditions.com

The Most Accurate Existing Conditions Surveys and As-Built Surveys™

All projects are measured using the most advanced laser measuring equipment and our best standards and practices. All work will be field verified by client prior to design or construction or other use, please visit www.existingconditions.com for terms and conditions of use.

www.existingconditions.com

General Notes:

 It is expressly understood by client that ECS is not an architectural or engineering entity. None of the documents prepared by ECS for client shall have any stamping or certification of such trade professionals.
 This is not a structural or MEP analysis or due diligence model. Visible and accessible elements are modeled for location and size. Further structural or MEP analysis could be necessary by others. size. Further structural or MEP analysis could be necessary by others.

3. STANDARD OF PRACTICE. Services performed by ECS under this Agreement will be conducted in a manner consistent with that level of care and skill ordinarily exercised by members of the profession currently practicing in the same locality under similar conditions. No other representation, expressed or implied, and no warranty or guarantee is included or intended in this Agreement, or in any report, opinion, document or otherwise. Client shall field verify all work prior to design construction, or other use.

Laser Scanning Notes:

1. Visit FARO.com and leica-geosystems.com for 3D laser scanner tolerances, range information and product specifications.
2. Laser scanning equipment uses light waves to measure distances, unforeseen site conditions such as dust, moisture, vibration, surface reflectivity, lighting conditions, temperature, humidity, ferromagnetic materials, building configuration etc. may impact registration between scan locations.
3. Accuracy over long distances can be improved if the client provides survey benchmarks prior to scanning in order to reference the laser scan data into a coordinate system.
4. The Revit file contains the most complete alignment of point cloud data. All laser scanning by default is in a localized coordinate system. Laser scans completed on multiple days may be tied into previous laser scans by use of site specific features and targets. Point cloud adjustments are made in Revit for a final verification.


Revision Schedule

Revision Revision Revision Number Description Date

Existing Basement Floor Plan

Date: 11/01/2019 EX01 Drawn By: ECS



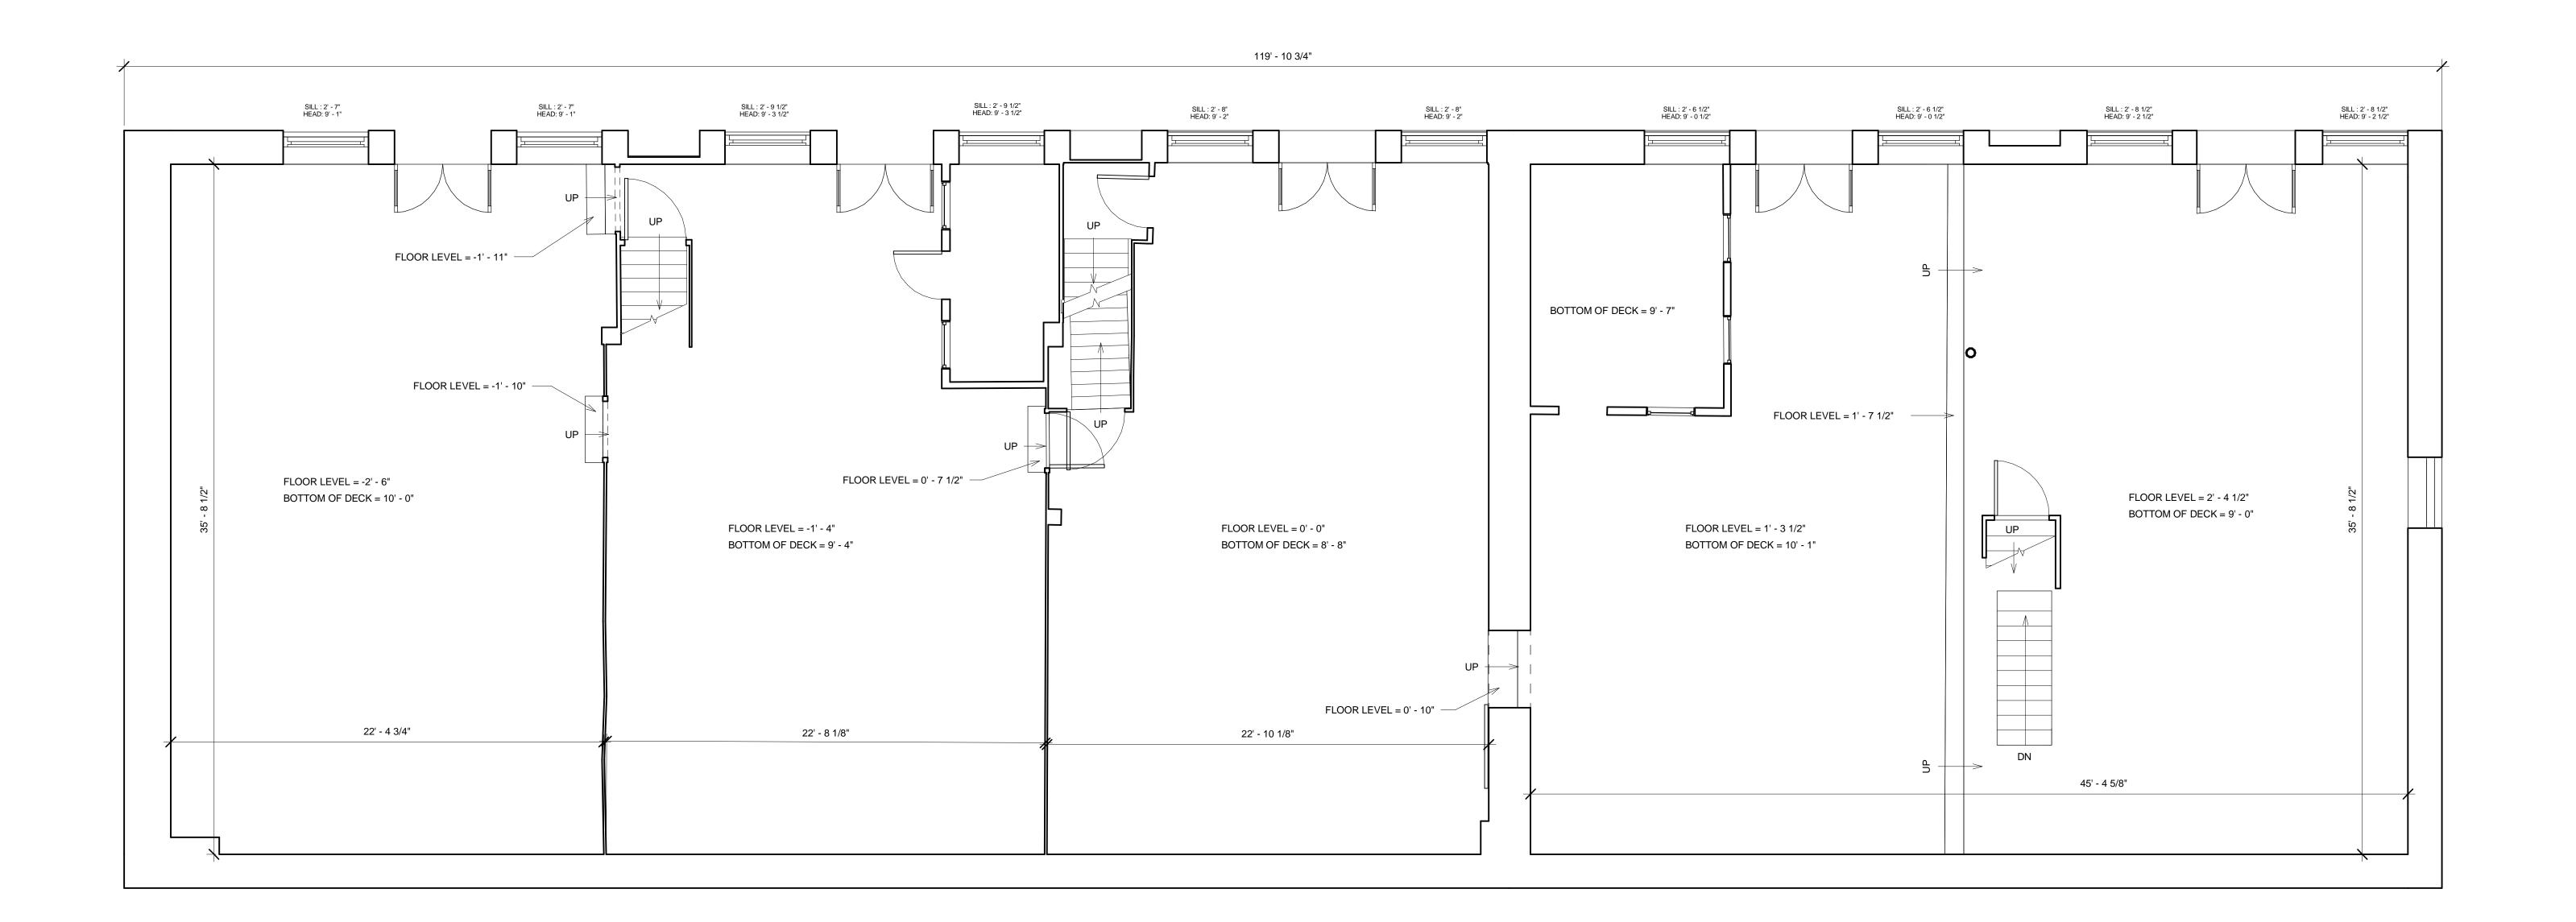

New Bedford, MA

Existing Conditions Surveys Inc. 398 Columbus Avenue #334

Boston, MA 02116 USA

T 617.247.9161

F 617.249.0746 E info@existingconditions.com

www.existingconditions.com

The Most Accurate Existing Conditions Surveys and As-Built Surveys™

All projects are measured using the most advanced laser measuring equipment and our best standards and practices. All work will be field verified by client prior to design or construction or other use, please visit www.existingconditions.com for terms and conditions of use.

www.existingconditions.com

General Notes:

 It is expressly understood by client that ECS is not an architectural or engineering entity. None of the documents prepared by ECS for client shall have any stamping or certification of such trade professionals.
 This is not a structural or MEP analysis or due diligence model. Visible and accessible elements are modeled for location and size. Further structural or MEP analysis could be necessary by others. size. Further structural or MEP analysis could be necessary by others.

3. STANDARD OF PRACTICE. Services performed by ECS under this Agreement will be conducted in a manner consistent with that level of care and skill ordinarily exercised by members of the profession currently practicing in the same locality under similar conditions. No other representation, expressed or implied, and no warranty or guarantee is included or intended in this Agreement, or in any report, opinion, document or otherwise. Client shall field verify all work prior to design construction, or other use.

Laser Scanning Notes:

1. Visit FARO.com and leica-geosystems.com for 3D laser scanner tolerances, range information and product specifications.
2. Laser scanning equipment uses light waves to measure distances, unforeseen site conditions such as dust, moisture, vibration, surface reflectivity, lighting conditions, temperature, humidity, ferromagnetic materials, building configuration etc. may impact registration between scan locations.
3. Accuracy over long distances can be improved if the client provides survey benchmarks prior to scanning in order to reference the laser scan data into a coordinate system.
4. The Revit file contains the most complete alignment of point cloud data. All laser scanning by default is in a localized coordinate system. Laser scans completed on multiple days may be tied into previous laser scans by use of site specific features and targets. Point cloud adjustments are made in Revit for a final verification.


Revision Schedule

Revision Revision Revision Number Description Date

Existing First Floor Plan

Date: 11/01/2019 EX02 Drawn By: ECS



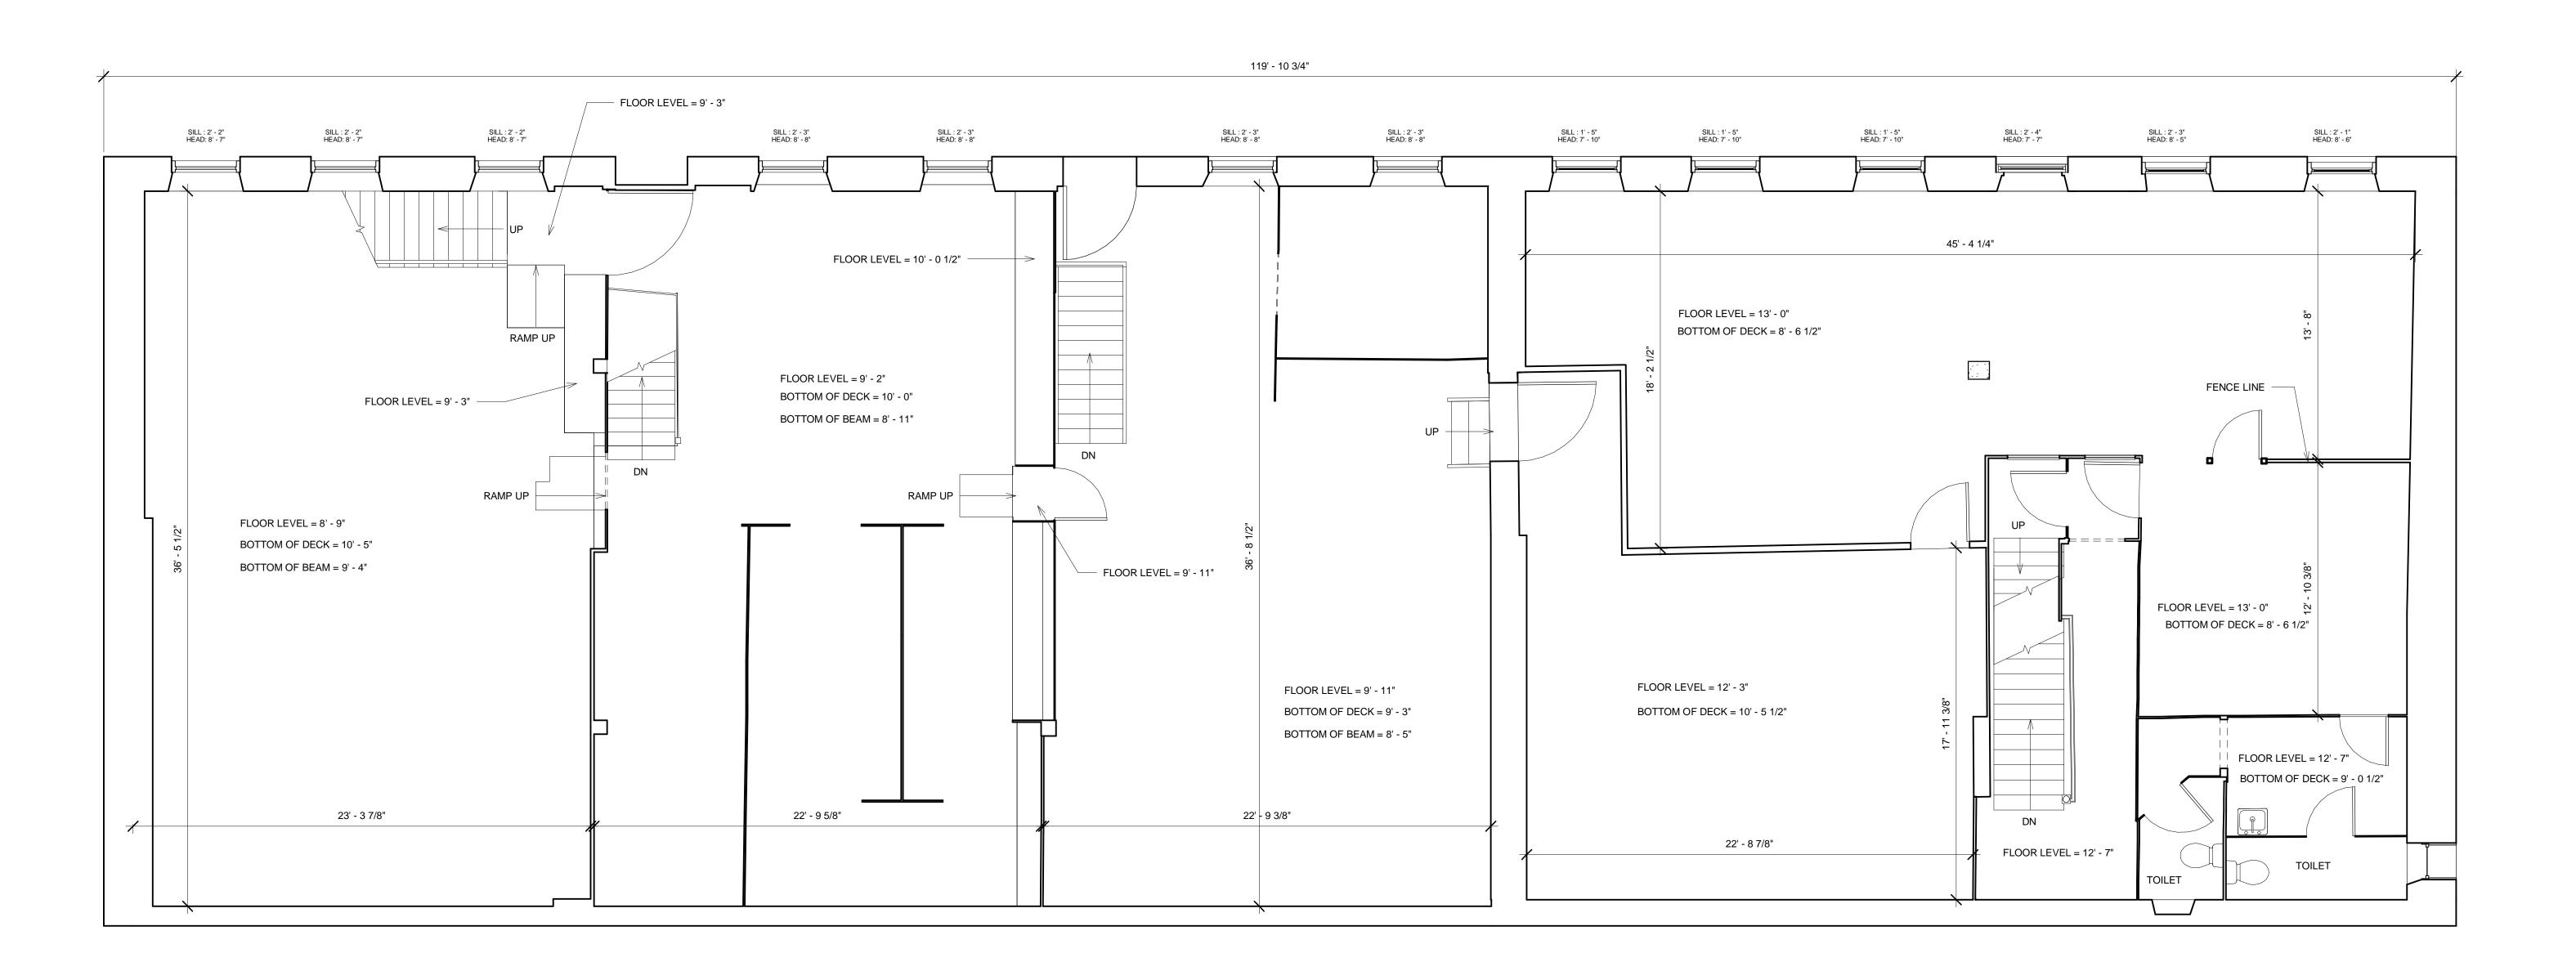

New Bedford, MA

Existing Conditions Surveys Inc.

398 Columbus Avenue #334 Boston, MA 02116 USA

T 617.247.9161 F 617.249.0746

E info@existingconditions.com www.existingconditions.com

The Most Accurate Existing Conditions Surveys and As-Built Surveys™

All projects are measured using the most advanced laser measuring equipment and our best standards and practices. All work will be field verified by client prior to design or construction or other use, please visit www.existingconditions.com for terms and conditions of use.

www.existingconditions.com

General Notes:

 It is expressly understood by client that ECS is not an architectural or engineering entity. None of the documents prepared by ECS for client shall have any stamping or certification of such trade professionals.

 This is not a structural or MEP analysis or due diligence model. Visible and accessible elements are modeled for location and size. Further structural or MEP analysis could be necessary by others. size. Further structural or MEP analysis could be necessary by others.

3. STANDARD OF PRACTICE. Services performed by ECS under this Agreement will be conducted in a manner consistent with that level of care and skill ordinarily exercised by members of the profession currently practicing in the same locality under similar conditions. No other representation, expressed or implied, and no warranty or guarantee is included or intended in this Agreement, or in any report, opinion, document or otherwise. Client shall field verify all work prior to design construction, or other use.

Laser Scanning Notes:

1. Visit FARO.com and leica-geosystems.com for 3D laser scanner tolerances, range information and product specifications.
2. Laser scanning equipment uses light waves to measure distances, unforeseen site conditions such as dust, moisture, vibration, surface reflectivity, lighting conditions, temperature, humidity, ferromagnetic materials, building configuration etc. may impact registration between scan locations.
3. Accuracy over long distances can be improved if the client provides survey benchmarks prior to scanning in order to reference the laser scan data into a coordinate system.
4. The Revit file contains the most complete alignment of point cloud data. All laser scanning by default is in a localized coordinate system. Laser scans completed on multiple days may be tied into previous laser scans by use of site specific features and targets. Point cloud adjustments are made in Revit for a final verification.


Revision Schedule

Revision Revision Revision Number Description Date

Existing Second Floor Plan

Date: 11/01/2019 EX03 Drawn By: ECS



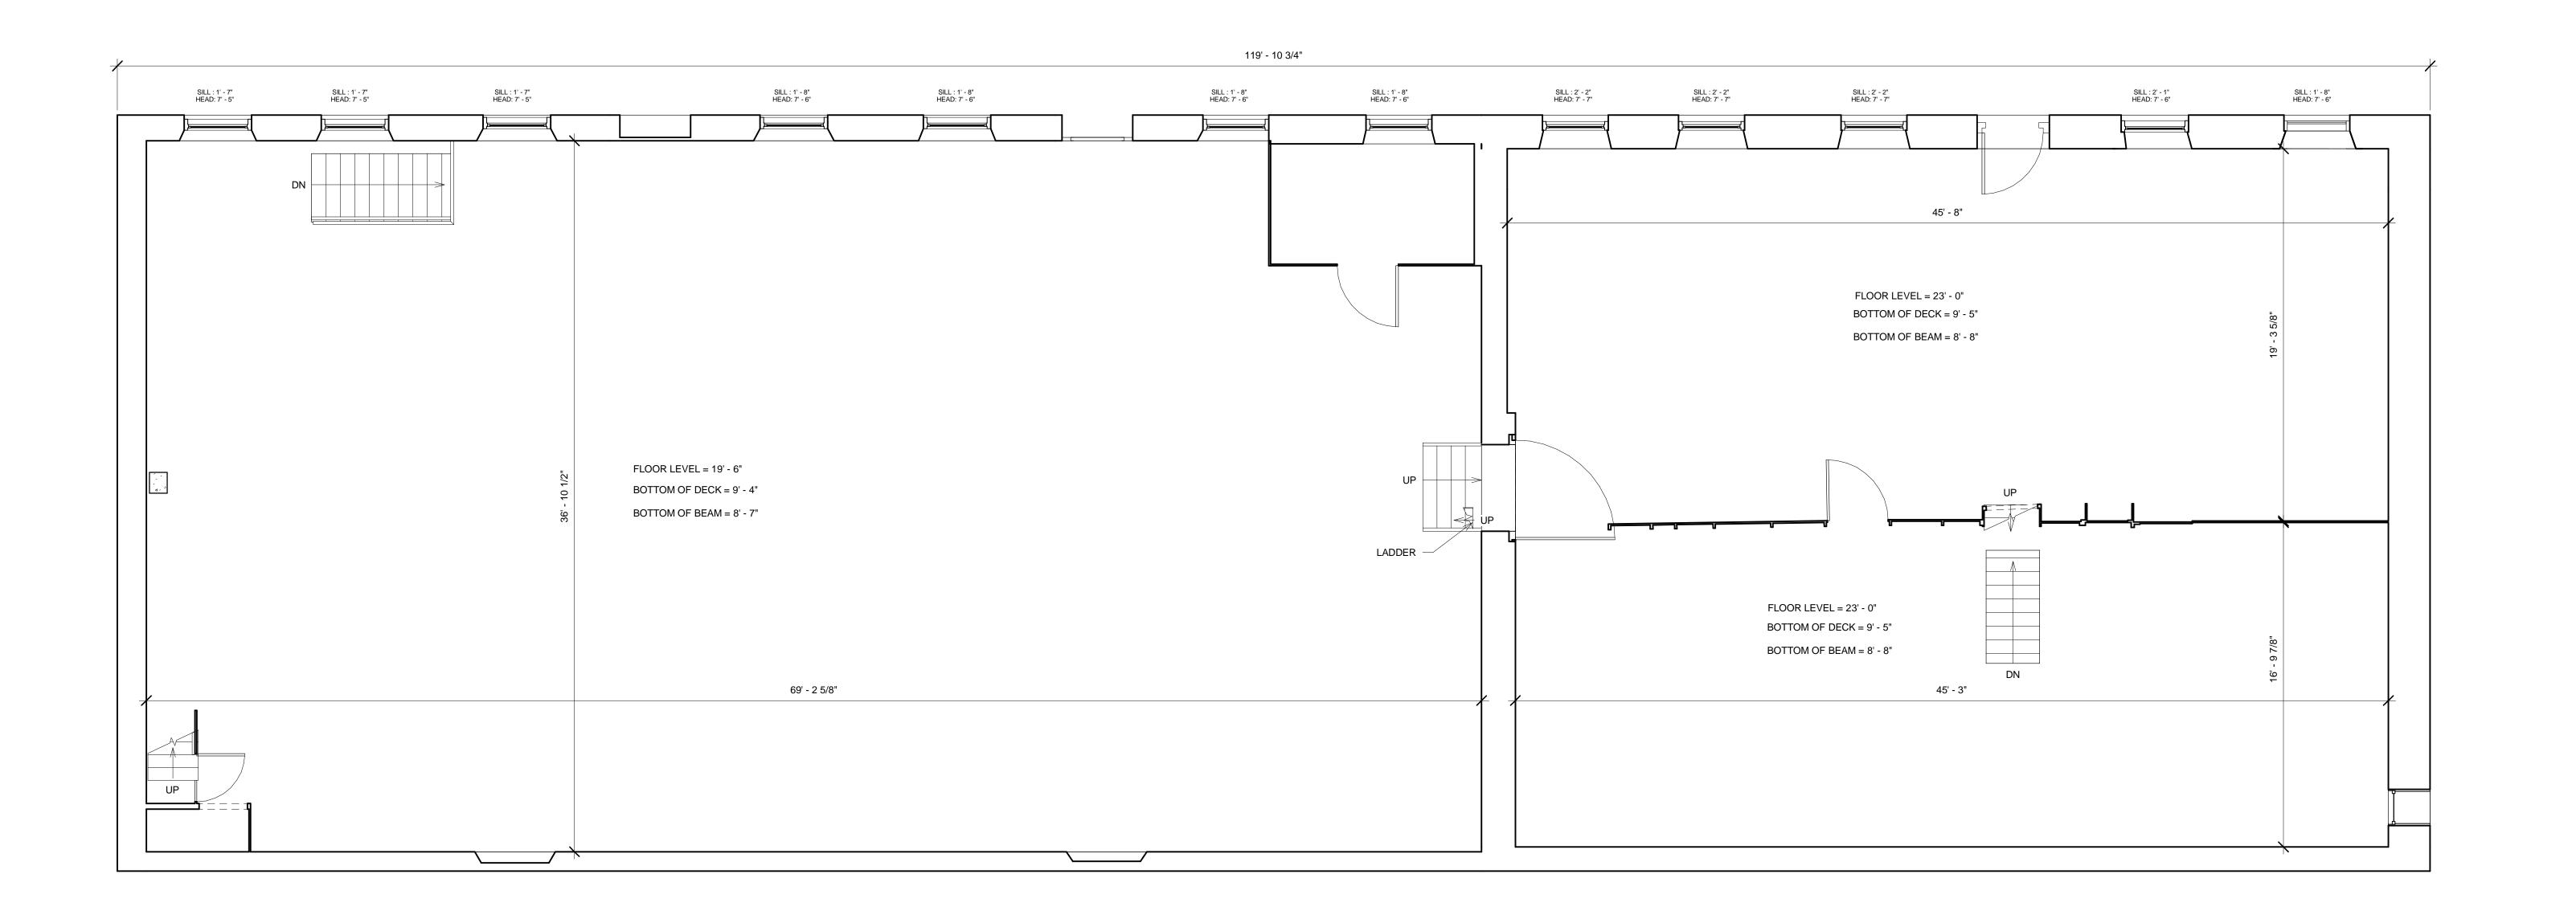

New Bedford, MA

Existing Conditions Surveys Inc. 398 Columbus Avenue #334

Boston, MA 02116 USA

T 617.247.9161 F 617.249.0746

E info@existingconditions.com www.existingconditions.com

The Most Accurate Existing Conditions Surveys and As-Built Surveys™

All projects are measured using the most advanced laser measuring equipment and our best standards and practices. All work will be field verified by client prior to design or construction or other use, please visit www.existingconditions.com for terms and conditions of use.

www.existingconditions.com

General Notes:

Laser Scanning Notes:

 It is expressly understood by client that ECS is not an architectural or engineering entity. None of the documents prepared by ECS for client shall have any stamping or certification of such trade professionals.
 This is not a structural or MEP analysis or due diligence model. Visible and accessible elements are modeled for location and size. Further structural or MEP analysis could be necessary by others. size. Further structural or MEP analysis could be necessary by others.

3. STANDARD OF PRACTICE. Services performed by ECS under this Agreement will be conducted in a manner consistent with that level of care and skill ordinarily exercised by members of the profession currently practicing in the same locality under similar conditions. No other representation, expressed or implied, and no warranty or guarantee is included or intended in this Agreement, or in any report, opinion, document or otherwise. Client shall field verify all work prior to design construction, or other use.

1. Visit FARO.com and leica-geosystems.com for 3D laser scanner tolerances, range information and product specifications.
2. Laser scanning equipment uses light waves to measure distances, unforeseen site conditions such as dust, moisture, vibration, surface reflectivity, lighting conditions, temperature, humidity, ferromagnetic materials, building configuration etc. may impact registration between scan locations.
3. Accuracy over long distances can be improved if the client provides survey benchmarks prior to scanning in order to reference the laser scan data into a coordinate system.
4. The Revit file contains the most complete alignment of point cloud data. All laser scanning by default is in a localized coordinate system. Laser scans completed on multiple days may be tied into previous laser scans by use of site specific features and targets. Point cloud adjustments are made in Revit for a final verification.


Revision Schedule

Revision Revision Revision Number Description Date

Existing Third Floor Plan

Date: 11/01/2019 EX04 Drawn By: ECS



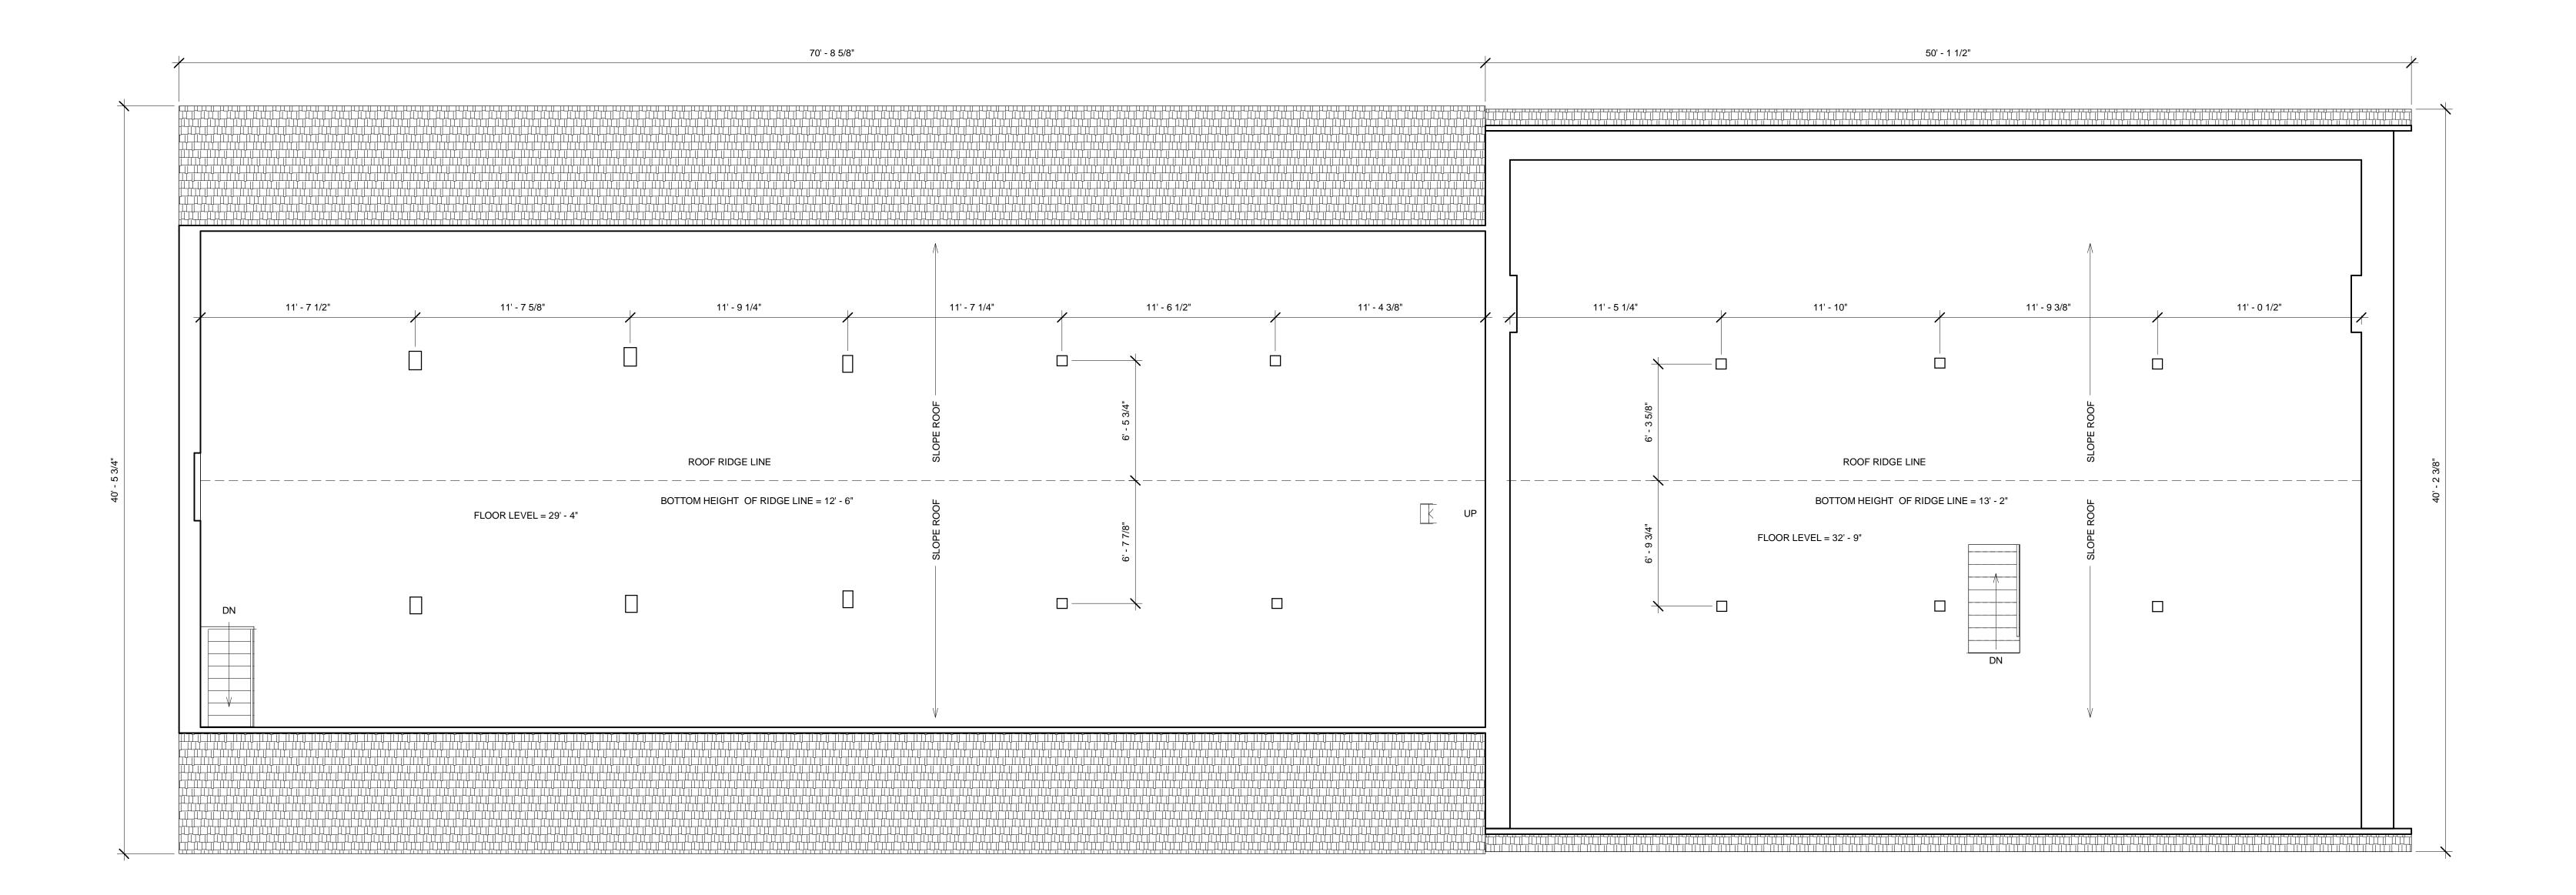

New Bedford, MA

Existing Conditions Surveys Inc. 398 Columbus Avenue #334

www.existingconditions.com

Boston, MA 02116 USA

T 617.247.9161

F 617.249.0746 E info@existingconditions.com

The Most Accurate **Existing Conditions Surveys and** As-Built Surveys[™]

All projects are measured using the most advanced laser measuring equipment and our best standards and practices. All work will be field verified by client prior to design or construction or other use, please visit www.existingconditions.com for terms and

conditions of use. www.existingconditions.com

General Notes:

Laser Scanning Notes:

 It is expressly understood by client that ECS is not an architectural or engineering entity. None of the documents prepared by ECS for client shall have any stamping or certification of such trade professionals.
 This is not a structural or MEP analysis or due diligence model. Visible and accessible elements are modeled for location and size. Further structural or MEP analysis could be necessary by others.
3. STANDARD OF PRACTICE. Services performed by ECS under this Agreement will be conducted in a manner consistent with that level of care and skill ordinarily exercised by members of the profession currently practicing in the same locality under similar conditions. No other representation, expressed or implied, and no warranty or guarantee is included or intended in this Agreement, or in any report, opinion, document or otherwise. Client shall field verify all work prior to design construction, or other use.

1. Visit FARO.com and leica-geosystems.com for 3D laser scanner tolerances, range information and product specifications.
2. Laser scanning equipment uses light waves to measure distances, unforeseen site conditions such as dust, moisture, vibration, surface reflectivity, lighting conditions, temperature, humidity, ferromagnetic materials, building configuration etc. may impact registration between scan locations.
3. Accuracy over long distances can be improved if the client provides survey benchmarks prior to scanning in order to reference the laser scan data into a coordinate system.
4. The Revit file contains the most complete alignment of point cloud data. All laser scanning by default is in a localized coordinate system. Laser scans completed on multiple days may be tied into previous laser scans by use of site specific may be tied into previous laser scans by use of site specific features and targets. Point cloud adjustments are made in Revit for a final verification.

Revision Schedule

Revision Revision Revision Number Description

Existing Roof

EX05 Drawn By: ECS



New Bedford, MA

Existing Conditions Surveys Inc. 398 Columbus Avenue #334

Boston, MA 02116 USA

T 617.247.9161 F 617.249.0746

E info@existingconditions.com www.existingconditions.com

The Most Accurate Existing Conditions Surveys and As-Built Surveys™

All projects are measured using the most advanced laser measuring equipment and our best standards and practices. All work will be field verified by client prior to design or construction or other use, please visit www.existingconditions.com for terms and conditions of use.

www.existingconditions.com

General Notes:

 It is expressly understood by client that ECS is not an architectural or engineering entity. None of the documents prepared by ECS for client shall have any stamping or certification of such trade professionals.
 This is not a structural or MEP analysis or due diligence model. Visible and accessible elements are modeled for location and size. Further structural or MEP analysis could be necessary by others. size. Further structural or MEP analysis could be necessary by others.

3. STANDARD OF PRACTICE. Services performed by ECS under this Agreement will be conducted in a manner consistent with that level of care and skill ordinarily exercised by members of the profession currently practicing in the same locality under similar conditions. No other representation, expressed or implied, and no warranty or guarantee is included or intended in this Agreement, or in any report, opinion, document or otherwise. Client shall field verify all work prior to design construction, or other use.

Laser Scanning Notes:

1. Visit FARO.com and leica-geosystems.com for 3D laser scanner tolerances, range information and product specifications.
2. Laser scanning equipment uses light waves to measure distances, unforeseen site conditions such as dust, moisture, vibration, surface reflectivity, lighting conditions, temperature, humidity, ferromagnetic materials, building configuration etc. may impact registration between scan locations.
3. Accuracy over long distances can be improved if the client provides survey benchmarks prior to scanning in order to reference the laser scan data into a coordinate system.
4. The Revit file contains the most complete alignment of point cloud data. All laser scanning by default is in a localized coordinate system. Laser scans completed on multiple days may be tied into previous laser scans by use of site specific features and targets. Point cloud adjustments are made in Revit for a final verification.


Revision Schedule

Revision Revision Revision Number Description Date

Existing Exterior North Elevation

EX06



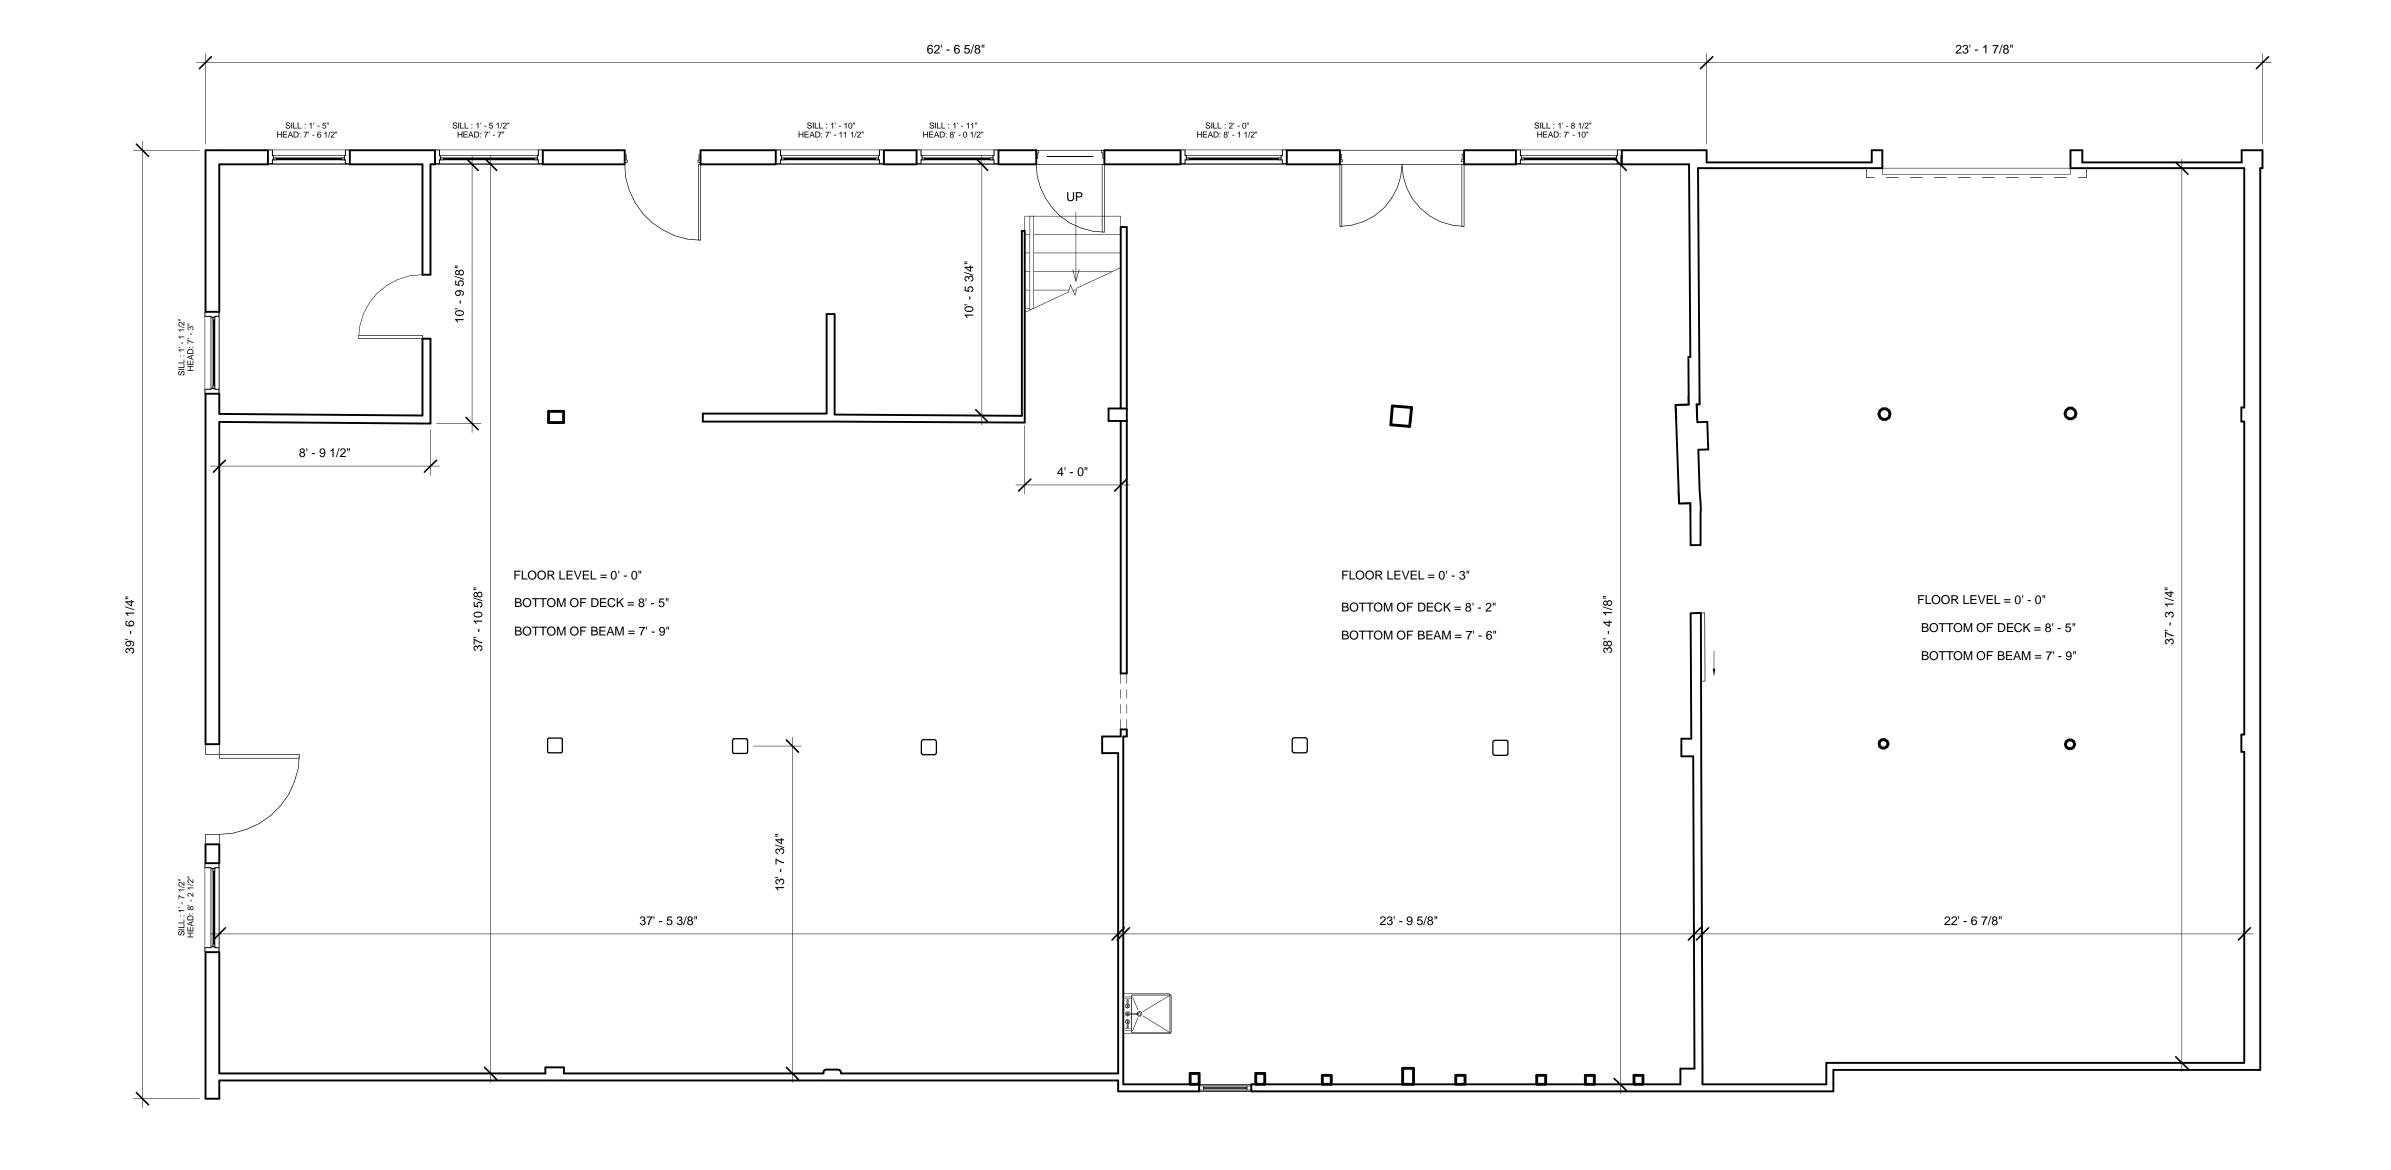

New Bedford, MA

Existing Conditions Surveys Inc. 398 Columbus Avenue #334

Boston, MA 02116 USA

T 617.247.9161

F 617.249.0746 E info@existingconditions.com

www.existingconditions.com

The Most Accurate Existing Conditions Surveys and As-Built Surveys™

All projects are measured using the most advanced laser measuring equipment and our best standards and practices. All work will be field verified by client prior to design or construction or other use, please visit www.existingconditions.com for terms and conditions of use.

www.existingconditions.com

 It is expressly understood by client that ECS is not an architectural or engineering entity. None of the documents prepared by ECS for client shall have any stamping or certification of such trade professionals.

 This is not a structural or MEP analysis or due diligence model. Visible and accessible elements are modeled for location and size. Further structural or MEP analysis could be necessary by others. size. Furtner structural or MEP analysis could be necessary by others.

3. STANDARD OF PRACTICE. Services performed by ECS under this Agreement will be conducted in a manner consistent with that level of care and skill ordinarily exercised by members of the profession currently practicing in the same locality under similar conditions. No other representation, expressed or implied, and no warranty or guarantee is included or intended in this Agreement, or in any report, opinion, document or otherwise. Client shall field verify all work prior to design construction, or other use.

Laser Scanning Notes:

1. Visit FARO.com and leica-geosystems.com for 3D laser scanner tolerances, range information and product specifications.
2. Laser scanning equipment uses light waves to measure distances, unforeseen site conditions such as dust, moisture, vibration, surface reflectivity, lighting conditions, temperature, humidity, ferromagnetic materials, building configuration etc. may impact registration between scan locations.
3. Accuracy over long distances can be improved if the client provides survey benchmarks prior to scanning in order to reference the laser scan data into a coordinate system.
4. The Revit file contains the most complete alignment of point cloud data. All laser scanning by default is in a localized coordinate system. Laser scans completed on multiple days may be tied into previous laser scans by use of site specific features and targets. Point cloud adjustments are made in Revit for a final verification.


Revision Schedule

Revision Revision Revision Number Description Date

Existing First Floor Plan

Date: 11/01/2019 EX07 Drawn By: ECS



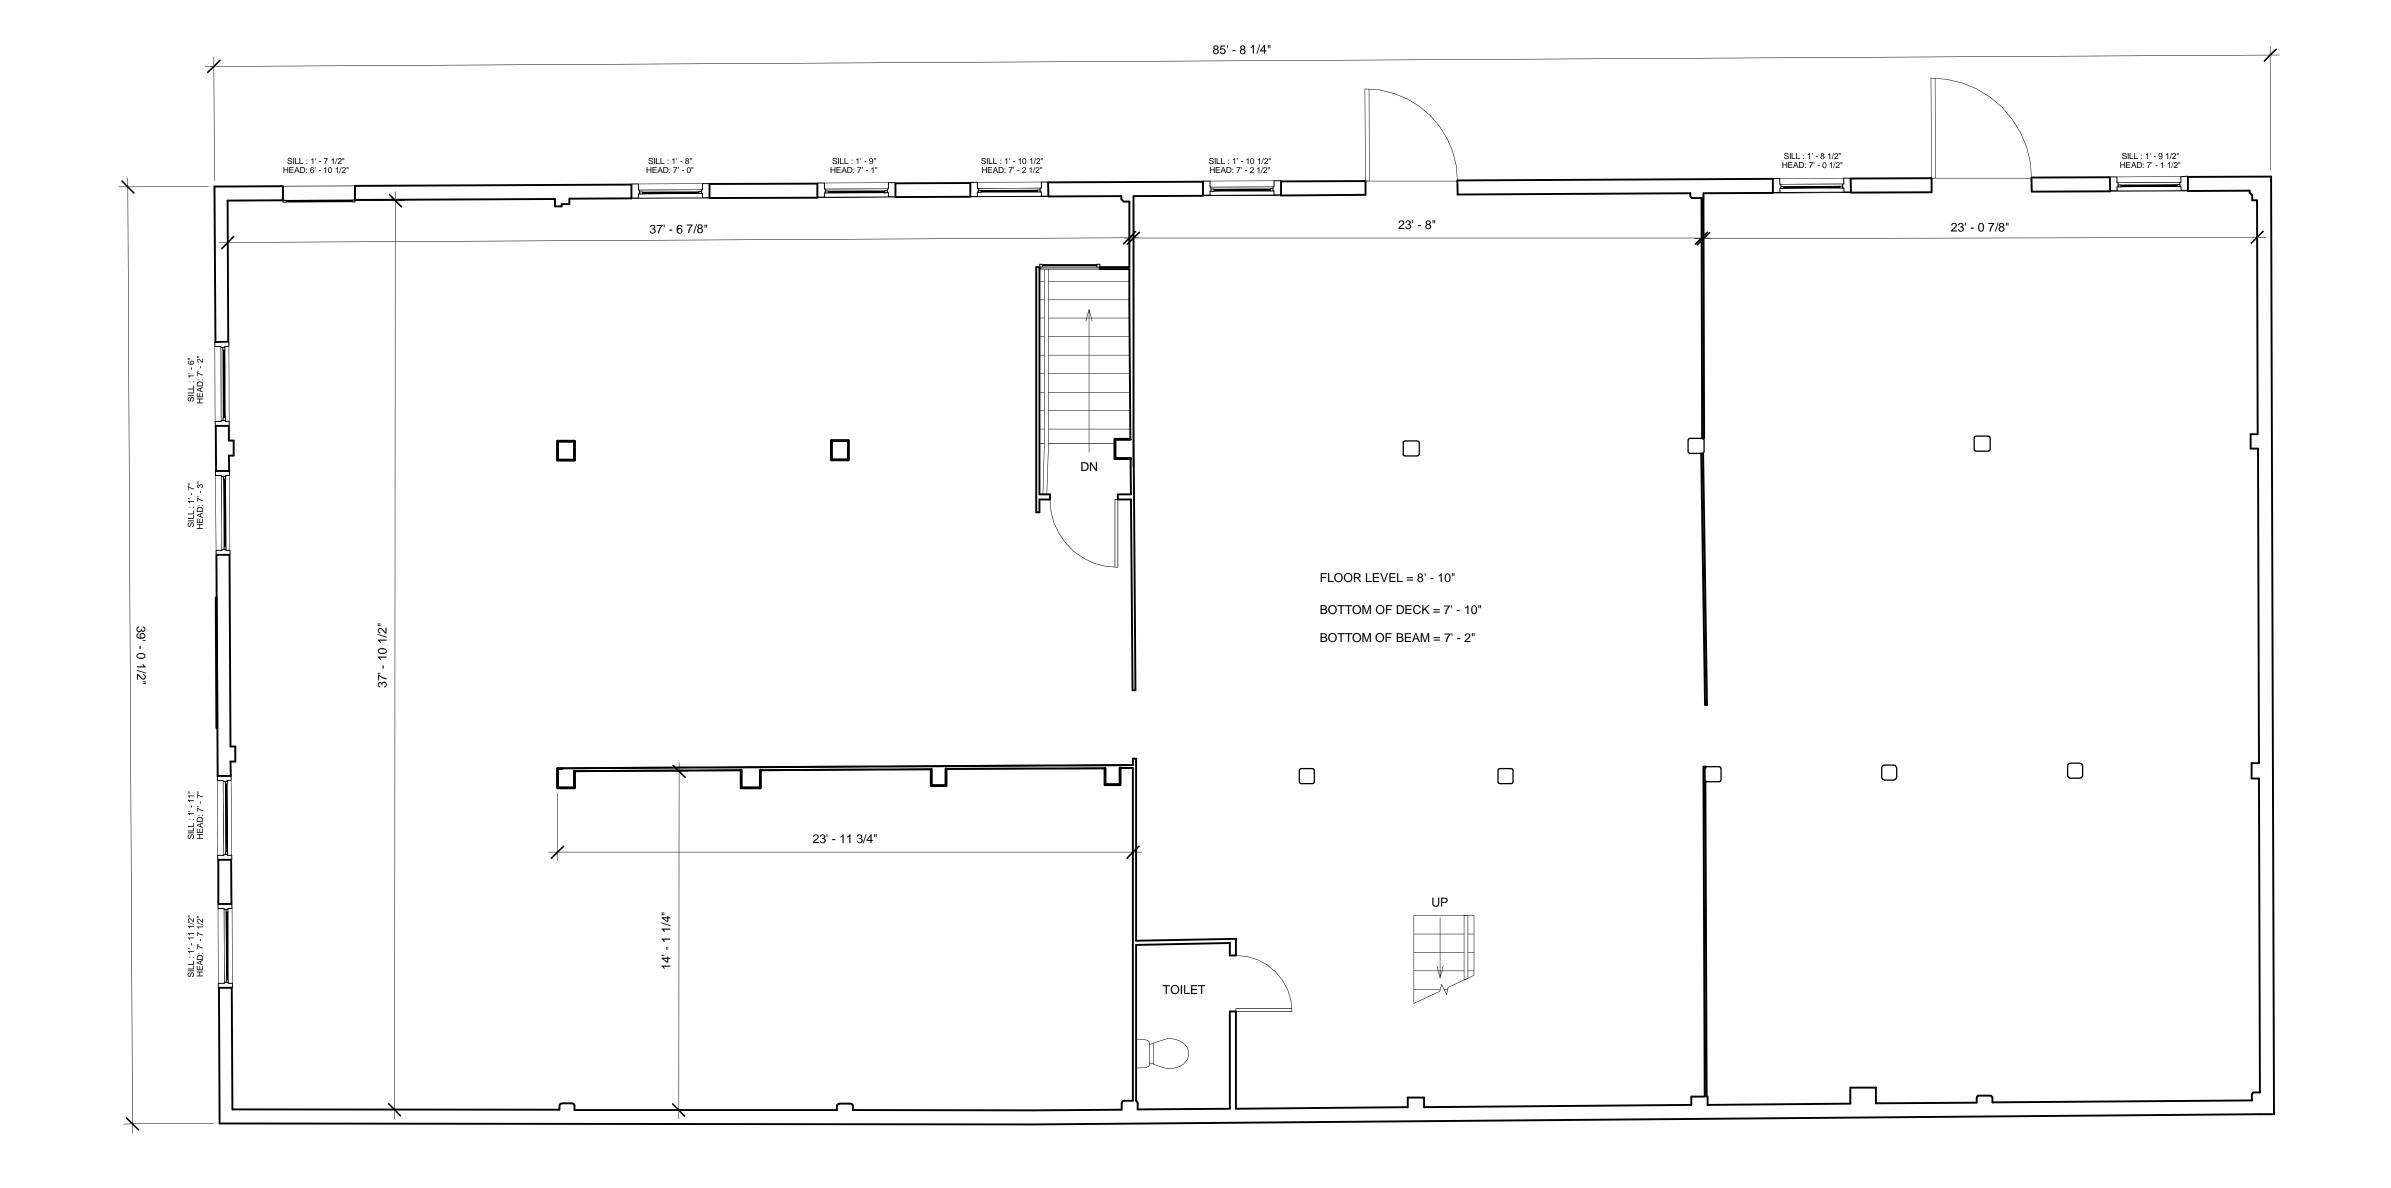

New Bedford, MA

Existing Conditions Surveys Inc. 398 Columbus Avenue #334

Boston, MA 02116 USA

T 617.247.9161 F 617.249.0746

E info@existingconditions.com www.existingconditions.com

The Most Accurate Existing Conditions Surveys and As-Built Surveys™

All projects are measured using the most advanced laser measuring equipment and our best standards and practices. All work will be field verified by client prior to design or construction or other use, please visit

www.existingconditions.com for terms and conditions of use. www.existingconditions.com

General Notes:

 It is expressly understood by client that ECS is not an architectural or engineering entity. None of the documents prepared by ECS for client shall have any stamping or certification of such trade professionals.

 This is not a structural or MEP analysis or due diligence model. Visible and accessible elements are modeled for location and size. Further structural or MEP analysis could be necessary by others. size. Further structural or MEP analysis could be necessary by others.

3. STANDARD OF PRACTICE. Services performed by ECS under this Agreement will be conducted in a manner consistent with that level of care and skill ordinarily exercised by members of the profession currently practicing in the same locality under similar conditions. No other representation, expressed or implied, and no warranty or guarantee is included or intended in this Agreement, or in any report, opinion, document or otherwise. Client shall field verify all work prior to design construction, or other use.

Laser Scanning Notes:

1. Visit FARO.com and leica-geosystems.com for 3D laser scanner tolerances, range information and product specifications.
2. Laser scanning equipment uses light waves to measure distances, unforeseen site conditions such as dust, moisture, vibration, surface reflectivity, lighting conditions, temperature, humidity, ferromagnetic materials, building configuration etc. may impact registration between scan locations.
3. Accuracy over long distances can be improved if the client provides survey benchmarks prior to scanning in order to reference the laser scan data into a coordinate system.
4. The Revit file contains the most complete alignment of point cloud data. All laser scanning by default is in a localized coordinate system. Laser scans completed on multiple days may be tied into previous laser scans by use of site specific features and targets. Point cloud adjustments are made in Revit for a final verification.


Revision Schedule

Revision Revision Revision Number Description Date


Existing Second Floor Plan

Date: 11/01/2019 EX08 Drawn By: ECS



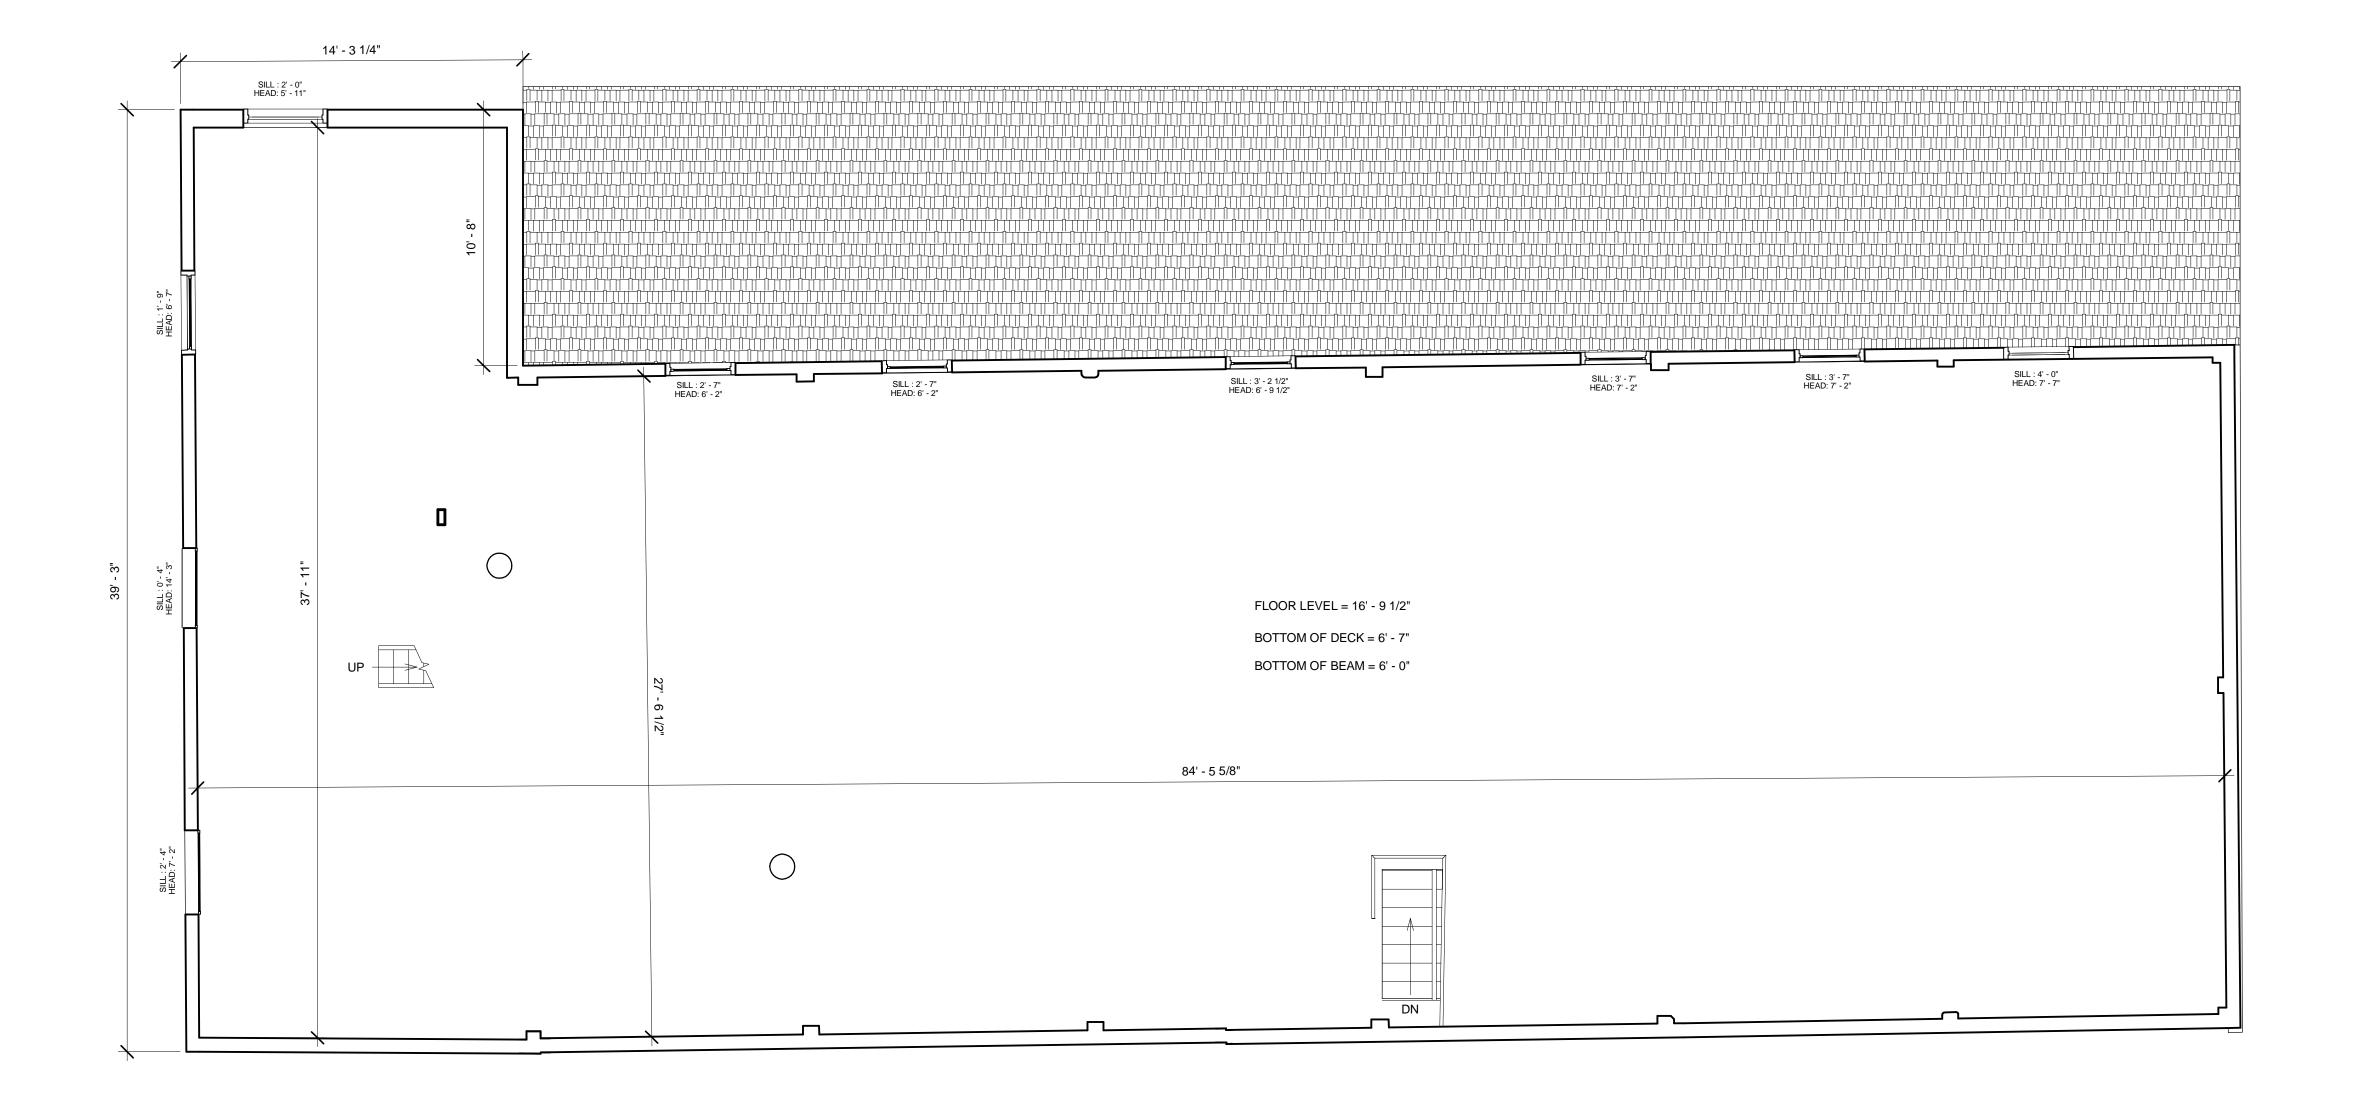

New Bedford, MA

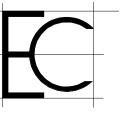

Existing Conditions Surveys Inc. 398 Columbus Avenue #334

Boston, MA 02116 USA

T 617.247.9161

F 617.249.0746 E info@existingconditions.com

www.existingconditions.com

The Most Accurate **Existing Conditions Surveys and** As-Built Surveys™

All projects are measured using the most advanced laser measuring equipment and our best standards and practices. All work will be field verified by client prior to design or construction or other use, please visit www.existingconditions.com for terms and conditions of use.

www.existingconditions.com

General Notes:

 It is expressly understood by client that ECS is not an architectural or engineering entity. None of the documents prepared by ECS for client shall have any stamping or certification of such trade professionals.
 This is not a structural or MEP analysis or due diligence model. Visible and accessible elements are modeled for location and size. Further structural or MEP analysis could be necessary by others. size. Further structural or MEP analysis could be necessary by others.

3. STANDARD OF PRACTICE. Services performed by ECS under this Agreement will be conducted in a manner consistent with that level of care and skill ordinarily exercised by members of the profession currently practicing in the same locality under similar conditions. No other representation, expressed or implied, and no warranty or guarantee is included or intended in this Agreement, or in any report, opinion, document or otherwise. Client shall field verify all work prior to design construction, or other use.

Laser Scanning Notes:

1. Visit FARO.com and leica-geosystems.com for 3D laser scanner tolerances, range information and product specifications.
2. Laser scanning equipment uses light waves to measure distances, unforeseen site conditions such as dust, moisture, vibration, surface reflectivity, lighting conditions, temperature, humidity, ferromagnetic materials, building configuration etc. may impact registration between scan locations.
3. Accuracy over long distances can be improved if the client provides survey benchmarks prior to scanning in order to reference the laser scan data into a coordinate system.
4. The Revit file contains the most complete alignment of point cloud data. All laser scanning by default is in a localized coordinate system. Laser scans completed on multiple days may be tied into previous laser scans by use of site specific features and targets. Point cloud adjustments are made in Revit for a final verification.


Revision Schedule

Revision Revision Revision Number Description Date


Existing Third Floor Plan

Date: 11/01/2019 EX09 Drawn By: ECS



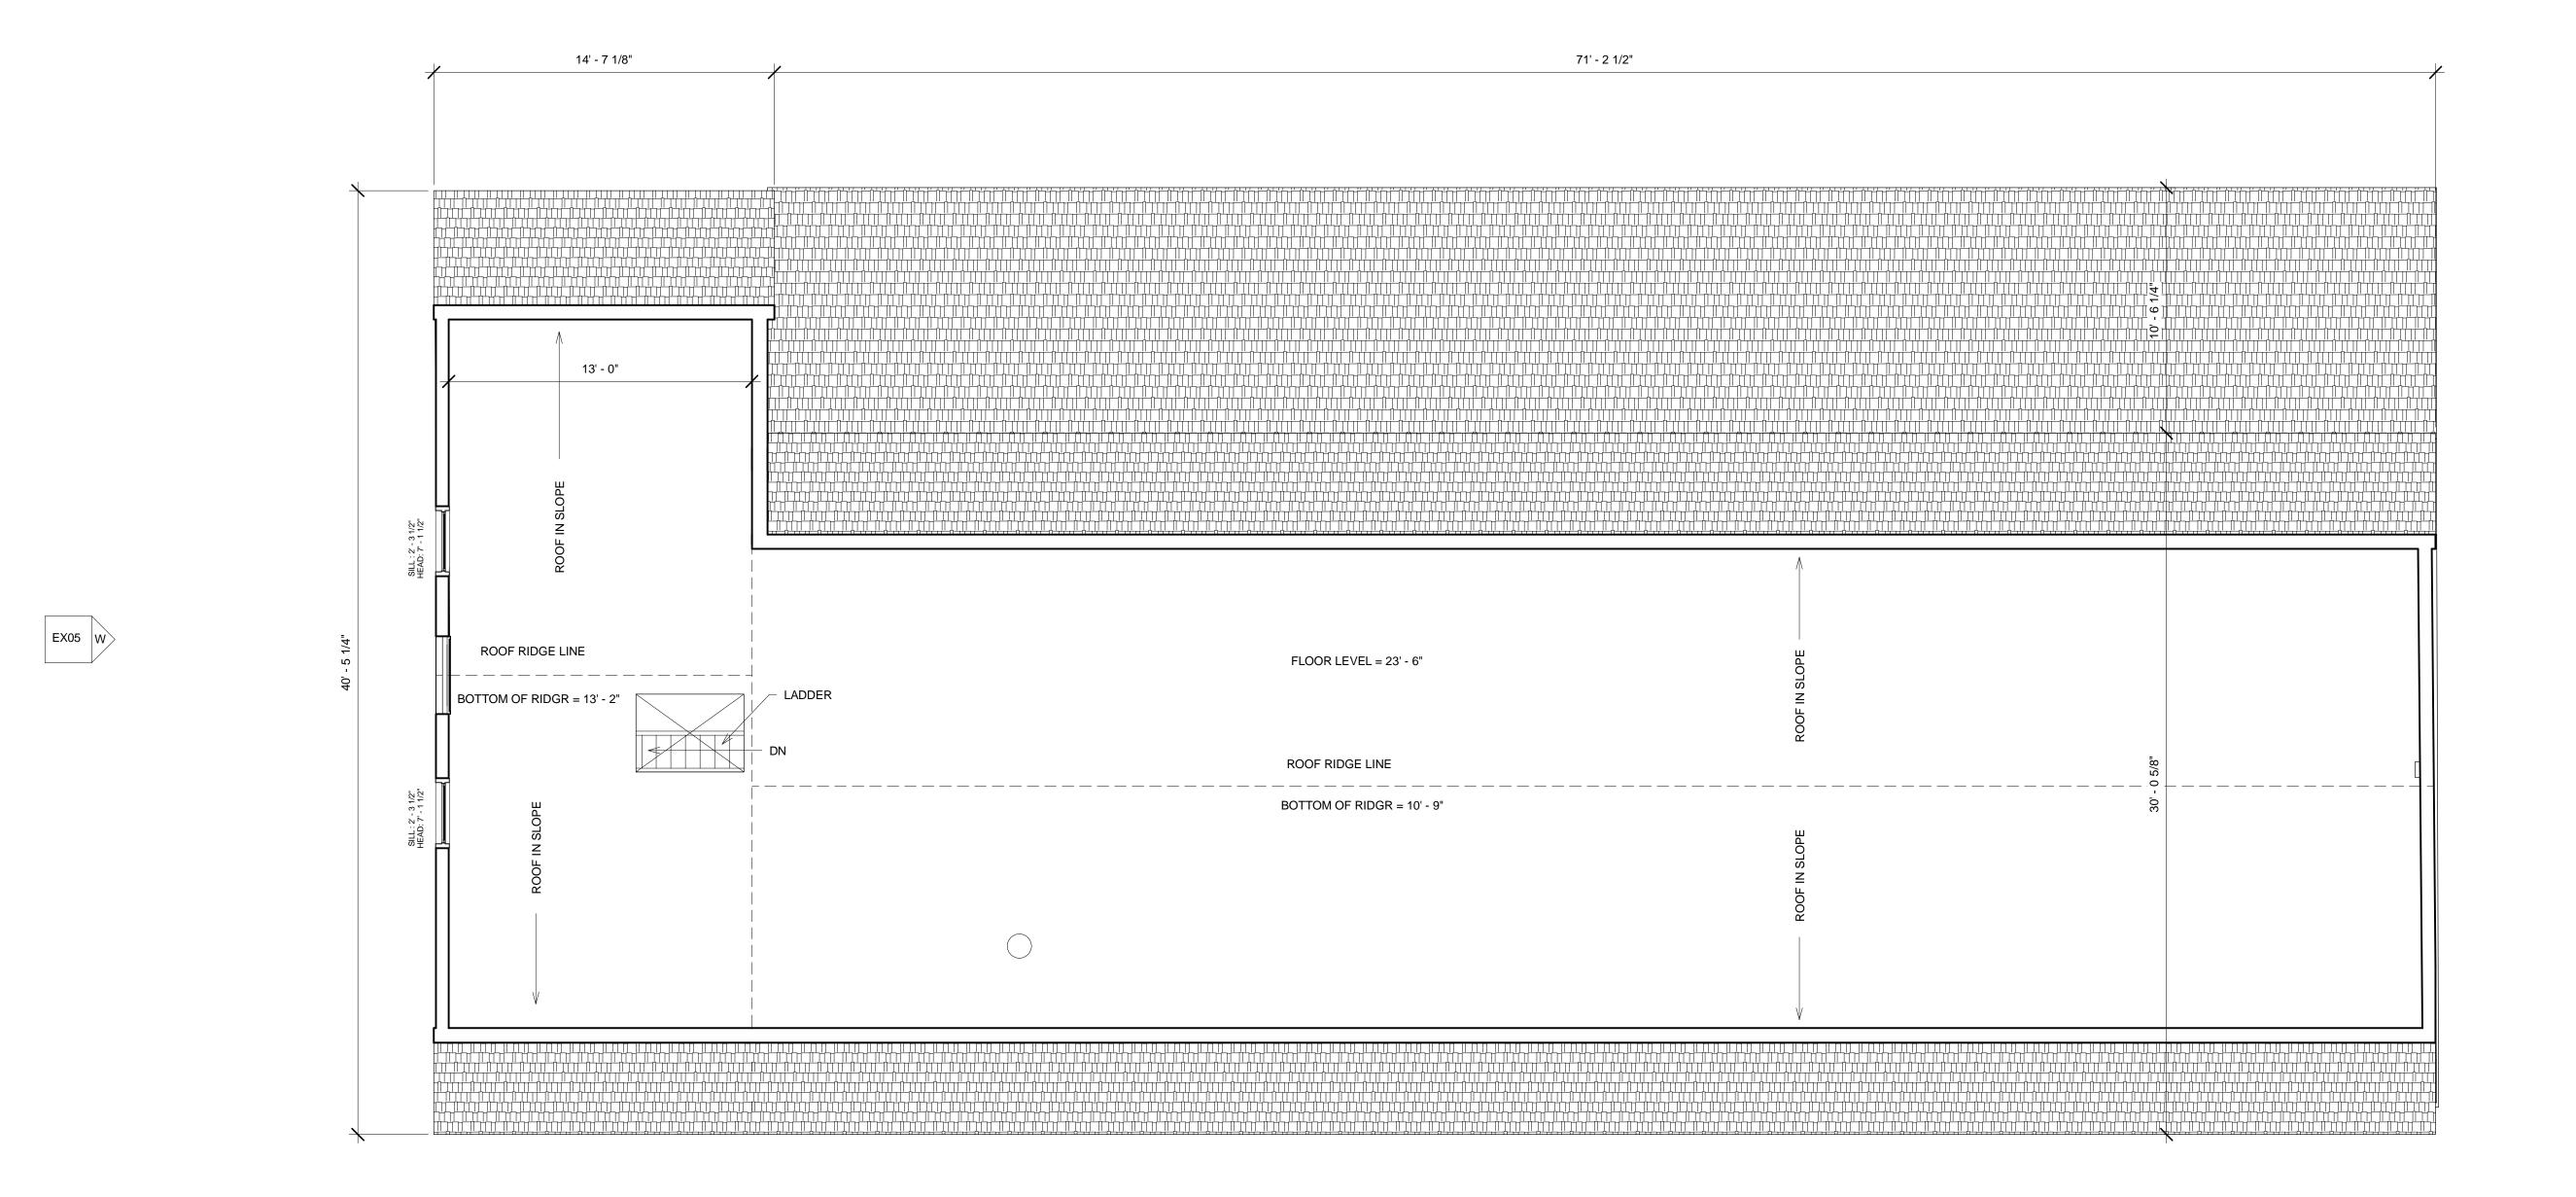

New Bedford, MA

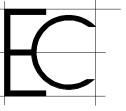

Existing Conditions Surveys Inc.

398 Columbus Avenue #334 Boston, MA 02116 USA

- T 617.247.9161
- F 617.249.0746
- E info@existingconditions.com www.existingconditions.com

The Most Accurate **Existing Conditions Surveys and** As-Built Surveys™

All projects are measured using the most advanced laser measuring equipment and our best standards and practices. All work will be field verified by client prior to design or construction or other use, please visit www.existingconditions.com for terms and conditions of use.

www.existingconditions.com

General Notes:

 It is expressly understood by client that ECS is not an architectural or engineering entity. None of the documents prepared by ECS for client shall have any stamping or certification of such trade professionals.
 This is not a structural or MEP analysis or due diligence model. Visible and accessible elements are modeled for location and size. Further structural or MEP analysis could be necessary by others.
3. STANDARD OF PRACTICE. Services performed by ECS 3. STANDARD OF PRACTICE. Services performed by ECS under this Agreement will be conducted in a manner consistent with that level of care and skill ordinarily exercised by members of the profession currently practicing in the same locality under similar conditions. No other representation, expressed or implied, and no warranty or guarantee is included or intended in this Agreement, or in any report, opinion, document or otherwise. Client shall field verify all work prior to design construction, or other use.

Laser Scanning Notes:

1. Visit FARO.com and leica-geosystems.com for 3D laser scanner tolerances, range information and product specifications.
2. Laser scanning equipment uses light waves to measure distances, unforeseen site conditions such as dust, moisture, vibration, surface reflectivity, lighting conditions, temperature, humidity, ferromagnetic materials, building configuration etc. may impact registration between scan locations.
3. Accuracy over long distances can be improved if the client provides survey benchmarks prior to scanning in order to reference the laser scan data into a coordinate system. reference the laser scan data into a coordinate system.

4. The Revit file contains the most complete alignment of point cloud data. All laser scanning by default is in a localized coordinate system. Laser scans completed on multiple days may be tied into previous laser scans by use of site specific features and targets. Point cloud adjustments are made in Revit for a final verification.

Revision Schedule

Revision Revision Revision Number Description

Existing Roof

EX10



 $\underbrace{N \text{ North Elevation}}_{1/4" = 1'-0"}$



13-19 Commercial New Bedford

New Bedford, MA

Existing Conditions Surveys Inc. 398 Columbus Avenue #334

Boston, MA 02116 USA

T 617.247.9161 F 617.249.0746

E info@existingconditions.com www.existingconditions.com

The Most Accurate Existing Conditions Surveys and As-Built Surveys™

All projects are measured using the most advanced laser measuring equipment and our best standards and practices. All work will be field verified by client prior to design or construction or other use, please visit www.existingconditions.com for terms and conditions of use.

www.existingconditions.com

General Notes:

 It is expressly understood by client that ECS is not an architectural or engineering entity. None of the documents prepared by ECS for client shall have any stamping or certification of such trade professionals.
 This is not a structural or MEP analysis or due diligence model. Visible and accessible elements are modeled for location and size. Further structural or MEP analysis could be necessary by others. size. Further structural or MEP analysis could be necessary by others.

3. STANDARD OF PRACTICE. Services performed by ECS under this Agreement will be conducted in a manner consistent with that level of care and skill ordinarily exercised by members of the profession currently practicing in the same locality under similar conditions. No other representation, expressed or implied, and no warranty or guarantee is included or intended in this Agreement, or in any report, opinion, document or otherwise. Client shall field verify all work prior to design construction, or other use.

Laser Scanning Notes:

1. Visit FARO.com and leica-geosystems.com for 3D laser scanner tolerances, range information and product specifications.
2. Laser scanning equipment uses light waves to measure distances, unforeseen site conditions such as dust, moisture, vibration, surface reflectivity, lighting conditions, temperature, humidity, ferromagnetic materials, building configuration etc. may impact registration between scan locations.
3. Accuracy over long distances can be improved if the client provides survey benchmarks prior to scanning in order to reference the laser scan data into a coordinate system.
4. The Revit file contains the most complete alignment of point cloud data. All laser scanning by default is in a localized coordinate system. Laser scans completed on multiple days may be tied into previous laser scans by use of site specific features and targets. Point cloud adjustments are made in Revit for a final verification.


Revision Schedule

Revision Revision Revision Number Description Date

Existing Exterior Elevations

Date: 11/01/2019 EX11 Drawn By: ECS




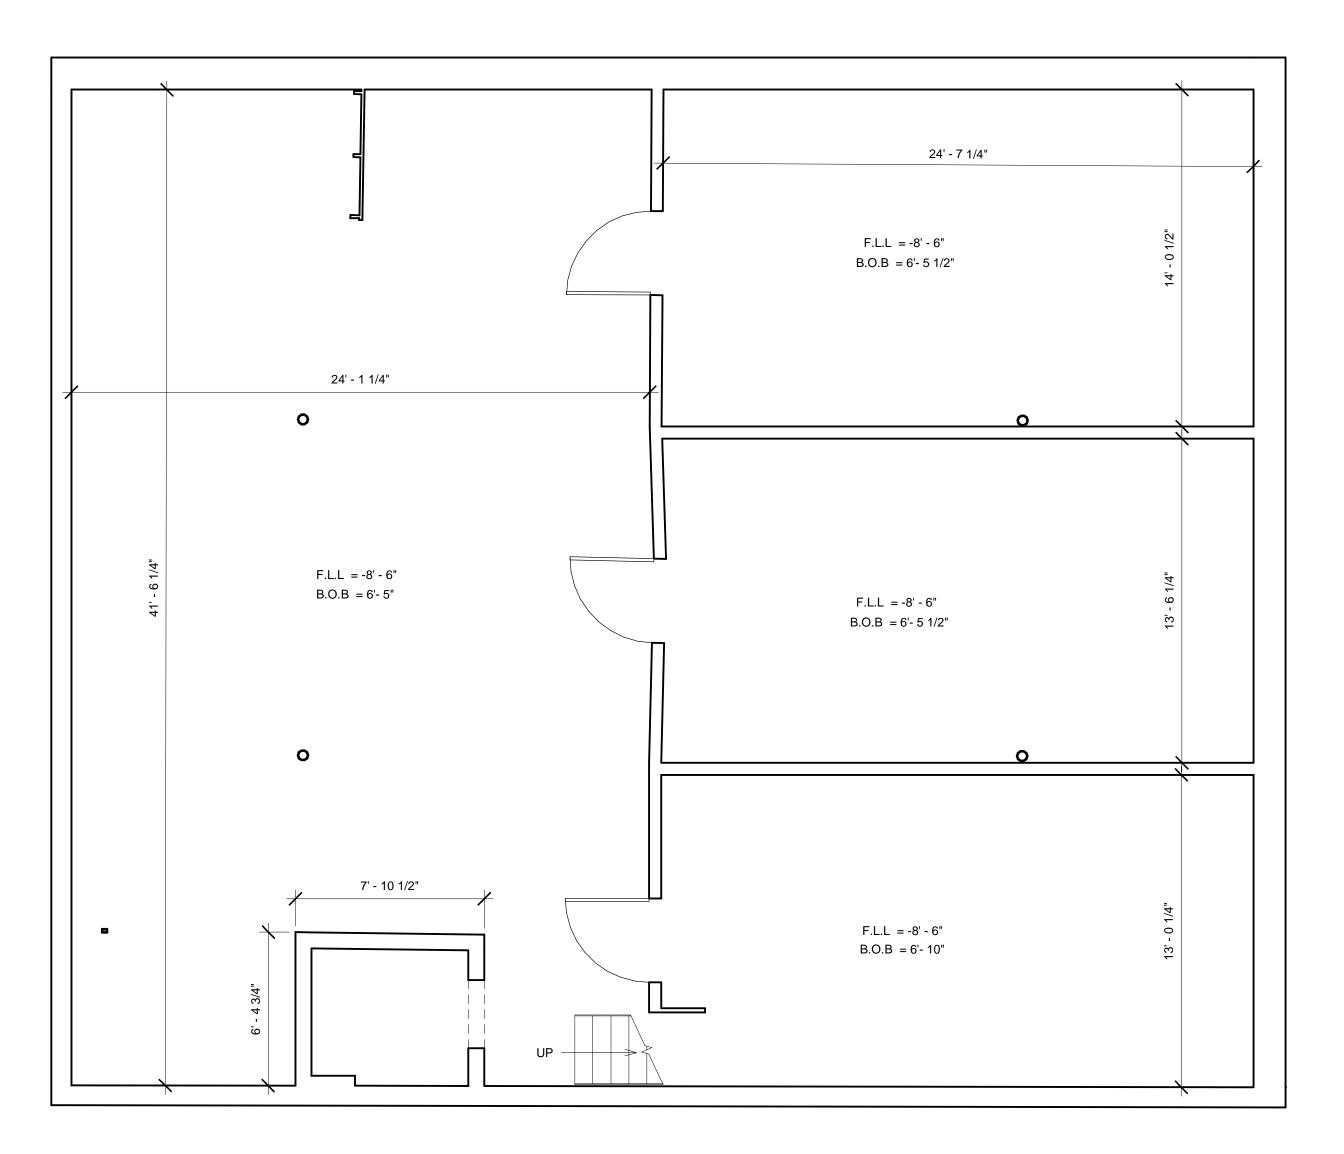



24 Union - New Bedford

New Bedford, MA

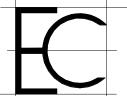

Existing Conditions Surveys Inc.

398 Columbus Avenue #334 Boston, MA 02116 USA

- T 617.247.9161
- F 617.249.0746
- E info@existingconditions.com www.existingconditions.com

The Most Accurate Existing Conditions Surveys and As-Built Surveys™

All projects are measured using the most advanced laser measuring equipment and our best standards and practices. All work will be field verified by client prior to design or construction or other use, please visit www.existingconditions.com for terms and conditions of use.

www.existingconditions.com

General Notes:

- It is expressly understood by client that ECS is not an architectural or engineering entity. None of the documents prepared by ECS for client shall have any stamping or certification of such trade professionals.
 This is not a structural or MEP analysis or due diligence model. Visible and accessible elements are modeled for location and size. Further structural or MEP analysis could be necessary by others.
- size. Further structural of MEP analysis could be necessary by others.

 3. STANDARD OF PRACTICE. Services performed by ECS under this Agreement will be conducted in a manner consistent with that level of care and skill ordinarily exercised by members of the profession currently practicing in the same locality under similar conditions. No other representation, expressed or implied, and no warranty or guarantee is included or intended in this Agreement, or in any report, opinion, document or otherwise. Client shall field verify all work prior to design construction, or other use.

Laser Scanning Notes:


1. Visit FARO.com and leica-geosystems.com for 3D laser scanner tolerances, range information and product specifications.
2. Laser scanning equipment uses light waves to measure distances, unforeseen site conditions such as dust, moisture, vibration, surface reflectivity, lighting conditions, temperature, humidity, ferromagnetic materials, building configuration etc. may impact registration between scan locations.
3. Accuracy over long distances can be improved if the client provides survey benchmarks prior to scanning in order to reference the laser scan data into a coordinate system.
4. The Revit file contains the most complete alignment of point cloud data. All laser scanning by default is in a localized coordinate system. Laser scans completed on multiple days may be tied into previous laser scans by use of site specific features and targets. Point cloud adjustments are made in Revit for a final verification.

Revision Schedule					
Revision Number	Revision Description	Revision Date			

Existing Basement Floor Plan

Date: 11/01/2019



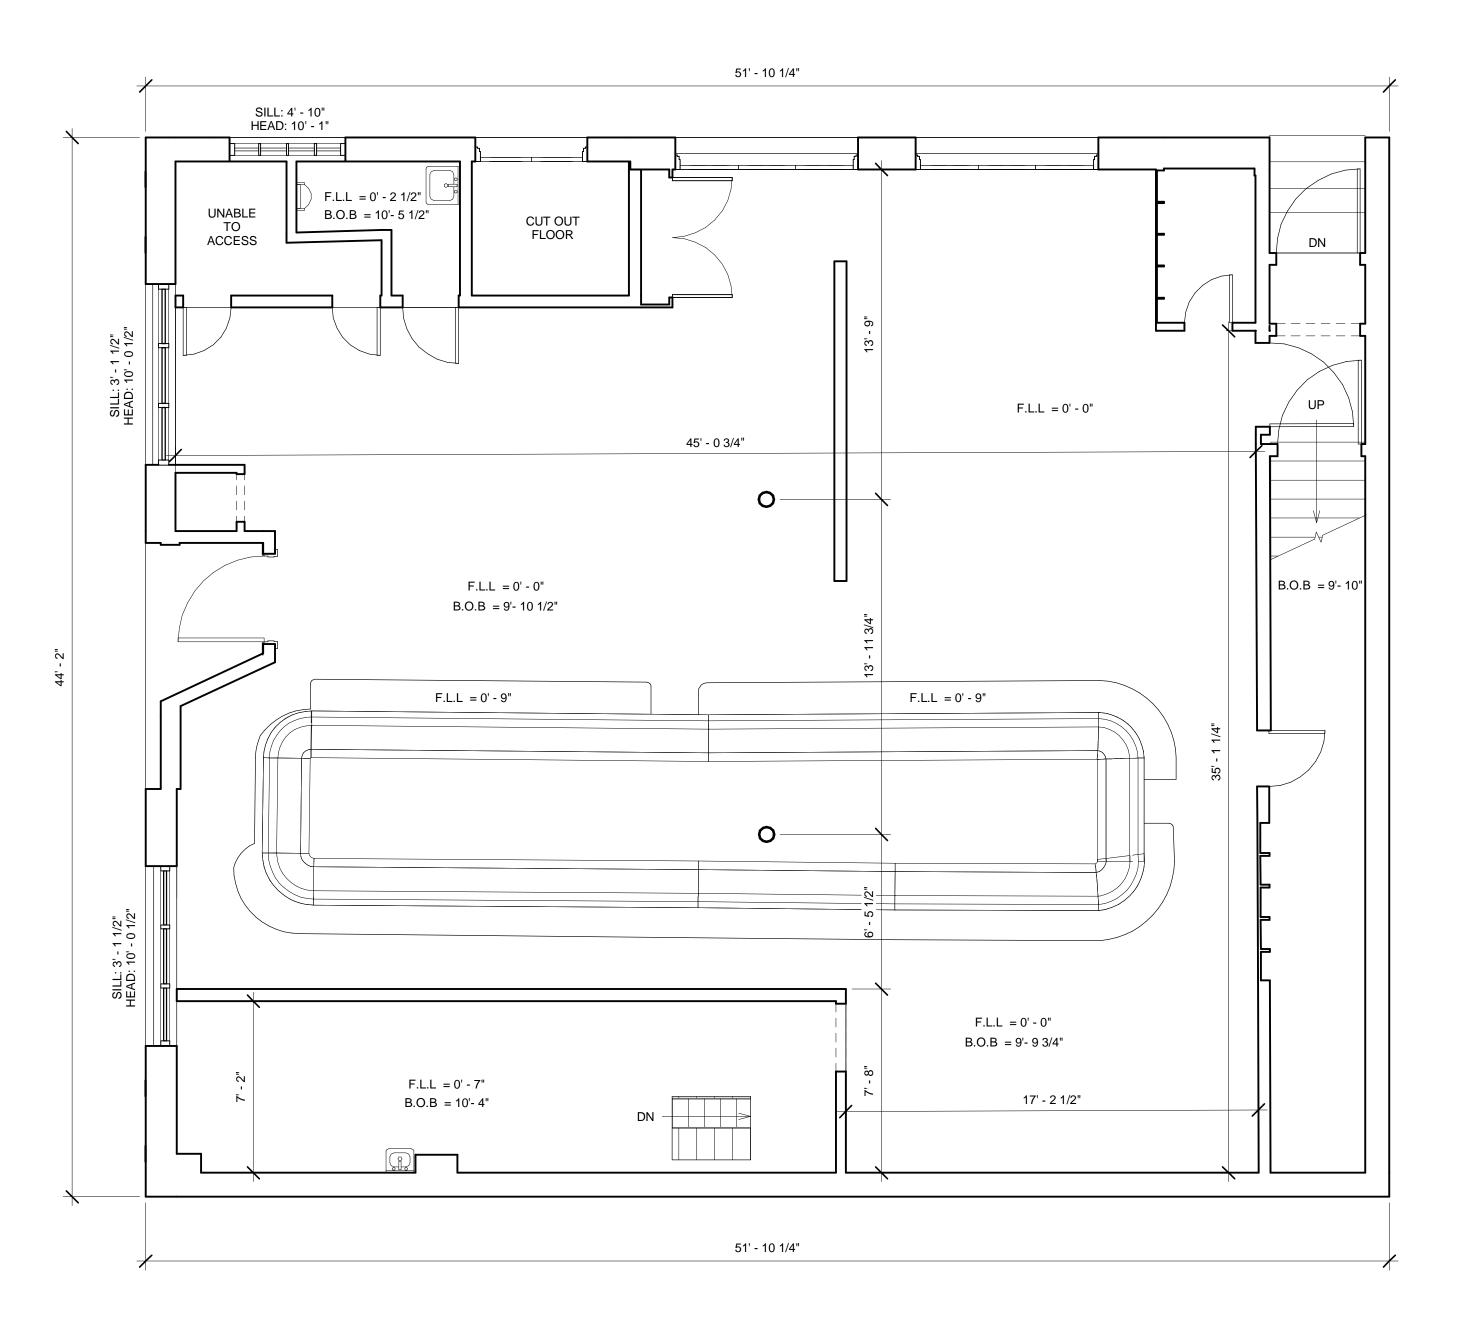

24 Union - New Bedford

New Bedford, MA



Existing Conditions Surveys Inc.

398 Columbus Avenue #334 Boston, MA 02116 USA

- T 617.247.9161 F 617.249.0746
- E info@existingconditions.com
- www.existingconditions.com

The Most Accurate Existing Conditions Surveys and As-Built Surveys™

All projects are measured using the most advanced laser measuring equipment and our best standards and practices. All work will be field verified by client prior to design or construction or other use, please visit www.existingconditions.com for terms and conditions of use.

www.existingconditions.com

General Notes:

- It is expressly understood by client that ECS is not an architectural or engineering entity. None of the documents prepared by ECS for client shall have any stamping or certification of such trade professionals.

 This is not a structural or MEP analysis or due diligence model. Visible and accessible elements are modeled for location and size. Further structural or MEP analysis could be necessary by others.
- size. Further structural of MEP analysis could be necessary by others.

 3. STANDARD OF PRACTICE. Services performed by ECS under this Agreement will be conducted in a manner consistent with that level of care and skill ordinarily exercised by members of the profession currently practicing in the same locality under similar conditions. No other representation, expressed or implied, and no warranty or guarantee is included or intended in this Agreement, or in any report, opinion, document or otherwise. Client shall field verify all work prior to design construction, or other use.

Laser Scanning Notes:

1. Visit FARO.com and leica-geosystems.com for 3D laser scanner tolerances, range information and product specifications.
2. Laser scanning equipment uses light waves to measure distances, unforeseen site conditions such as dust, moisture, vibration, surface reflectivity, lighting conditions, temperature, humidity, ferromagnetic materials, building configuration etc. may impact registration between scan locations.
3. Accuracy over long distances can be improved if the client provides survey benchmarks prior to scanning in order to reference the laser scan data into a coordinate system.
4. The Revit file contains the most complete alignment of point cloud data. All laser scanning by default is in a localized coordinate system. Laser scans completed on multiple days may be tied into previous laser scans by use of site specific features and targets. Point cloud adjustments are made in Revit for a final verification.


Revision Schedule

Revision Revision Revision Number Description Date

Existing First Floor Plan

Date: 11/01/2019



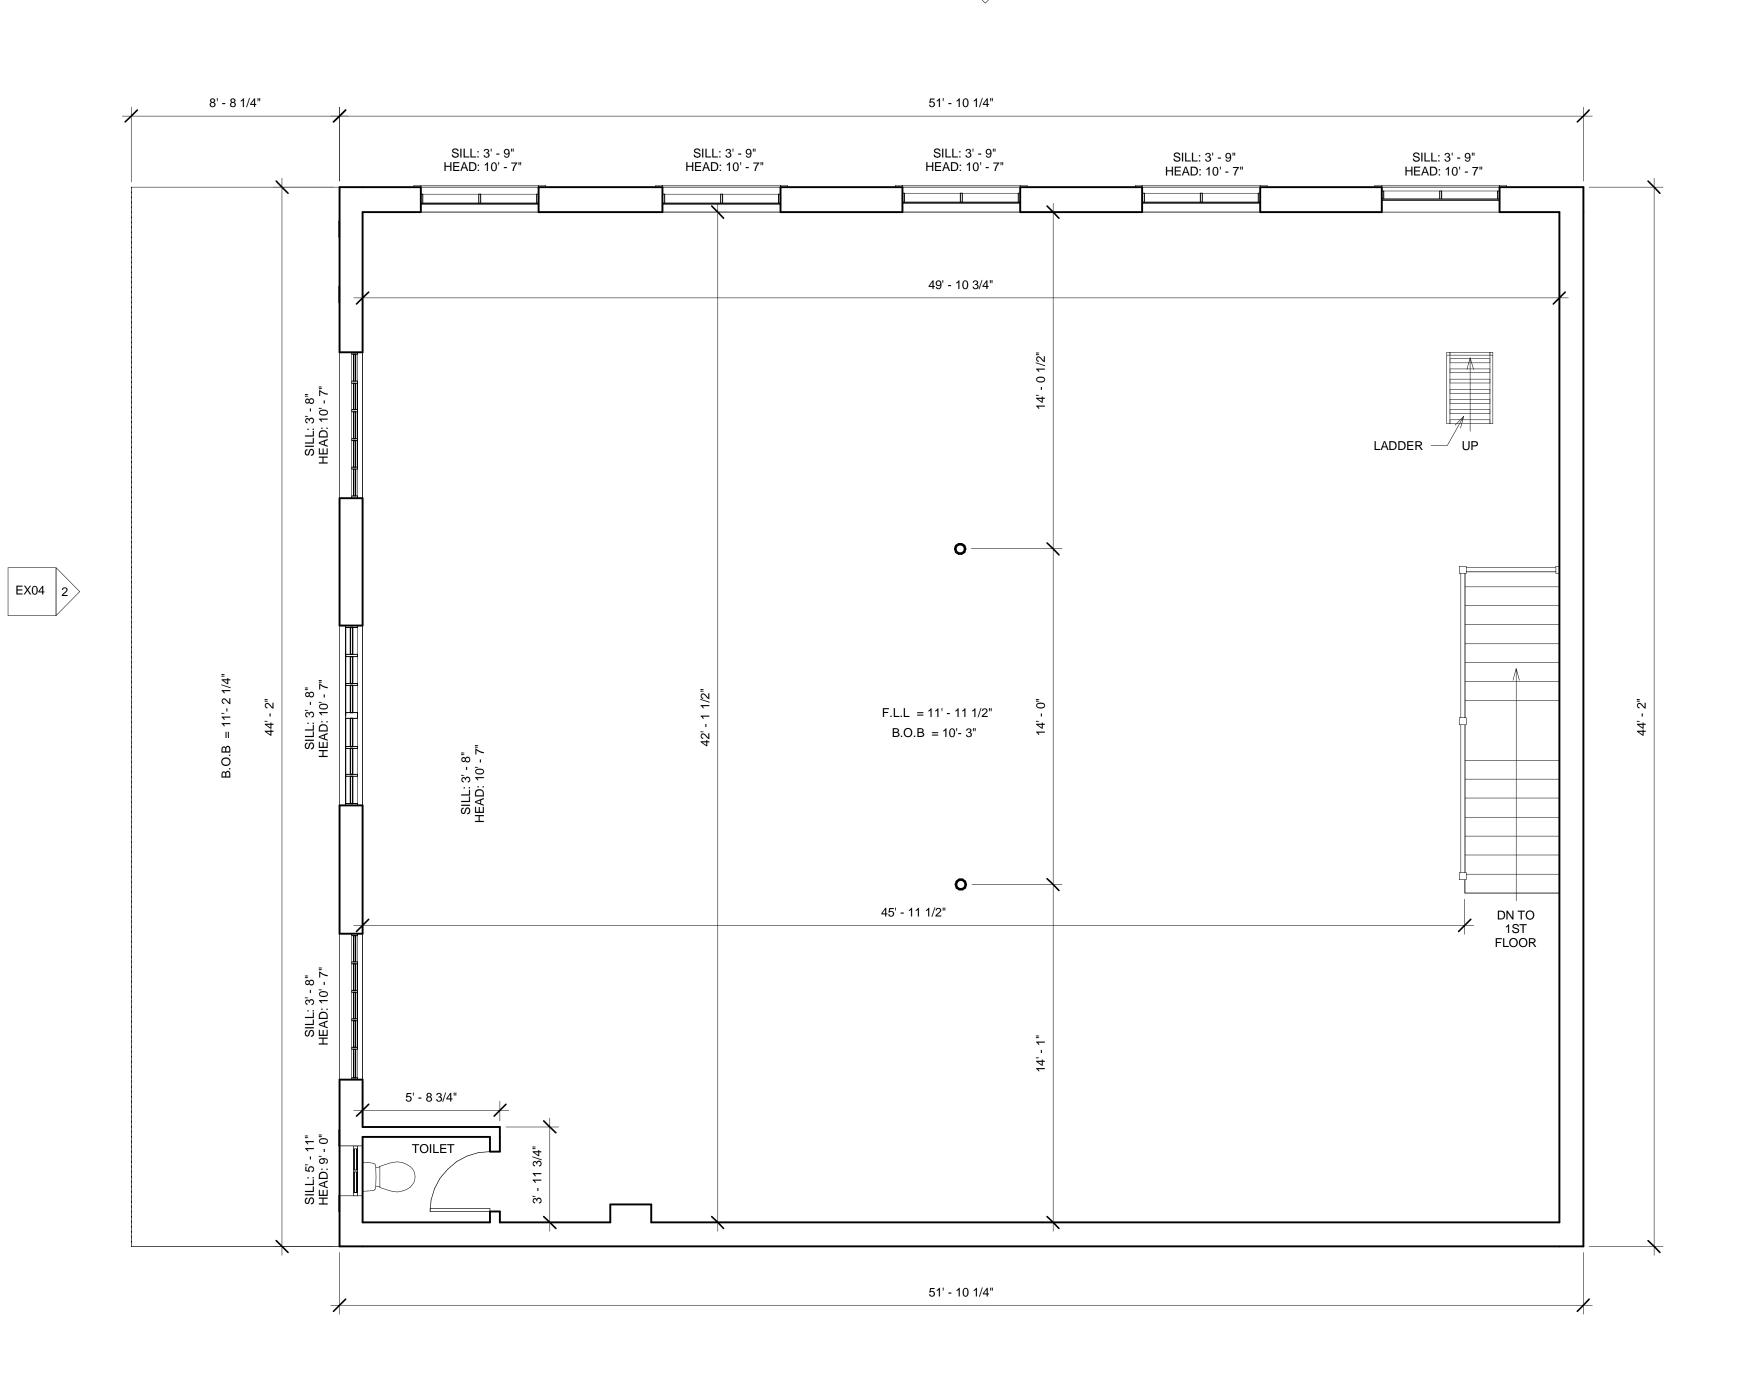

24 Union - New Bedford

New Bedford, MA



Existing Conditions Surveys Inc.

398 Columbus Avenue #334 Boston, MA 02116 USA

- T 617.247.9161
- F 617.249.0746 E info@existingconditions.com
- www.existingconditions.com

The Most Accurate Existing Conditions Surveys and As-Built Surveys™

All projects are measured using the most advanced laser measuring equipment and our best standards and practices. All work will be field verified by client prior to design or construction or other use, please visit www.existingconditions.com for terms and conditions of use.

www.existingconditions.com

General Notes:

- It is expressly understood by client that ECS is not an architectural or engineering entity. None of the documents prepared by ECS for client shall have any stamping or certification of such trade professionals.

 This is not a structural or MEP analysis or due diligence model. Visible and accessible elements are modeled for location and size. Further structural or MEP analysis could be necessary by others.
- size. Further structural of MEP analysis could be necessary by others.

 3. STANDARD OF PRACTICE. Services performed by ECS under this Agreement will be conducted in a manner consistent with that level of care and skill ordinarily exercised by members of the profession currently practicing in the same locality under similar conditions. No other representation, expressed or implied, and no warranty or guarantee is included or intended in this Agreement, or in any report, opinion, document or otherwise. Client shall field verify all work prior to design construction, or other use.

Laser Scanning Notes:

- 1. Visit FARO.com and leica-geosystems.com for 3D laser scanner tolerances, range information and product specifications.
 2. Laser scanning equipment uses light waves to measure distances, unforeseen site conditions such as dust, moisture, vibration, surface reflectivity, lighting conditions, temperature, humidity, ferromagnetic materials, building configuration etc. may impact registration between scan locations.
 3. Accuracy over long distances can be improved if the client provides survey benchmarks prior to scanning in order to reference the laser scan data into a coordinate system.
 4. The Revit file contains the most complete alignment of point cloud data. All laser scanning by default is in a localized coordinate system. Laser scans completed on multiple days may be tied into previous laser scans by use of site specific features and targets. Point cloud adjustments are made in Revit for a final verification.

Revision Schedule

Revision Number	Revision Description	Revision Date
		1

Existing Second Floor Plan

Date: 11/01/2019






 $1 \frac{\text{North Elevation}}{1/4" = 1'-0"}$



 $\frac{\text{West Elevation}}{1/4" = 1'-0"}$

24 Union - New Bedford

New Bedford, MA

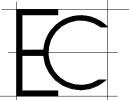

Existing Conditions Surveys Inc.

398 Columbus Avenue #334 Boston, MA 02116 USA

- T 617.247.9161
- F 617.249.0746
- E info@existingconditions.com www.existingconditions.com

The Most Accurate Existing Conditions Surveys and As-Built Surveys™

All projects are measured using the most advanced laser measuring equipment and our best standards and practices. All work will be field verified by client prior to design or construction or other use, please visit www.existingconditions.com for terms and conditions of use.

www.existingconditions.com

General Notes:

- It is expressly understood by client that ECS is not an architectural or engineering entity. None of the documents prepared by ECS for client shall have any stamping or certification of such trade professionals.

 This is not a structural or MEP analysis or due diligence model. Visible and accessible elements are modeled for location and size. Further structural or MEP analysis could be necessary by others.
- size. Further structural of MEP analysis could be necessary by others.

 3. STANDARD OF PRACTICE. Services performed by ECS under this Agreement will be conducted in a manner consistent with that level of care and skill ordinarily exercised by members of the profession currently practicing in the same locality under similar conditions. No other representation, expressed or implied, and no warranty or guarantee is included or intended in this Agreement, or in any report, opinion, document or otherwise. Client shall field verify all work prior to design construction, or other use.

Laser Scanning Notes:

- 1. Visit FARO.com and leica-geosystems.com for 3D laser scanner tolerances, range information and product specifications.
 2. Laser scanning equipment uses light waves to measure distances, unforeseen site conditions such as dust, moisture, vibration, surface reflectivity, lighting conditions, temperature, humidity, ferromagnetic materials, building configuration etc. may impact registration between scan locations.
 3. Accuracy over long distances can be improved if the client provides survey benchmarks prior to scanning in order to reference the laser scan data into a coordinate system.
 4. The Revit file contains the most complete alignment of point cloud data. All laser scanning by default is in a localized coordinate system. Laser scans completed on multiple days may be tied into previous laser scans by use of site specific features and targets. Point cloud adjustments are made in Revit for a final verification.

Revision Schedule			
vision	Revision	Revision	
umber	Description	Date	

Number	Description	Date


Existing Exterior Elevations

Date: 11/01/2019

EXISTING BASEMENT ELEVATOR MACHINE ROOM MECHANICAL ROOM **EXISTING BASEMENT EXISTING BASEMENT** SPRINKLER ROOM oʻ oʻ linexcavated





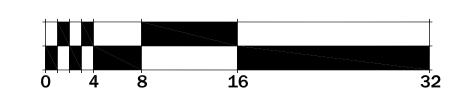


Newport Collaborative Architects

2 Marlborough Street Newport, RI 02840 Phone: **(401) 466-7900** Web Site: newportcollaborativearchitects.com



Lanagan & Co. Inc. REAL PROPERTY BROKER

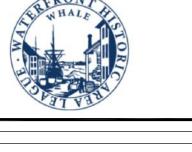

EIGHTEEN & UNION New Bedford, MA


11 & 13 COMMERCIAL STREET/ 10 FRONT STREET NEW BEDFORD, MA 02740


FOR REVIEW ONLY NOT FOR CONSTRUCTION

Project Type:
INTERIOR AND EXTERIOR RENOVATION


BASEMENT LEVEL


A-1.0 Project Number: 19002 Date Issued: 11/01/2019

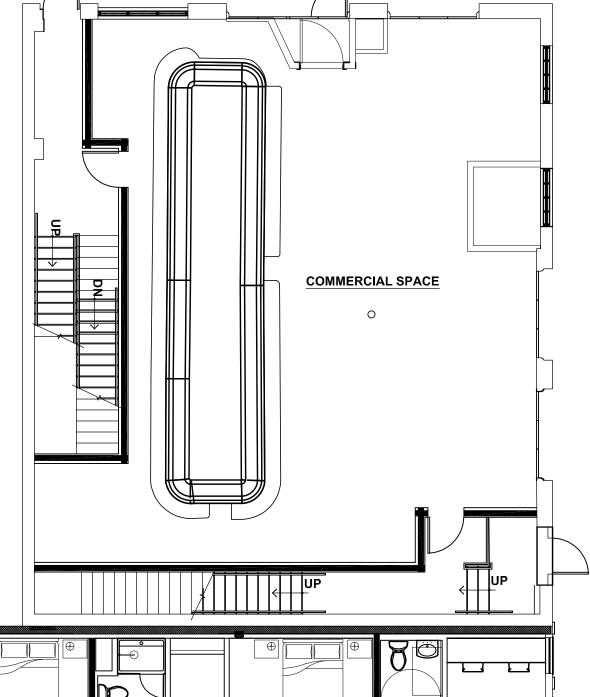

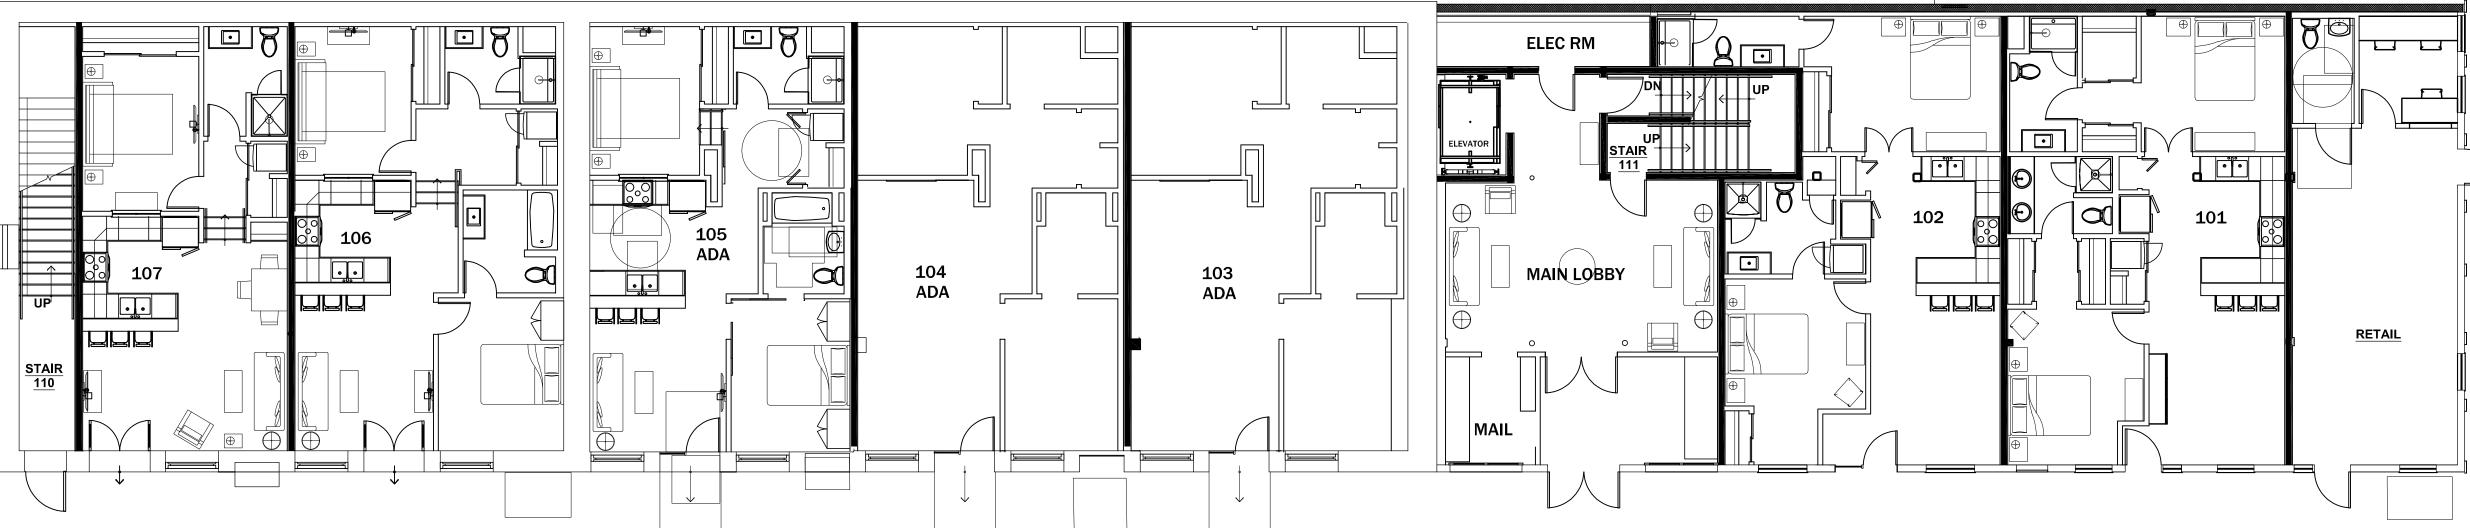



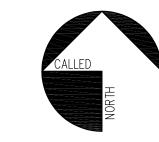

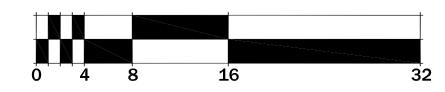

Newport Collaborative Architects

2 Marlborough Street Newport, RI 02840 Phone: **(401) 466-7900** Web Site: newportcollaborativearchitects.com



Lanagan & Co. Inc. REAL PROPERTY BROKER




EIGHTEEN & UNION New Bedford, MA


11 & 13 COMMERCIAL STREET/ 10 FRONT STREET NEW BEDFORD, MA 02740


FOR REVIEW ONLY NOT FOR CONSTRUCTION


INTERIOR AND EXTERIOR RENOVATION


FIRST FLOOR LEVEL

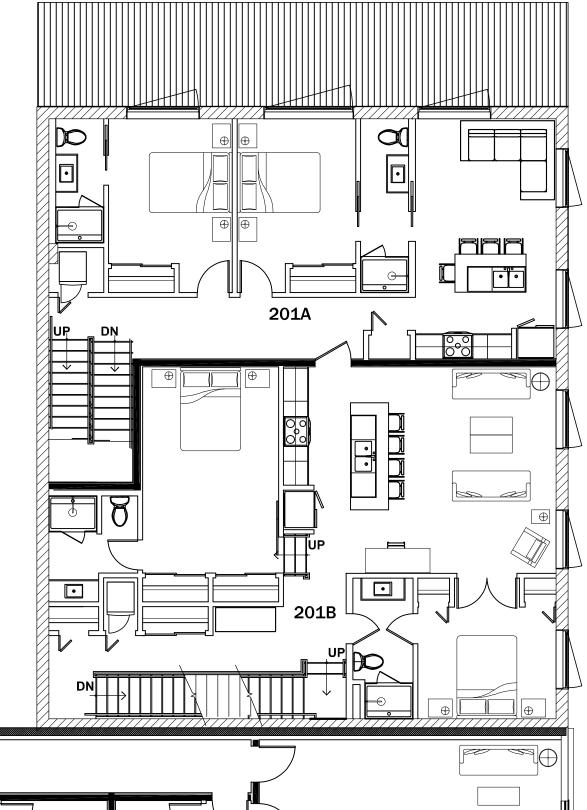

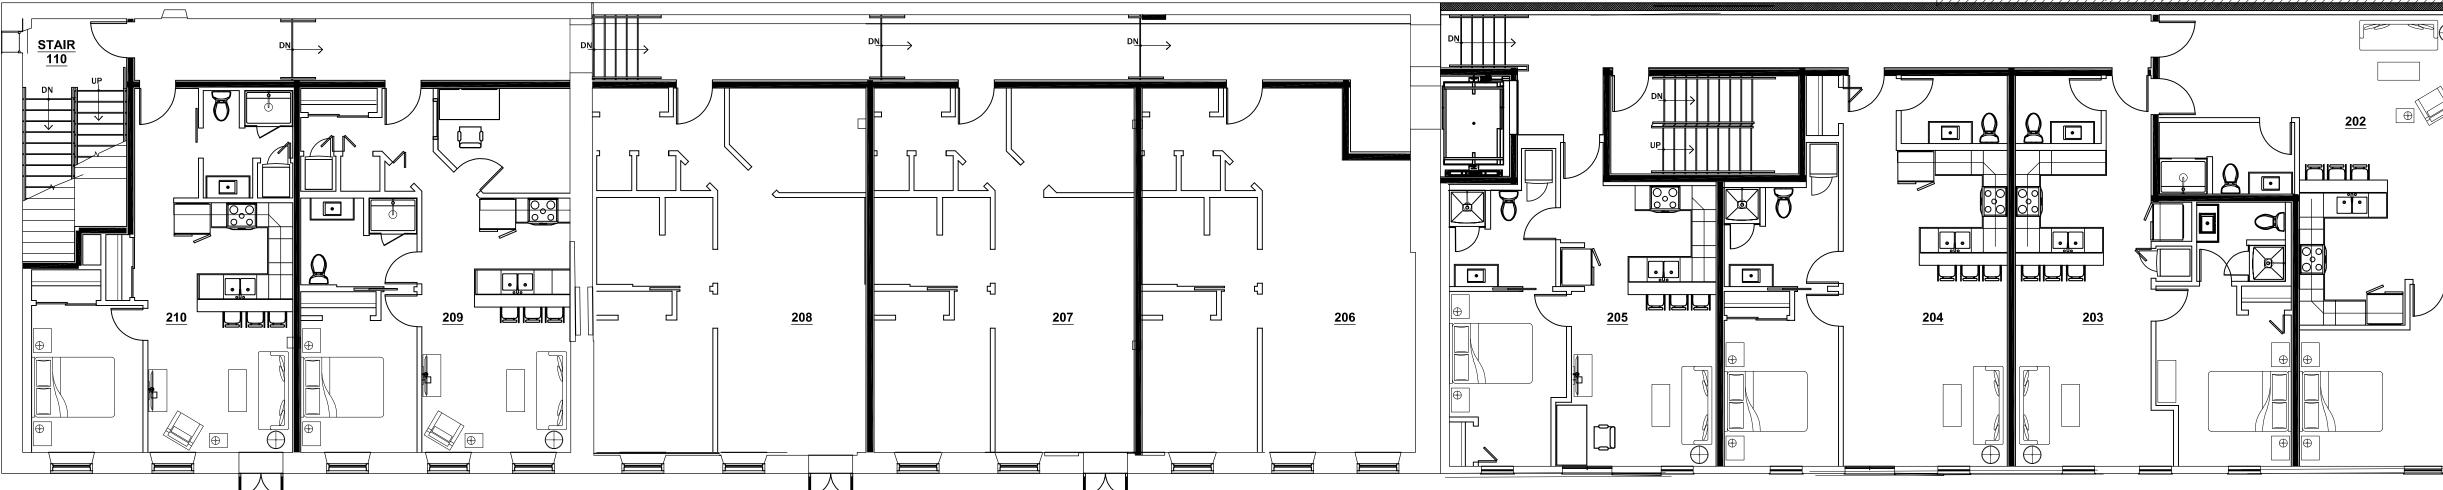

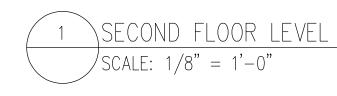

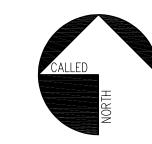

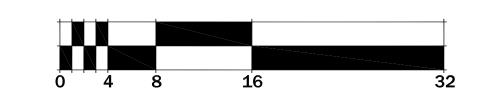

Newport Collaborative

2 Marlborough Street Newport, RI 02840 Phone: **(401) 466-7900** Web Site: newportcollaborativearchitects.com

Architects



Lanagan & Co. Inc. REAL PROPERTY BROKER




EIGHTEEN & UNION New Bedford, MA


11 & 13 COMMERCIAL STREET/ 10 FRONT STREET NEW BEDFORD, MA 02740


FOR REVIEW ONLY NOT FOR CONSTRUCTION


INTERIOR AND EXTERIOR RENOVATION

SECOND FLOOR LEVEL

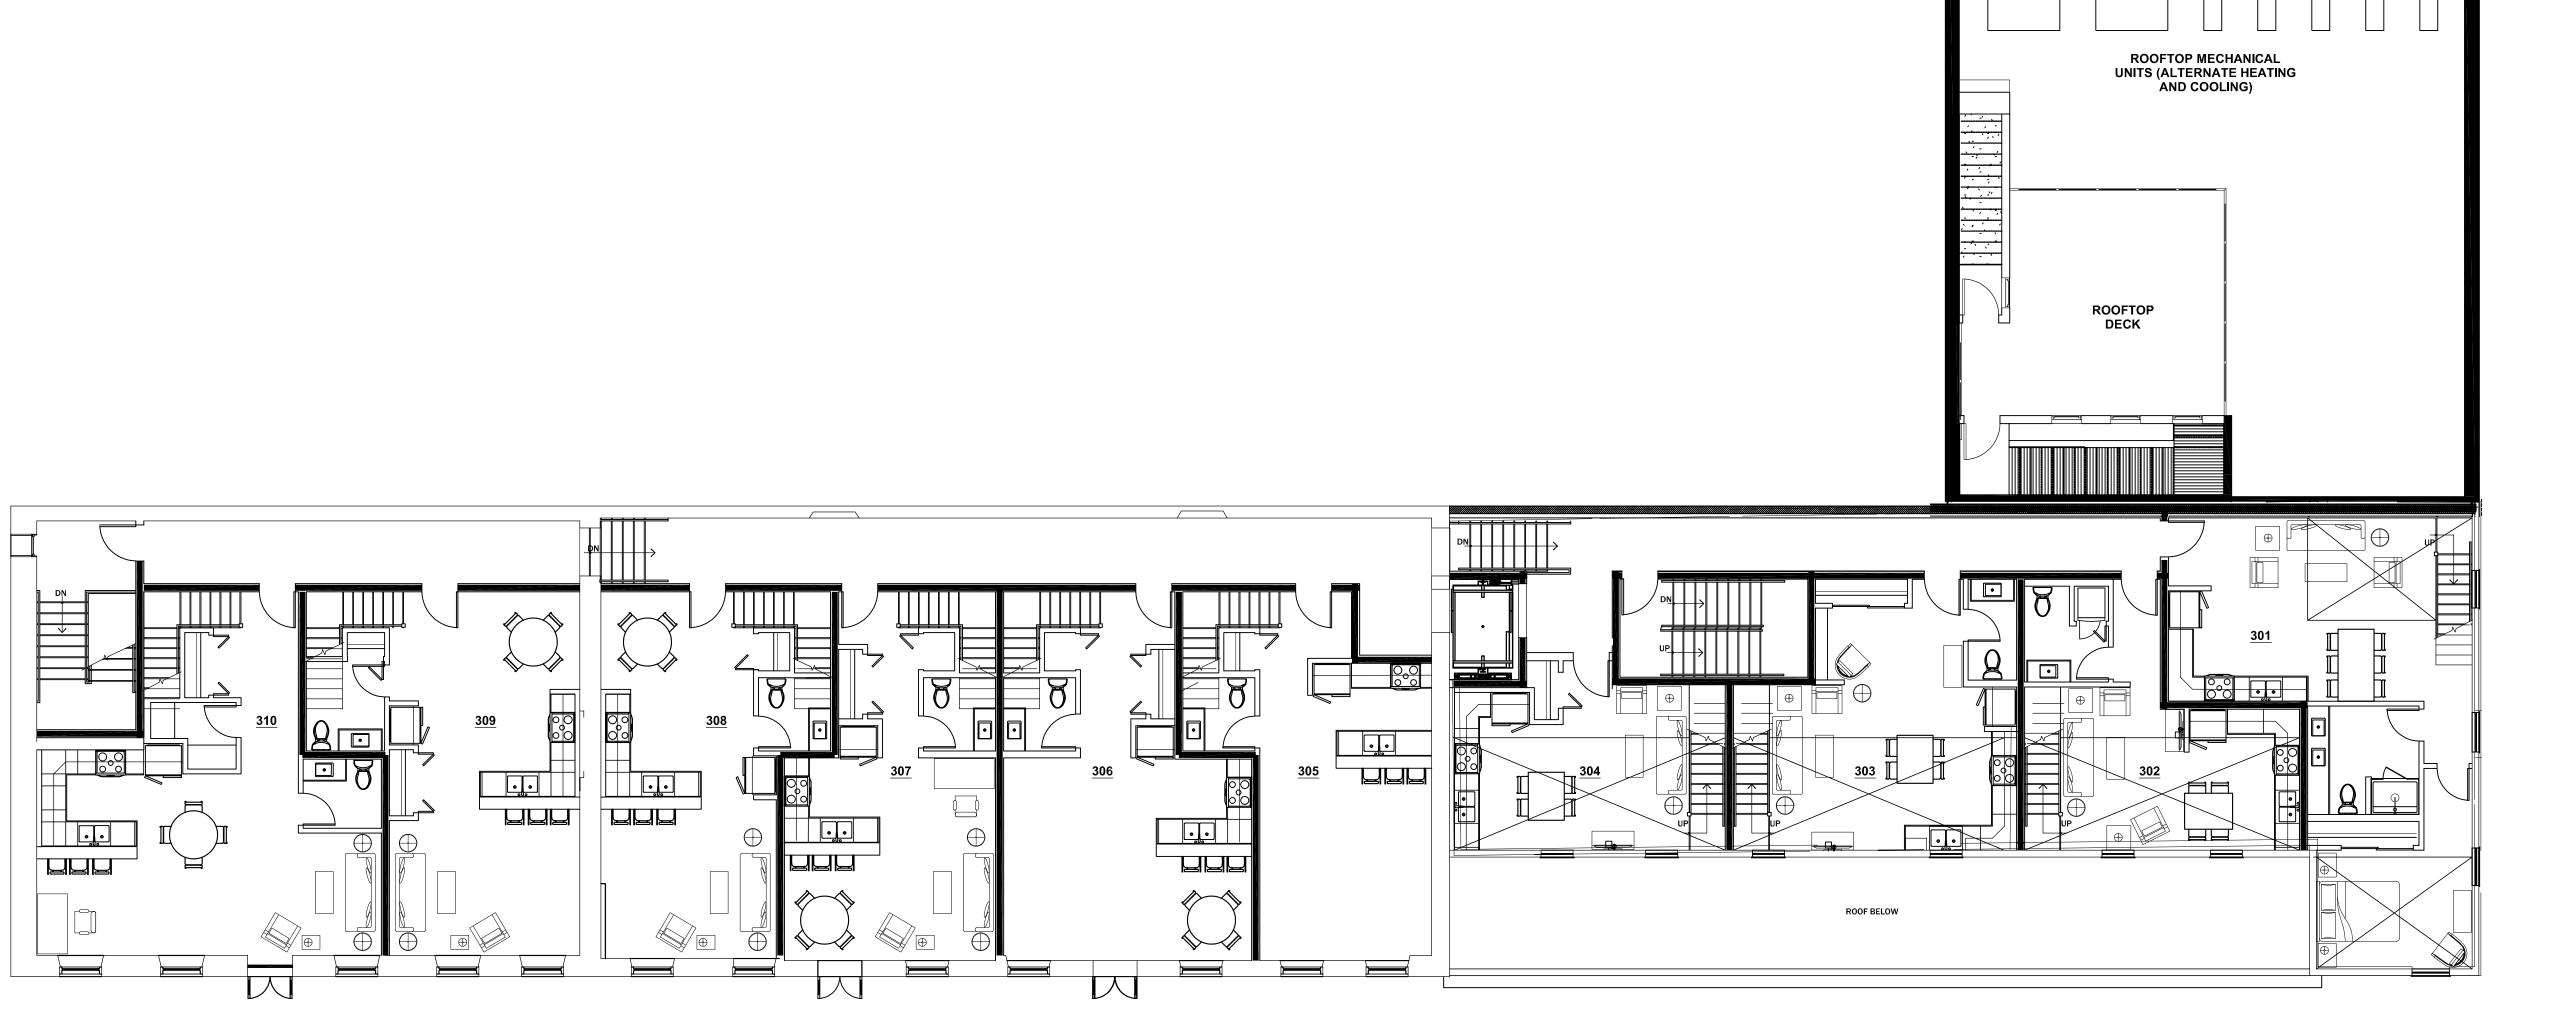

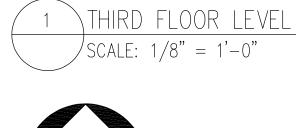

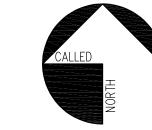

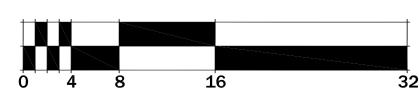



2 Marlborough Street Newport, RI 02840 Phone: **(401) 466-7900** Web Site: newportcollaborativearchitects.com



Lanagan & Co. Inc. REAL PROPERTY BROKER



EIGHTEEN & UNION New Bedford, MA


11 & 13 COMMERCIAL STREET/ 10 FRONT STREET NEW BEDFORD, MA 02740

FOR REVIEW ONLY NOT FOR CONSTRUCTION


Project Type:
INTERIOR AND EXTERIOR RENOVATION


THIRD FLOOR LEVEL

Newport Collaborative Architects 2 Marlborough Street Newport, RI 02840 Phone: (401) 466-7900 Web Site: newportcollaborativearchitects.com

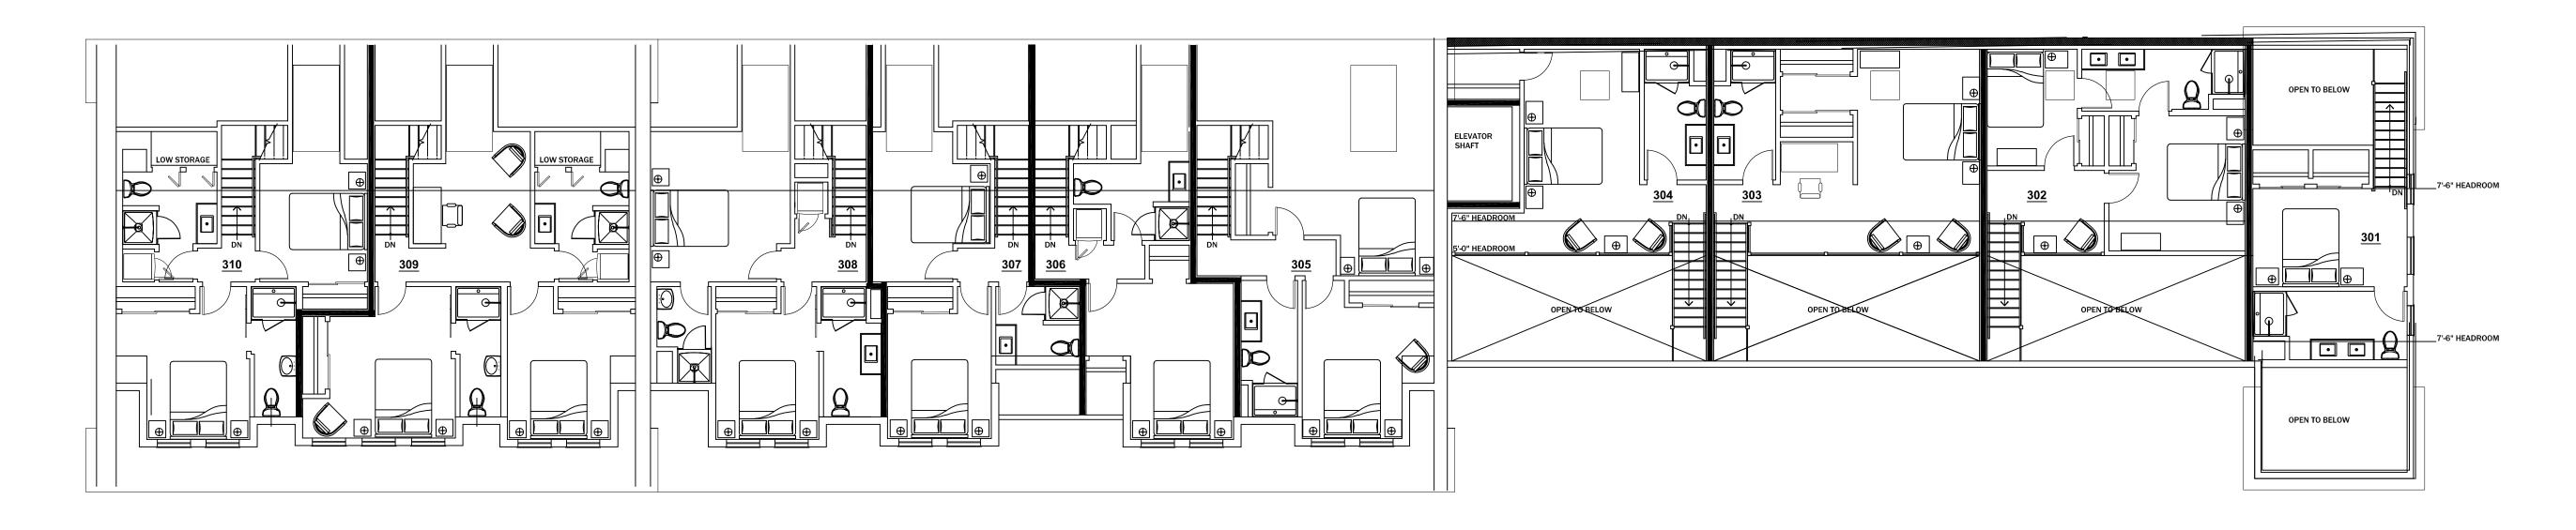




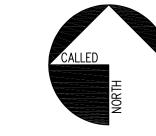

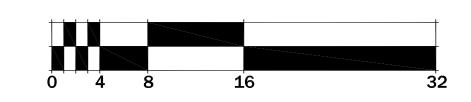



Lanagan & Co. Inc. REAL PROPERTY BROKER

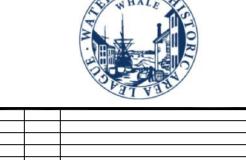

Number	Date	Description
Revision	ns:	
Project	Name:	

EIGHTEEN & UNION New Bedford, MA

11 & 13 COMMERCIAL STREET/ 10 FRONT STREET NEW BEDFORD, MA 02740

FOR REVIEW ONLY NOT FOR CONSTRUCTION

INTERIOR AND EXTERIOR RENOVATION

FOURTH FLOOR LEVEL







Newport Collaborative Architects

2 Marlborough Street Newport, RI 02840 Phone: **(401) 466-7900** Web Site: newportcollaborativearchitects.com



Lanagan & Co. Inc.

REAL PROPERTY BROKER



Number Date Description

oject Name:

EIGHTEEN & UNION
New Bedford, MA

11 & 13 COMMERCIAL STREET/ 10 FRONT STREET NEW BEDFORD, MA 02740

FOR REVIEW ONLY NOT FOR CONSTRUCTION

INTERIOR AND EXTERIOR RENOVATION

ELEVATIONS

Drawing Scale:
Project Number:
19002