SHORELINE RESOURCES

TRUE VALUE MARINE HARDWARE

SITE PLANSET 137 - 143 POPES ISLAND NEW BEDFORD, MASSACHUSETTS

SEPTEMBER 2019



Shoreline Resources, LLC 137 Popes Island New Bedford, MA 02740 (774) 930-3795 gscotttaber@hotmail.com

Owner of Record: Shoreline Resources, LLC 137 Popes Island New Bedford, MA 02740 (508) 990-7918 charlie@quinnfisheries.com

#137: Standard Marine Outfitters #143: Machine Shop

Proposed Use:

#137: Standard Marine Outfitters #143: True Value Retail Store, Bulk Item Storage, Machine Shop

Project -

DRAWING SET: SITE PLANS ISSUED FOR: LOCAL APPROVALS





LOT REFERENCES: ASSESSORS: MAP 60 PARCEL 60-13 DEED BOOK/PAGE: 11075/274

LOCATION MAP SCALE: 1" = 250'



BETA Group Inc. 1 Springfield Street, Suite 4 Chicopee, MA 01013 413-331-5326

> ISSUE DATE: SEPTEMBER 6, 2019 REVISION DATE: SEPTEMBER 20, 2019

PLAN INDEX

SHEET NO.	DESCRIPTION	REVISION DATE		
1	COVER SHEET	9/20/2019		
2	EXISTING CONDITIONS PLAN	9/20/2019		
3	CONSTRUCTION LAYOUT AND LIGHTING PLAN	9/20/2019		
4	GRADING, DRAINAGE, UTILITY, LANDSCAPE, AND EROSION CONTROL PLAN	9/20/2019		
5	DETAILS	9/20/2019		


NEW BEDFORD	ZONING RE	QUIREMENTS	
ZONING DIS	STRICT: INDUSTI	RIAL A (IA)	
	REQUIRED	EXISTING	PROPOSED
MIN. LOT AREA (SF)	0	131,160	131,160
MIN. LOT FRONTAGE (FT)	0	152	152
FRONT/SIDE/REAR SETBACKS - BUILDING (FT)	25	6	6
FRONT/SIDE/REAR SETBACKS - PARKING (FT)	0	0	0
MAX BUILDING HEGHT (FT)	100	27	27
MAX LOT COVERAGE - BUILDINGS (%)	50	34	34
MIN GREEN SPACE (%)	20	15	15*
OFF-STREET PARKING SPACES	108	24	73**
COMPACT PARKING SPACES	N/A	0	0
ACCESSIBLE PARKING SPACES	4	2	4
VAN ACCESSIBLE PARKING SPACES	1	0	1
SCREENING BUFFERS (FT)	5	0	0***
UPLAND AREA (%)	N/A	100	100
UPLAND AREA (SF)	N/A	131,160	131,160


** REFER TO SHEET 3. REDUCED PARKING SPACE QUANTITY TO BE REQUESTED VIA SPECIAL PERMIT


PERMITTING SUBMISSION




REGISTERED PROFESSIONAL

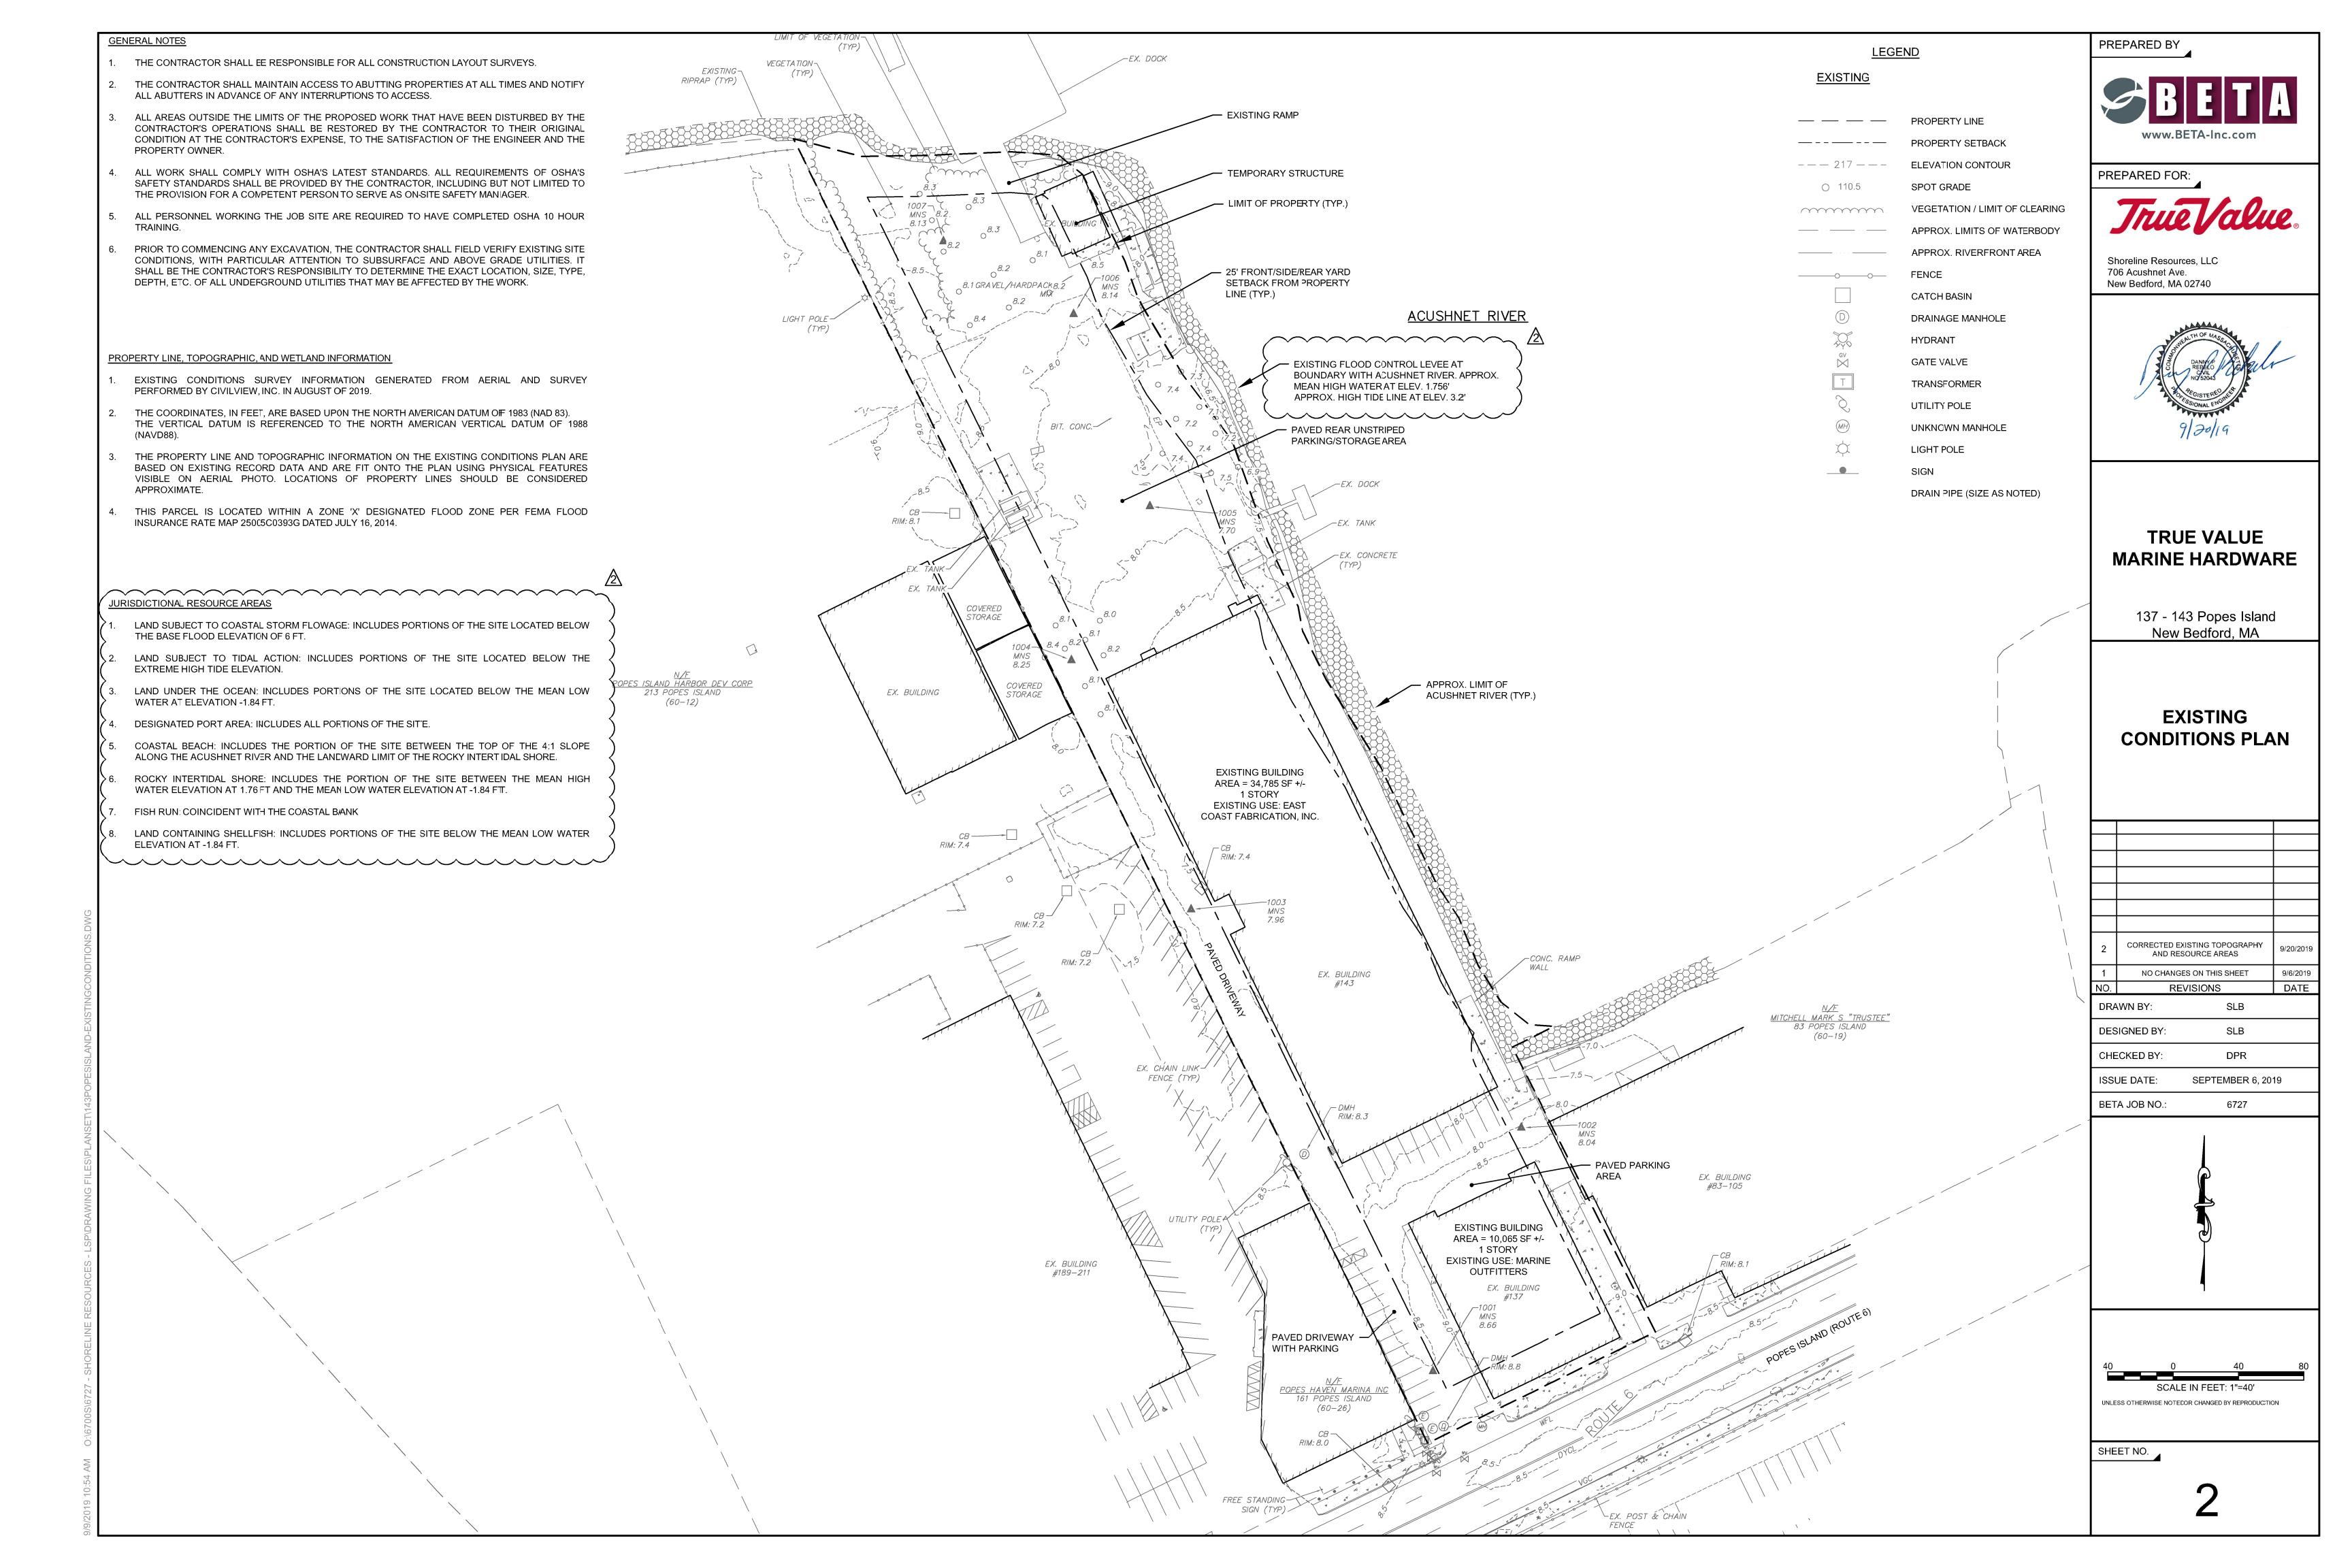

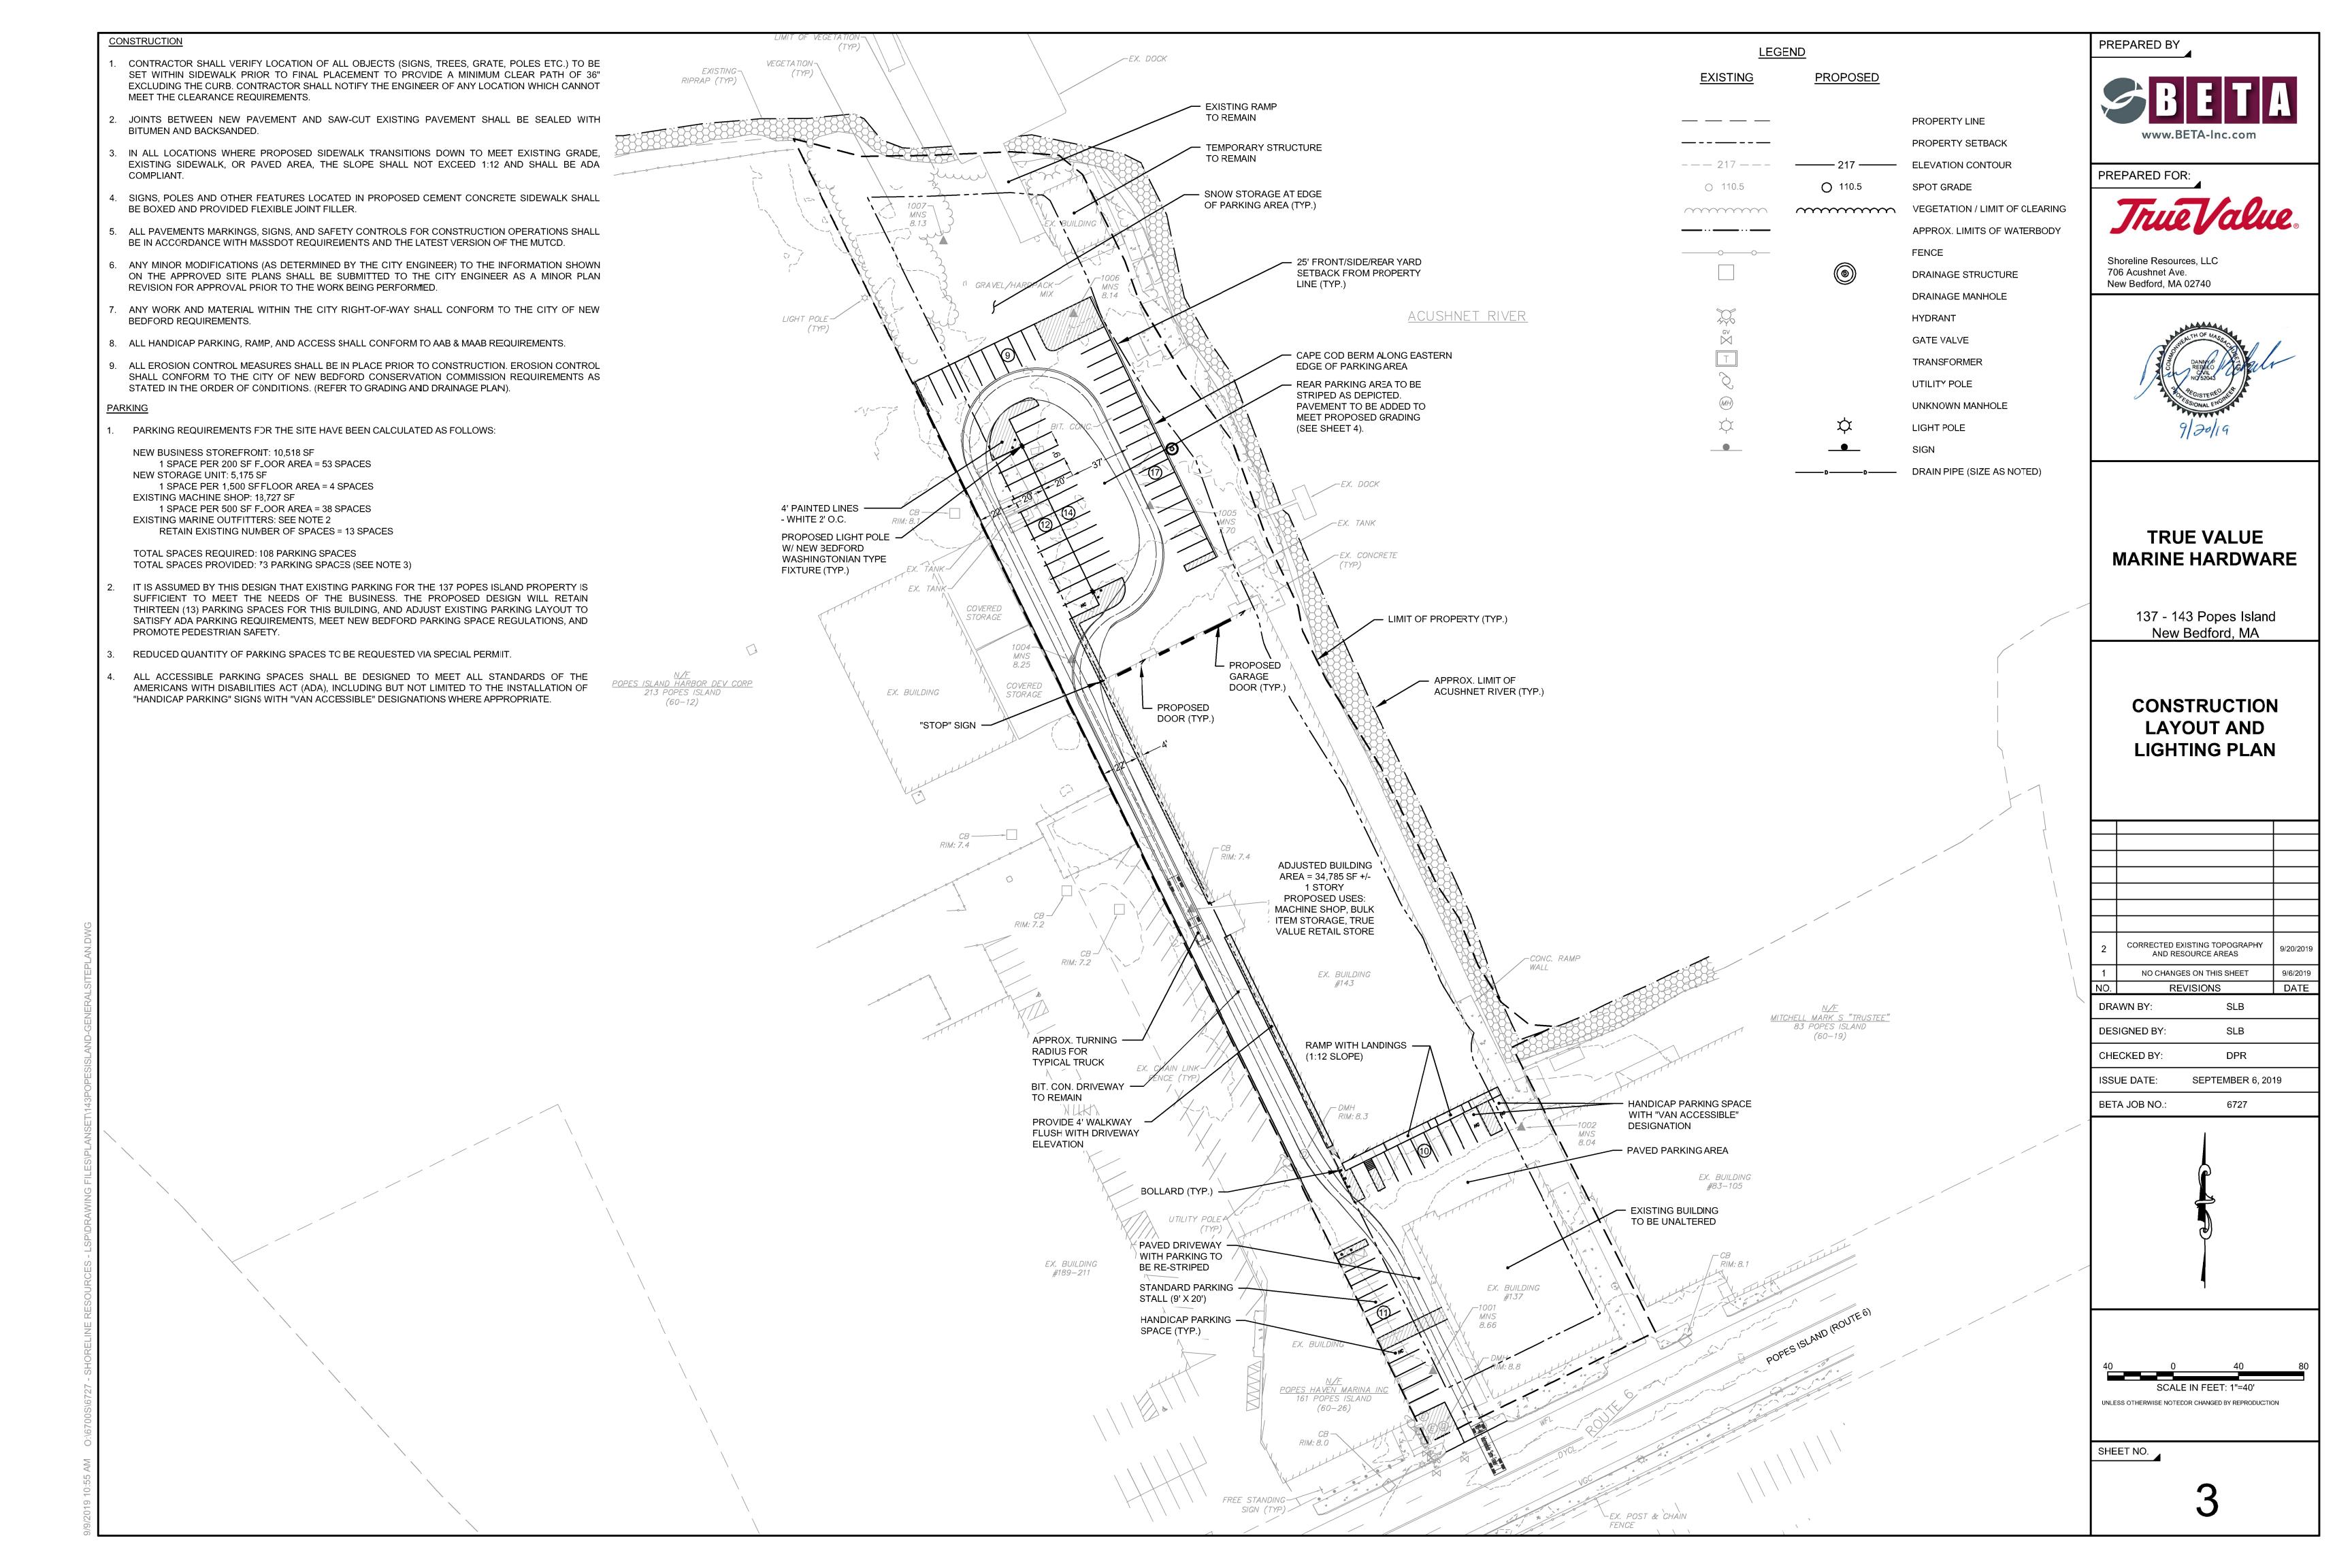

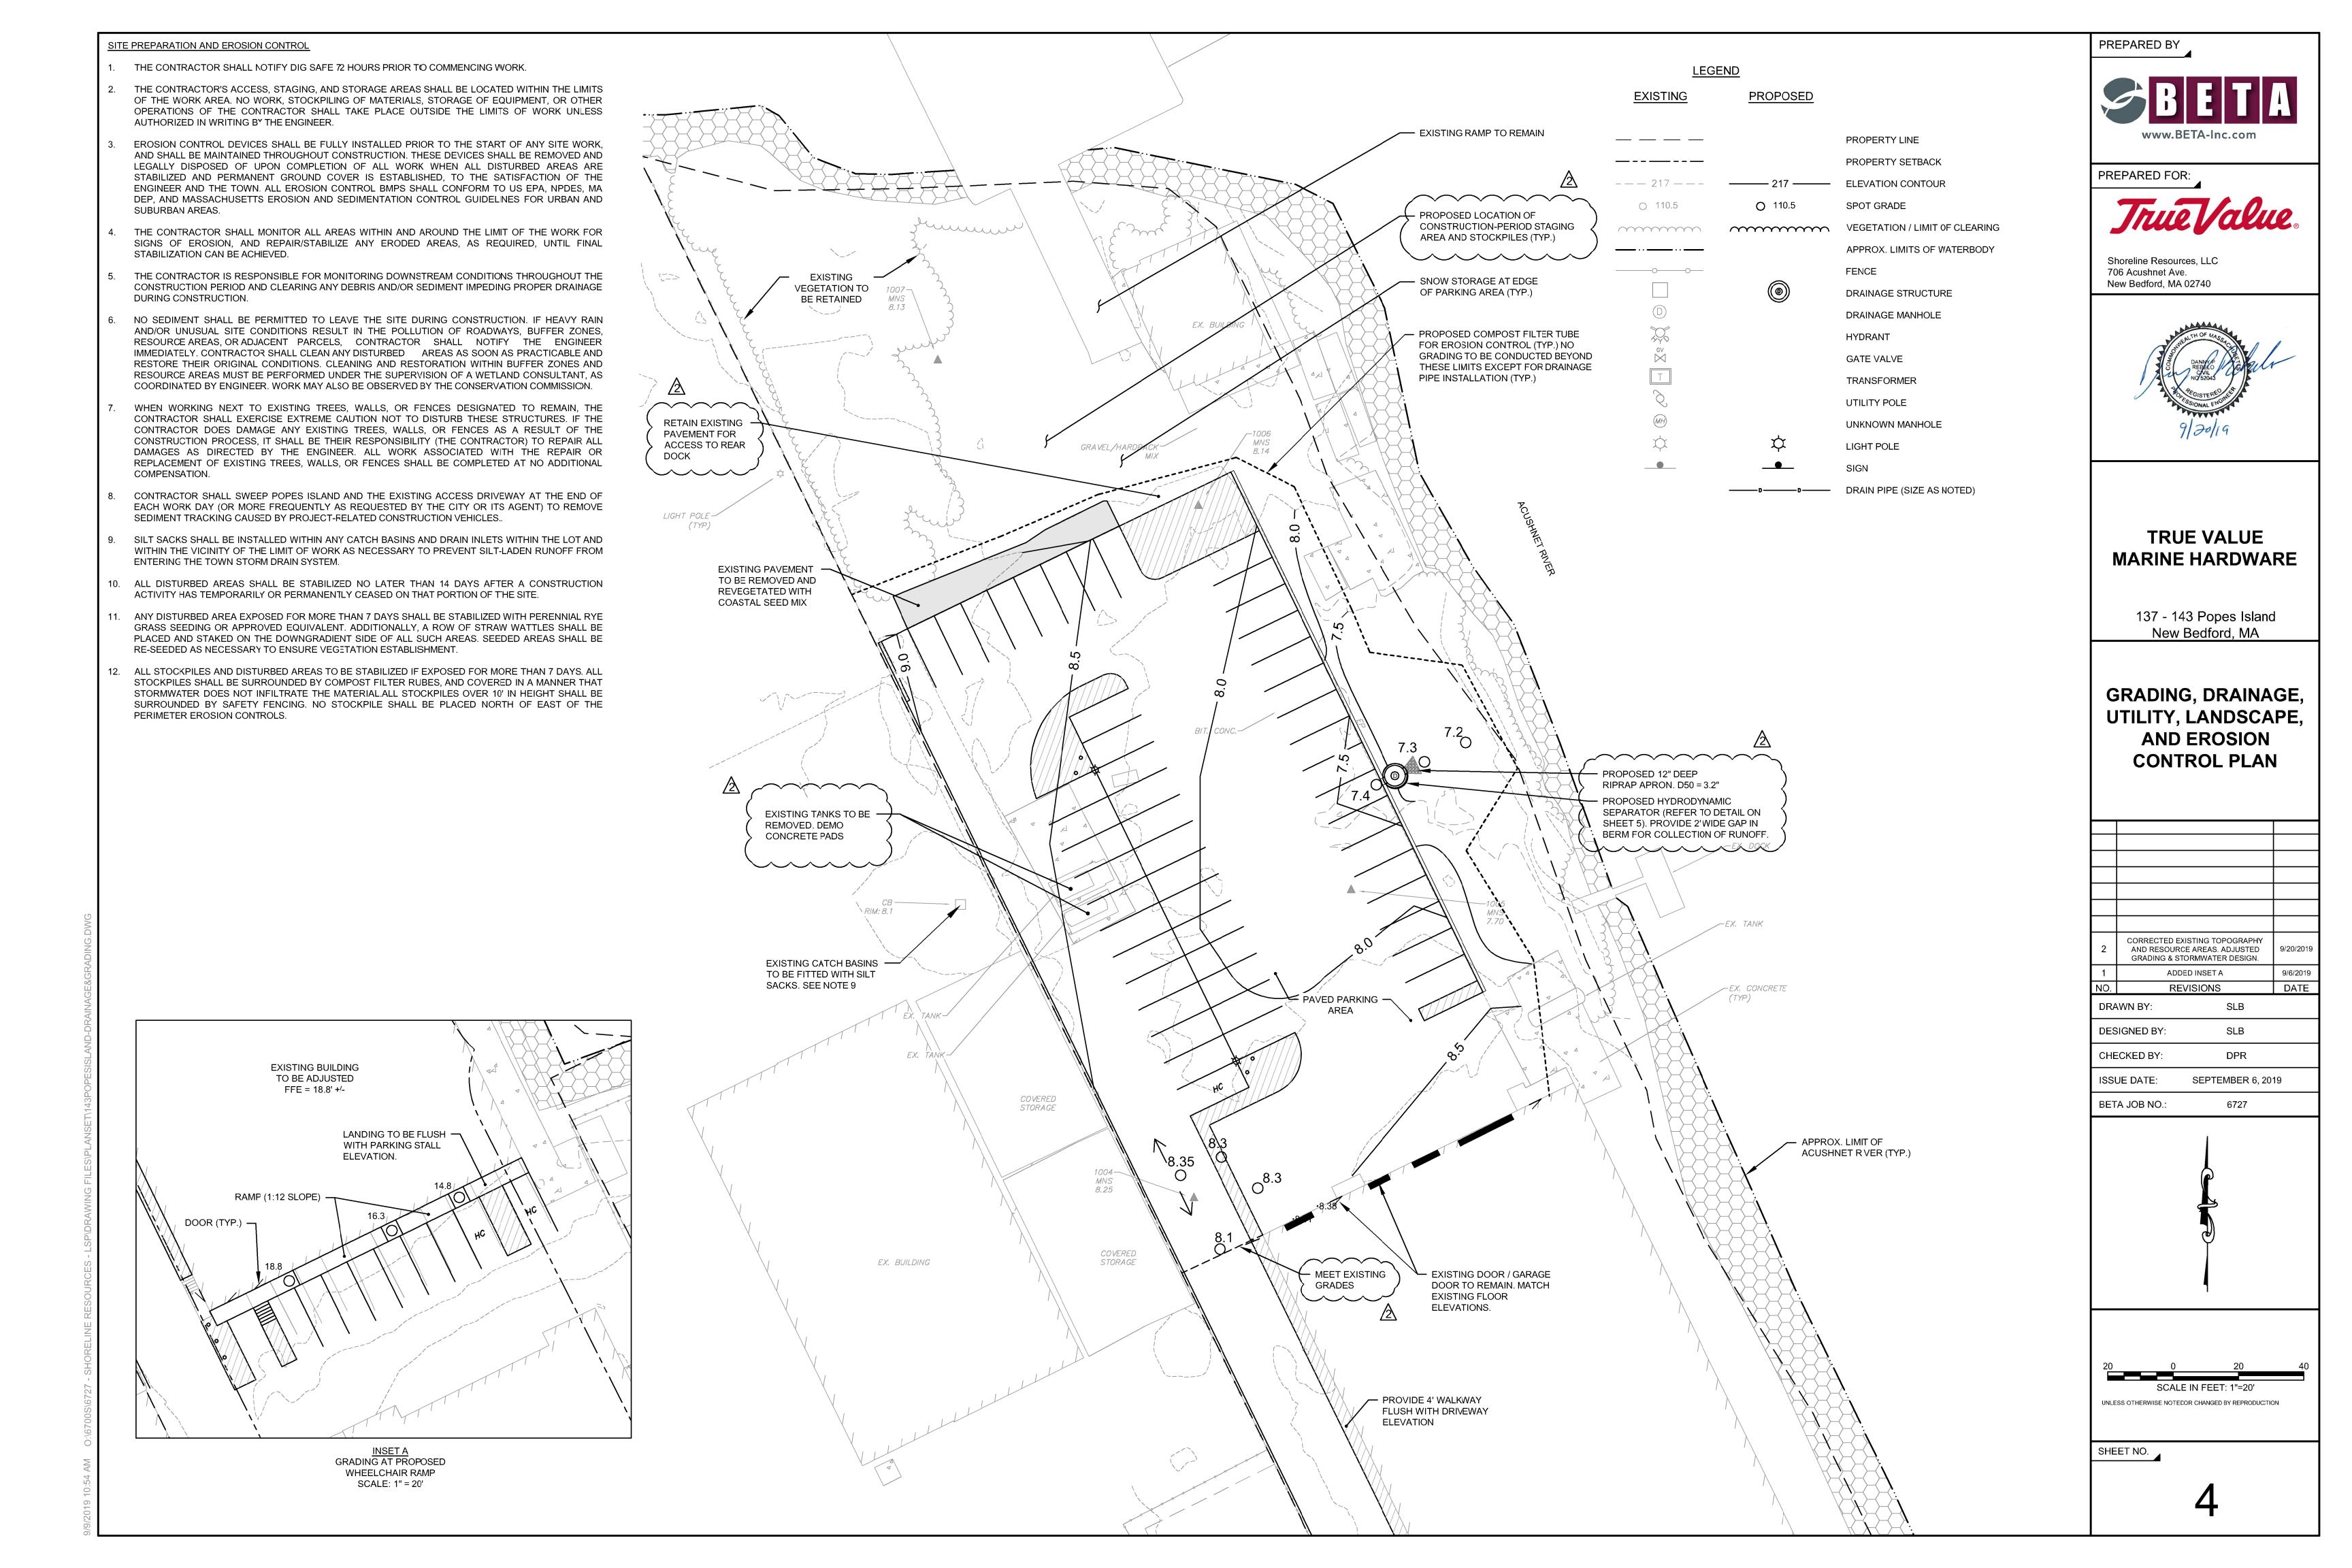

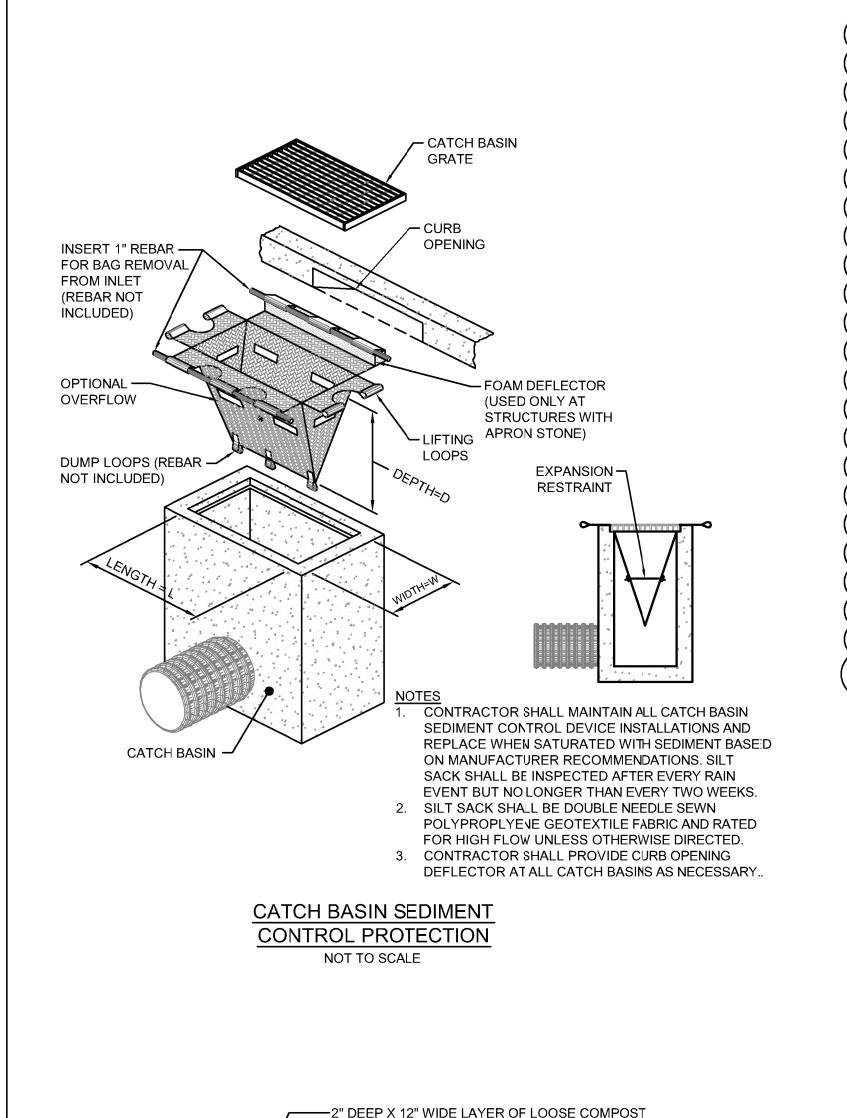



MATERIAL PLACED ON UPHILL/FLOR SIDE OF TUBES

—COMPOST FILTER TUBE

TO FILL SPACE BETWEEN SOL SURFACE AND TUBES

MIN. 12" IN DIAMETER WITH E-FECTIVE HEIGHT OF 9.5"

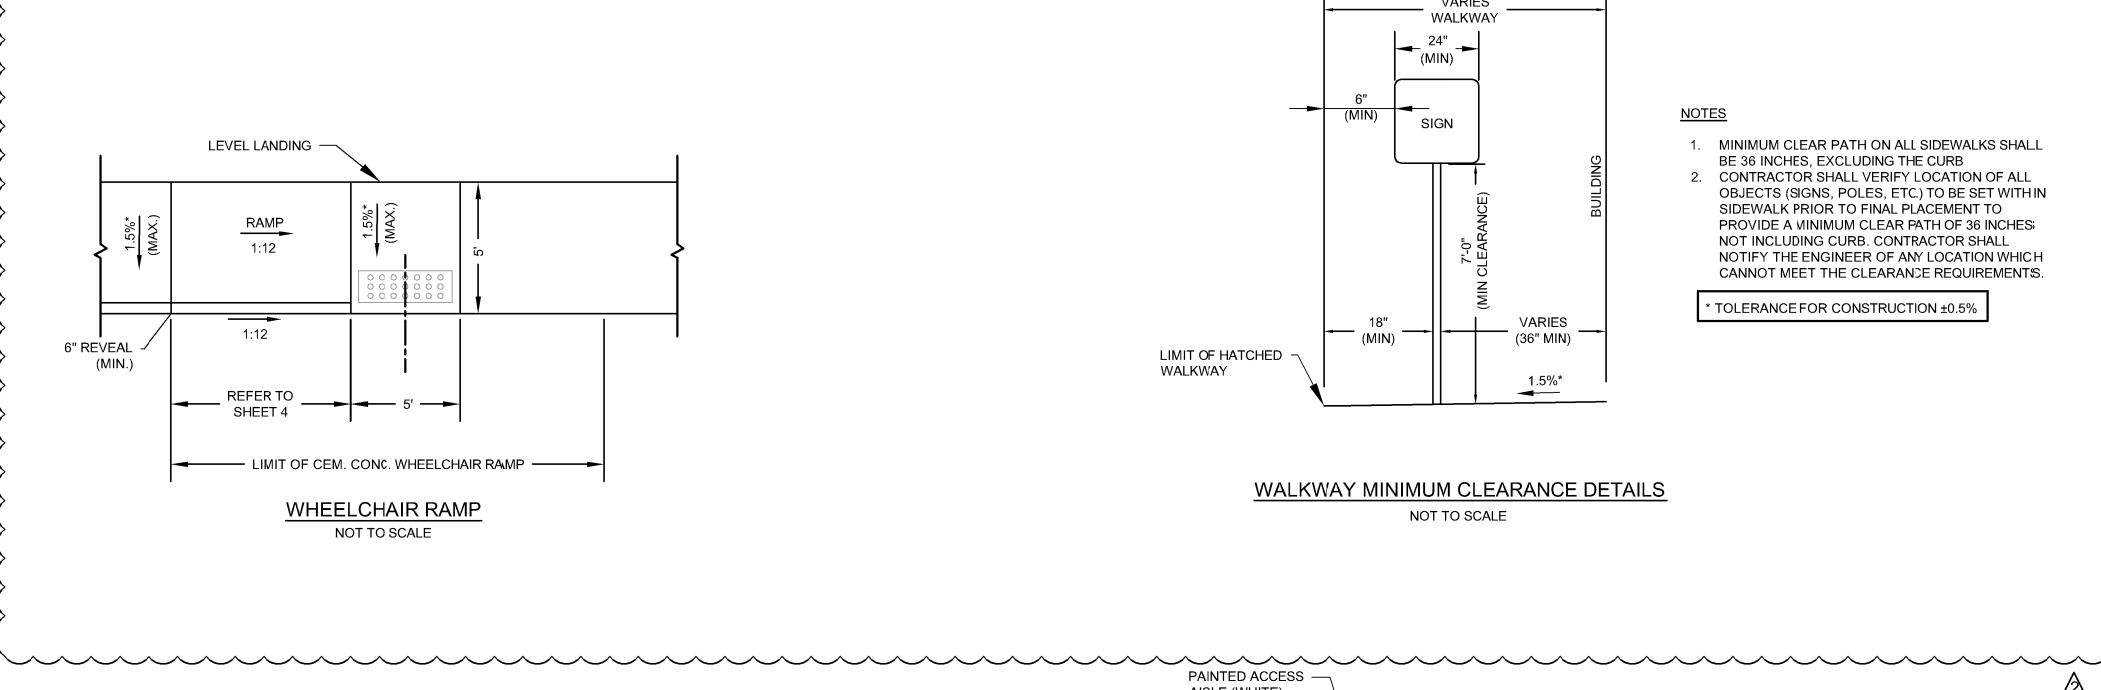

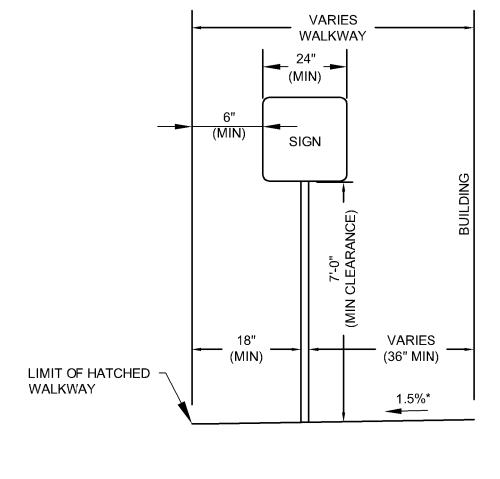

1. MINIMUM CLEAR PATH ON ALL SIDEWALKS SHALL

BE 36 INCHES, EXCLUDING THE CURB

2. CONTRACTOR SHALL VERIFY LOCATION OF ALL OBJECTS (SIGNS, POLES, ETC.) TO BE SET WITHIN SIDEWALK PRIOR TO FINAL PLACEMENT TO PROVIDE A MINIMUM CLEAR PATH OF 36 INCHES NOT INCLUDING CURB. CONTRACTOR SHALL NOTIFY THE ENGINEER OF ANY LOCATION WHICH CANNOT MEET THE CLEARANCE REQUIREMENTS.

* TOLERANCE FOR CONSTRUCTION ±0.5%

PAVEMENT

ACCESSIBLE PARKING SPACE

SLOPE WITHIN

ACCESSIBLE SPACE OR AISLE

DESIGNED TO MEET ALL REQUIREMENTS OF ADA, INCLUDING

"VAN ACCESSIBLE" DESIGNATION WHERE SPECIFIED IN THE PLANS.

SHALL NOT EXCEED 2% GRADE. PARKING SIGNS SHALL BE

3. ALL PARKING SPACE STRIPING

SHALL BE 4" PAINTED WHITE LINES.

NOT TO SCALE

PAINTED ACCESS

AISLE (WHITE)

POST MOUNTED ACCESSIBLE

SIGN WITH CONCRETE BASE

AT EACH SPACE

WALKWAY MINIMUM CLEARANCE DETAILS

www.BETA-Inc.com

PREPARED BY

PREPARED FOR:

Shoreline Resources, LLC

New Bedford, MA 02740

706 Acushnet Ave.

TRUE VALUE MARINE HARDWARE

137 - 143 Popes Island New Bedford, MA

DETAILS

REVISED HYDRODYNAMIC

SEPARATOR DESIGN. ADDED SIGN

AND RAMP DETAILS.

NO CHANGES ON THIS SHEET

REVISIONS

SLB

SLB

DPR

SEPTEMBER 6, 2019

6727

DRAWN BY:

DESIGNED BY:

CHECKED BY:


ISSUE DATE:

BETA JOB NO.:


9/20/2019

9/6/2019

DATE

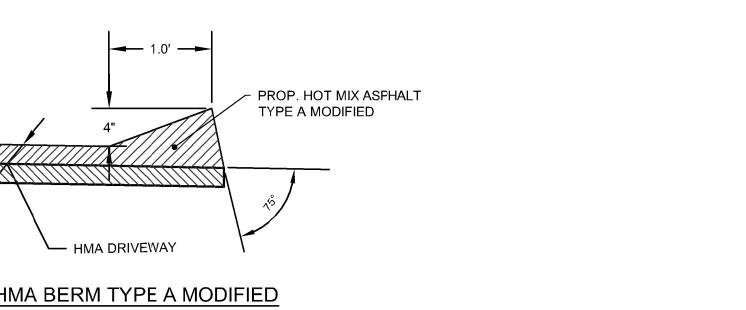

HMA BERM TYPE A MODIFIED (CAPE COD BERM) NOT TO SCALE

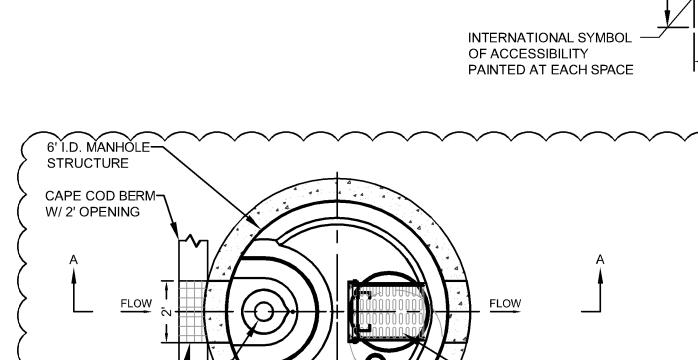

(MAY VARY)

8' OR 5'

TOP SLAB ACCESS TO BE ORIENTED OVER OIL INSPECTION PIPE AND OUTLET RISER PLAN VIEW

CONTRACTOR TO GROUT TO FINISHED GRADE GRADE RINGS / RISERS--SAFETY GRATE CUSTOM 6" HIGH X 24" WIDE OUTLET -PROPOSED RIPRAP APRON. SEE SHEET 4


SAFETY GRATE OVER

OUTLET RISER

- 1. STRUCTURE SHALL MEET AASHTO HS20 AND CASTINGS SHALL MEET HS20 (AASHTO M 306) LOAD RATING, ASSUMING GROUNDWATER ELEVATION AT, OR BELOW, THE OUTLET PIPE INVERT ELEVATION. ENGINEER OF RECORD TO CONFIRM ACTUAL GROUNDWATER ELEVATION.
- 2. PVC HYDRAULIC SHEAR PLATE IS PLACED ON SHELF AT BOTTOM OF SCREEN CYLINDER. REMOVE AND REPLACE AS NECESSARY DURING MAINTENANCE CLEANING.
- 3. HYDRODYNAMIC SEPARATOR STRUCTURE SHALL BE PRECAST CONCRETE CONFORMING TO ASTM C473 AND AASHTO LOAD FACTOR DESIGN METHOD.

- A. ANY SUB-BASE, BACKFILL DEPTH, AND/OR ANTI-FLOTATION PROVISIONS ARE SITE-SPECIFIC DESIGN CONSIDERATIONS AND SHALL BE SPECIFIED BY ENGINEER
- B. CONTRACTOR TO PROVIDE EQUIPMENT WITH SUFFICIENT LIFTING AND REACH CAPACITY TO LIFT AND SET THE MANHOLE STRUCTURE (LIFTING CLUTCHES
- C. CONTRACTOR TO ADD JOINT SEALANT BETWEEN ALL STRUCTURE SECTIONS, AND ASSEMBLE STRUCTURE.
- D. CONTRACTOR TO TAKE APPROPRIATE MEASURES TO ASSURE UNIT IS WATER TIGHT, HOLDING WATER TO FLOWLINE INVERT MINIMUM. IT IS SUGGESTED THAT ALL JOINTS BELOW PIPE INVERTS ARE GROUTED.

HYDRODYNAMIC SEPARATOR

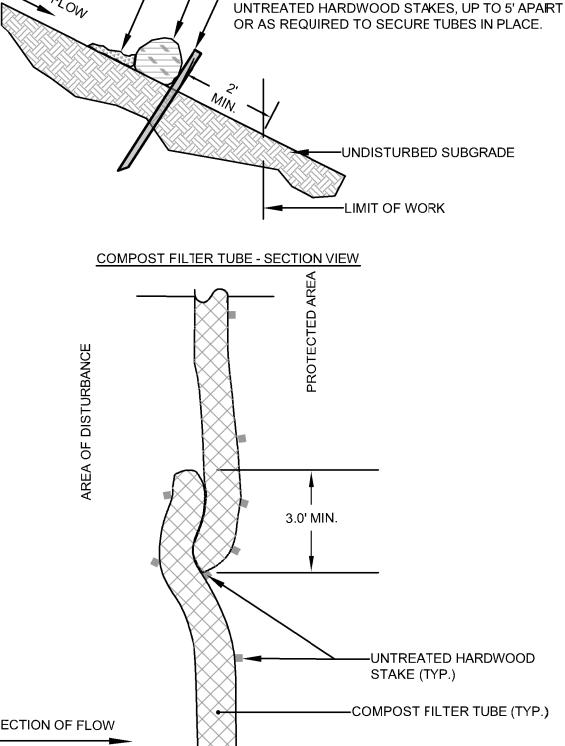

COMPOST FILTER TUBE NOTES:

- 1. PROVIDE A MINIMUM TUBE DIAMETER OF 12 INCHES FOR SLOPES UP TO 50 FEET IN LENGTH NITH A SLOPE RATIO OF 3H:1V OR STEEPER. LONGER SLOPES OF 3H:1\ MAY REQUIRE LARGER TUBE DIAMETER OR ADDITIONAL COURSING OF FILTER TUBES TO CREATE A FILTER BERM. REFER TO MANUFACTURER'S RECOMMENDATIONS FOR SITUATIONS WITH LONGER OR STEEPER SLOPES.
- 2. INSTALL TUBES ALONG CONTOURS AND PERPENDICULAR TO SHEET OR
- CONCENTRATED FLOW. 3. DO NOT INSTALL IN PERENNIAL, EPHEMERAL OR INTERMITTENT STREAMS.
- 4. CONFIGURE TUBES AROUND EXISTING SITE FEATURES TO MINIMIZE SITE DISTURBANCE AND MAXIMIZE CAPTURE AREA OF STORMWATER RUN-OFF.
- 5. TUBES FOR COMPOST FILTERS SHALL BE JUTE MESH OR APPROVED BIODEGRADABLE MATERIAL. ADDITIONAL TUBES SHALL BE USED AT THE DIRECTION OF THE ENGINEER.
- 6. TAMP TUBES IN FLACE TO ENSURE GOOD CONTACT WITH SOIL SURFACE. IT IS NOT NECESSARY TO TRENCH TUBES INTO EXISTING GRADE. 7. WHEN STAKING IS NOT POSSIBLE, SUCH AS WHEN TUBES MUST BE PLACED ON PAVEMENT, HEAVY CONCRETE OR CINDER BLOCKS CAN BE USED BEHIND TUBES UP TO 5' APART OR AS REQUIRED TO SECURE TUBES IN
- PLACE. 8. PROVIDE A 3' MINMUM OVERLAP AT ENDS OF TUBES TO JOIN IN A CONTINUOUS BARRIER AND MINIMIZE UNIMPEDED FLOW. STAKE JOINING TUBES SNUGLY AGAINST EACH OTHER TO PREVENT UNFILTERED FLOW BETWEEN THEM. SECURE ENDS OF TUBES WITH STAKES SPACED 18" APPART THROUGH TOPS OF TUBES. DO NOT PUNCTURE TUBES WITH STAKES.

6" ORIFICE PLATE-6" OIL INSPECTION PIPE. (TOP 1" MIN. FROM INSIDE OF TOP SLAB) STORMSCEPTOR INSERT-TRASH RACK AROUND-ORIFICE OPENING CUSTOM 6" HIGH X 24" WIDE CURB INLET 12" DROP TEE-SOLIDS STORAGE~ SUMP

1" MIN OPENINGS-

SECTION A-A

└NON-WOVEN

∽PERMANENT POOL ELEVATION

GEOTEXTILE FABRIC

-24" OUTLET RISER

SHEET NO.

DIRECTION OF FLOW

COMPOST FILTER TUBE - PLAN VIEW

SINGLE COMPOST FILTER TUBE FOR EROSION CONTROL

NOT TO SCALE