
— SITE PLAN — WS ORCHARD STREET ASSESSORS MAP 23 LOTS 158 & 294 NEW BEDFORD, MASSACHUSETTS

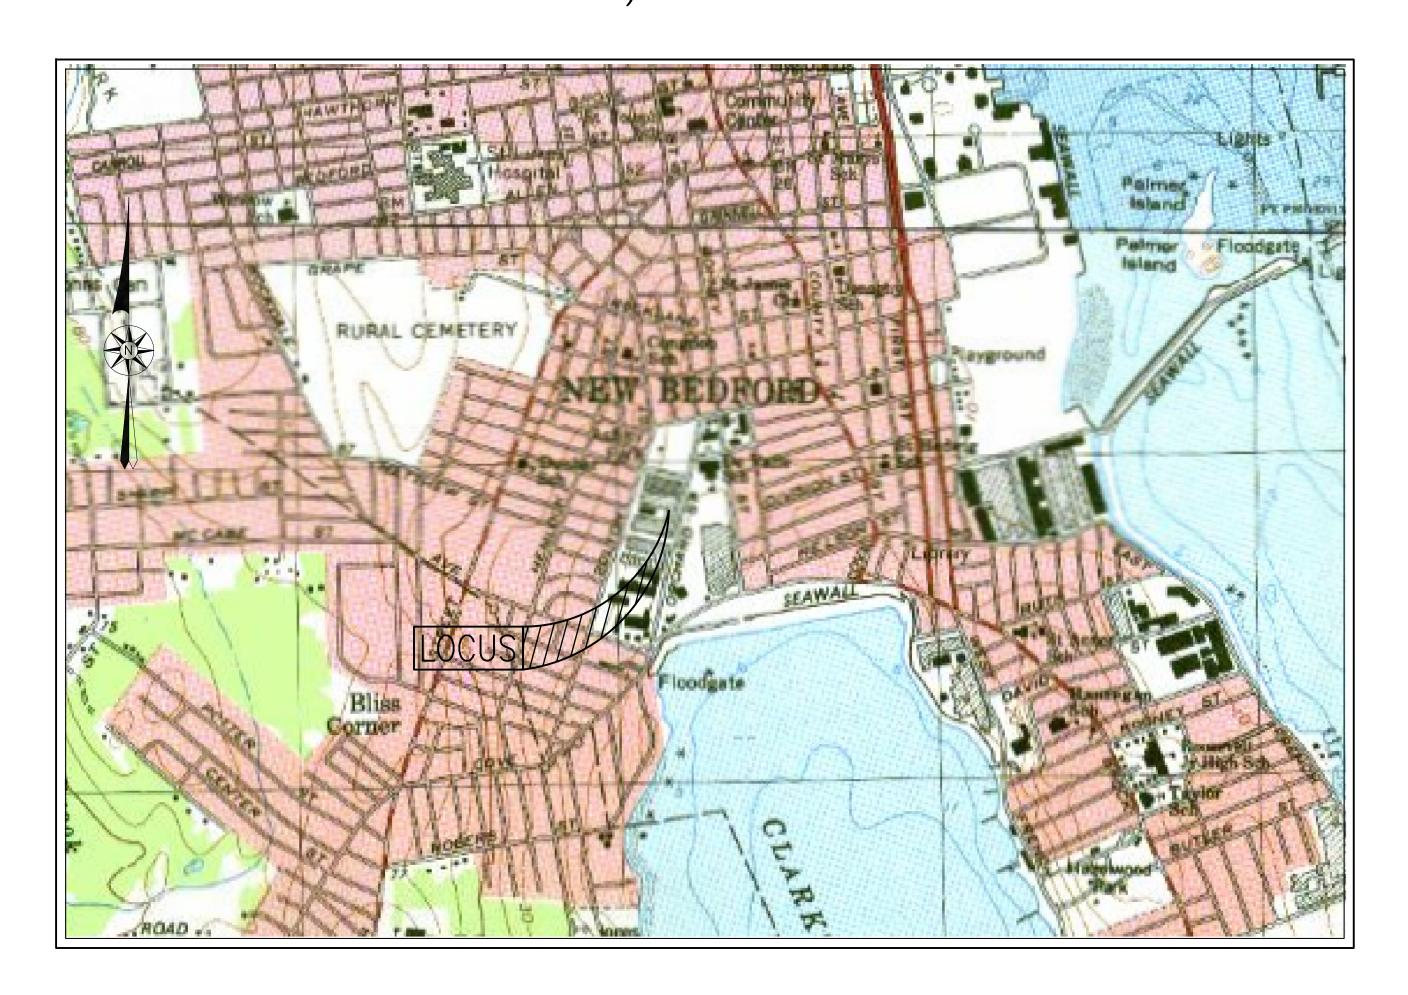

---AREA MAP---

SCALE: 1"=1,000'±

CORD OWNER

RECORD OWNER:

ASSESSORS MAP 23 LOTS 158 & 294
CLARK'S COVE DEVELOPMENT CO., LLC
651 ORCHARD STREET, SUITE 200
NEW BEDFORD, MA 02744
DEED BOOK 7223 PAGE 263
PLAN BOOK 177 PAGE 6

WAIVERS REQUESTED

<u>CODE OF ORDINANCES — CH. 9 COMPREHENSIVE ZONING</u>

1. SECTION 5455 — DEVELOPMENT IMPACT STATEMENT

NING DATA -	
JB (MIXED USE BUSINESS)	
<u>REQUIRED</u>	<u>PROVIDED</u>
8,000 S.F.	46,174± S.F.
0 FT	230.00 FT
0 FT	77.5± FT
10 FT	53.5± FT
10 FT	40.5± FT
100 FT	22.9± FT
100 %	21.7± %
100 %	62.6± %
	USE BUSINESS) REQUIRED 8,000 S.F. 0 FT 10 FT 10 FT 100 FT 100 FT

- PARKING & LOADING REQUIREMENTS -PRINCIPAL USE: RETAIL STORE REQUIREMENT <u>PROVIDED</u> ONE (1) SPACE PER EACH 200 S.F. OF GROSS FLOOR AREA, BUT NOT LESS THAN TWO (2) SPACES FOR EACH BUSINESS USE INTENDED TO OCCUPY THE PREMISES. AFTER 20,000 S.F. OF 50 TOTAL SPACES 50 TOTAL SPACES GROSS FLOOR AREA, ONE SPACE PER 400 S.F. WHEN 26-50 TOTAL PARKING SPACES ARE REQUIRED, 2 MUST BE 2 ACCESSIBLE 2 ACCESSIBLE ACCESSIBLE SPACES. ONE IN EVERY EIGHT ACCESSIBLE SPACES, SPACES BUT NOT LESS THAN ONE, SHALL BE VAN ACCESSIBLE TWO (2) LOADING SPACES FOR EACH BUILDING CONTAINING 10,000 S.F. OF GROSS FLOOR AREA. THEREAFTER, ONE (1) ADDITIONAL LOADING SPACE SHALL BE REQUIRED FOR EACH FIFTEEN (15) FEET 1 LOADING SPACE 1 LOADING SPACE OF DOCK, PLATFORM, OR OPENING IN THE BUILDING WHERE THE LOADING OR UNLOADING OF COMMODITIES IS INTENDED TO OCCUR.

- IN D E X -

SHEET DESCRIPTION

1 COVE

EXISTING CONDITIONS

3 LAYOU

GRADING & DRAINAGE

5 UTILITIES

LANDSCAPE

7 LIGHTING

8 NOTES & LEGEND

9-10 DETAILS

REVISIONS





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401 COUNTY STREET
NEW BEDFORD, MA 02
P.508.717.3479
OFFICES IN:
•TAUNTON
•MARLBOROUGH
•WARWICK, RI

DRAWN BY: MJW

DESIGNED BY: MJW

SITE PLAN
WS ORCHARD STREET -

ASSESSORS

NEW BI
PREPARED LISCIOTTI DEVE

OR: 83 ORCHARD

JUNE 7, 2019

SCALE: AS NOTED


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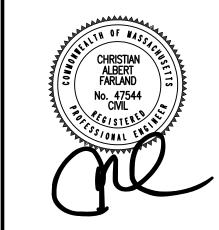
COVER

SHEET 1 OF 10

LISCIOTTIDEVELOPMENT



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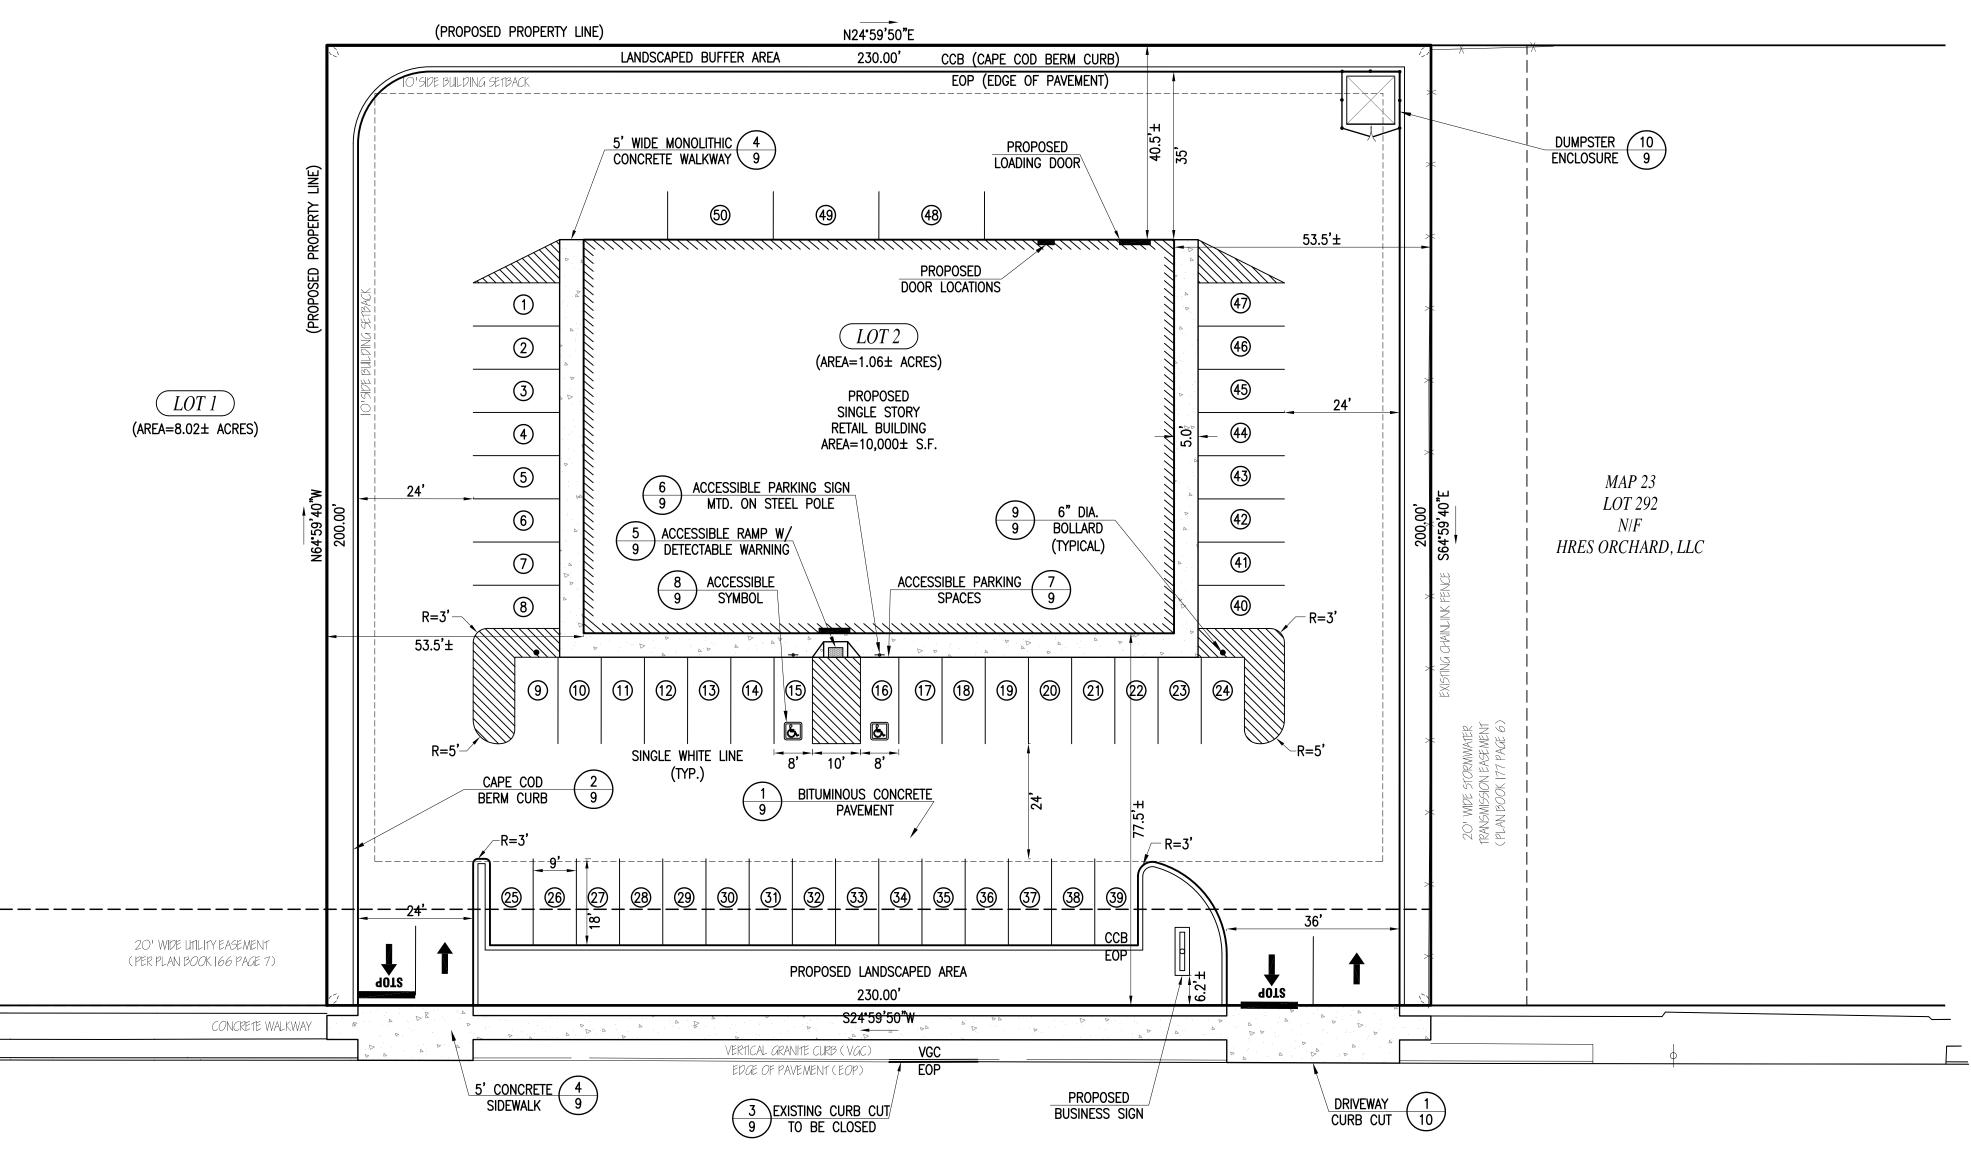
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2 ASSESSORS MAP 23 LOTS 158
NEW BEDFORD, MASSACHUS

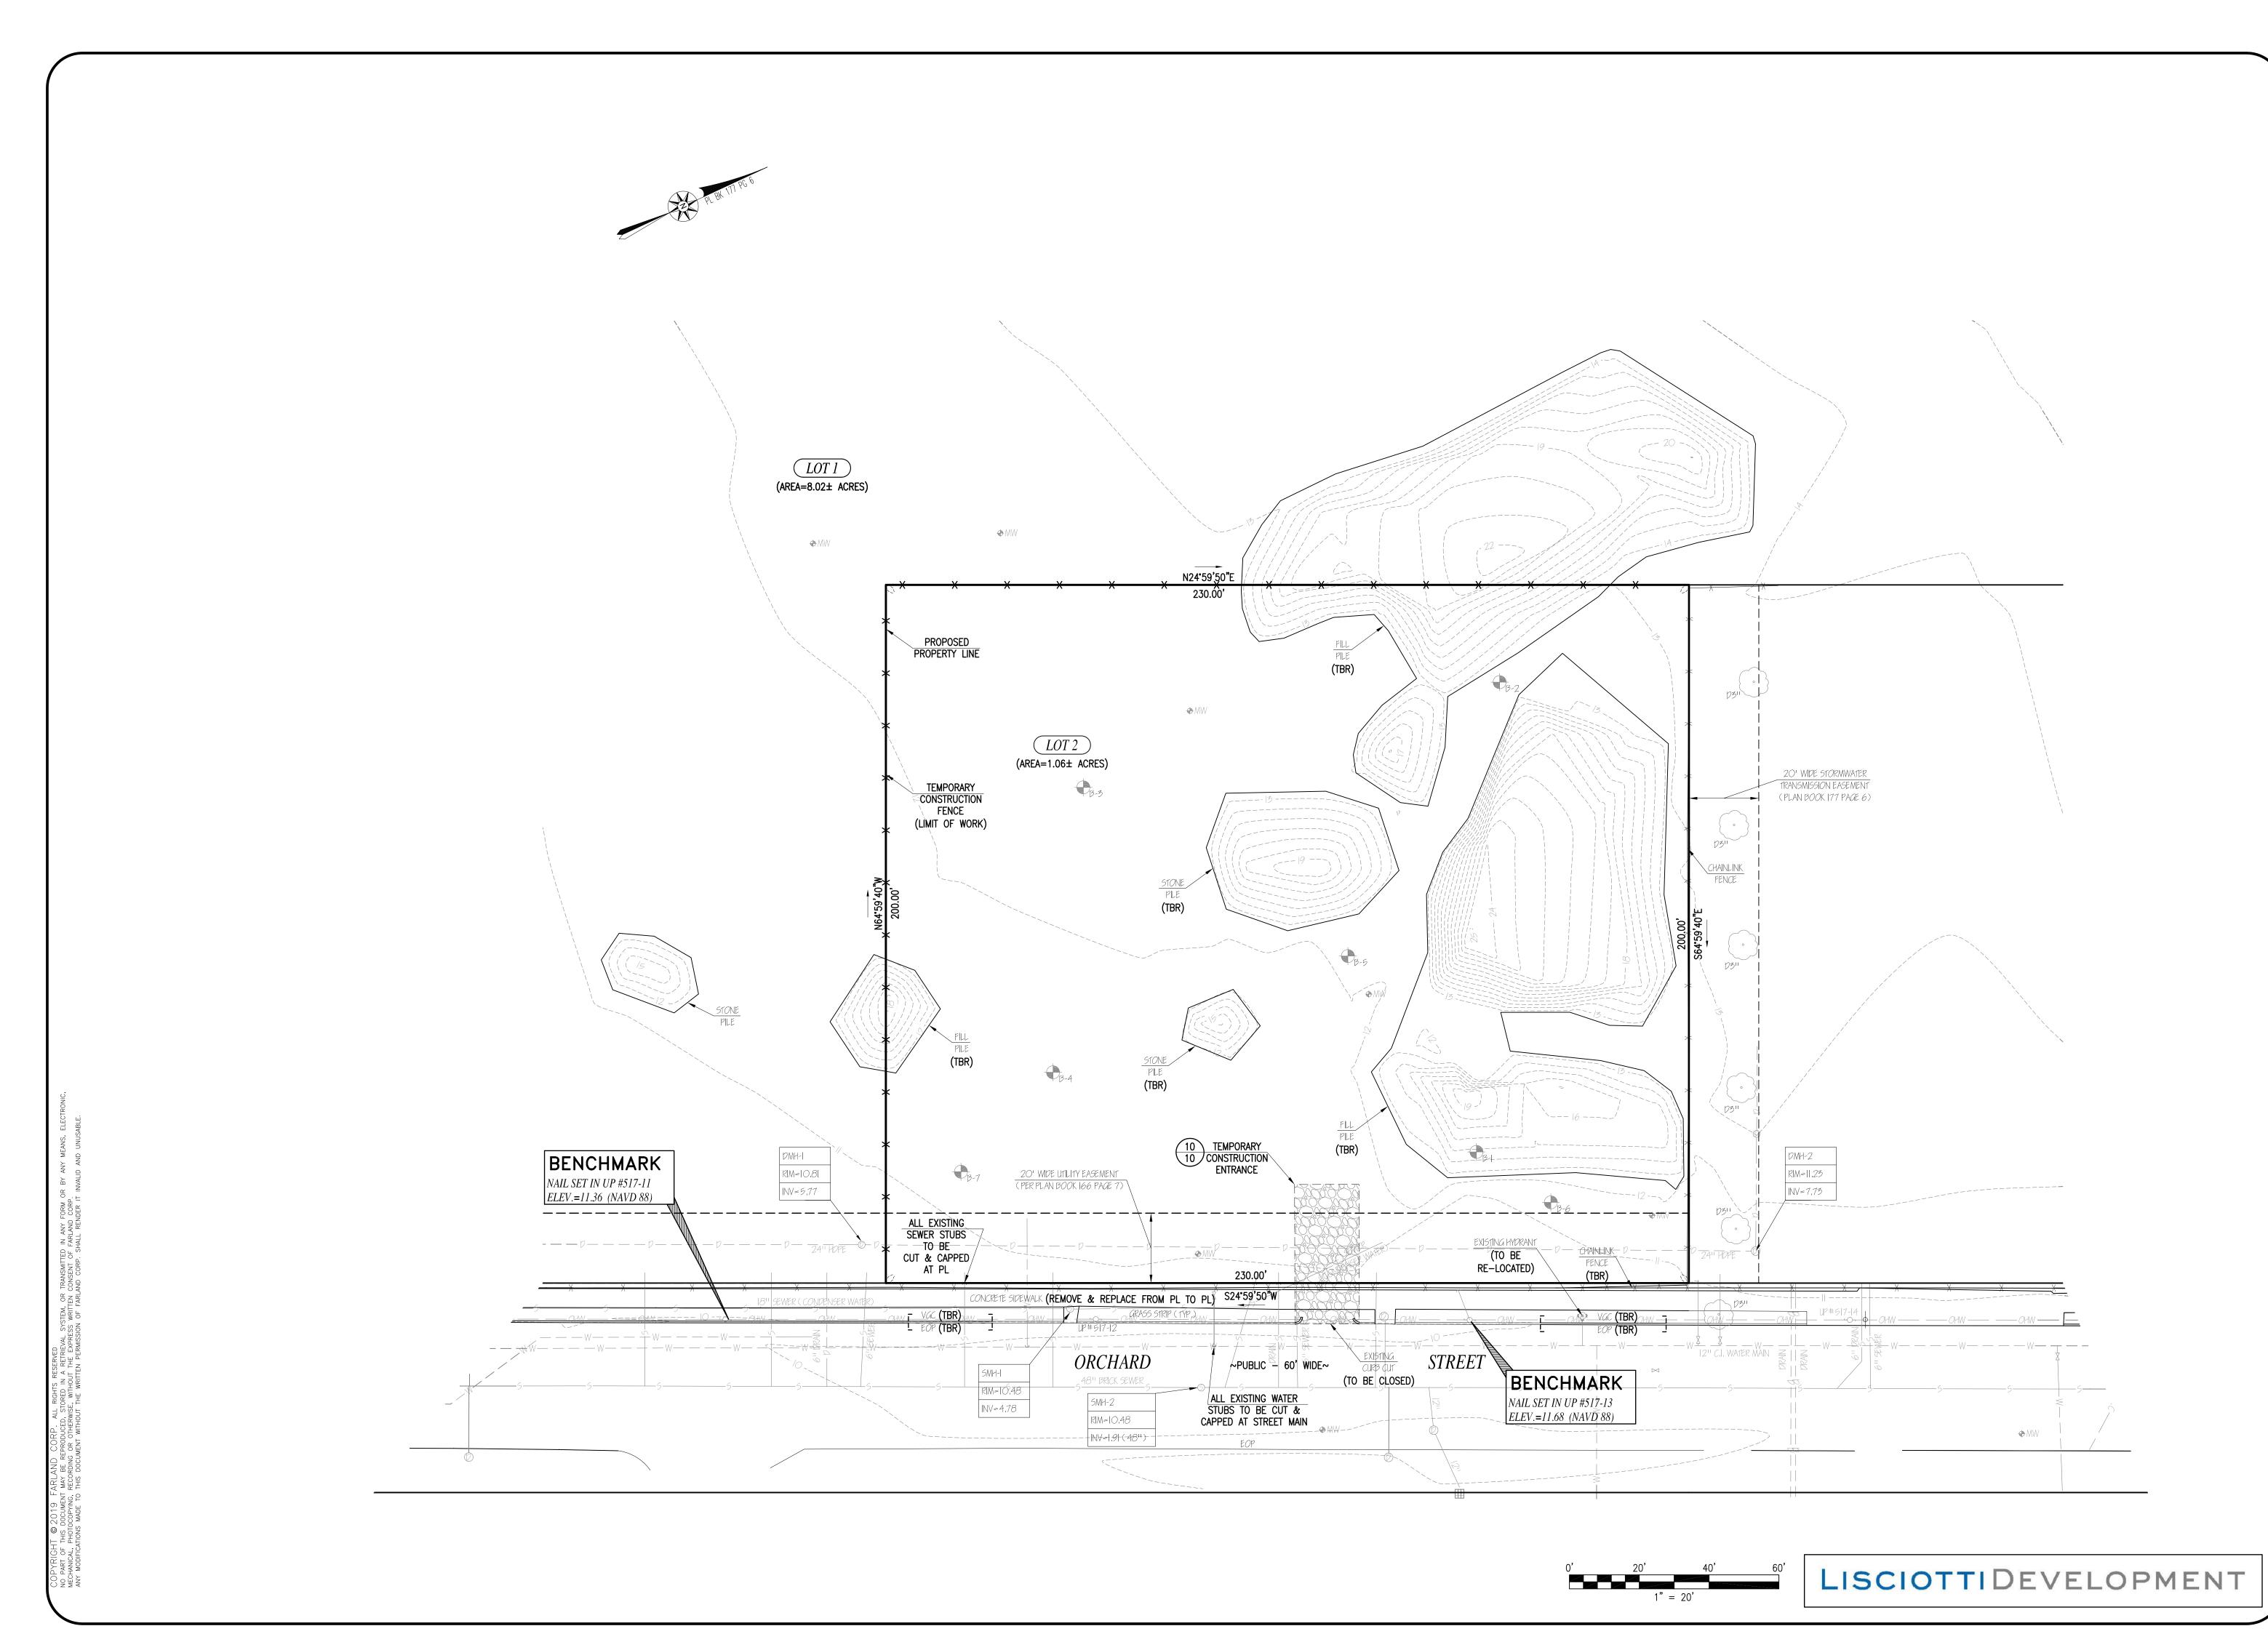JUNE 7, 2019 SCALE: 1"=20' JOB NO. 19-210 LATEST REVISION:

EXISTING CONDITIONS

SHEET 2 OF 10



ORCHARD ~PUBLIC - 60' WIDE~ STREET

LISCIOTTIDEVELOPMENT

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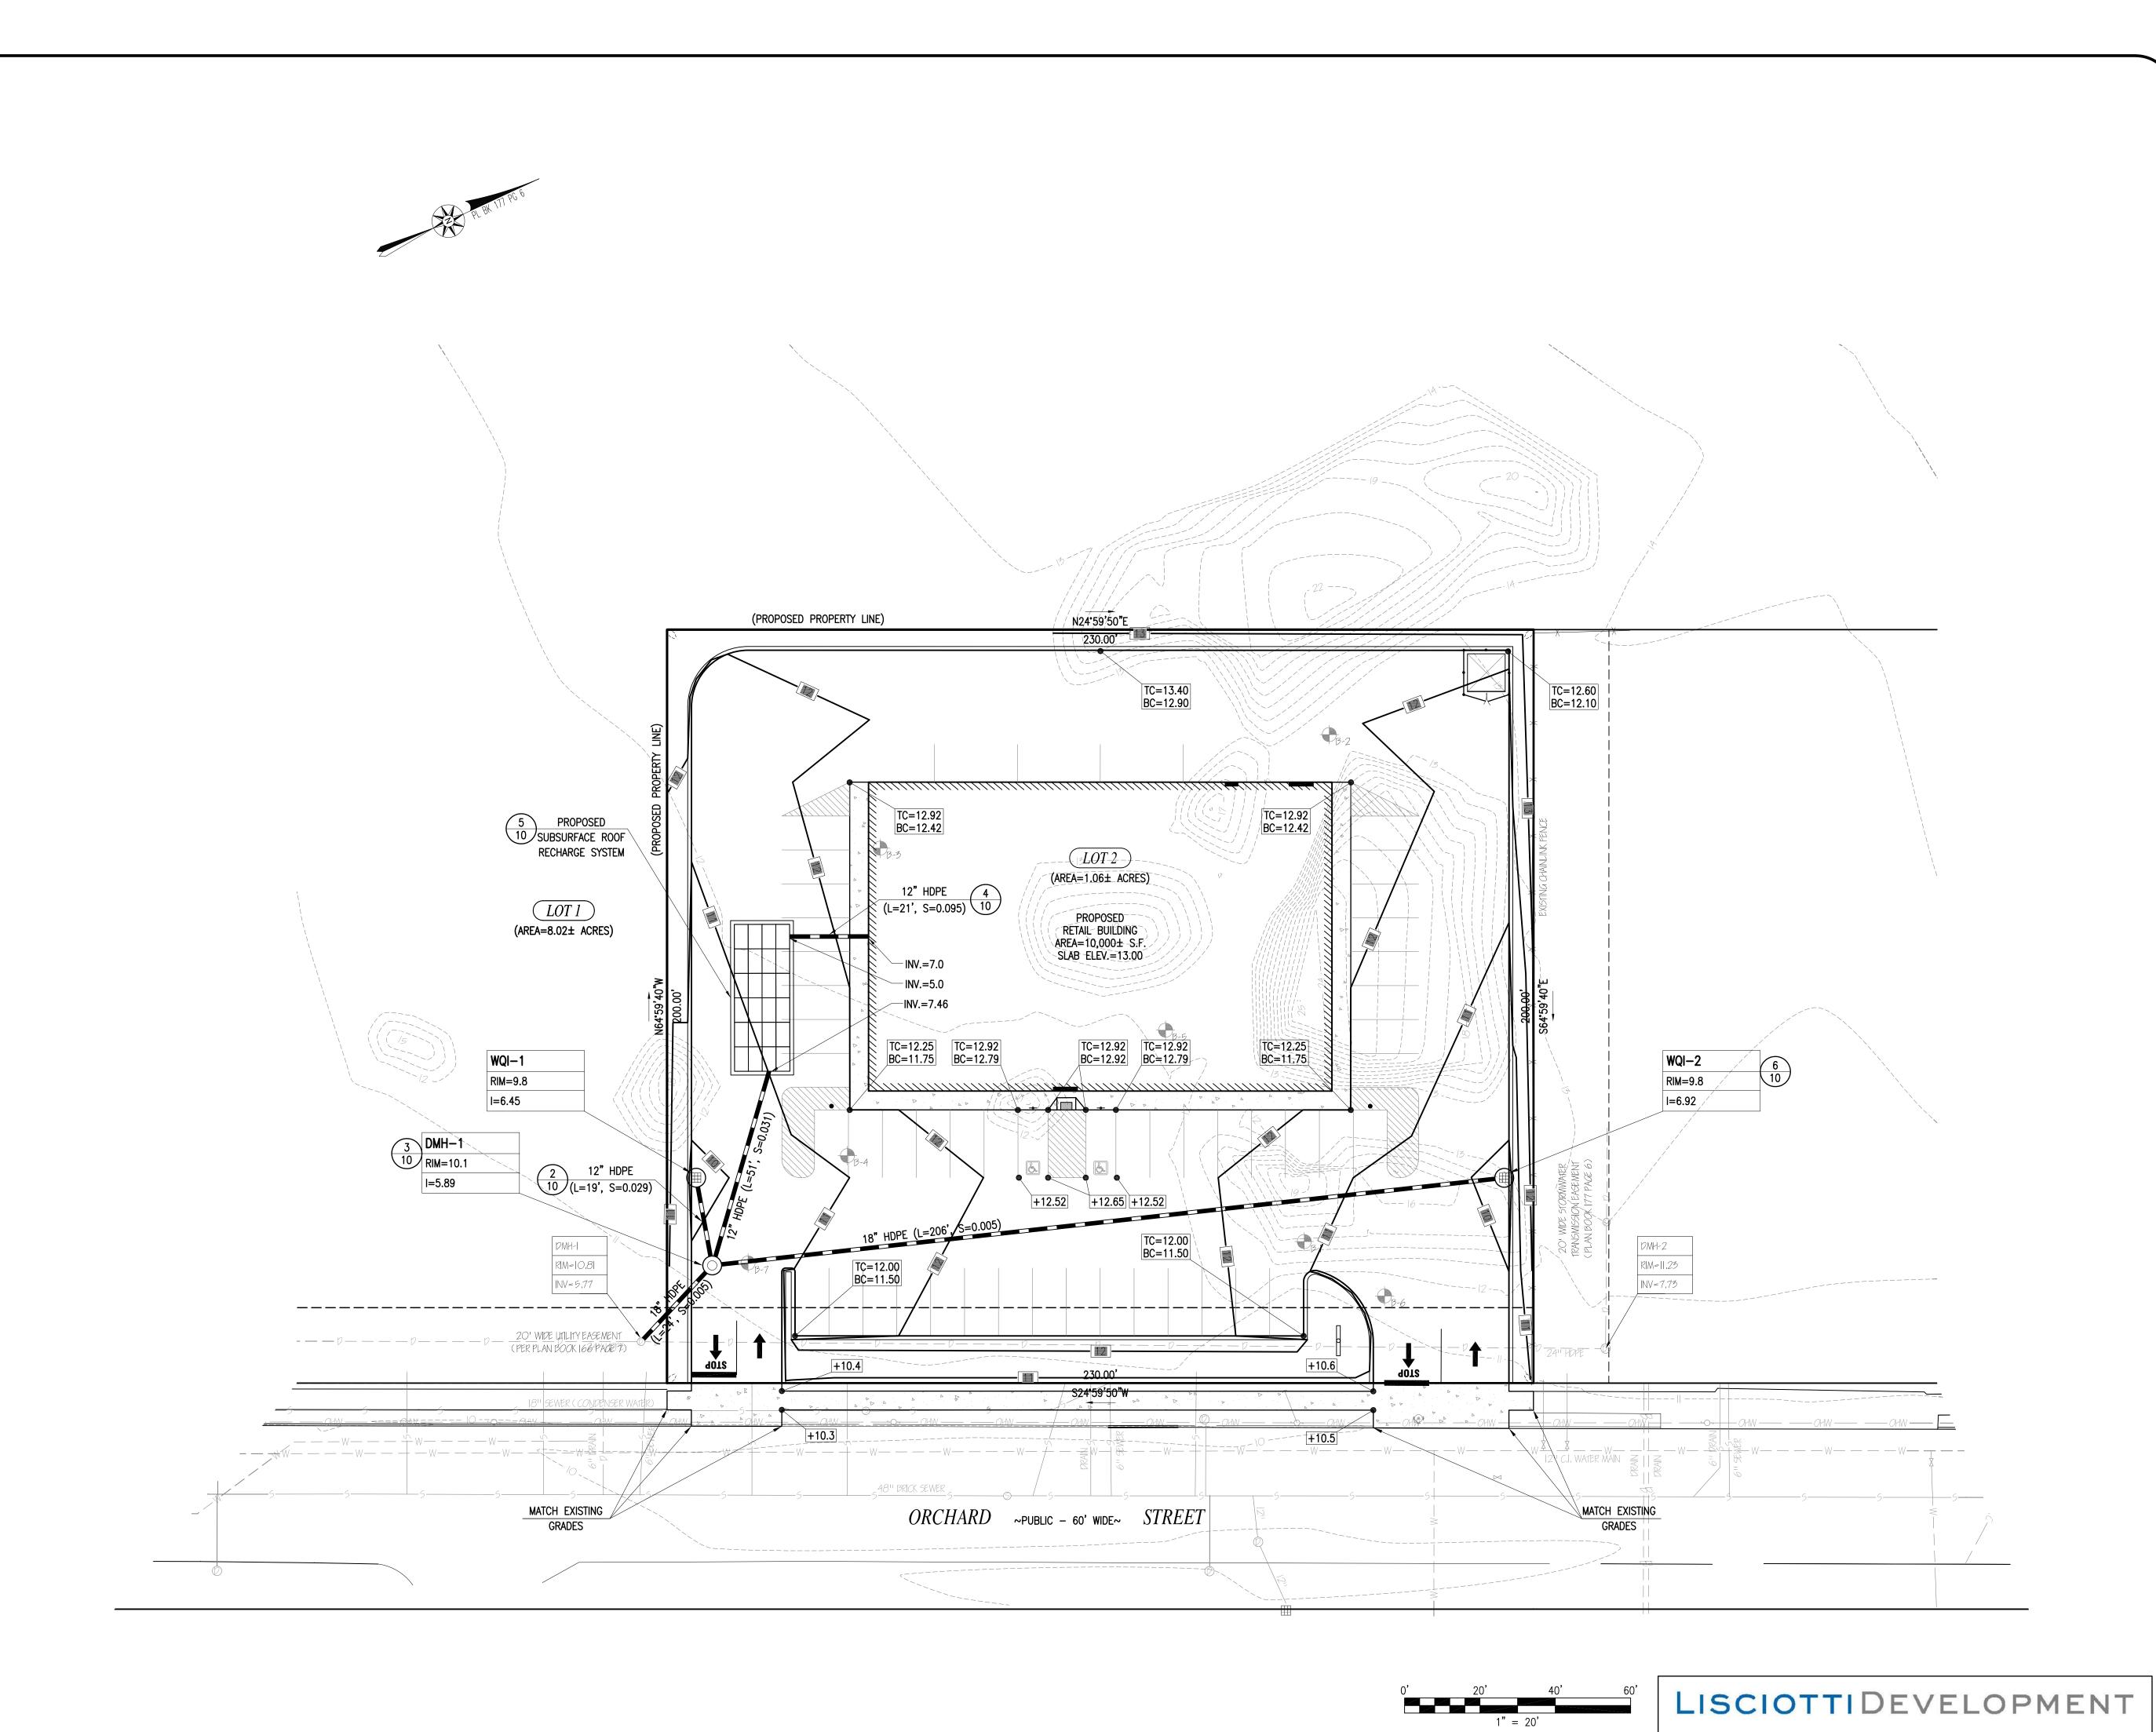
0 2 **%** □ ASSESSORS MAP 23 LOTS 158

NEW BEDFORD, MASSACHUS

> JUNE 7, 2019 SCALE: 1"=20' JOB NO. 19-210 LATEST REVISION:

LAYOUT

SHEET 3 OF 10



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•WARWICK, RI

DRAWN BY: MJW
DESIGNED BY: MJW
CHECKED BY: CAF

ASSESSORS MAP 23 LOTS 158 & 294

NEW BEDFORD, MASSACHUSETTS

NEW BEDFORI
REPARED LISCIOTTI DEVELOPMENT
OR: 83 ORCHARD HILL PARK DR
LEOMINSTER MA 01453

JUNE 7, 2019


SCALE: 1"=20'

JOB NO. 19-210

LATEST REVISION:

GRADING & DRAINAGE

SHEET 4 OF 10

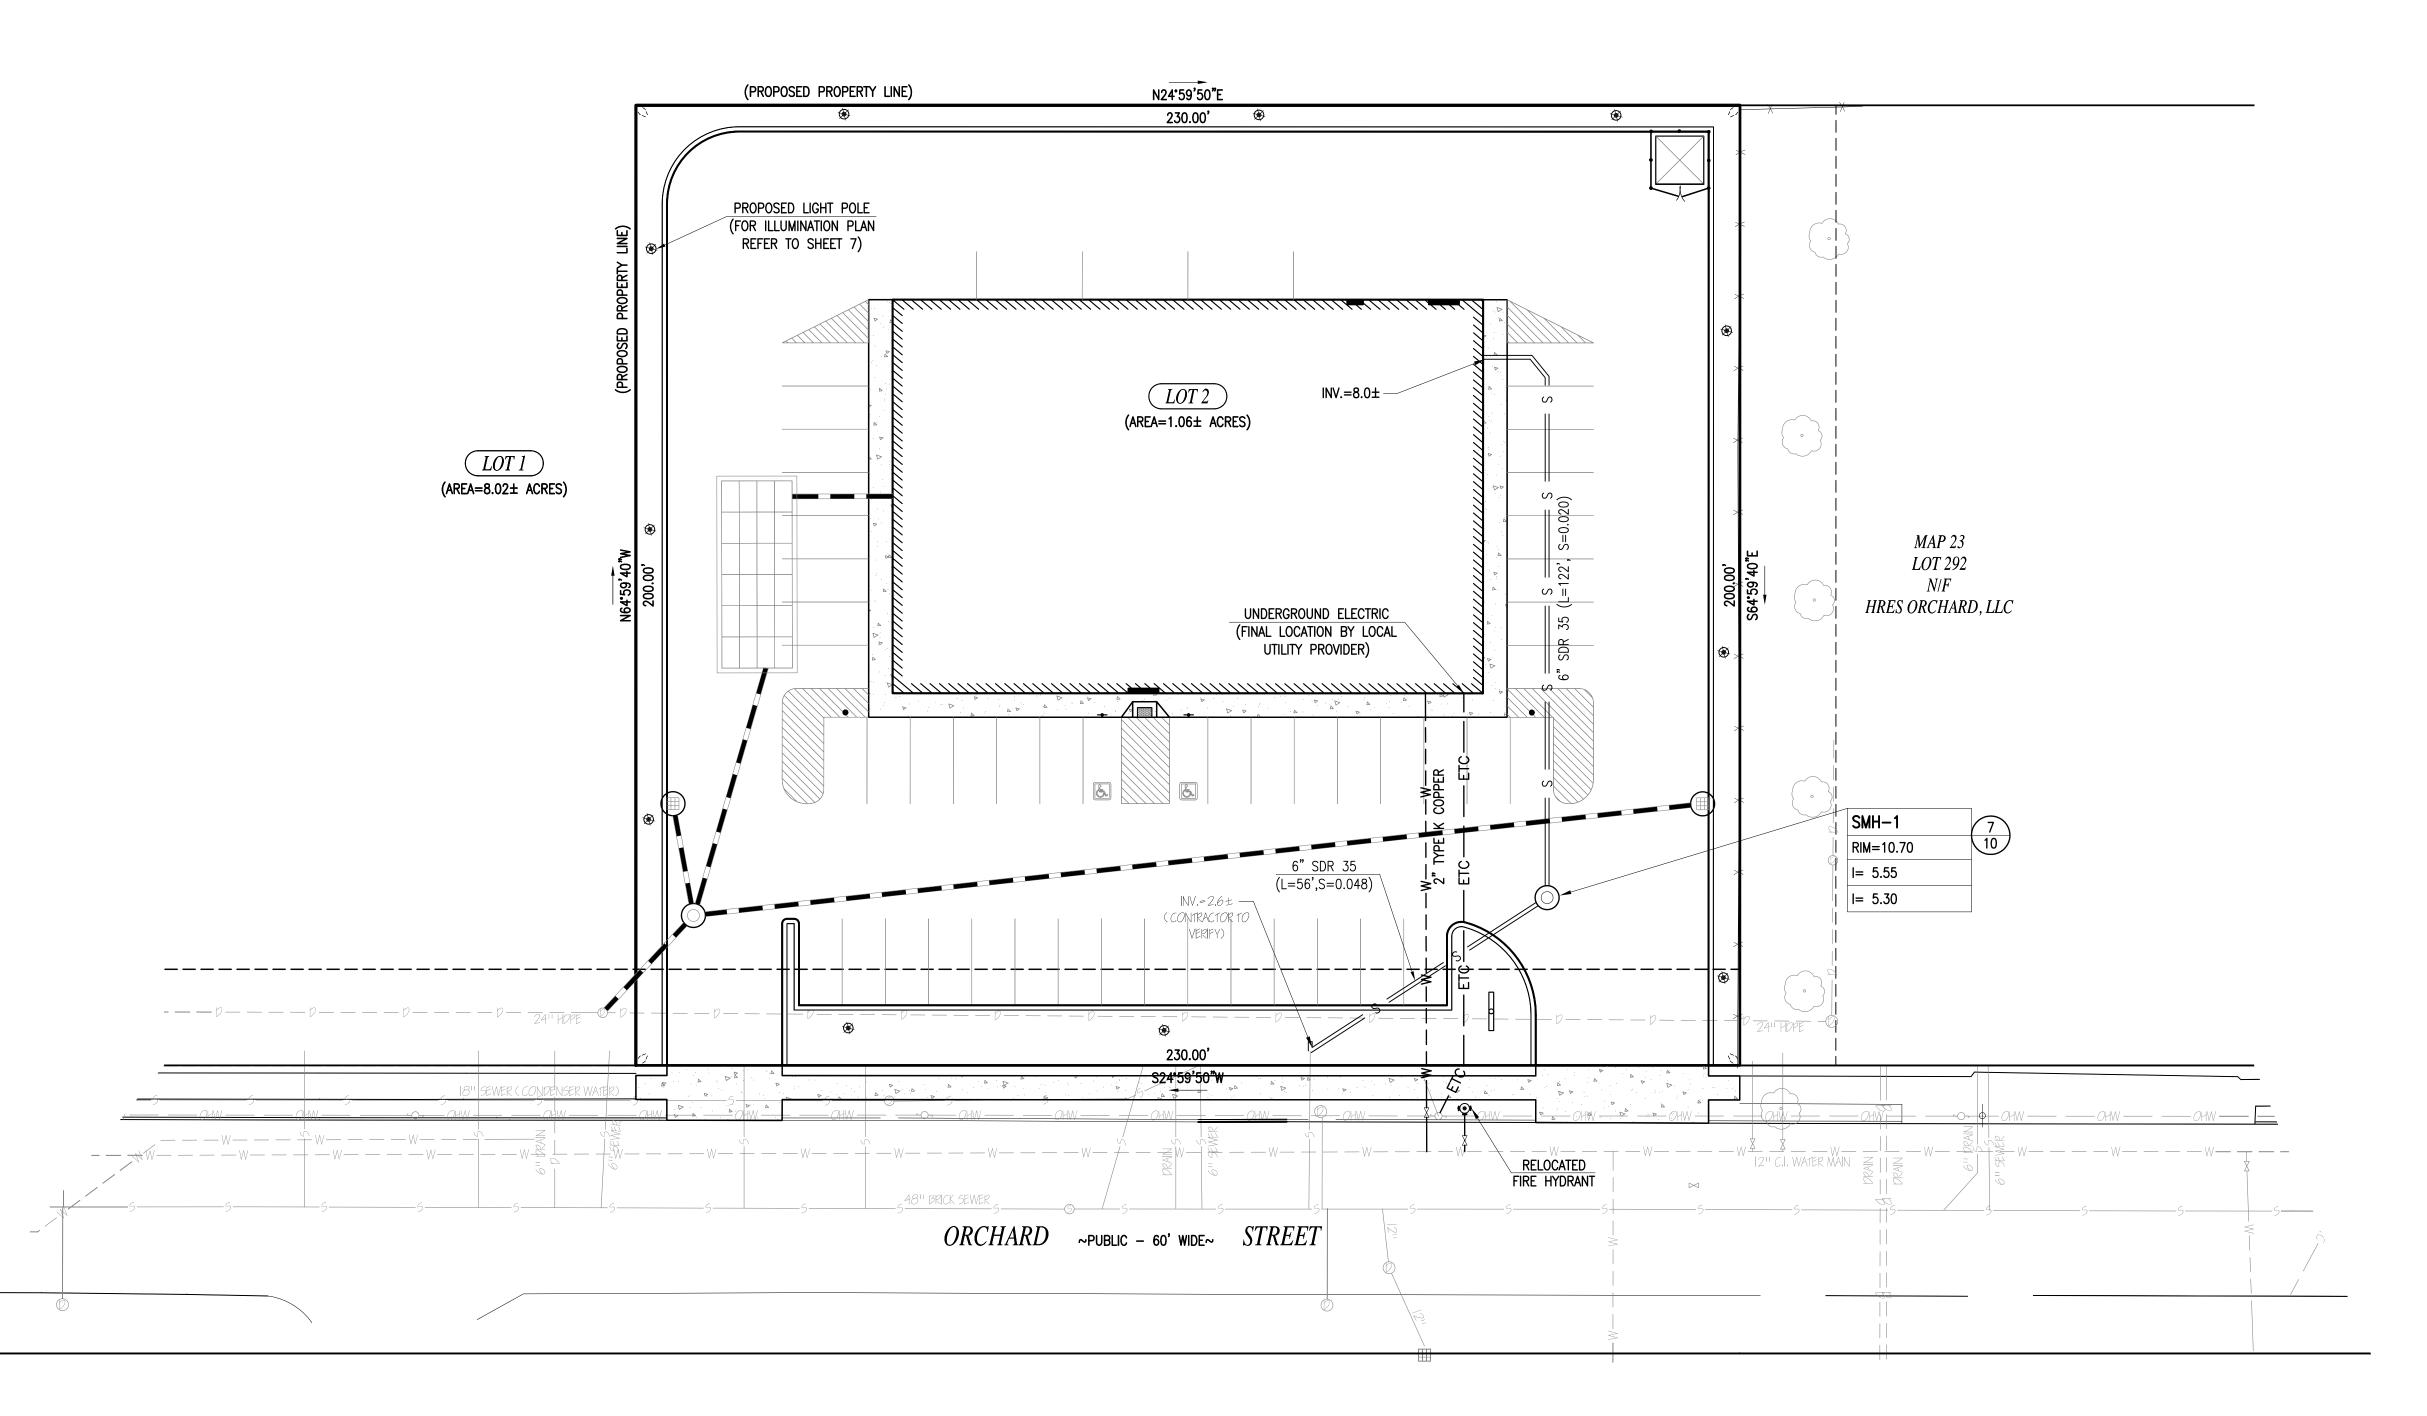

LISCIOTTIDEVELOPMENT





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2 ASSESSORS MAP 23 LOTS 158
NEW BEDFORD, MASSACHUSE


JUNE 7, 2019 SCALE: 1"=20' JOB NO. 19-210

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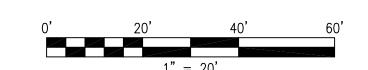
UTILITES SHEET 5 OF 10

LANDSCAPE TABLE				
SYMBOL	BOTANICAL NAME	COMMON NAME	SIZE	QUANTITY
		TREES		
	SYRINGA RETICULA	JAPANESE LILAC	5'-6' HT	6
	PICEA PUNGENS 'COLORADO GREEN'	BLUE SPRUCE	6'-8' HT	8
	CORNUS FLORIDA	WHITE DOGWOOD	12'-14' HT	6
SHRUBS				
	LLEX GLABRA 'SHAMROCK'	INKBERRY	2 GAL.	6
	HYDRANGEA MACROPHYLLA 'NIKKO BLUE'	NIKKO BLUE HYDRANGEA	2 GAL.	6
	ILEX OPACA	AMERICAN HOLLY	2 GAL.	6
**	MISCANTHUS SINENSIS	AUTUMN ANTHEM	2 GAL.	14



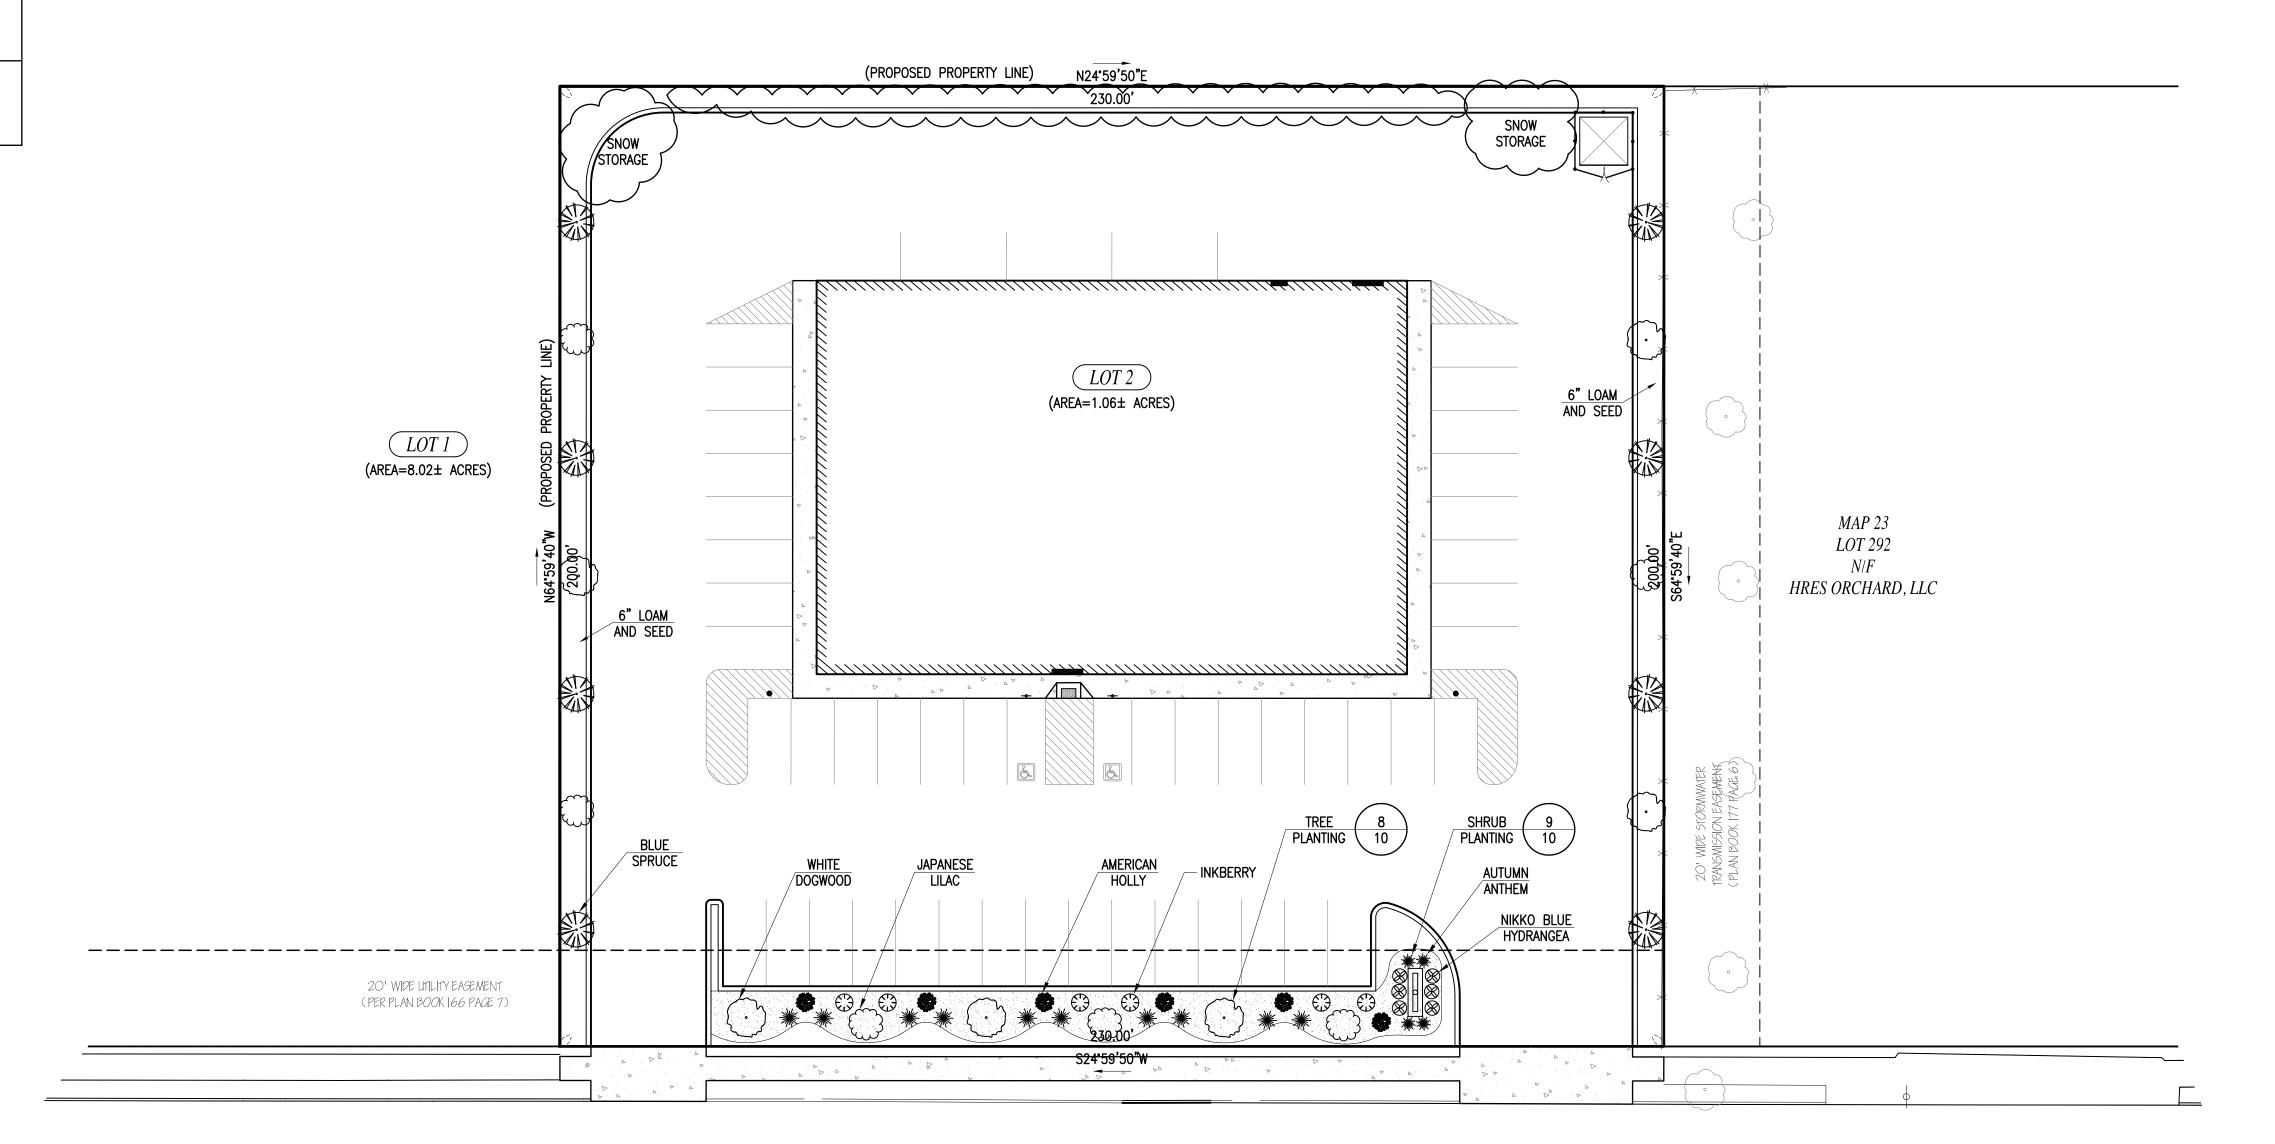

ORCHARD ~PUBLIC - 60' WIDE~ STREET



LISCIOTTIDEVELOPMENT





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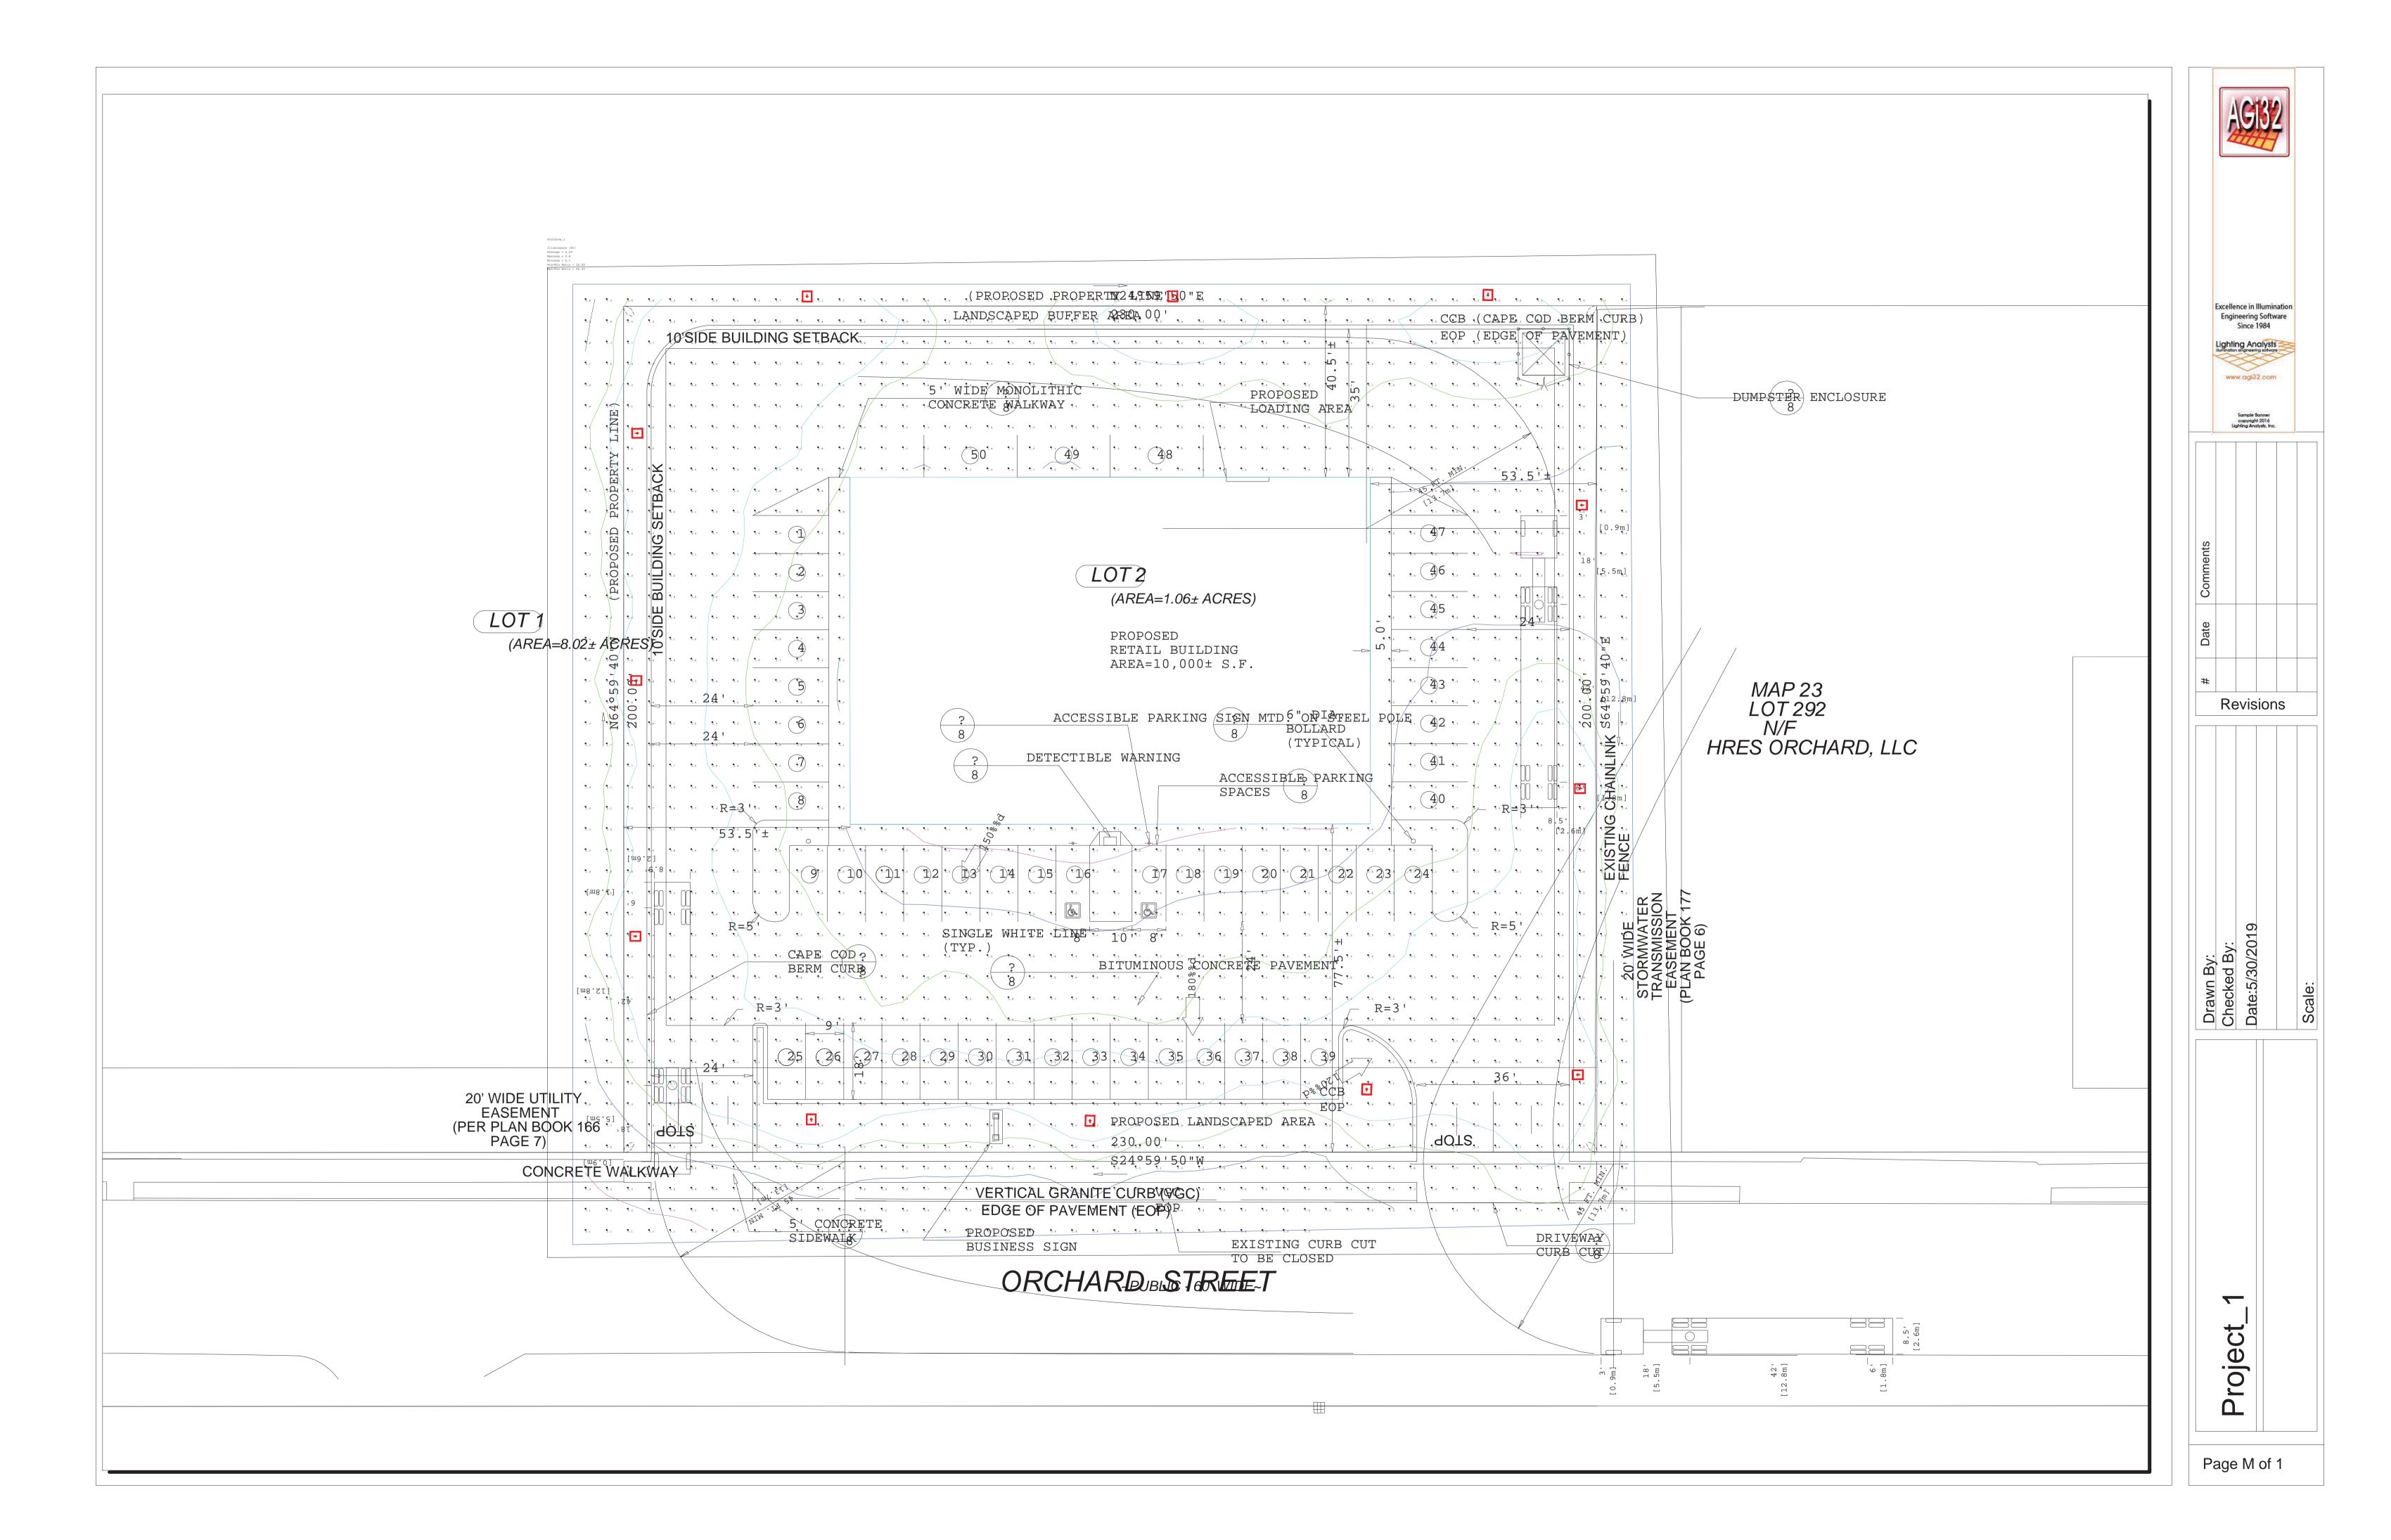
DESIGNED BY: MJW CHECKED BY: CAF

& 294 TTS

JUNE 7, 2019 SCALE: 1"=20' JOB NO. 19-210 LATEST REVISION:

LANDSCAPING

SHEET 6 OF 10



GENERAL CONSTRUCTION NOTES

- 1. THE CONTRACTOR IS SPECIFICALLY CAUTIONED THAT THE LOCATION AND/OR ELEVATION OF EXISTING UTILITIES AND STRUCTURES AS SHOWN ON THESE PLANS IS BASED ON RECORDS OF VARIOUS UTILITY COMPANIES AND WHERE POSSIBLE, MEASUREMENTS TAKEN IN THE FIELD. THIS INFORMATION IS NOT TO BE RELIED ON AS BEING EXACT OR COMPLETE. THE LOCATION OF ALL UNDERGROUND UTILITIES AND STRUCTURES SHALL BE VERIFIED IN THE FIELD BY THE CONTRACTOR PRIOR TO THE START OF CONSTRUCTION. THE CONTRACTOR MUST CONTACT THE APPROPRIATE UTILITY COMPANY, ANY GOVERNING PERMITTING AUTHORITY, AND "DIG SAFE" AT LEAST 72 HOURS PRIOR TO ANY EXCAVATION WORK TO REQUEST EXACT FIELD LOCATION OF UTILITIES INTERFERING WITH THE PROPOSED CONSTRUCTION AND APPROPRIATE REMEDIAL ACTION TAKEN BEFORE PROCEEDING WITH THE WORK. IT SHALL BE THE RESPONSIBILITY OF THE CONTRACTOR TO RELOCATE ALL EXISTING UTILITIES WHICH CONFLICT WITH THE PROPOSED IMPROVEMENTS SHOWN ON THE PLAN.
- TOPOGRAPHIC AND PROPERTY LINE SURVEY PERFORMED BY FARLAND CORP. IN APRIL OF 2019.
- VERTICAL ELEVATIONS REFER TO THE CITY OF NEW BEDFORD DATUM. 4. ALL CONSTRUCTION SHALL BE IN ACCORDANCE WITH ALL APPLICABLE STATE AND LOCAL STANDARDS AND
- 5. THE CONTRACTOR SHALL BE RESPONSIBLE FOR ESTABLISHING AND MAINTAINING ALL CONTROL POINTS AND BENCH MARKS NECESSARY FOR THE WORK.
- 6. ALL BENCHMARKS SHOWN ON THIS PLAN ARE TO BE CHECKED FOR CONSISTENCY BY THE CONTRACTOR. ANY DISCREPANCIES MUST BE RESOLVED BY THIS OFFICE PRIOR TO CONSTRUCTION.
- WHERE PROPOSED PAVEMENT AND WALKS ARE TO MEET EXISTING, THE CONTRACTOR SHALL SAWCUT A NEAT LINE AND MATCH GRADE. SEAL ALL JOINTS WITH HOT BITUMINOUS ASPHALT JOINT SEALER.
- 8. CURBING TO BE AS INDICATED ON THE PLANS.
- 9. ALL EXISTING TREES, SHRUBS AND GROUND COVER WHERE NATURAL GRADE IS TO BE RETAINED SHALL BE KEPT IN THEIR EXISTING STATE UNLESS REMOVAL IS REQUIRED FOR CONSTRUCTION PURPOSES.
- 10. ALL AREAS DISTURBED BY CONSTRUCTION AND NOT TO BE PAVED OR OTHERWISE TREATED AS NOTED ON PLAN SHALL BE TREATED WITH 4" OF LOAM, SEEDED AND HAY MULCHED FOR EROSION CONTROL.
- 11. SITE IMPROVEMENTS SHALL CONFORM TO A.D.A. SPECIFICATIONS.
- LIGHTING SHALL BE DIRECTED ON SITE AND AWAY FROM TRAFFIC INTERFERENCE. 13. TEST PITS AND/OR BORINGS WERE TAKEN FOR THE PURPOSE OF DESIGN AND SHOW CONDITIONS AT BORING POINTS ONLY. THEY DO NOT NECESSARILY SHOW THE NATURE OF ALL MATERIALS TO BE ENCOUNTERED DURING CONSTRUCTION.
- 14. THE CONTRACTOR SHALL PROTECT AND/OR CAP OFF ALL EXISTING ON-SITE UTILITY SERVICES ACCORDING TO THE LOCAL AUTHORITY'S SPECIFICATIONS. SERVICES SHALL BE CAPPED OFF WHERE SAME ENTER THE PERIMETER OF THE PROPERTY LINE.
- 15. CONTRACTOR SHALL THOROUGHLY FAMILIARIZE THEMSELVES WITH ALL CONSTRUCTION DOCUMENTS, SPECIFICATIONS AND SITE CONDITIONS PRIOR TO BIDDING AND PRIOR TO CONSTRUCTION.
- 16. ANY DISCREPANCIES BETWEEN DRAWINGS, SPECIFICATIONS AND SITE CONDITIONS SHALL BE REPORTED IMMEDIATELY TO THE OWNER'S REPRESENTATIVE FOR CLARIFICATION AND RESOLUTION PRIOR TO BIDDING OR CONSTRUCTION.
- 17. THESE PLANS ARE PERMITTING PLANS AND SHALL NOT TO BE USED FOR CONSTRUCTION. A FINAL SET OF STAMPED PLANS FOR CONSTRUCTION WILL BE ISSUED AFTER RECEIVING FINAL APPROVAL FROM THE LOCAL AND/OR STATE DEPARTMENTS.

CONSTRUCTION SEQUENCING NOTES

- CONSTRUCT TEMPORARY AND PERMANENT EROSION CONTROL FACILITIES. EROSION CONTROL FACILITIES SHALL BE INSTALLED PRIOR TO ANY EARTH MOVING.
- 2. TREE PROTECTION FENCE SHALL BE INSTALLED AND APPROVED BY THE OWNER REPRESENTATIVE PRIOR TO ANY FARTH MOVING
- 3. ALL PERMANENT DITCHES AND SWALES ARE TO BE STABILIZED WITH VEGETATION OR RIP RAP PRIOR TO DIRECTING RUNOFF TO THEM.
- 4. CLEAR CUT, DEMOLISH AND DISPOSE OF EXISTING SITE ELEMENTS NOT TO REMAIN.
- 5. STORMWATER SHALL NOT BE DIRECTED TOWARDS THE INFILTRATION BASINS UNTIL THE ENTIRE CONTRIBUTING DRAINAGE AREA HAS BEEN STABILIZED.
- 6. GRADE AND GRAVEL ALL PAVED AREAS. ALL PROPOSED PAVED AREAS SHALL BE STABILIZED IMMEDIATELY AFTER GRADING.
- 7. BEGIN ALL PERMANENT AND TEMPORARY SEEDING AND MULCHING. ALL CUT AND FILL SLOPES SHALL BE SEEDED AND MULCHED IMMEDIATELY AFTER THEIR CONSTRUCTION.
- 8. DAILY, OR AS REQUIRED, CONSTRUCT TEMPORARY BERMS, DRAINS, DITCHES, SILT FENCES AND MULCH AND SEED AS REQUIRED.
- 9. FINISH PAVING ALL HARD SURFACE AREAS.
- 10. INSPECT AND MAINTAIN ALL EROSION AND SEDIMENT CONTROL MEASURES.
- 11. COMPLETE PERMANENT SEEDING AND LANDSCAPING. 12. REMOVE TEMPORARY EROSION CONTROL MEASURES.
- 13. THE CONSTRUCTION SEQUENCE SHALL BE CONFINED TO THE LIMIT OF WORK AS SHOWN ON THE DRAWINGS
- 14. UPON COMPLETION OF CONSTRUCTION THE OWNER SHALL AGREE TO MAINTAIN AND CLEAN ALL DRAINAGE STRUCTURES AS REQUIRED.

SITE PREPARATION NOTES

- WITHIN THE LIMIT OF WORK LINE AS NOTED ON THE SITE PLANS, REMOVE AND DISCARD ALL CONCRETE PAVEMENT, BITUMINOUS CONCRETE PAVEMENT, BRICK PAVEMENT, TOP SOIL, MULCH, TRASH, DEAD TREES AND STUMPS, SHRUBBERY, CHAIN LINK FENCE POSTS, RAILS, FABRIC, GATES, FOOTINGS AND ALL APPURTENANCES, BOLLARDS, POSTS, CONCRETE FOOTINGS AND FOUNDATIONS, WALLS AND CURBS UNLESS
- 2. THE OWNER'S REPRESENTATIVE SHALL BE CONSULTED AND WILL REVIEW THE WORK ON SITE WITH THE CONTRACTOR BEFORE ANY WORK SHALL COMMENCE. THE CONTRACTOR SHALL VERIFY ALL EXISTING CONDITIONS IN THE FIELD AND REPORT ANY DISCREPANCIES
- BETWEEN PLANS AND ACTUAL CONDITIONS TO THE OWNER'S REPRESENTATIVE PRIOR TO STARTING WORK. 4. THE CONTRACTOR IS RESPONSIBLE FOR ANY DAMAGE TO EXISTING CONDITIONS TO REMAIN THAT ARE DUE TO CONTRACTOR OPERATIONS.
- ALL ITEMS TO BE REMOVED THAT ARE NOT STOCKPILED FOR LATER REUSE ON THE PROJECT OR DELIVERED TO THE OWNER SHALL BE LEGALLY DISPOSED OF OFF SITE BY THE CONTRACTOR.
- 6. THE CONTRACTOR SHALL BE RESPONSIBLE FOR COORDINATING HIS EFFORTS OF THE DEMOLITION WITH ALL
- 7. THE CONTRACTOR SHALL COORDINATE ALL ADJUSTMENT OR ABANDONMENT OF UTILITIES WITH THE RESPECTIVE UTILITY COMPANY.
- THE CONTRACTOR SHALL MAINTAIN OR ADJUST TO NEW FINISH GRADES AS NECESSARY ALL UTILITY AND
 - SITE STRUCTURES SUCH AS LIGHT POLES, SIGN POLES, MANHOLES, CATCH BASINS, HAND HOLES, WATER AND GAS GATES, HYDRANTS, ETC., FROM MAINTAINED UTILITY AND SITE SYSTEMS UNLESS OTHERWISE NOTED OR DIRECTED BY THE OWNER'S REPRESENTATIVE.

<u>LAYOUT AND MATERIAL NOTES</u>

- CONTRACTOR SHALL THOROUGHLY FAMILIARIZE THEMSELVES WITH ALL CONSTRUCTION DOCUMENTS. SPECIFICATIONS AND SITE CONDITIONS PRIOR TO BIDDING AND PRIOR TO CONSTRUCTION. ANY DISCREPANCIES BETWEEN DRAWINGS, SPECIFICATIONS AND SITE CONDITIONS SHALL BE REPORTED
- IMMEDIATELY TO THE OWNER'S REPRESENTATTIVE FOR CLARIFICATION AND RESOLUTION PRIOR TO BIDDING OR CONSTRUCTION. SEE ARCHITECTURAL DRAWINGS FOR EXACT BUILDING DIMENSIONS AND ALL DETAILS CONTIGUOUS TO THE

BUILDING INCLUDING SIDEWALKS, RAMPS, UTILITY ENTRANCE LOCATIONS, WALL PACKS, CONCRETE DOOR

- PADS. ROOF DRAINS, ETC. ACCESSIBLE CURB RAMPS SHALL BE PER THE MASSACHUSETTS ARCHITECTURAL ACCESS BOARD AND THE
- AMERICANS WITH DISABILITIES ACT ACCESSIBLITY GUIDELINES, WHICHER IS MORE STRINGENT. THE FOLLOWING LAYOUT CRITERIA SHALL CONTROL UNLESS OTHERWISE NOTED ON THE PLAN:
- ALL DIMENSIONS ARE TO OUTSIDE FACE OF BUILDING. ALL DIMENSIONS ARE TO FACE OF CURB AT GUTTER LINE.
- ALL DIMENSIONS ARE TO CENTER OF PAVEMENT MARKINGS.
- ALL TIES TO PROPERTY LINES ARE PERPENDICULAR TO THE PROPERTY LINE UNLESS OTHERWISE NOTED.

UTILITY AND GRADING NOTES

- 1. ALL ON-SITE STORM DRAINAGE PIPES SHALL BE HIGH DENSITY POLYETHYLENE PIPE (HDPE) OR RCP, UNLESS NOTED OTHERWISE.
- HDPE PIPE SHALL CONFORM WITH AASHTO DESIGNATIONS M294 AND M252, SHALL BE MANUFACTURED WITH HIGH DENSITY POLYETHYLENE PLASTIC AND SHALL BE ADS N-12 PIPE AS MANUFACTURED BY

ADVANCE DRAINAGE SYSTEM, INC. OR HANCOR HI Q PIPE AS MANUFACTURED BY HANCOR, INC. OR

- APPROVED EQUAL UNLESS OTHERWISE NOTED OR DETAILED. 3. A MINIMUM OF 18" VERTICAL CLEARANCE SHALL BE MAINTAINED WHERE WATER SERVICES CROSS STORM
- DRAIN LINES. 4. ALL SERVICE CONNECTIONS SHALL BE INSTALLED TO A POINT OF 10 FEET FROM THE BUILDING WALL UNLESS OTHERWISE NOTED OR DETAILED.
- ALL WATER MAINS SHALL BE INSTALLED WITH A MINIMUM OF 5 FEET OF COVER AND A MAXIMUM OF 6 FEET OF COVER EXCEPT AS NOTED OR DETAILED OTHERWISE. GREATER DEPTHS ARE PERMITTED WHERE REQUIRED TO AVOID CONFLICTS WITH OTHER UTILITIES.
- 6. GENERALLY, WATER MAIN FITTINGS IDENTIFIED ON THIS DRAWING ARE SHOWN FOR INSTALLATION LOCATION PURPOSE. THE CONTRACTOR SHALL NOTE THAT NOT ALL FITTINGS ARE NOTED, SHOWN OR INDICATED.
- 7. ALL WATER MAIN FITTINGS, TEES, BENDS, HYDRANTS, ETC. SHALL BE RESTRAINED WITH CONCRETE THRUST BLOCKS.
- 8. ALL HYDRANTS SHALL BE INSTALLED WITH A 6" C.L.D.I. RUNOUT AND SHALL BE INSTALLED WITH APPROPRIATELY SIZED GATE VALVE, BOX, AND TEE FITTING. ALL HYDRANTS SHALL MEET LOCAL MUNICIPAL SPECIFICATION REQUIREMENTS AND SHALL BE INSTALLED IN ACCORDANCE WITH ALL LOCAL MUNICIPAL
- 9. DOMESTIC WATER SERVICES 2.5" AND SMALLER SHALL BE TYPE K COPPER TUBING AND SHALL BE INSTALLED WITH APPROPRIATELY SIZED CORPORATION STOP AND APPROVED SADDLE CURB STOP, AND BOX, USING MATERIALS SPECIFIED BY THE MUNICIPAL WATER DEPARTMENT OR COMPANY.
- 10. ALL WATER MAINS 3" AND LARGER SHALL BE CEMENT LINED DUCTILE IRON CLASS 52. AND SHALL BE
- INSTALLED WITH APPROPRIATELY SIZED FITTINGS AND GATE VALVES. 11. ALL WATER MAIN APPURTENANCES, MATERIALS, METHODS OF INSTALLATION AND TESTING REQUIREMENTS
- SHALL MEET OR EXCEED ALL LOCAL MUNICIPAL REQUIREMENTS. 12. PRESSURE AND LEAKAGE TEST, DISINFECTION AND FLUSHING SHALL BE IN ACCORDANCE WITH ALL LOCAL MUNICIPAL STANDARDS AND REQUIREMENTS. CONTRACTORS SHALL BE RESPONSIBLE FOR ALL COSTS IN
- CONNECTION WITH UTILITY TESTS, FLUSHING AND INSPECTIONS AS REQUIRED BY THE LOCAL MUNICIPALITY. 13. PRIMARY WATER METER AND BACKFLOW PREVENTER SHALL BE LOCATED AT THE POINT WHERE THE WATER
- LINE ENTERS THE BUILDING UNLESS OTHERWISE NOTED OR DETAILED ON THE DRAWINGS. 14. ALL GRAVITY SEWER PIPE SHALL BE PVC PER ASTM D3034, SDR-35 AND ASTM D1784 WITH RUBBER GASKET JOINTS.
- 15. WHERE SANITARY SEWERS CROSS WATER LINES, THE SEWER SHALL BE LAID AT SUCH AN ELEVATION THAT THE CROWN OF THE SEWER IS AT LEAST EIGHTEEN INCHES BELOW THE INVERT OF THE WATER MAIN. IF THE ELEVATION OF THE SEWER CANNOT BE VARIED TO MEET THIS REQUIREMENT. THE WATER MAIN SHALL BE RELOCATED TO PROVIDE THIS SEPARATION OR CONSTRUCTED WITH MECHANICAL JOINT PIPE FOR A DISTANCE OF TEN FEET ON EACH SIDE OF THE SEWER. ONE FULL LENGTH OF WATER MAIN SHALL BE CENTERED OVER THE SEWER SO THAT BOTH JOINTS WILL BE AS FAR AS THE SEWER AS POSSIBLE. IF MECHANICAL JOINT PIPE IS NOT USED THAN BOTH THE WATER MAIN AND SANITARY SEWER SHALL BE ENCASED IN CONCRETE FOR A MINIMUM DISTANCE OF 10 FEET FROM THE CROSSING POINT OF THE OTHER PIPE AS MEASURED NORMALLY FROM ALL POINTS ALONG THE PIPE.
- 16. DUE TO THE SMALL SCALE OF THE SITE WORK DRAWINGS, EXACT LOCATION OF UTILITY STUBS FOR BUILDING CONNECTIONS SHALL BE VERIFIED WITH THE BUILDING DRAWINGS. SERVICE STUBS TO THE BUILDING SHALL BE INSTALLED TO A POINT 10 FEET FROM THE BUILDING WALL UNLESS OTHERWISE NOTED OR DETAILED.
- 17. BEFORE THE DEVELOPMENT SITE IS GRADED, THE AREA OF THE DRAINAGE BASINS SHOULD BE FENCED OFF TO PREVENT HEAVY EQUIPMENT FROM COMPACTING THE UNDERLYING SOIL.
- 18. WHERE PROPOSED GRADES MEET EXISTING GRADES, CONTRACTOR SHALL BLEND GRADES TO PROVIDE A SMOOTH TRANSITION BETWEEN EXISTING AND NEW WORK. PONDING AT TRANSITION AREAS WILL NOT BE ALLOWED.
- 19. CONTRACTOR SHALL MAINTAIN POSITIVE DRAINAGE AWAY FROM ALL BUILDING FOUNDATIONS AND STRUCTURES.
- 20. MAXIMUM SLOPE IN DISTURBED AREAS SHALL NOT EXCEED 3:1, UNLESS OTHERWISE NOTED.
- 21. CONTRACTOR SHALL VERIFY EXISTING GRADES AND NOTIFY OWNER'S REPRESENTATIVE OF ANY
- 22. CONTRACTOR SHALL ADJUST UTILITY ELEMENT MEANT TO BE FLUSH WITH GRADE THAT IS AFFECTED BY SITE WORK OR GRADE CHANGES. WHETHER SPECIFICALLY NOTED ON PLANS OR NOT. 23. WHERE AN EXISTING UTILITY IS FOUND TO CONFLICT WITH THE PROPOSED WORK, THE LOCATION, ELEVATION
- AND SIZE OF THE UTILITY SHALL BE ACCURATELY DETERMINED WITHOUT DELAY BY THE CONTRACTOR, AND THE INFORMATION FURNISHED TO THE OWNER'S REPRESENTATIVE FOR RESOLUTION OF THE CONFLICT. 24. THE CONTRACTOR SHALL MAKE ALL ARRANGEMENTS FOR THE ALTERATION AND ADJUSTMENT OF ALL GAS,
- ELECTRIC, TELEPHONE AND ANY OTHER PRIVATE UTILITIES BY THE UTILITY COMPANIES. 25. ELECTRICAL DUCT BANK LOCATION IS SHOWN FOR COORDINATION PURPOSES, REFER TO ELECTRICAL PLANS FOR SECTIONS AND DETAILS OF THE UTILITY DUCT BANK.
- 26. THE LOCATION, SIZE, DEPTH AND SPECIFICATIONS FOR CONSTRUCTION OF PRIVATE UTILITY SERVICES SHALL BE INSTALLED ACCORDING TO THE REQUIREMENTS PROVIDED BY AND APPROVED BY THE RESPECTIVE UTILITY COMPANY (GAS, TELEPHONE AND ELECTRICAL). FINAL DESIGN AND LOCATIONS AT THE BUILDING WILL BE PROVIDED BY THE ARCHITECT. THE CONTRACTOR SHALL COORDINATE THE INSTALLATION OF THE UTILITY CONNECTIONS WITH THE RESPECTIVE COMPANIES PRIOR TO ANY UTILITY CONSTRUCTION.

GENERAL PLANTING NOTES

- 1. ALL PLANT MATERIAL SHALL CONFORM TO THE STANDARDS OF THE AMERICAN ASSOCIATION OF NURSERYMEN OR THE PLANT MATERIAL WILL BE UNACCEPTABLE. ALL PLANT MATERIAL SHALL BE TRUE TO SPECIES, VARIETY, SIZE AND BE CERTIFIED DISEASE AND INSECT FREE. THE OWNER AND/OR THE LANDSCAPE ARCHITECT RESERVES THE RIGHT TO APPROVE ALL PLANT MATERIAL ON SITE PRIOR TO
- ALL PLANT MATERIAL SHALL BE PROPERLY GUYED, STAKED, WRAPPED, AND PLANTED IN CONFORMANCE WITH THE TYPICAL PLANTING DETAILS. GUY WIRES SHALL BE ATTACHED TO THE TREE AT A HEIGHT OF TWO-THIRDS THE HEIGHT OF THE TREE AND SHOULD BE LOCATED AT POINTS SO AS NOT TO SPLIT THE TRUNK OF MULTI-STEMMED TREES. PROVIDE THREE STAKES PER TREE UNLESS NOTED OTHERWISE INSTALL ALL PLANT MATERIAL ON UNDISTURBED GRADE. PROVIDE BURLAP WRAPPING WITH A 50% OVERLAP. CUT AND REMOVE BURLAP FROM TOP ONE-THIRD OF THE ROOT BALL.
- PROVIDE PLANTING PITS AS INDICATED ON PLANTING DETAILS. BACKFILL PLANTING PITS WITH ONE PART EACH OF TOP SOIL, PEAT MOSS, AND PARENT MATERIAL. IF WET SOIL CONDITIONS EXIST THEN PLANTING PITS SHALL BE EXCAVATED AN ADDITIONAL 12" AND FILLED WITH SAND.
- 4. NEWLY INSTALLED PLANT MATERIAL SHALL BE WATERED AT THE TIME OF INSTALLATION AND SHALL BE SUBSEQUENTLY FLOODED TWICE WITHIN TWENTY-FOUR (24) HOURS OF PLANTING. REGULAR WATERING
- SHALL BE PROVIDED TO ENSURE THE ESTABLISHMENT, GROWTH AND SURVIVAL OF ALL PLANTS. 5. ALL PLANT MATERIAL SHALL BE GUARANTEED FOR ONE YEAR AFTER THE DATE OF FINAL ACCEPTANCE. ANY PLANT MATERIAL THAT DIES WITHIN THAT TIME PERIOD SHALL BE REMOVED, INCLUDING THE STUMP, AND REPLACED WITH MATERIAL OF SIMILAR SIZE AND SPECIES AT THE EXPENSE OF THE DEVELOPER. THE
- REPLACED PLANT MATERIAL SHALL BE GUARANTEED FOR ONE YEAR AFTER THE REPLACEMENT DATE. 6. THE LANDSCAPE CONTRACTOR SHALL PROVIDE A MINIMUM 4" LAYER OF TOPSOIL IN ALL LAWN AREAS AND A MINIMUM OF 6" OF TOPSOIL IN ALL PLANTING AREAS. A FULL SOIL ANALYSIS SHALL BE CONDUCTED
- AFTER CONSTRUCTION AND PRIOR TO PLANTING TO DETERMINE THE EXTENT OF SOIL AMENDMENT REQUIRED. ALL DISTURBED LAWN AREAS SHALL BE STABILIZED WITH EITHER SOD OR SEED AS INDICATED ON THE LANDSCAPE PLANS. SEED SHALL CONSIST OF THE MIXTURE LISTED IN THE GENERAL SEEDING NOTES. ALL DISTURBED LAWN AREAS SHALL BE TOP SOILED, LIMED, FERTILIZED, AND FINE GRADED PRIOR TO LAWN
- ALL PLANTING BEDS SHALL RECEIVE 3" OF SHREDDED PINE, CEDAR OR HEMLOCK BARK.
- 9. ALL SHRUB MASSES SHALL BE PLANTED IN CONTINUOUS MULCHED BEDS. 10. ALL TREES ARE TO BE GUYED, 3 EACH, UNLESS OTHERWISE NOTED ON PLAN.

CONTRACTOR.

- 11. ALL DECIDUOUS TREES ARE TO BE WRAPPED, WITH TREE WRAP, UP TO THE FIRST BRANCHING AND
- 12. THE LANDSCAPE CONTRACTOR IS TO PERFORM ALL CONTRACTED WORK IN A REASONABLE PERIOD OF CONTINUOUS WORK.
- 13. THE LANDSCAPE CONTRACTOR IS TO MAINTAIN PLANT MATERIAL WHILE THE PROJECT IS UNDERWAY AND FOR A PERIOD OF TWO WEEKS AFTER THE COMPLETION OF THE PROJECT UNLESS OTHERWISE SPECIFIED. 14. THE CONTRACTOR IS TO CLEAN UP AND REMOVE ANY DEBRIS FROM THE SITE, CAUSED BY THE LANDSCAPE


SOIL EROSION AND SEDIMENT CONTROL NOTES


- 1. SOIL EROSION AND SEDIMENT CONTROL PRACTICES IN THE PLAN SHALL BE CONSTRUCTED IN ACCORDANCE WITH THE PLANS AND SPECIFICATIONS.
- 2. ALL APPLICABLE SOIL EROSION AND SEDIMENT CONTROL PRACTICES SHALL BE IN PLACE PRIOR TO ANY

4. ALL SOIL EROSION AND SEDIMENT CONTROL STRUCTURES SHALL BE INSPECTED AND MAINTAINED ON A

- DEMOLITION GRADING OPERATIONS AND/OR INSTALLATION OF PROPOSED STRUCTURES OR UTILITIES. ALL APPLICABLE SOIL EROSION AND SEDIMENT CONTROL PRACTICES SHALL BE LEFT IN PLACE UNTIL
- CONSTRUCTION IS COMPLETED AND/OR THE AREA IS STABILIZED.
- REGULAR BASIS AND AFTER EVERY STORM EVENT. 5. THE MAINTENANCE OF SOIL EROSION AND SEDIMENT CONTROL MEASURES AND FACILITIES DURING AND IMMEDIATELY AFTER CONSTRUCTION RESTS WITH THE GENERAL CONTRACTOR. UPON ACCEPTANCE OF THE
- PROJECT, THE OWNER SHALL BECOME RESPONSIBLE FOR MAINTENANCE OF ANY REMAINING MEASURES AND FACILITIES. 6. OFF SITE SEDIMENT DISTURBANCE MAY REQUIRE ADDITIONAL CONTROL MEASURES TO BE DETERMINED BY
- THE ENGINEER. 7. ADJOINING PROPERTIES SHALL BE PROTECTED FROM EXCAVATION AND FILLING OPERATIONS AT ALL TIMES. 8. THE CONTRACTOR SHALL UTILIZE ALL METHODS NECESSARY TO PREVENT BLOWING AND MOVEMENT OF DUST FROM THE EXPOSED SOIL SURFACES.
- 9. PAVED ROADWAYS MUST BE KEPT CLEAN AT ALL TIMES. 10. A CRUSHED STONE TIRE CLEANING PAD WILL BE INSTALLED WHEREVER A CONSTRUCTION ENTRANCE EXISTS. SEE LOCATION DETAIL ON PLAN.
- 11. ALL CATCH BASIN INLETS SHALL BE PROTECTED DURING CONSTRUCTION AS DETAILED ON THE PLAN, IF APPLICABLE.
- 12. ALL STORM DRAINAGE OUTLETS SHALL BE PROTECTED AS REQUIRED HEREON BEFORE DISCHARGE POINTS BECOME OPERATIONAL.
- 13. THE SITE SHALL AT ALL TIMES BE GRADED AND MAINTAINED SUCH THAT ALL STORMWATER RUNOFF IS DIVERTED TO SOIL EROSION AND SEDIMENT CONTROL FACILITIES.
- 14. LAND AREAS EXPOSED AT ANY ONE TIME AND THE LENGTH OF EXPOSURE SHALL BE KEPT TO A PRACTICAL MINIMUM. THEY SHALL BE LEFT IN A NEAT AND FINISHED APPEARANCE AND PROTECTED FROM EROSION. 15. ANY DISTURBED AREA THAT WILL BE LEFT EXPOSED FOR MORE THAN SIXTY (60) DAYS AND NOT SUBJECT
- TO CONSTRUCTION TRAFFIC SHALL IMMEDIATELY RECEIVE A TEMPORARY SEEDING AND FERTILIZATION. IF THE SEASON PROHIBITS TEMPORARY SEEDING, THE DISTRIBUTED AREAS SHALL BE MULCHED. 16. ALL CRITICAL AREAS SUBJECT TO EROSION SHALL RECEIVE A TEMPORARY SEEDING AND BE MULCHED IN
- ACCORDANCE WITH THE SPECIFICATIONS IMMEDIATELY FOLLOWING ROUGH GRADING. 17. IMMEDIATELY AFTER COMPLETION OF STRIPPING AND STOCKPILING OF TOPSOIL. SEED THE STOCKPILE WITH ANNUAL RYE GRASS. STABILIZE TOPSOIL STOCKPILES WITH STRAW MULCH FOR PROTECTION IF THE SEASON DOES NOT PERMIT THE APPLICATION AND ESTABLISHMENT OF TEMPORARY SEEDING.
- 18. SOIL STOCKPILES ARE NOT TO BE LOCATED WITHIN FIFTY (50) FEET OF WETLANDS. THE FLOODPLAIN. SLOPE, ROADWAY OR DRAINAGE FACILITIES. THE BASE OF ALL STOCKPILES SHALL BE PROTECTED BY A HAY BALE BARRIER OR SEDIMENT FENCE. LOCATIONS ARE DELINEATED ON THE PLAN.
- 19. MAXIMUM SIDE SLOPES OF ALL EXPOSED SURFACES SHALL NOT BE CONSTRUCTED STEEPER THAN 3:1 UNLESS OTHERWISE APPROVED BY THE DISTRICT. 20. ALL AREAS NOT STABILIZED BY CONSTRUCTION, SODDING OR LANDSCAPING SHALL BE SEEDED AND
- STABILIZED IN ACCORDANCE WITH THE SEEDING AND MULCHING SPECIFICATIONS. 21. MULCHING IS REQUIRED ON ALL SEEDED AREAS TO INSURE AGAINST EROSION BEFORE GRASS IS
- ESTABLISHED TO PROMOTE EARLIER VEGETATIVE COVER. 22. ALL DEWATERING OPERATIONS MUST DISCHARGE DIRECTLY INTO A SEDIMENT FILTRATION DEVICE. THE

SEDIMENT FILTER MUST BE CAPABLE OF FILTERING THE SEDIMENT AND BE PLACED SO AS NOT TO CAUSE EROSION OF THE DOWNSTREAM AREA.

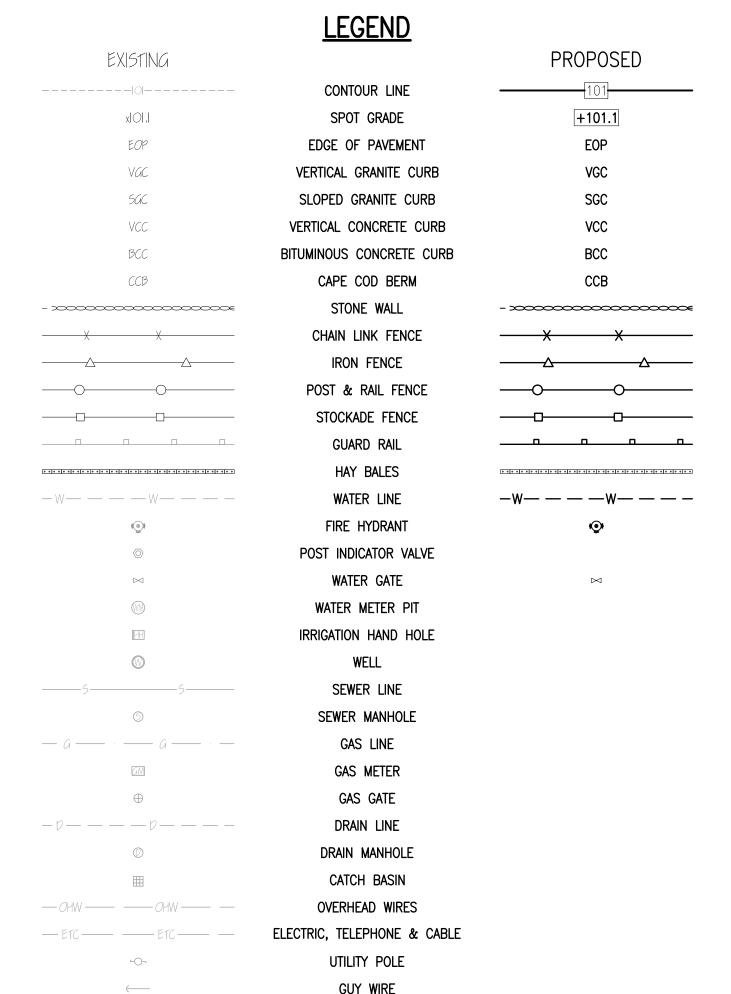


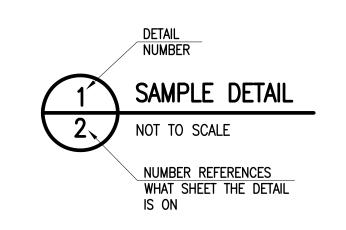


SOIL BORING LOGS

TH-1 ELEV.=11.58± 5/13/19	TH-2 ELEV.=12.77± 5/13/19	TH-3 ELEV.=12.46± 5/13/19	TH-4 ELEV.=11.52± 5/13/19
0"-2" A HORIZON TOPSOIL LOAM 11.41±	A HORIZON NONE	0"-2" A HORIZON TOPSOIL LOAM 12.29±	WE DEPTH TO THE PROPERTY OF TH
2"-48" B1 HORIZON MEDIUM FILL SAND W/ GRAVEL 7.58±	0"-60" B1 HORIZON DENSE FILL SAND W/ GRAVEL 7.77±	2"-18" B1 HORIZON MEDIUM FILL SILTY SAND W/ GRAVEL 10.96±	2"-84" B1 HORIZON MEDIUM FILL SILTY SAND W/ GRAVEL 4.52±
48"-108" B2 HORIZON LOOSE FILL SAND W/ GRAVEL 2.58±	60"-120" B2 HORIZON MEDIUM FILL SILTY SAND W/ GRAVEL 2.77±	18"-48" B2 HORIZON LOOSE FILL SAND 8.46±	B4"-180" B2 HORIZON DENSE FILL SAND W/ GRAVEL -3.48±
108"-156" B3 HORIZON DENSE FILL SAND W/ GRAVEL -1.42±	120"-156" B3 HORIZON DENSE FILL SAND W/ GRAVEL -0.23±	REFUSAL @ 48"	180"-204" C HORIZON SILTY SAND W/ GRAVEL -5.48±
STANDING © 120" ELEV.=1.46±	STANDING ② 132" ELEV.=1.77±		STANDING @ 112" ELEV.=2.19±

	001	. <u>-</u>	50111110	
TH-3 ELEV.=12.46± 5/13/19		[TH-4 ELEV.=11.52± 5/13/19	:
0"-2" A HORIZON TOPSOIL LOAM	الله ± 12.29		0"-2" A HORIZON TOPSOIL LOAM	11.35±
2"-18" B1 HORIZON MEDIUM FILL SILTY SAND W/ GRAVEL	±800VE AND REPLACE		2"-84" B1 HORIZON MEDIUM FILL SILTY SAND W/ GRAVEL	4.52±
18"-48" B2 HORIZON LOOSE FILL SAND	8.46±		84"-180" B2 HORIZON DENSE FILL SAND W/ GRAVEL	<u></u>
REFUSAL			180"-204" C HORIZON SILTY SAND W/ GRAVEL	
			STANDING @ 112" ELEV.=2.19±	

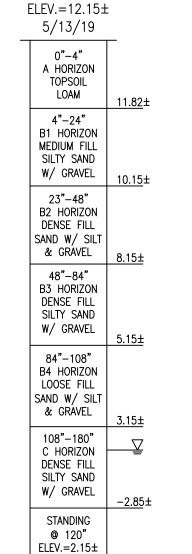

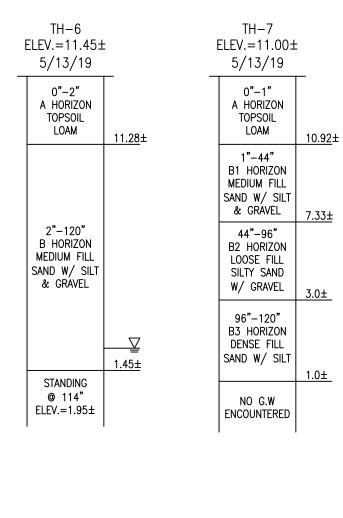

/ww.FarlandCorp.con 401 COUNTY STREET NEW BEDFORD, MA 02740 P.508.717.3479

REVISIONS

CHRISTIAN

No. 47544 CIVIL

OFFICES IN: TAUNTON MARLBOROUGH WARWICK, RI

DRAWN BY: MJW DESIGNED BY: MJW

CHECKED BY: CAF

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H ORC MAP FOR SS 0 S


JUNE 7, 2019 SCALE: AS NOTED JOB NO. 19-210


NOTES & LEGEND


SHEET 8 OF 10

LATEST REVISION:

LISCIOTTIDEVELOPMENT

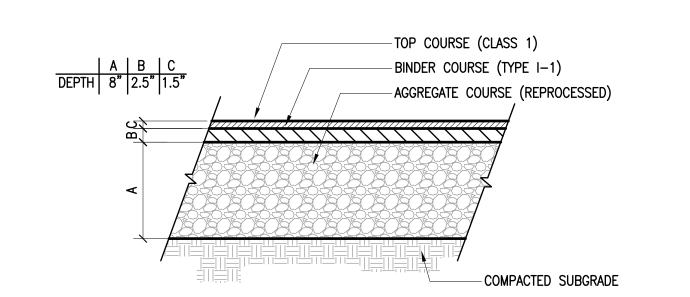

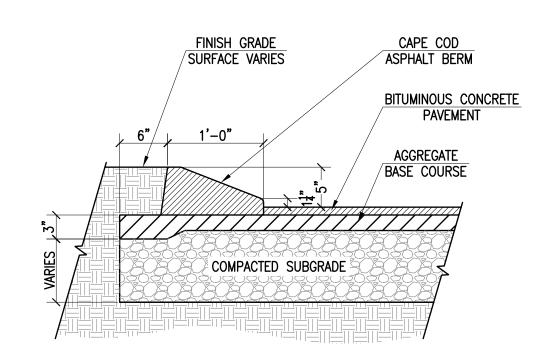


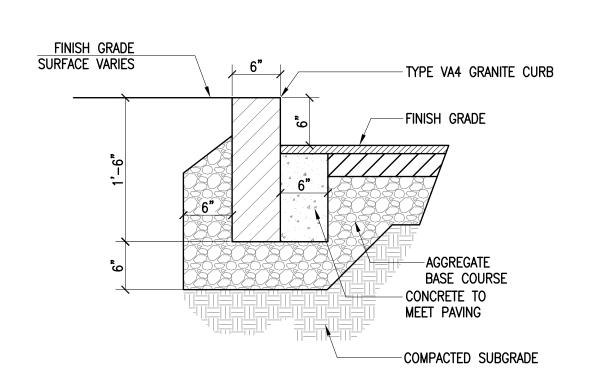

TRAFFIC SIGN ACCESSIBLE VAN PARKING

PRECAST CONCRETE

CURB STOP

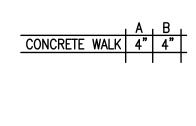


NOTE: UNLESS OTHERWISE NOTED ON PLANS, CONTRACTION JOINTS TO BE 5'-0" O.C. AND EXPANSION JOINTS TO BE 40'-0" O.C. MAX., OR AT BACK OF CURB, CHANGE OF DIRECTION, OTHER WALK, UTILITY APPURTENANCE, OR FACE OF STRUCTURE.

-BLUE PAINT

-WHITE PAINT

DETAIL NOTE:

GRID SQUARES ARE 2 1/4" RE: ANSI A117.1, FIG. 703.6.3.1

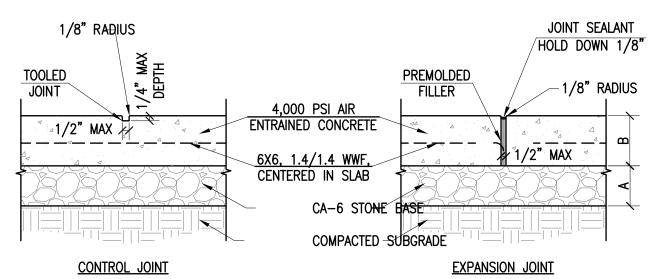



REVISIONS

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401 COUNTY STREET NEW BEDFORD, MA 02740 P.508.717.3479 OFFICES IN: TAUNTON MARLBOROUGH •WARWICK, RI

DRAWN BY: MJW DESIGNED BY: MJW

CHECKED BY: CAF

0 \sim SITE PLAN

WS ORCHARD STREET

SSESSORS MAP 23 LOTS 158 (
NEW BEDFORD, MASSACHUSEI

JUNE 7, 2019 SCALE: AS NOTED

JOB NO. 19-210 LATEST REVISION:

DETAILS

SHEET 9 OF 10

BITUMINOUS CONCRETE PAVEMENT

BITUMINIOUS CONCRETE CAPE COD BERM

VERTICAL GRANITE CURB

CONCRETE PAVEMENT SIDEWALK

PAINTED ISLAND 4" W/ WHITE

TRAFFIC PAINT TYP. 18" O.C.

BLEND GRADES AT REAR SIDEWALK -rear panel FRONT PANEL BOTTOM 6" VERTICAL CURB TRANSITIONAL CURB 24" DETECTABLE WARNING SURFACE NOTES:

1. RAMP CROSS SECTION TO BE THE SAME AS ADJACENT SIDEWALK, I.E. DEPTH OF SURFACE AND FOUNDATION. 2. DIMENSIONS ARE SUBJECT TO CHANGE IN FIELD. ALL SLOPES AND


DIMENSIONS TO COMPLY WITH ADA MAAB REQUIREMENTS. 3. PROVIDE EXPANSION JOINTS AT TOPS OF RAMP AND AT BACK OF WALK AT

INTERFACE OF CURB. 4. PROVIDE HEAVY BROOM FINISH ON RAMP AND SIDE SLOPES PERPENDICULAR

TO FLOW OF TRAFFIC. 5. MINIMUM WALK DIMENSIONS ARE FROM BACK OF CURB.


TRANSITION CURB LENGTH AS REQUIRED TO MEET CODE. 7. FIXED OBJECTS (I.E. UTILITY POLES, HYDRANTS, ETC.) MUST NOT ENCROACH

ON ANY PART OF A WHEELCHAIR RAMP, INCLUDING TRANSITION SLOPES. 8. AT NO TIME IS ANY PART OF THE WHEELCHAIR RAMP, EXCLUDING CURB TRANSITIONS, TO BE LOCATED OUTSIDE OF THE CROSSWALK.

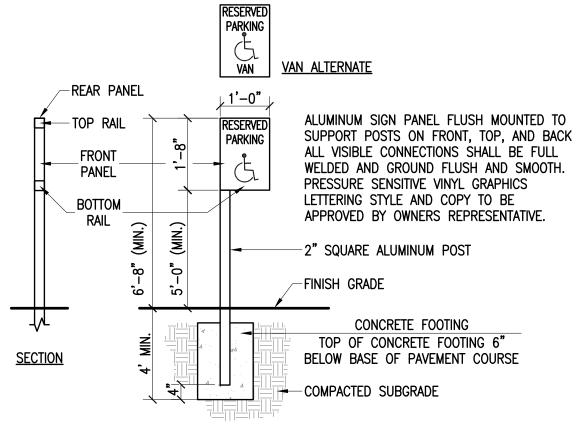

<u>PLAN VIEW</u>



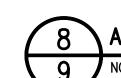

ACCESSIBLE PARKING SYMBOL

ACCESSIBLE RAMP TYPE B

NOT TO SCALE

NOT TO SCALE

CONCRETE FILL, 3000 PSI IN 28 DAYS, ROUND TOP W/ SMOOTH FINISH, PAINT SÁME AS PIPE 6" O.D. SCHEDULE 40 GALVANIZED STEEL PIPE PAINT AS SPECIFIED FINISH GRADE CONCRETE BASE 3,000 PSI IN 28 DAYS COMPACTED SUBGRADE

← PER PLAN 5' 0.C. 4 3' (TYP.) DUMPSTER

ACCESSIBLE PARKING SIGN

3" SQ. STEEL TUBING 6" DIA. BOLLARD 5"x5" TREATED (SEE DETAIL) CEDAR POSTS (TYP.) - (4) 5/8" ADJUSTABLE HINGES 6" CONCRETE SLAB w/6'x6' WIRE MESH (SEE PLAN) LOCKING GATE LATCH 5"x5" TREATED CEDAR 1-1/2" SQ. STEEL TUBING (SHOP WELD ALL JOINTS) POSTS 5' O.C. (TYP.) 12" DIA. x 4'-8" DEEP CONCRETE FOOTING DRILL HOLES IN CONCRETE W/POST SLEEVE (TYP.) TO LOCK GATES IN OPEN AND CLOSED POSITIONS. 6' HIGH BOARD-ON-BOARD FENCE (SEE DETAIL, COLOR 18" DIA. CONC. FOOTING (TYP.-2 PLACES) AS SPECIFIED BY OWNER) **ELEVATION VIEW**

DUMPSTER ENCLOSURE

CONCRETE FILLED STEEL BOLLARD


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(2) 36" LONG 3/8" STEEL RODS.

LISCIOTTIDEVELOPMENT




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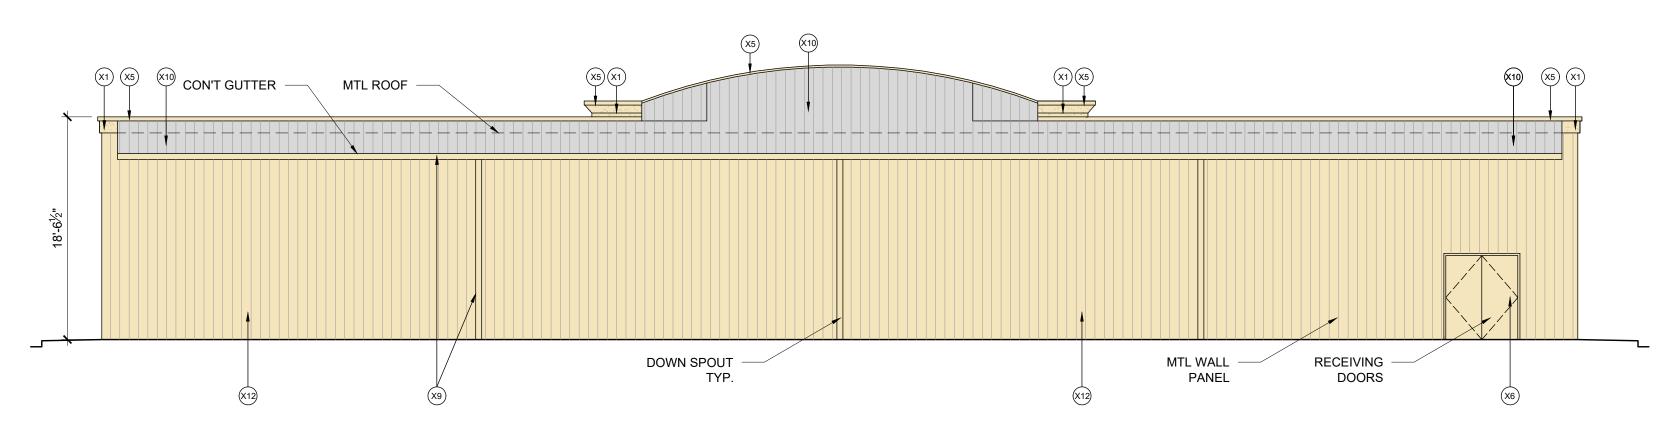
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DETAILS CONT.


SHEET 10 OF 10

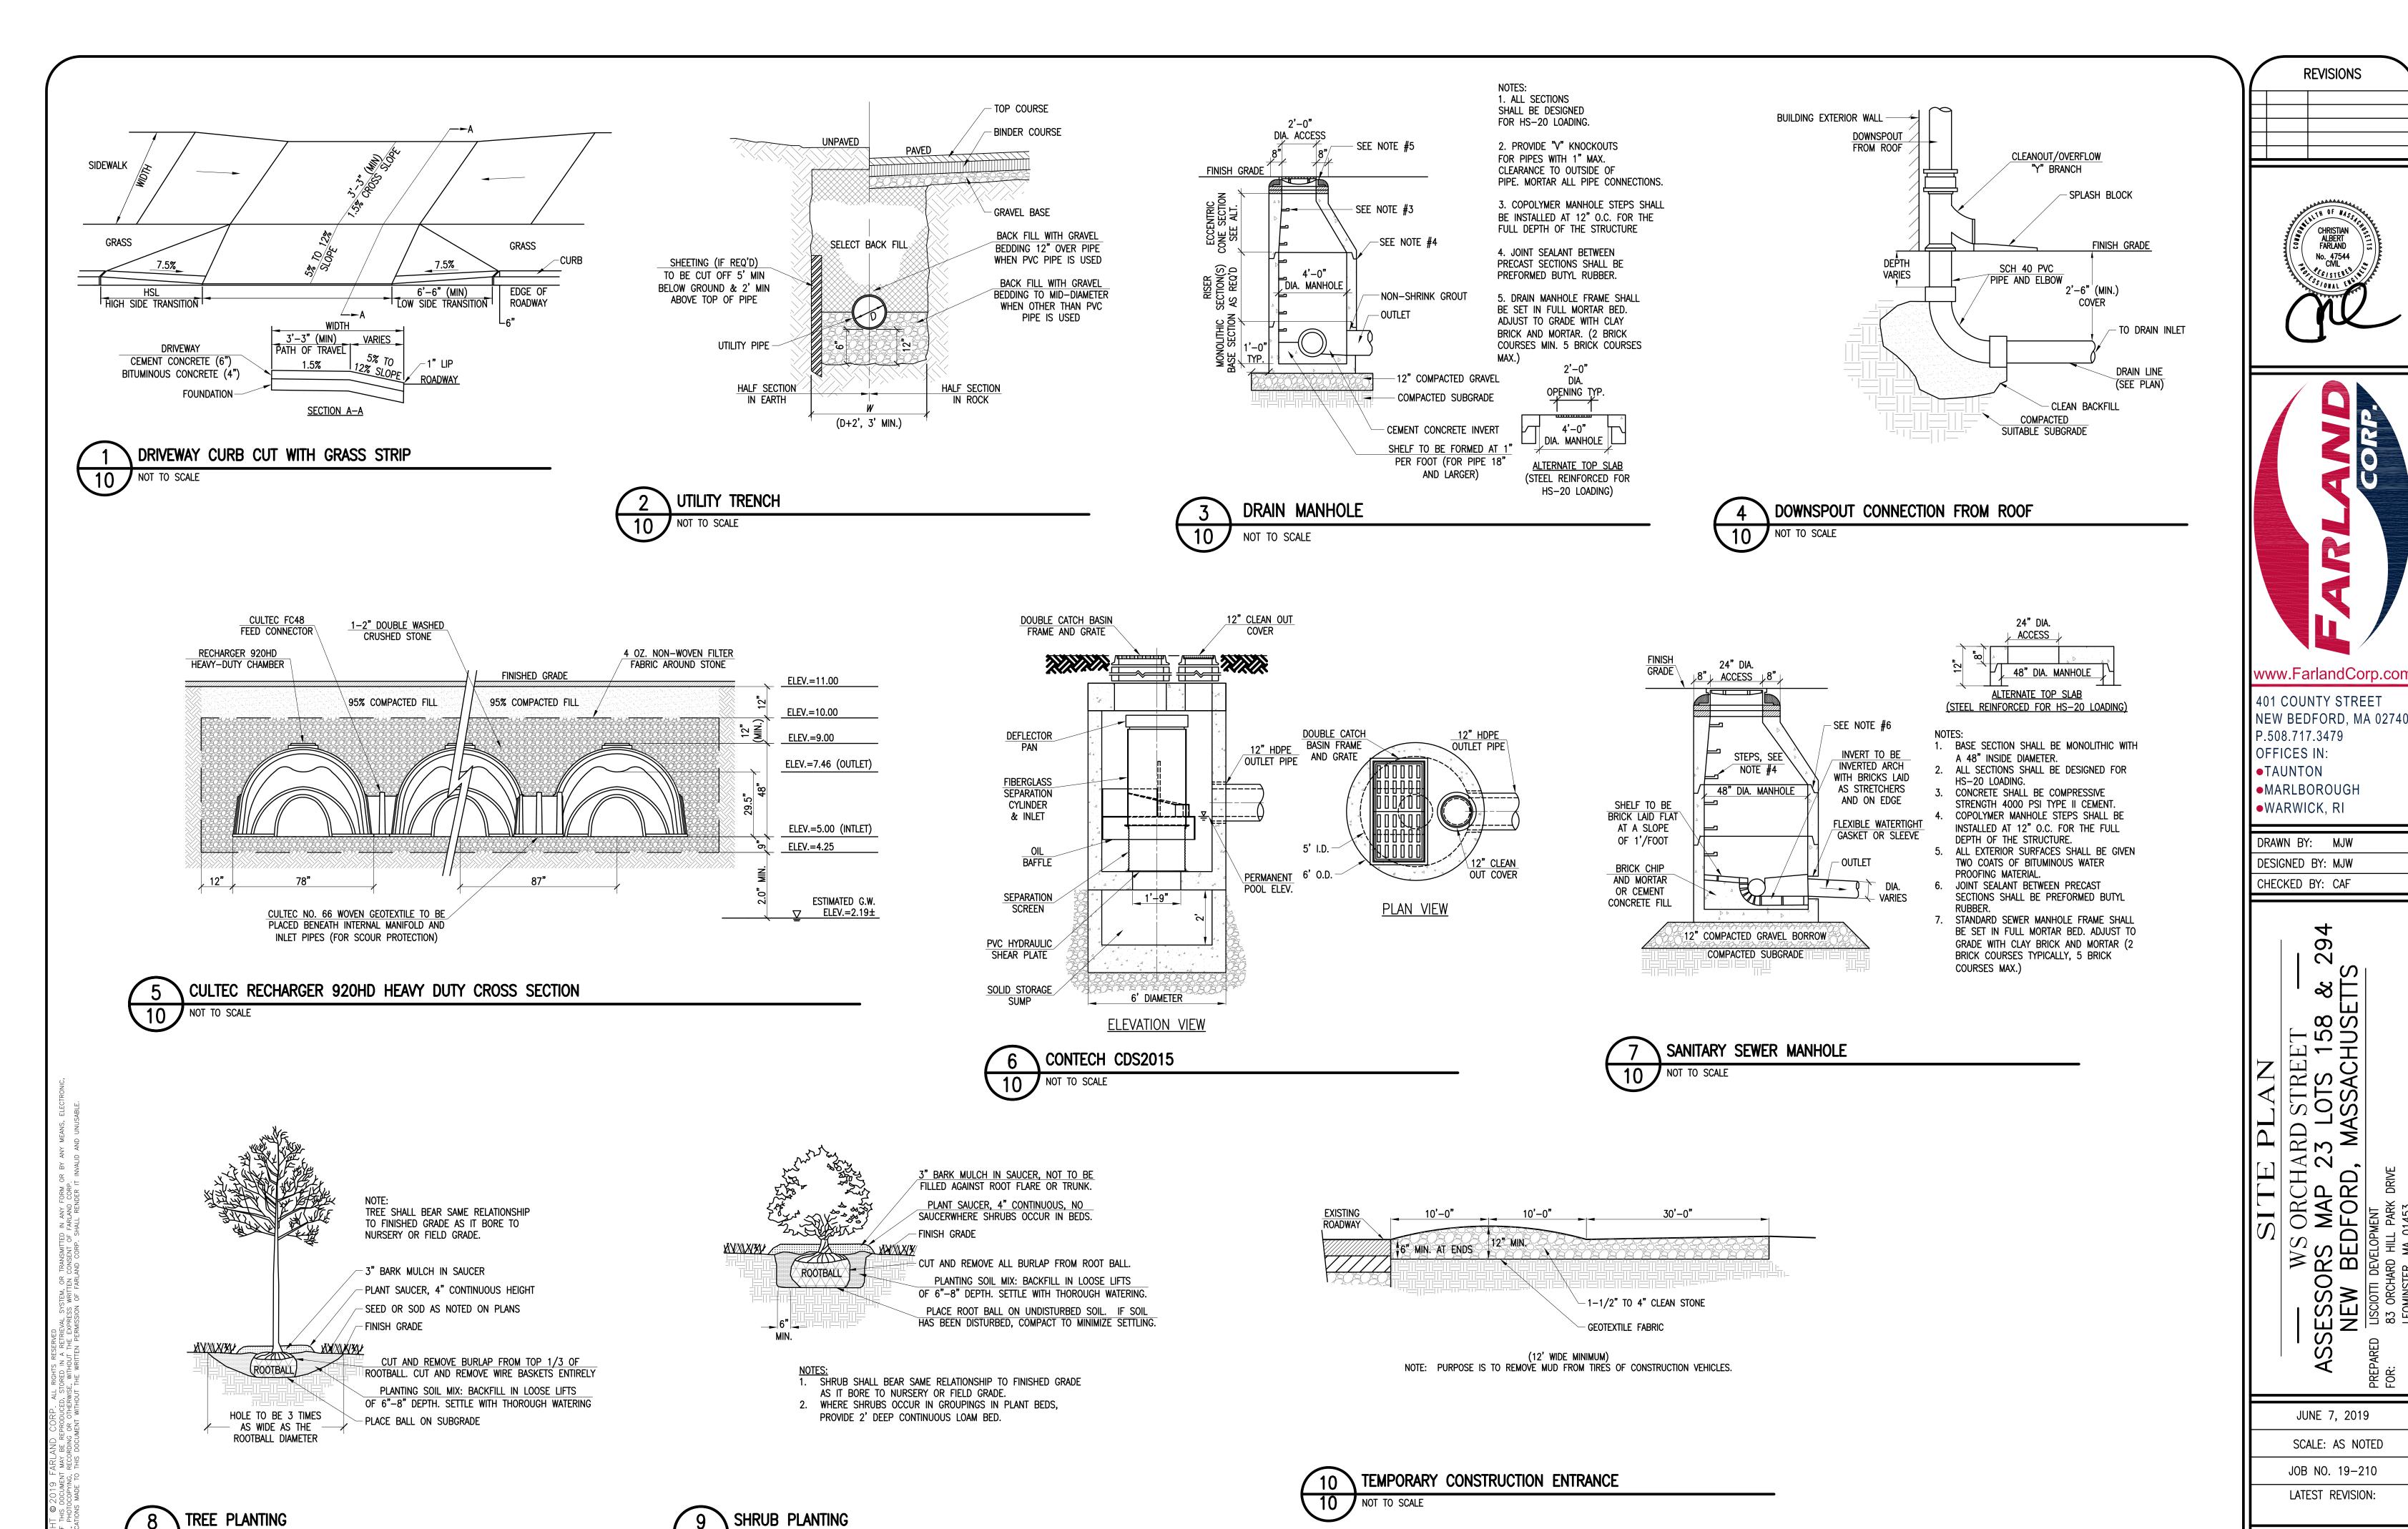


FRONT ELEVATION (ORCHARD ST) SCALE: 1/8"-1'-0"

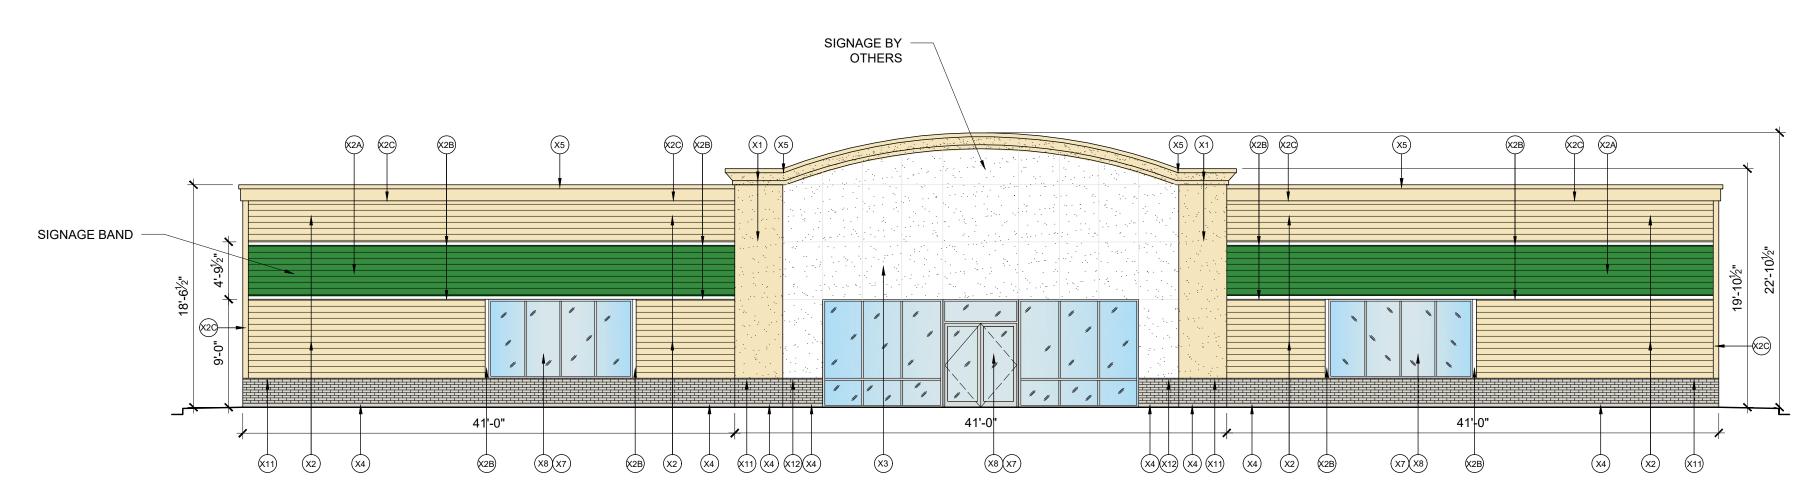

REAR ELEVATION SCALE: 1/8"-1'-0"

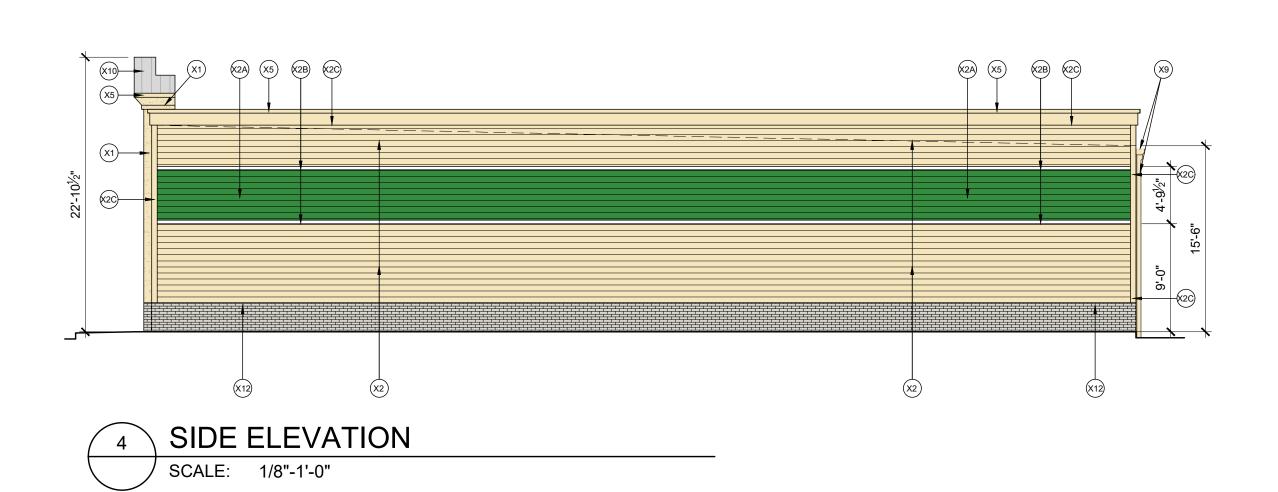

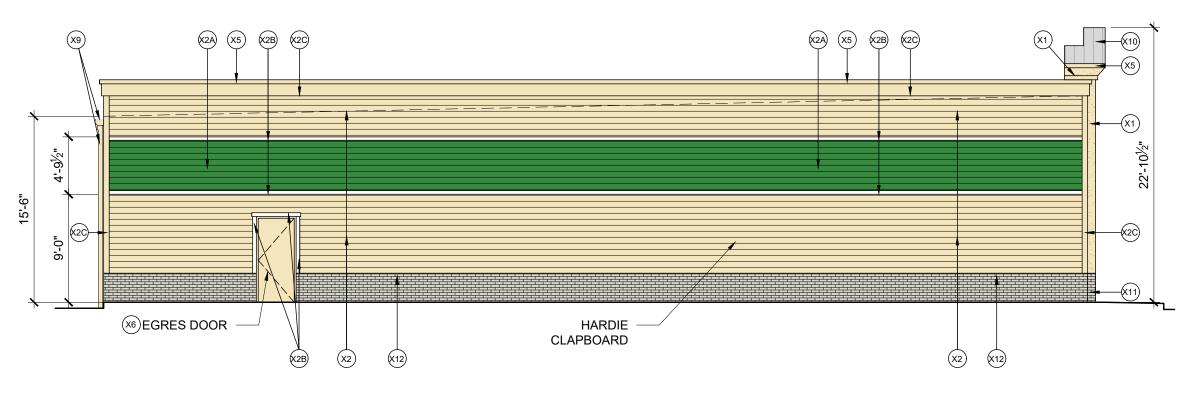



	EXTERIOR	FINISH SCHEDULE	
TAG	MATERIAL/ MFG.	COLOR/ NO.	NOTES
(X1)	EIFS CLADDING	COLOR: TO MATCH SW 6686 LIMON CHIFFON	PRE-FINISHED
(X2)	JAMES HARDIE CLAPBOARD	COLOR: TO MATCH JH SAILCLOTH	PRE-FINISHED
X2A	JAMES HARDIE CLAPBOARD	COLOR: SW 6925 ENVY	PAINTED
X2B	JAMES HARDIE TRIM BOARD	COLOR: JH WHITE PICKET FENCE	PRE-FINISHED
(X2C)	JAMES HARDIE TRIM BOARD	COLOR: TO MATCH JH SAILCLOTH	PRE-FINISHED
(X3)	EIFS CLADDING	COLOR: TO MATCH SW 7100 ARCADE WHITE	PRE-FINISHED
(X4)	METAL BASE FLASHING	COLOR: TO MATCH (X11)	PRE-FINISHED
(X5)	METAL COPING	COLOR: TO MATCH SW 6686 LIMON CHIFFON	PRE-FINISHED
(X6)	METAL DOORS & FRAMES	COLOR: TO MATCH SW 6686 LIMON CHIFFON	PAINTED
(X7)	METAL DOORS & FRAMES	COLOR: CLEAR ANODIZED	PREFINISHED
(X8)	INSULATED GLAZING	COLOR: CLEAR	TEMP WHERE REQUIRED
X9	GUTTERS & DOWNSPOUTS	COLOR: TO MATCH SW 6686 LIMON CHIFFON (CHIEF BUILDINGS -PARCHMENT)	PRE-FINISHED
X10)	METAL ROOF	COLOR: GALVALUME	PRE-FINISHED
X11)	NICHIHA CANYON BRICK PANEL	COLOR: SHALE BROWN	PRE-FINISHED
X12)	METAL PANEL	COLOR: TO MATCH SW 6686 LIMON CHIFFON (CHIEF BUILDINGS -PARCHMENT)	PRE-FINISHED

Conceptual Elevations





