

divelept
 454 N 600 W, SLC, UT 84116
 e: howdy@divelept.com
 p: 801-660-4485
 w: www.divelept.com



PLANNING BOARD SUBMITTAL SELF STORAGE FACILITY 8 WASHBURN ST. NEW BEDFORD, MASS.

NEBE

OWNER

LLC
 ATTN: DANIEL LYMAN
 101 S 200 E, STE. 200
 SALT LAKE CITY, UT 84111

ARCHITECT / APPLICANT

DIVELEPT DESIGN, LLC
 ATTN: JAROD HALL
 454 N 600 W
 SALT LAKE CITY, UT 84116
 801-660-4485

CIVIL ENGINEER


BRACKEN ENGINEERING
 ATTN: DON BRACKEN
 49 HERRING POND ROAD
 BUZZARDS BAY, MA
 508-833-0070

ZONING ANALYSIS

ZONE IB - Industrial B
 SITE 1.59 ACRES (69,260 SF)

	REQUIRED	PROPOSED
MINIMUM LOT SIZE	0 SF	69,226 SF
MINIMUM LOT FRONTAGE	0'	601 LF
MAXIMUM BUILDING HEIGHT	100'	21'
STORIES	7	1
FRONT YARD	25'	0' EXISTING
SIDE YARD	25'	0' EXISTING
REAR YARD	25'	0' EXISTING
MAXIMUM BLDG COVERAGE	50% (34,630 SF)	77.7% (63,790 SF)
MINIMUM LANDSCAPE AREA	20% (13,852 SF)	4.7% (3,225 SF)
PARKING SPACES		12 + 1 ACCESSIBLE

No. Date Description

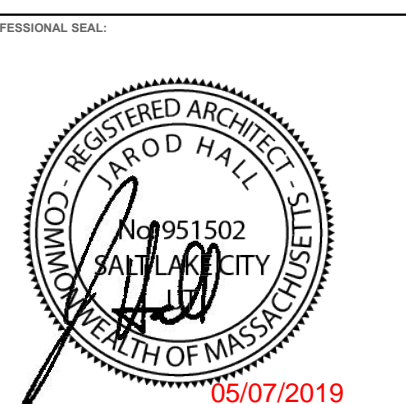


PROJECT ADDRESS: 8 WASHBURN
 NEW BEDFORD, MA 02740
 ARCHITECT: JDH
 DATE PUBLISHED: 07 MARCH 2019
 SHEET SCALE: 12" = 1'-0"

PLANNING
 COVER SHEET

G01

DIVELEPT DESIGN LLC © 2019

5/7/2019 10:22:08 PM

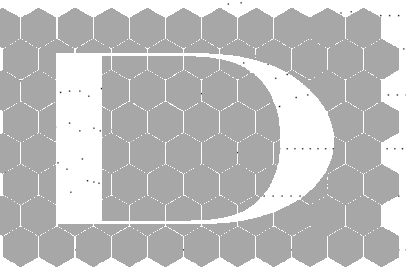


divelept


454 N 600 W, SLC, UT 84116
e: howdy@divelept.com
p: 801-660-4485
w: www.divelept.com




26 NORTH WEST - OVERALL

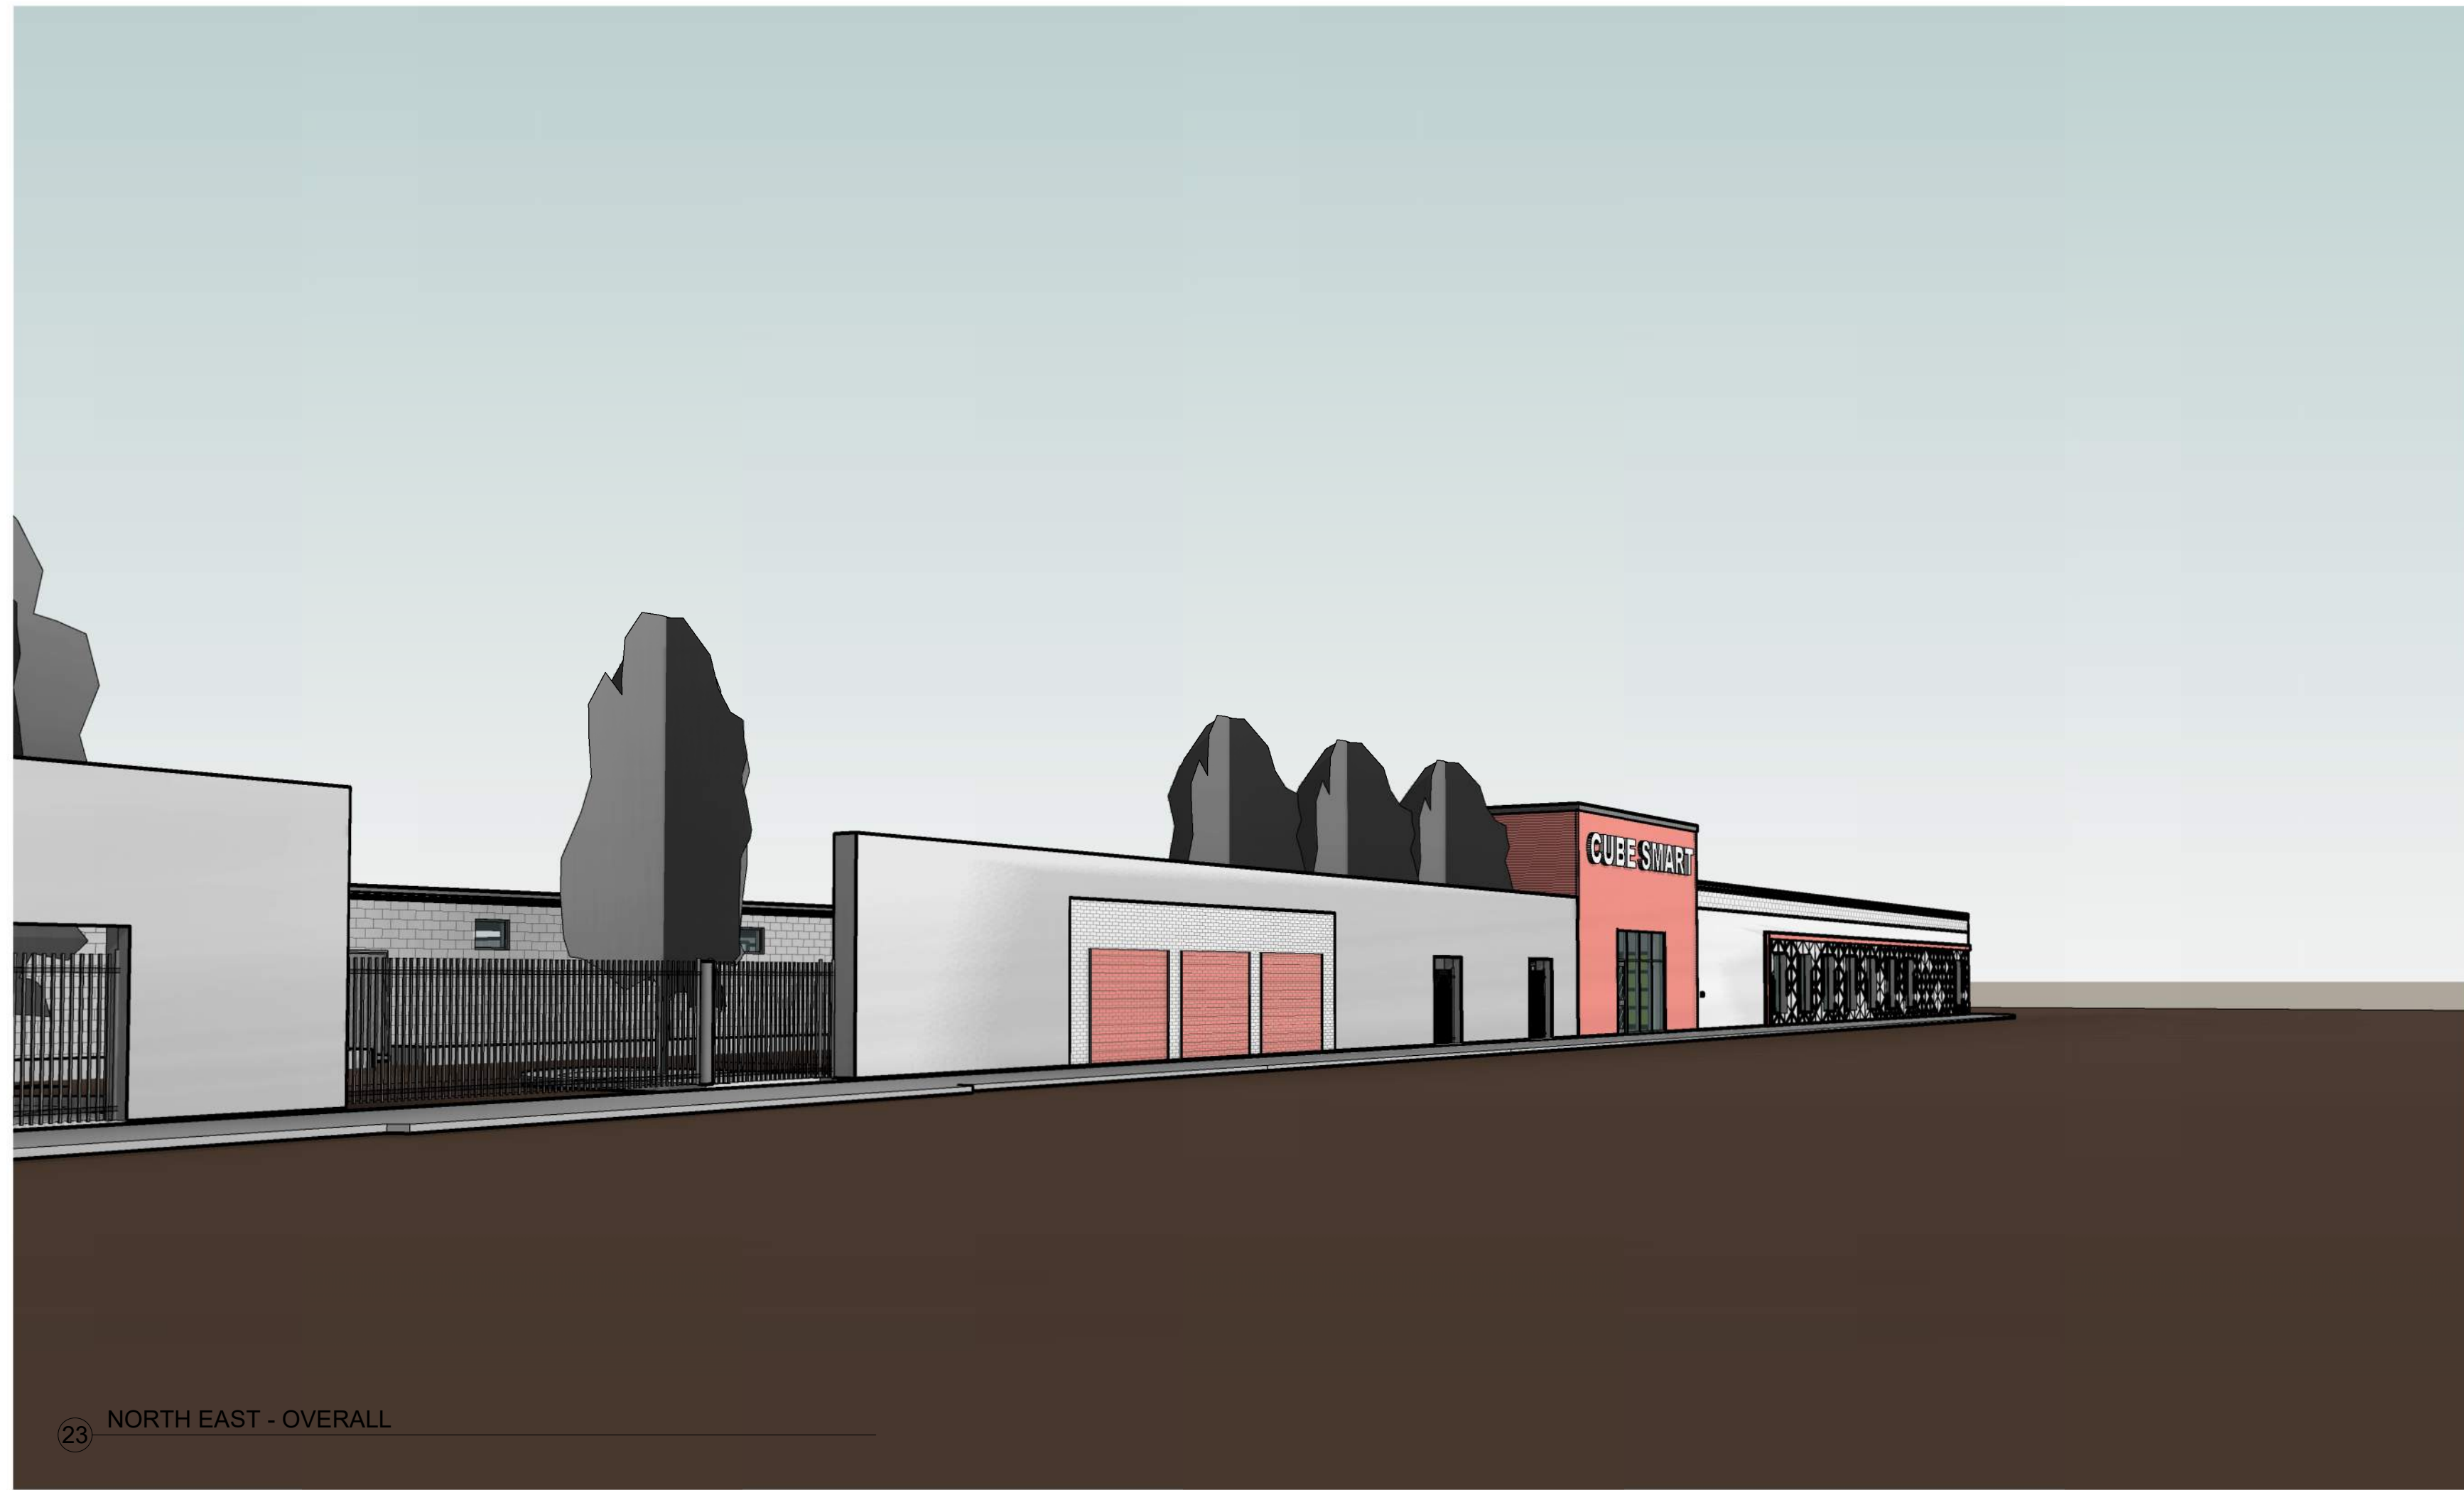

23 NORTH EAST - OVERALL

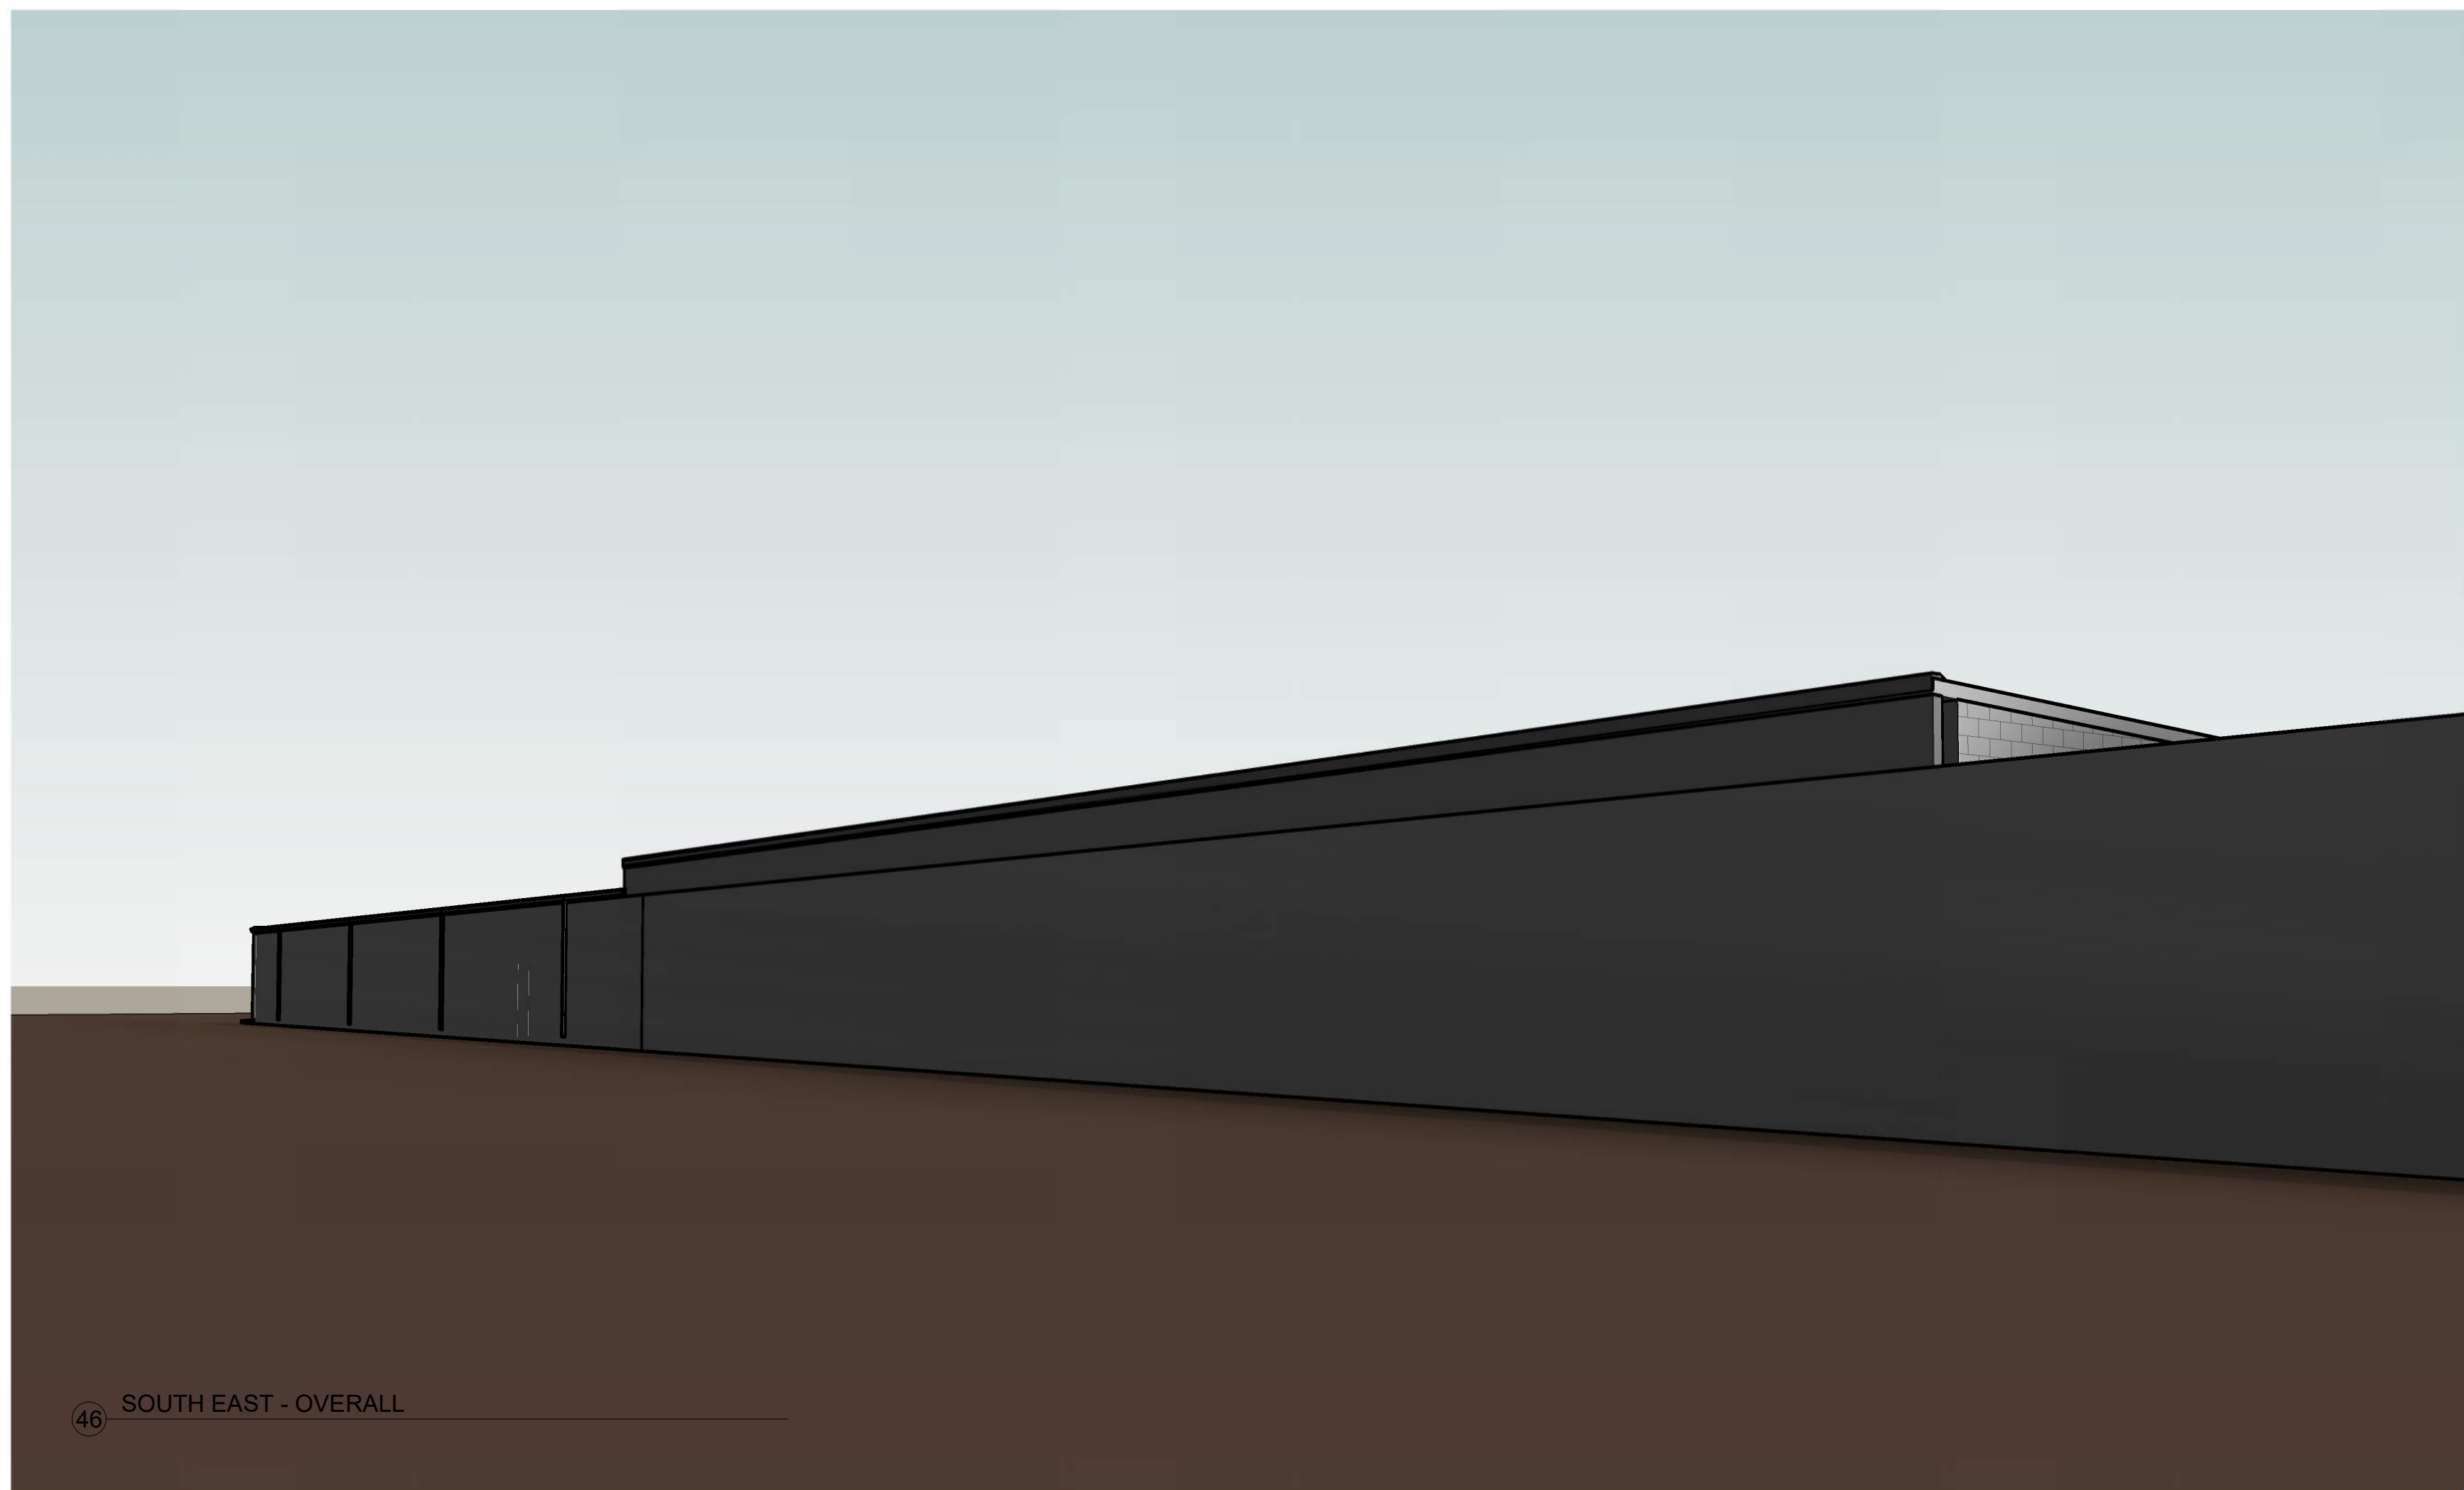


46 SOUTH EAST - OVERALL

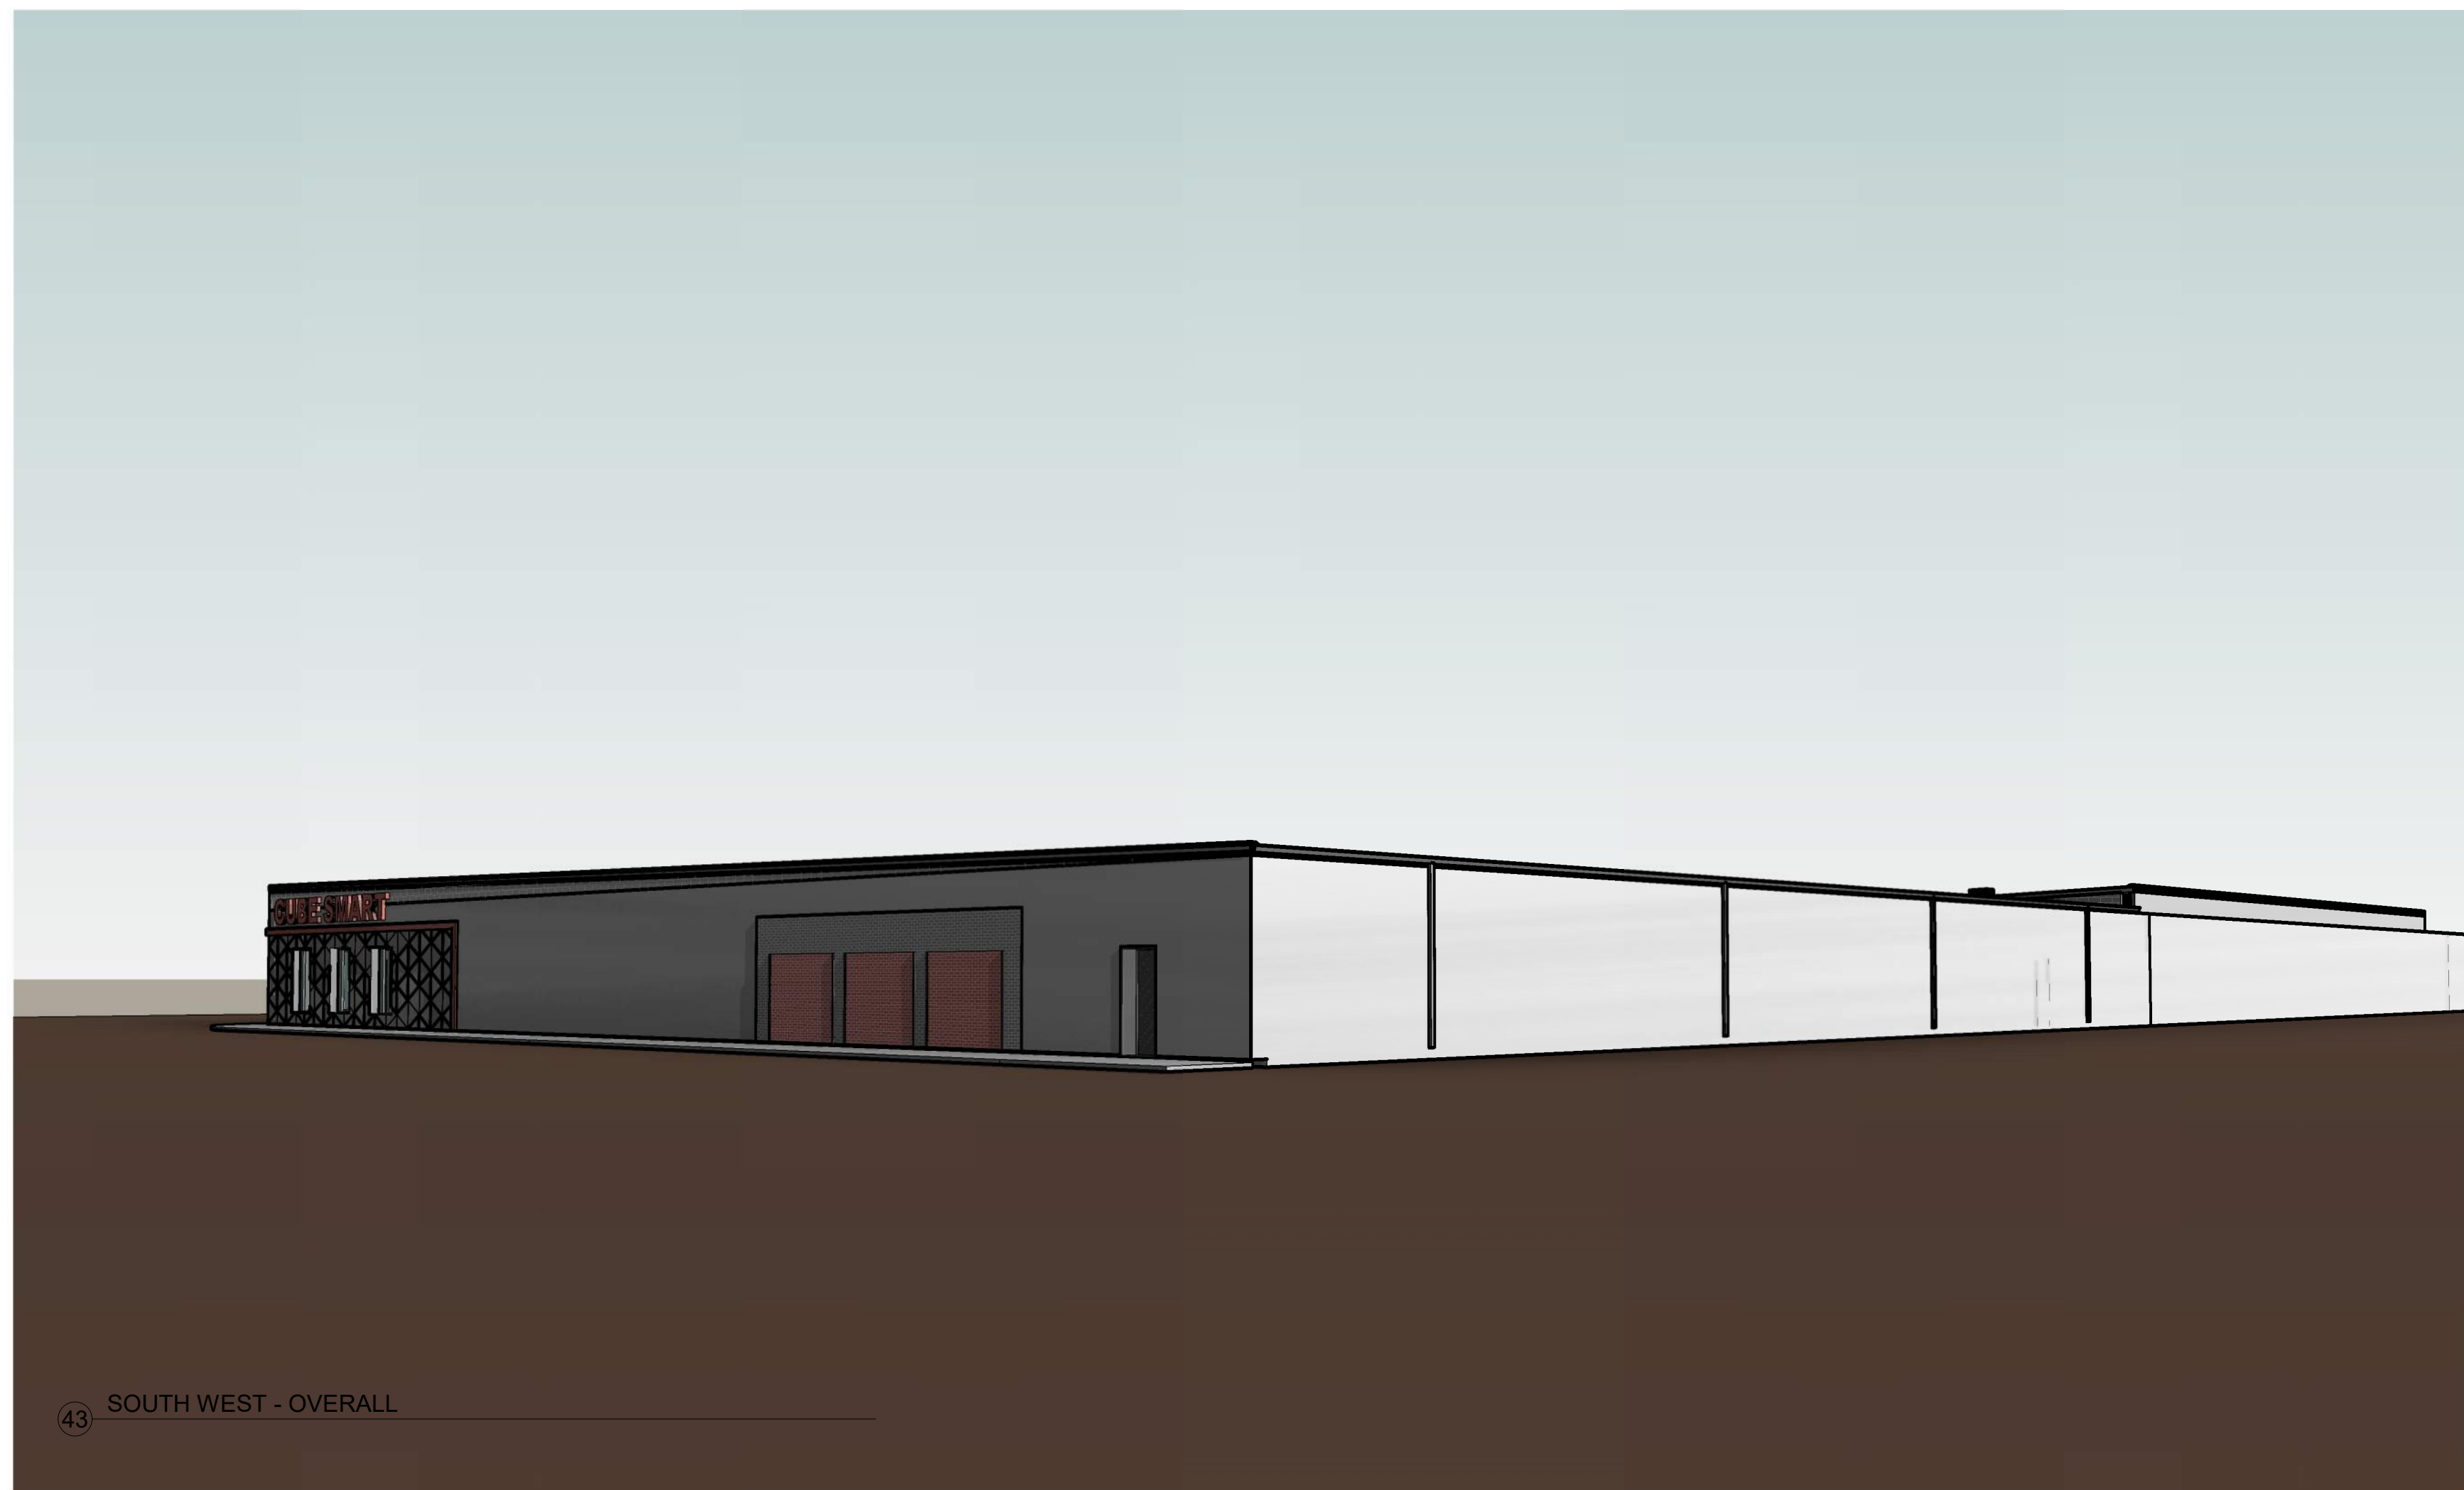

43 SOUTH WEST - OVERALL

NEBE


No. Date Description

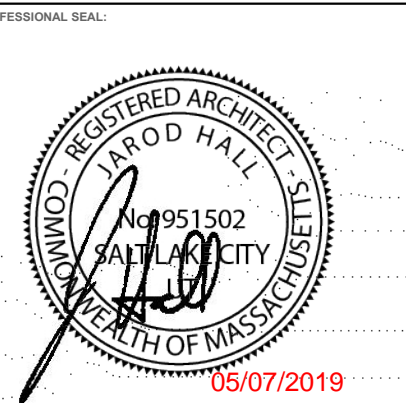

PROJECT ADDRESS: 8 WASHBURN
NEW BEDFORD, MA 02740
ARCHITECT: 18-18
P.E.: JDH
DATE: INITIAL SUBMITTAL
DATE: 07 MARCH 2019
SHEET NAME:

3D VIEWS

SHEET NUMBER: G300
5/7/2019 10:22:26 PM
DIVELEPT DESIGN LLC © 2019

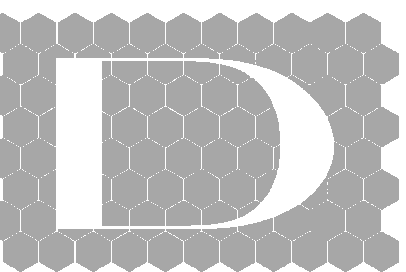

divelept

454 N 600 W, SLC, UT 84116
e: howdy@divelept.com
p: 801-660-4485
w: www.divelept.com

PARKING

TYPE	COUNT
9' x 19'-6" (8' Aisle)	1
9' x 20' - 90 deg	12
10' x 30' - 90 deg	2

KEYNOTES

10-KB KNOX BOX

SITE NOTES

- ALL SIDEWALKS TO BE A MINIMUM OF 4" THICK AIR ENTRAINED CONCRETE OVER 6" ROAD BASE, UNO.
- GRADING AT THE BUILDING SHALL HAVE A 5% MINIMUM SLOPE AWAY FROM THE BUILDING FOR A MINIMUM OF 10'-0", UNO. HARDSCAPE SHALL BE SLOPED 2% AWAY FROM BUILDING.
- FINISH GRADE TO BE 6" BELOW TOP OF FOUNDATION, UNO.
- FINISH GRADE OF SOFTSCAPE SHALL BE 2" UNIFORMLY BELOW PAVING SURFACES UNLESS NOTED OTHERWISE. REFERENCE CIVIL AND LANDSCAPE DRAWINGS.
- ALL EXTERIOR SIDEWALKS, STAIRS AND LANDINGS TO HAVE POSITIVE DRAINAGE BUT NO MORE THAN A MAXIMUM OF 1/4" SLOPE PER FOOT TO ALLOW POSITIVE DRAINAGE. ALL REBAR IN EXTERIOR APPLICATIONS TO BE EPOXY COATED.
- ALL PARKING LOT LINES, ARROWS, NO-PARKING AREAS, ETC., LOCATIONS TO BE APPROVED BY ARCHITECT PRIOR TO APPLICATION.

- CONCRETE SIDEWALK/DRIVEWAY
- ASPHALTIC PAVEMENT
- LANDSCAPING, TURF LAWN OR XERISCAPE
- PROPERTY LINE
- BUILDING OFFSET LINE

10

20

30

40

50


10

20



30

40

50

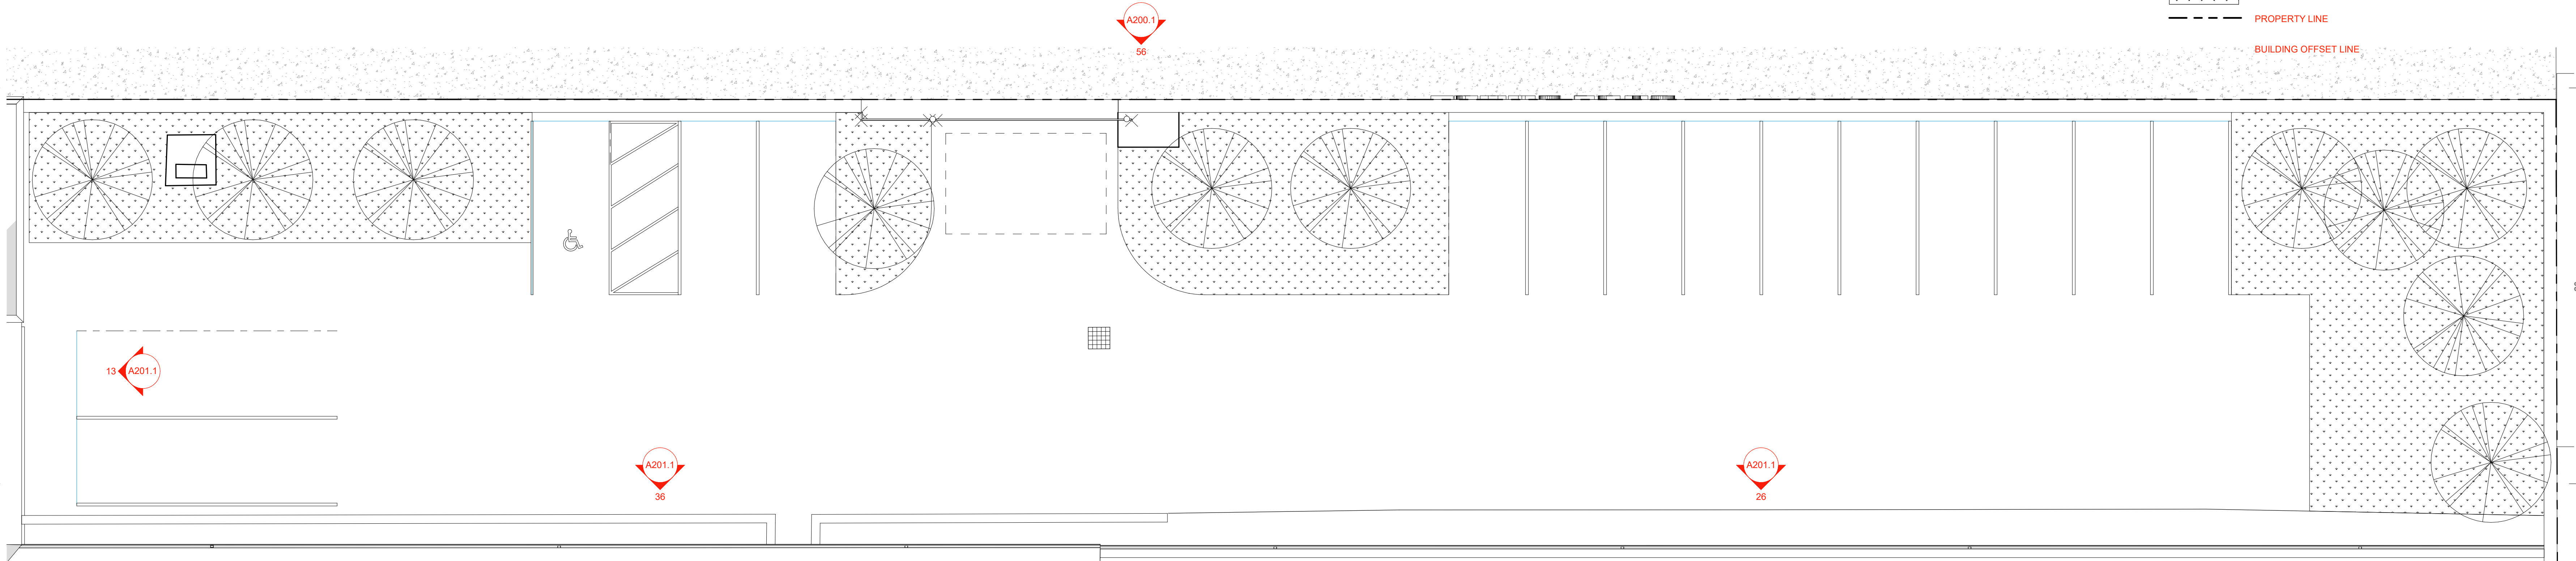


2 SITE PLAN - COURTYARD
1/8" = 1'-0"

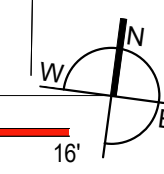
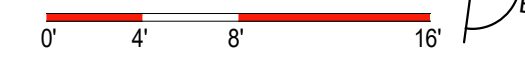


WASHBURN STREET

BELLEVILLE AVE.

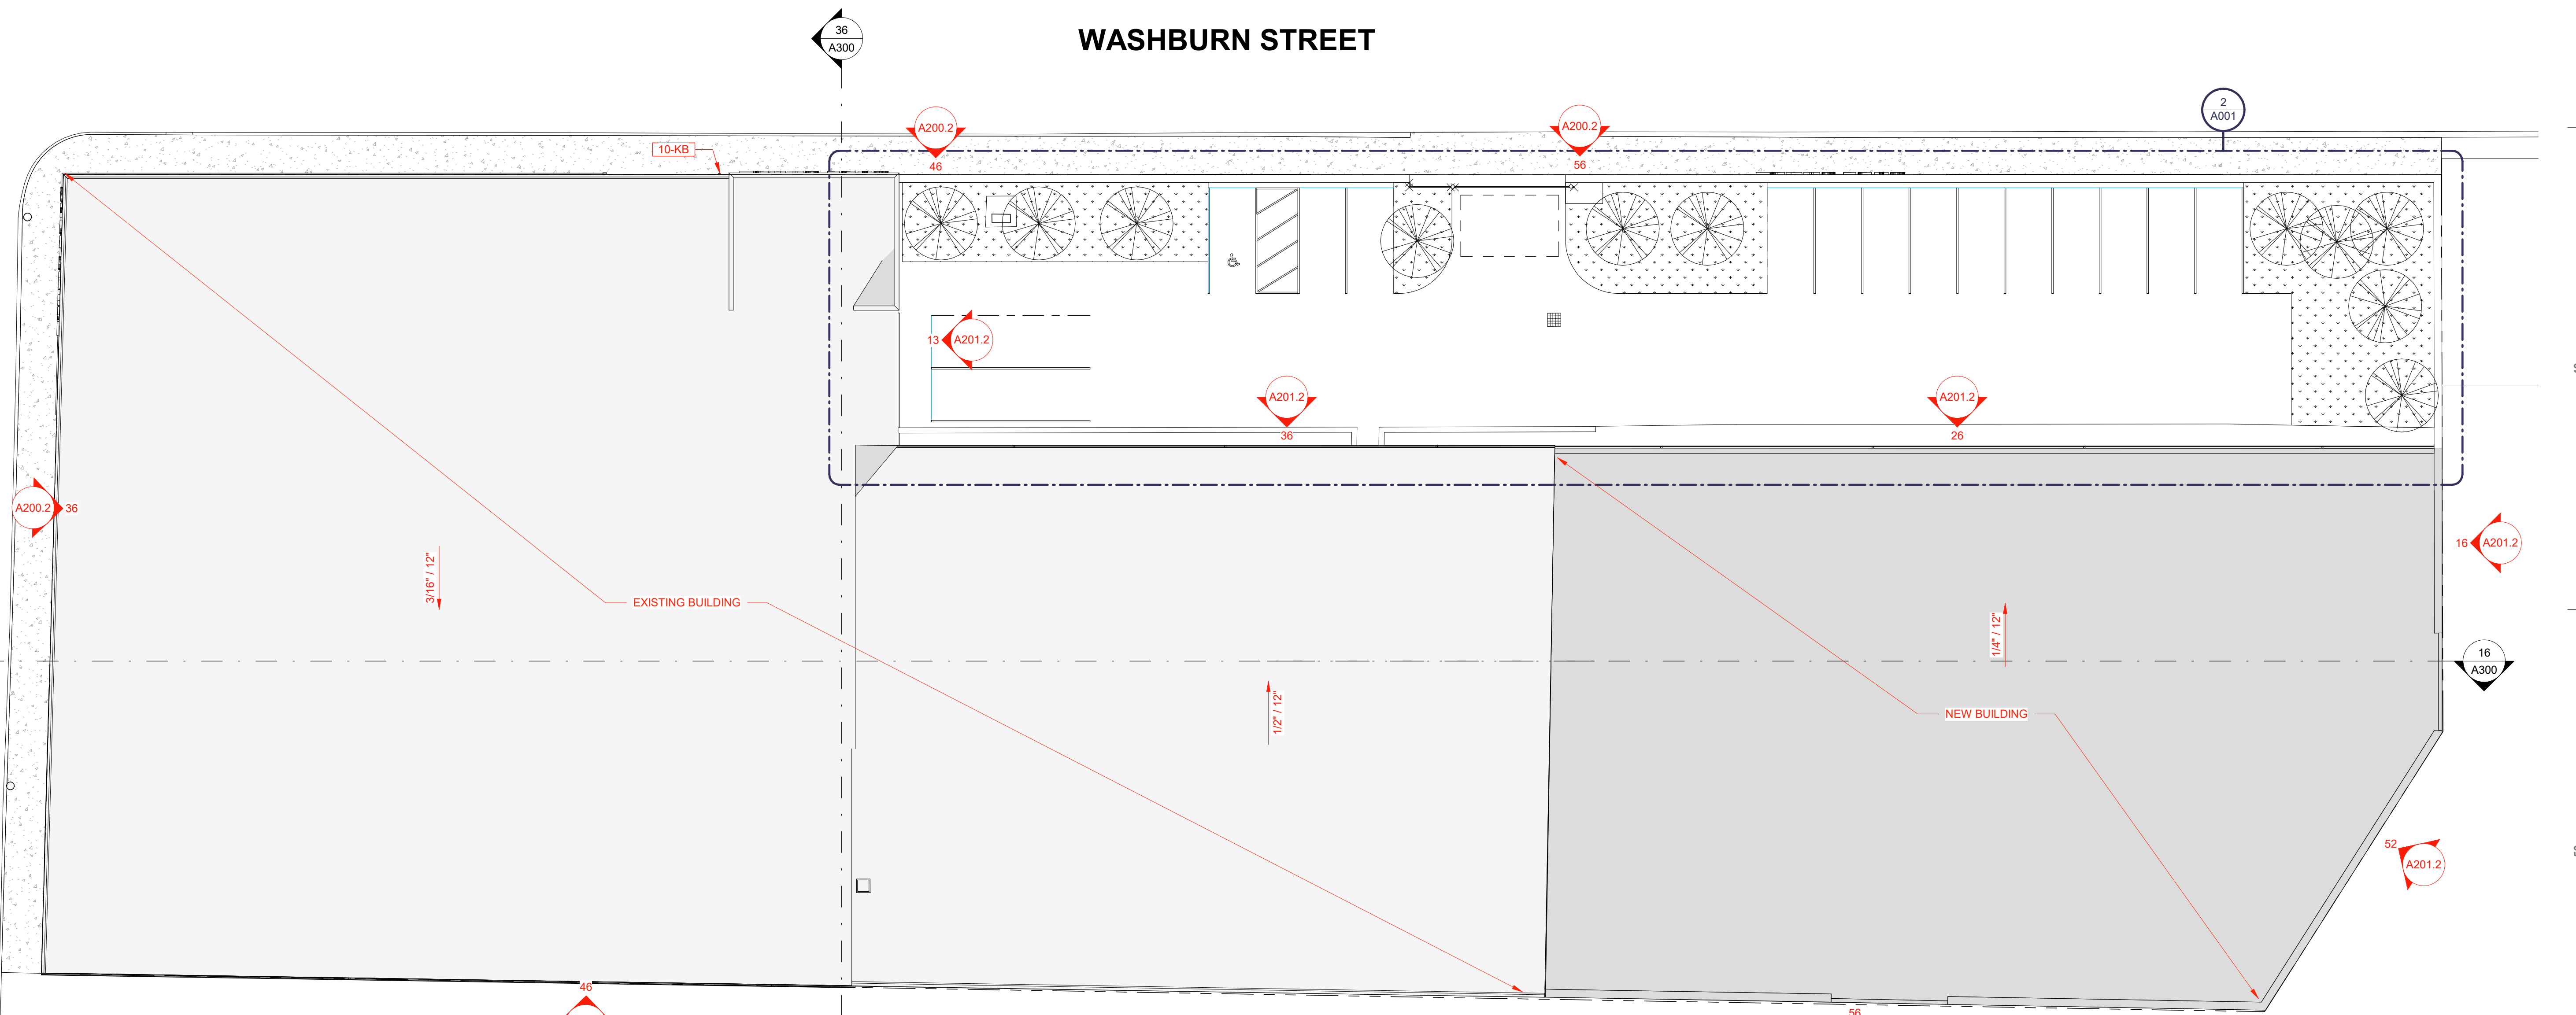

1 SITE PLAN
1/16" = 1'-0"

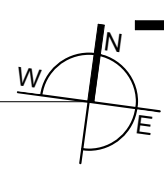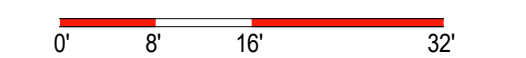

NEBE

No. Date Description




PROJECT ADDRESS: 8 WASHBURN NEW BEDFORD, MA 02740
ARCHITECT: 18-18
P.L.S.: JDH
PHASE: INITIAL SUBMITTAL
DATE: 07 MARCH 2019
SHEET SCALE: As indicated

ARCHITECTURAL SITE PLAN

A001

5/7/2019 10:21:00 PM

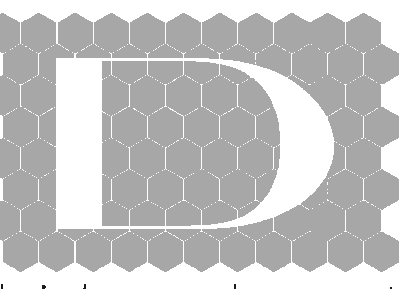


454 N 600 W, SLC, UT 84116
 c.howdy@divelept.com
 p: 801-660-4485
 w: www.divelept.com

KEYNOTES

- 2-1 EXISTING WALL CONSTRUCTION, PROTECT WHERE NOT CALLED OUT FOR DEMOLISHING
- 2-2 CUT OPENING IN EXISTING CONCRETE WALL, PATCH AND REPAIR EDGES AS REQUIRED TO PREPARE FOR NEW PAINT AT JAMBS
- 2-3 REMOVE EXISTING WALL CONSTRUCTION
- 2-4 REMOVE EXISTING OFFICE AREA IN ITS ENTIRETY, INCLUDING, BUT NOT LIMITED, TO WALLS, FLOORS, CEILING, ELECTRICAL DEVICES AND RACEWAYS, PLUMBING FIXTURES AND PIPES
- 2-5 REMOVE EXISTING DOOR AND FRAME
- 2-6 REMOVE EXISTING OVERHEAD COILING DOOR
- 2-7 EXISTING CONCRETE FLOOR, PROTECT FROM DAMAGE
- 2-9 EXISTING BUILDING COLUMN, PROTECT FROM DAMAGE
- 2-10 REMOVE EXISTING PLUMBING FIXTURES AND ABOVE SLAB PIPES, CAP BELOW SLAB PIPES BELOW FLOOR, PATCH FLOOR AS REQUIRED TO PROVIDE SMOOTH SURFACE
- 2-11 REMOVE EXISTING UTILITY EQUIPMENT

DEMO PLAN NOTES

1. THE CONTRACTOR MUST FIELD VERIFY ALL DIMENSIONS AND CONDITIONS INCLUDING EXISTING UTILITIES PRIOR TO BIDDING AS THE LOCATIONS SHOWN IN THE DOCUMENTS ARE APPROXIMATED. ALL VARIANCES FROM WHAT IS SHOWN IN THE DRAWINGS SHALL BE BROUGHT TO THE ATTENTION OF THE OWNER AND ARCHITECT PRIOR TO BID.
2. CONTRACTOR SHALL TAKE ALL PRECAUTIONS NECESSARY TO PROTECT THE EXISTING STRUCTURE, FINISHES, AND SITE ELEMENTS NOT CALLED FOR DEMOLITION DURING WORK.
3. AFTER DEMOLITION AND PRIOR TO FINISH, PATCH AND REPAIR ALL EXISTING WALLS AND FLOORS AS NECESSARY TO PROVIDE SMOOTH SURFACE SUITABLE FOR NEW FINISHES.
4. ANY ELECTRICAL AND/OR MECHANICAL DEVICES OR OTHER ITEMS REMOVED DURING DEMOLITION SHOULD BE SALVAGED AND REINSTALLED, UNLESS NOTED OTHERWISE.
5. WHERE ELECTRICAL FIXTURES ARE TO BE REMOVED, REMOVE ASSOCIATED CIRCUITS TO PANEL, INCLUDING BUT NOT LIMITED TO, DEVICES, WIRES, CONDUIT, AND JUNCTION BOXES.
6. WHERE EXISTING PLUMBING IS TO BE REMOVED, REMOVE ANY ASSOCIATED ABOVE SLAB LINES BACK TO NEAREST LINE THAT WILL STILL BE IN USE. CAP BELOW GRADE LINES BELOW THE SLAB AND REPAIR/FILL SLAB TO A SMOOTH FLAT FINISH.
7. WHERE EXISTING MECHANICAL EQUIPMENT IS TO BE REMOVED, REMOVE ASSOCIATED DUCTS AND GAS LINES BACK TO NEAREST POINT THAT IS STILL IN USE.
8. ANY DAMAGE SHOULD BE REPORTED IMMEDIATELY SO THAT THEY MAY BE EASILY CORRECTED BEFORE PROBLEMS DEVELOP.
9. REMOVE CEILING AND HEADERS AS REQUIRED IN REMODELED AREAS. PREP EXTERIOR FOR NEW PAINT, REMOVE ALL STAY OBJECTS ATTACHED TO BUILDING, REMOVED PEELING/CHIPPING PAINT, REPOINT BRICK WHERE REQUIRED.
11. REMOVE ALL EXTERIOR LIGHT FIXTURES AND PREP FOR A NEW FIXTURE IN SAME LOCATION.

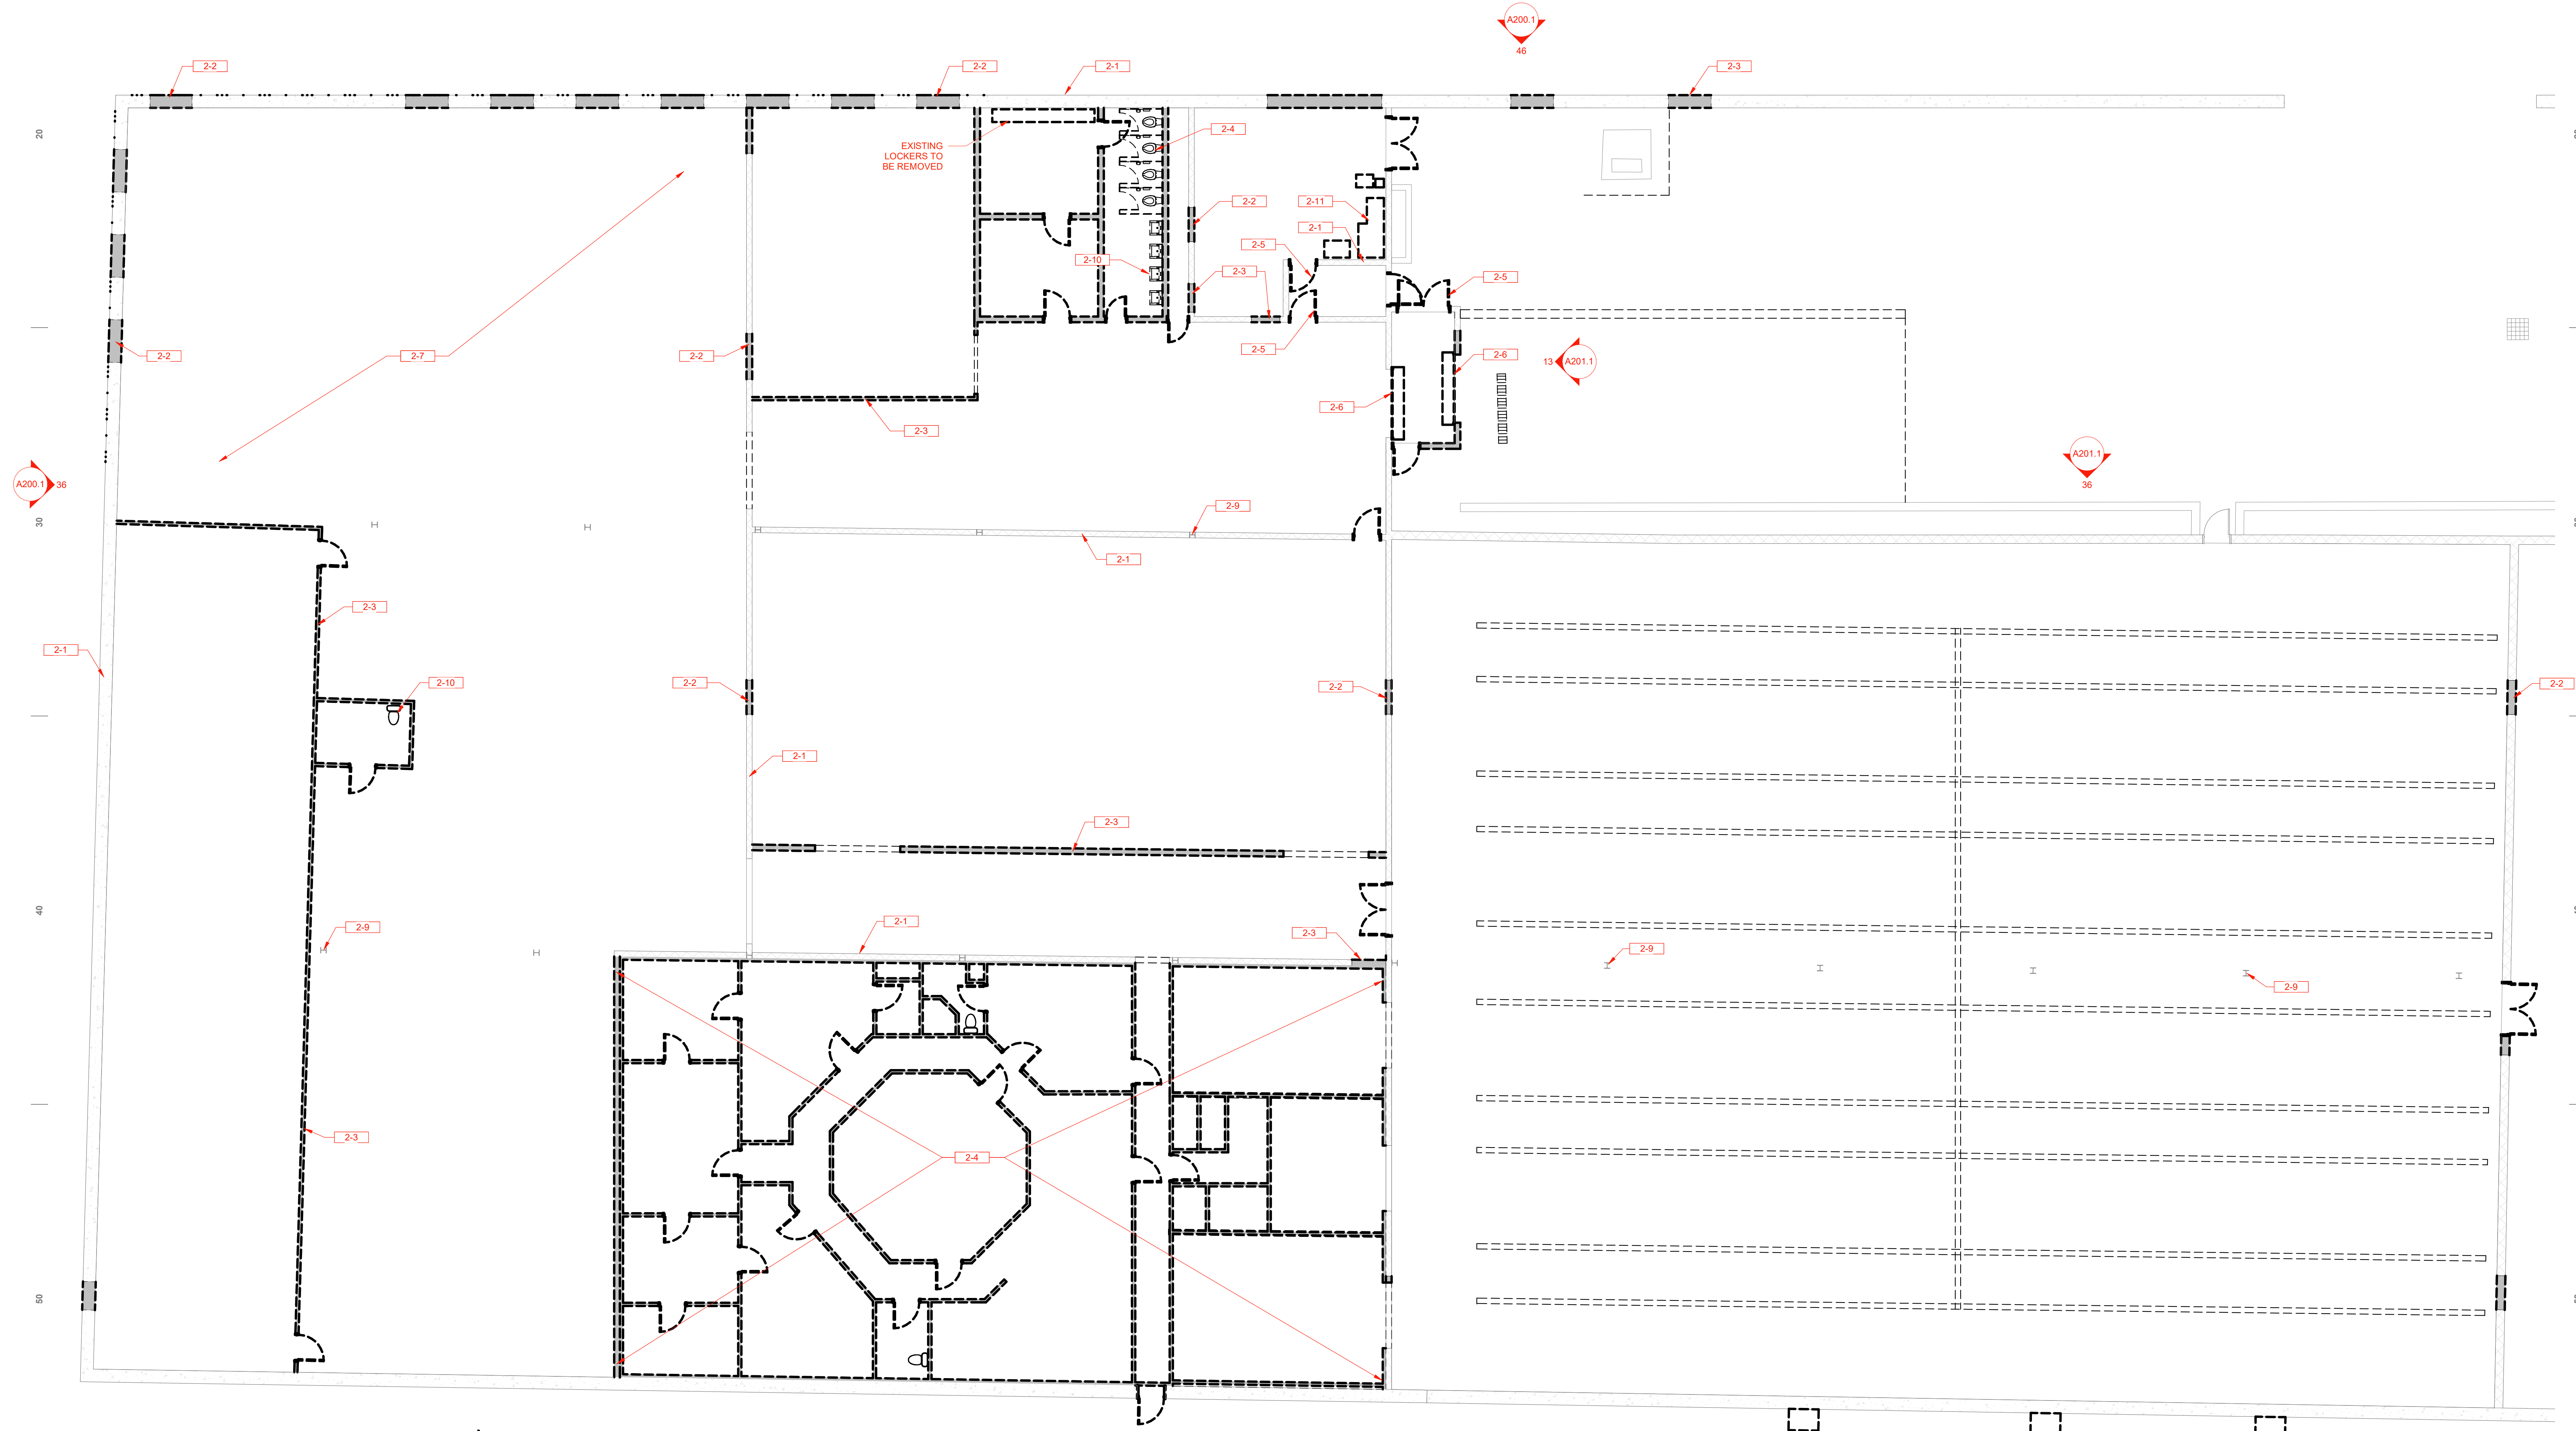

56 LEVEL 1 DEMO - WEST SIDE
 1/8" = 1'-0"

NEBE

Revised: No. Date Description




PROJECT ADDRESS: 8 WASHBURN NEW BEDFORD, MA 02740
 ARCHITECT: 18-18
 P.E.: JDH
 PHASE: INITIAL SUBMITTAL
 ISSUE DATE: 07 MARCH 2019
 SHEET SCALE: 1/8" = 1'-0"

LEVEL 1 DEMO - WEST SIDE

A110.1
 DIVELLEPT DESIGN LLC © 2019

5/7/2019 10:21:02 PM

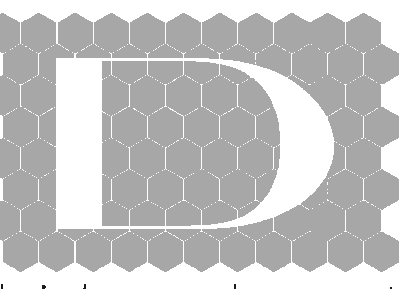

divelept
 454 N 600 W, SLC, UT 84116
 c.howdy@divelept.com
 p: 801-660-4485
 w: www.divelept.com


KEYNOTES

- 1-2 LINE OF BUILDING ABOVE
- 2-1 EXISTING WALL CONSTRUCTION, PROTECT WHERE NOT CALLED OUT FOR DEMOLISHING
- 2-8 EXISTING CONCRETE FLOOR, PREP HALLWAYS FOR SEALER
- 2-9 EXISTING BUILDING COLUMN, PROTECT FROM DAMAGE
- 5-RAL STEEL ROOF ACCESS LADDER TO HATCH ABOVE
- 7-MD METAL DOWNSPOUT
- 8-DP DIAMOND PLATE WALL PROTECTION
- 10-S3 10-

PLAN NOTES

1. SEE SHEET A500 FOR ASSEMBLY TYPES AND DETAILS
2. DOORS ARE TO BE 4" FROM HINGE SIDE OPENING TO EDGE OF STUD U.N.O.
3. PROVIDE A TRANSITION STRIP BETWEEN DIFFERENT TYPES OF FLOORING.
4. COORDINATE CASEWORK WITH APPLIANCES BEFORE FABRICATION.
5. WALL DIMENSIONING & ALIGNMENTS UNLESS NOTED OTHERWISE.
 - A. WHERE INTERIOR STUD WALLS ARE LOCATED ON GRID, CENTER STUD ON GRID
 - B. AT NON-SHEER WALLS ALIGN FRONT OF CORRIDOR SYSTEM PANELS ON GRID LINE
 - C. CORRIDORS ARE TO BE 5'-0" CLR
 - D. TYPICAL DIMENSIONS ARE TO FACE OF FRAMING
 - E. DIMENSIONS ARE TO FACE-OF-FINISH IF MARKED CLR (CLEAR DIMENSION)
 - F. DIMENSIONS ARE TO CENTER OF STUD WHERE INDICATED BY CL (CENTER LINE) SYMBOL
6. COORDINATE ALL EQUIPMENT REQUIREMENTS WITH MECHANICAL, PLUMBING AND ELECTRICAL DRAWINGS
7. APPLIANCES AND EQUIPMENT SHOWN FOR COORDINATION PURPOSES. PROVIDE UTILITY HOOKUPS FOR EQUIPMENT APPROPRIATE TO SELECTED EQUIPMENT
8. FURNITURE LAYOUT IF SHOWN (DASHED) FOR SCHEMATIC PURPOSES. NO FURNITURE IS TO BE PROVIDED IN THIS CONTRACT
9. TEMPERED GLASS SHALL BE PROVIDED IN: FRAMELESS GLASS DOORS, GLASS IN DOORS, GLASS WITHIN A 24" ARCH OF DOORS, GLAZING LESS THAN 60" ABOVE A WALKING SURFACE THAT IS WITHIN 5 FT OF STAIRS, OR GLAZING WITHIN 5 FT OF SPAS OR POOLS, CERTAIN FIXED GLASS PANELS, AND SIMILAR GLAZED OPENINGS SUBJECT TO HUMAN IMPACT. ALL NEW OPENINGS IN EXISTING WALLS AS 8'-10" UNLESS NOTED OTHERWISE

- NAME → ROOM NAME
- 101 → ROOM NUMBER
- 101A → MAN DOOR TAG
- 10 → OVERHEAD DOOR TAG
- 10C → ASSEMBLY TAG
- A → WINDOW TAG
- A → ALIGN FACES OF FINISH

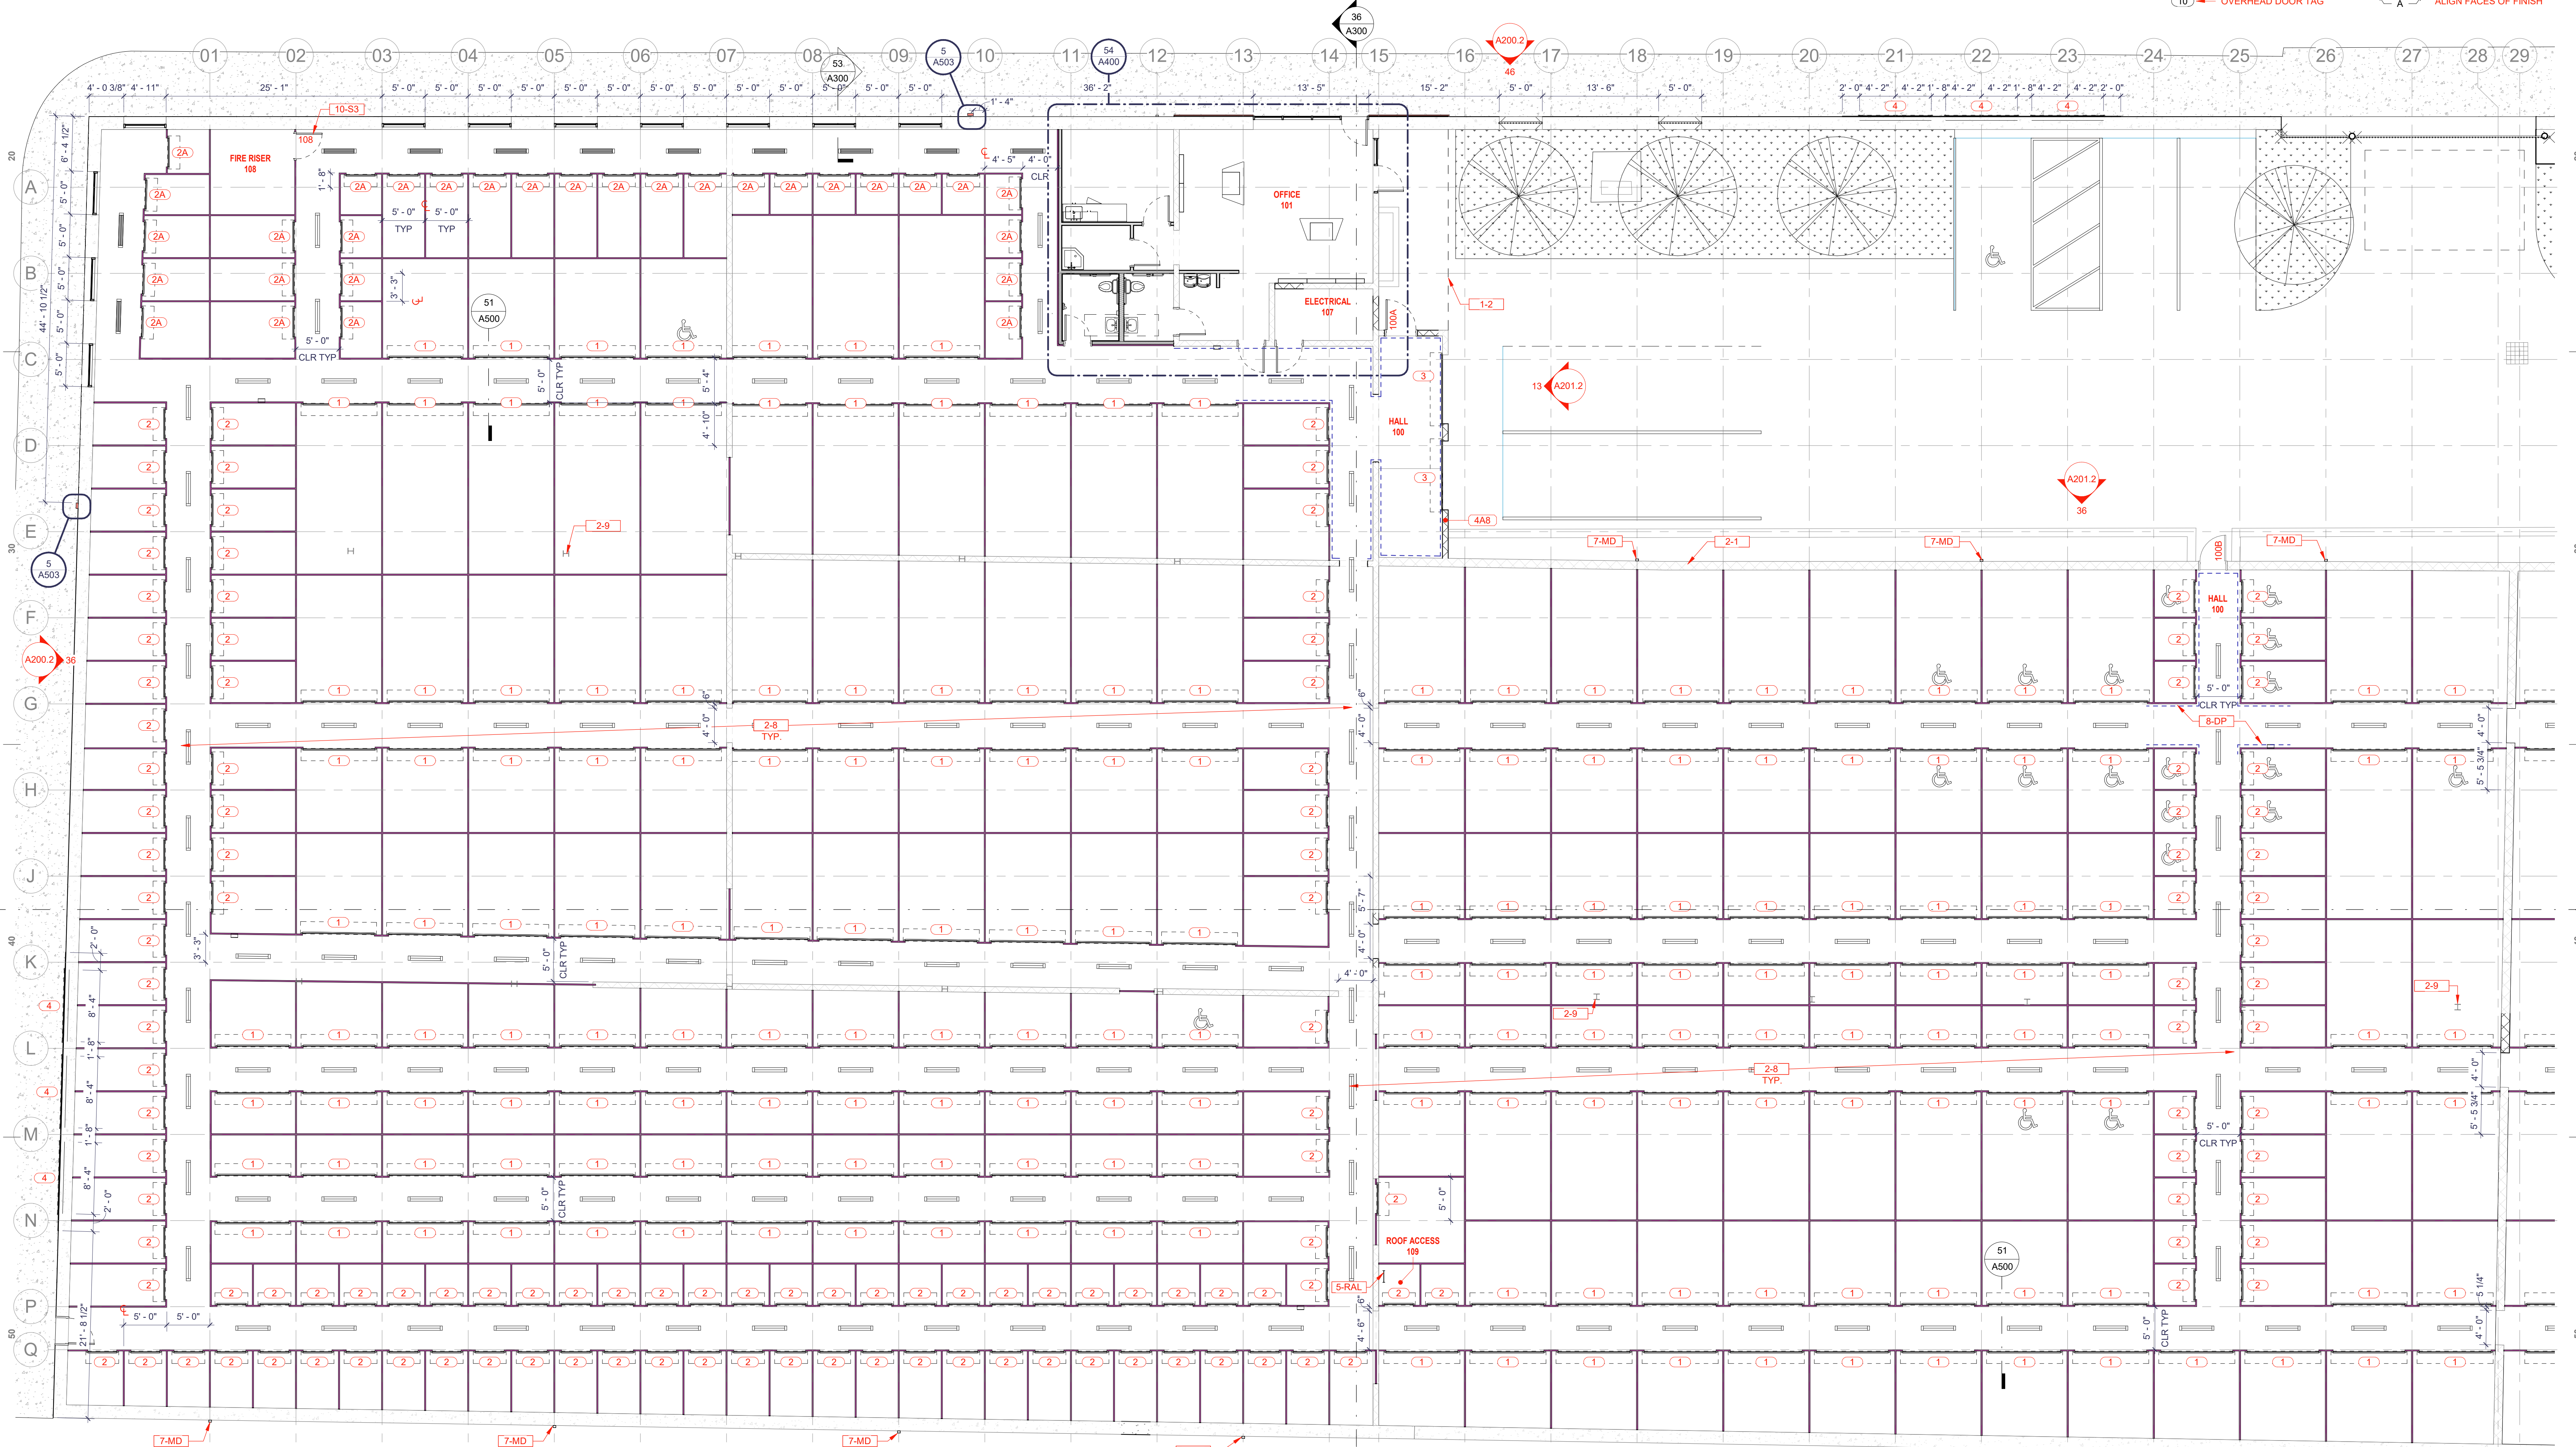

NEBE

No. Date Description

26 A300




PROJECT ADDRESS: 8 WASHBURN NEW BEDFORD, MA 02740
 ARCHITECT: 18-18
 ARCHITECT: JDH
 PHASE: INITIAL SUBMITTAL
 PHASE PUBLISHED: 07 MARCH 2019
 SHEET SCALE: 1/8" = 1'-0"

LEVEL 1 PLAN - WEST SIDE

A110.2

DIVELEPT DESIGN LLC © 2019

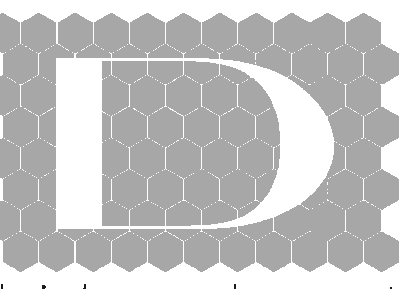

454 N 600 W, SLC, UT 84116
 c:howdy@divelept.com
 p:801-660-4485
 w:www.divelept.com


KEYNOTES

- 7-MD METAL DOWNSPOUT
- 8-DP DIAMOND PLATE WALL PROTECTION

PLAN NOTES

1. SEE SHEET A500 FOR ASSEMBLY TYPES AND DETAILS
2. DOORS ARE TO BE 4" FROM HINGE SIDE OPENING TO EDGE OF STUD U.N.O.
3. PROVIDE A TRANSITION STRIP BETWEEN DIFFERENT TYPES OF FLOORING.
4. COORDINATE CASEWORK WITH APPLIANCES BEFORE FABRICATION.
5. WALL DIMENSIONING & ALIGNMENTS UNLESS NOTED OTHERWISE
 - A. WHERE INTERIOR STUD WALLS ARE LOCATED ON GRID, CENTER STUD ON GRID
 - B. AT NON-SHEER WALLS ALIGN FRONT OF CORRIDOR SYSTEM PANELS ON GRID LINE
 - C. CORRIDORS ARE TO BE 5'-0" CLR
 - D. TYPICAL DIMENSIONS ARE TO FACE OF FRAMING
 - E. DIMENSIONS ARE TO FACE-OF-FINISH IF MARKED CLR (CLEAR DIMENSION)
 - F. DIMENSIONS ARE TO CENTER OF STUD WHERE INDICATED BY CL (CENTER LINE) SYMBOL
6. COORDINATE ALL EQUIPMENT REQUIREMENTS WITH MECHANICAL, PLUMBING AND ELECTRICAL DRAWINGS
7. APPLIANCES AND EQUIPMENT SHOWN FOR COORDINATION PURPOSES. PROVIDE UTILITY HOOKUPS FOR EQUIPMENT APPROPRIATE TO SELECTED EQUIPMENT
8. FURNITURE LAYOUT IF SHOWN (DASHED) FOR SCHEMATIC PURPOSES. NO FURNITURE IS TO BE PROVIDED IN THIS CONTRACT
9. TEMPERED GLASS SHALL BE PROVIDED IN: FRAMELESS GLASS DOORS, GLASS IN DOORS, GLASS WITHIN A 24" ARCH OF DOORS, GLAZING LESS THAN 60" ABOVE A WALKING SURFACE THAT IS WITHIN 5 FT OF STAIRS, OR GLAZING WITHIN 5 FT OF SPAS OR POOLS, CERTAIN FIXED GLASS PANELS, AND SIMILAR GLAZED OPENINGS SUBJECT TO HUMAN IMPACT. ALL NEW OPENINGS IN EXISTING WALLS AS 8'-10" UNLESS NOTED OTHERWISE

- NAME → ROOM NAME
- 101 → ROOM NUMBER
- 101A → MAN DOOR TAG
- 10 → OVERHEAD DOOR TAG
- 10C → ASSEMBLY TAG
- A → WINDOW TAG
- A → ALIGN FACES OF FINISH

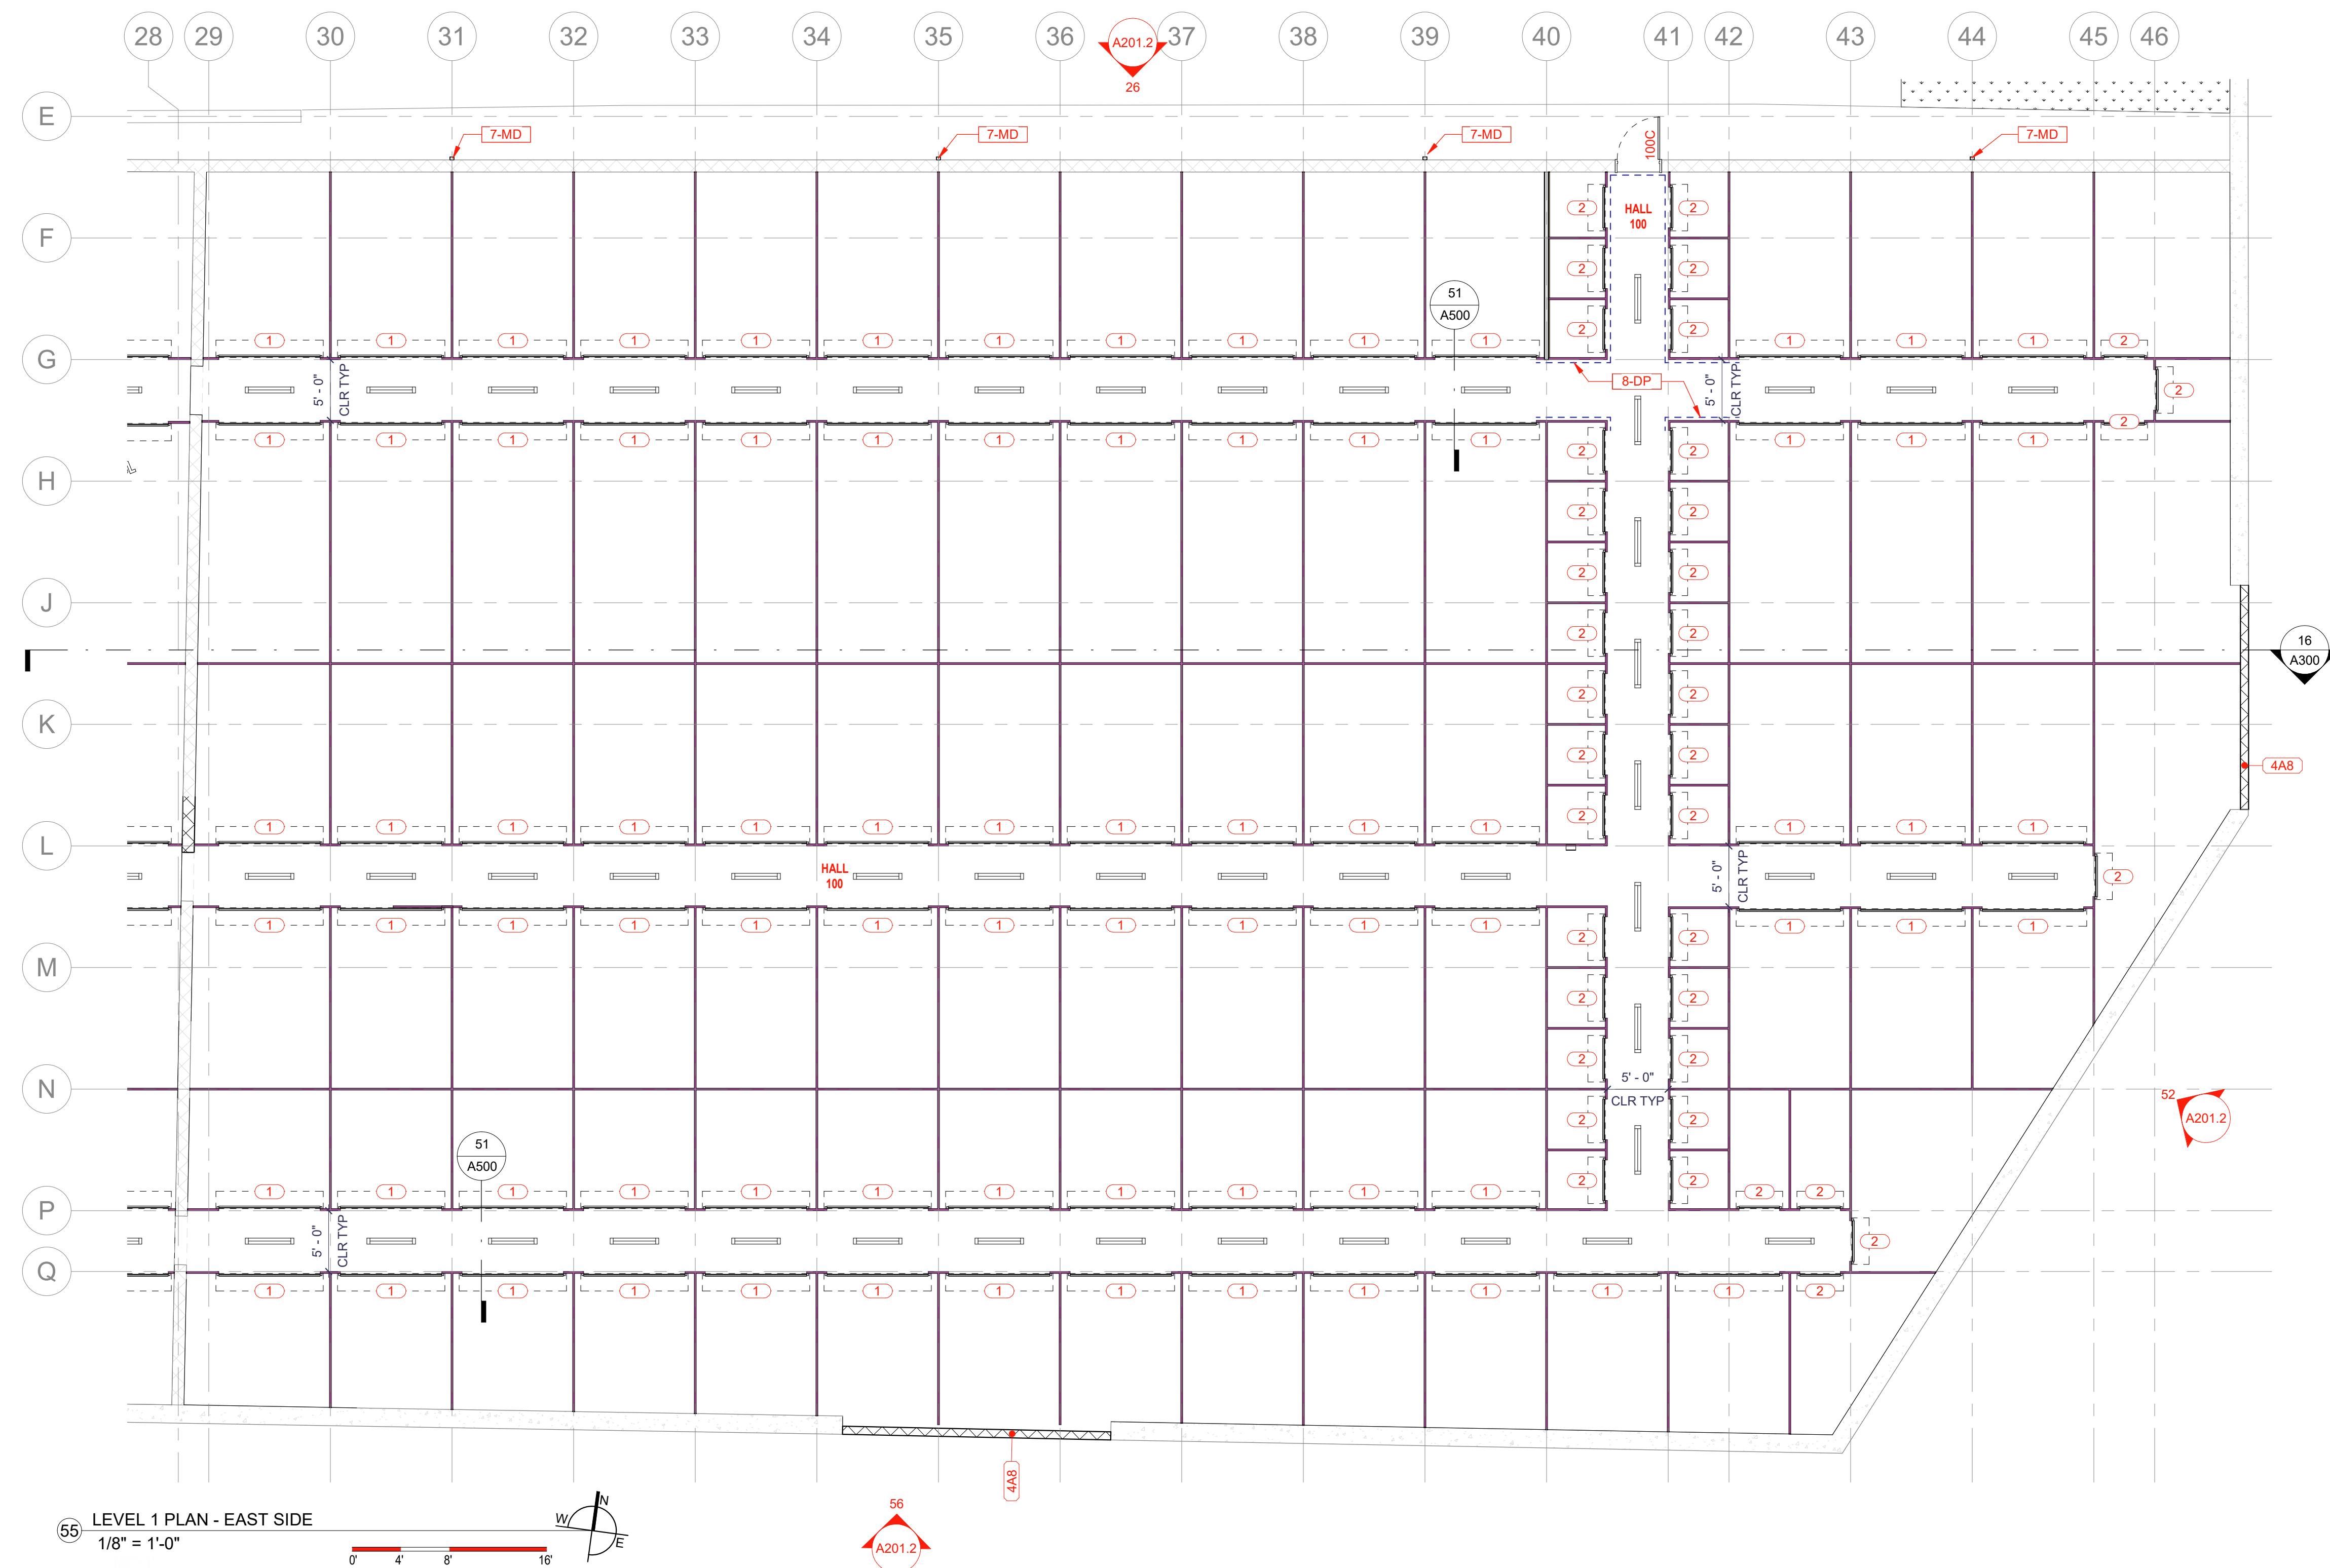

NEBE


No.	Date	Description



PROJECT ADDRESS:	8 WASHBURN NEW BEDFORD, MA 02740
ARCHITECT:	18-18
P.L.S.:	JDH
PHASE:	INITIAL SUBMITTAL
PHASE PUBLISHED DATE:	07 MARCH 2019
SHEET SCALE:	1/8" = 1'-0"
SHEET NAME:	

**LEVEL 1 PLAN
- EAST SIDE**

A111.2
 DIVELLEPT DESIGN LLC © 2019
 5/7/2019 10:21:06 PM

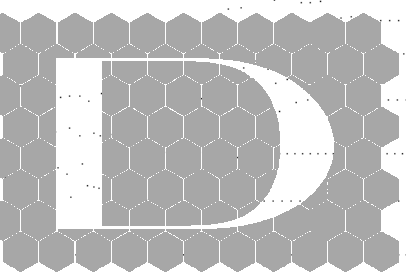

divelept

454 N 600 W, SLC, UT 84116
e: howdy@divelept.com
p: 801-660-4485
w: www.divelept.com

EXT. ELEVATION NOTES


- ALL FIXTURES MOUNTED TO EXTERIOR WALL TO BE ALIGNED VERTICALLY WHERE APPLICABLE.
- THESE ELEVATIONS WHEN PRINTED IN COLOR ARE INTENDED TO REPRESENT THE FINISH COLORS OF SIDING AND TRIM TO ILLUSTRATE DESIGN INTENT. NOT ALL TRIM ON THE PROJECT IS SHOWN. IF CONFLICTS BETWEEN THE COLORS SHOWN AND THE DRAWING INSTRUCTIONS, THE ARCHITECT IS TO BE NOTIFIED SO THAT A CLARIFICATION CAN BE ISSUED.
- EXTERIOR FINISH COLOR INSTRUCTIONS U.N.O.
 - EXPOSED TRIMS AND/OR FLASHINGS TO MATCH PAINT COLOR OF ADJACENT SIDING. IF ADJACENT TO TWO OR MORE COLORS AND NO FURTHER DIRECTION IS GIVEN, THE ARCHITECT IS TO BE NOTIFIED SO THAT A CLARIFICATION CAN BE ISSUED.
 - HOLLOW METAL MAN DOORS AND FRAMES PAINT TO MATCH ADJACENT SIDING.
 - HORIZONTAL FLASHING TRIM AT FLOOR LINES (WHERE EXIST) SHALL BE COLOR MC-1.
 - WINDOW SURROUND TRIMS AND FLASHING SHALL BE COLOR MC-1.
 - METAL OUTSIDE CORNER TRIM IS TO MATCH ADJACENT SIDING AT EACH LEVEL OF THE BUILDING. SIDING ON EITHER SIDE OF THE TRIM SHOULD BE THE SAME COLOR.
 - METAL INSIDE CORNER TRIM WHEN ADJACENT TO COLOR MC-1 ON EITHER SIDE SHALL BE COLOR MC-1.
 - PARAPET CAP, ROOF CAP, GUTTERS AND DOWNSPOUTS TO BE COLOR MC-1.
 - PAINTED CMU TO MATCH CORRESPONDING METAL COLOR AS SHOWN.

COLORS

- (SEE FINISH KEY ON SHEET A600 FOR FINISH COLOR DEFINITIONS)
- MC-1
 - P-1
 - P-2
 - P-3
 - TB-1
 - TB-2
 - C-1
 - C-2

KEYNOTES



- 7-MRT METAL RAKE TRIM
- 8-MS MAIL SLOT
- 8-SF1 ALUMINUM STOREFRONT TYPE 01
- 10-S1 BRANDED BUILDING SIGNAGE
- 32-F1 DECORATIVE SECURITY FENCE

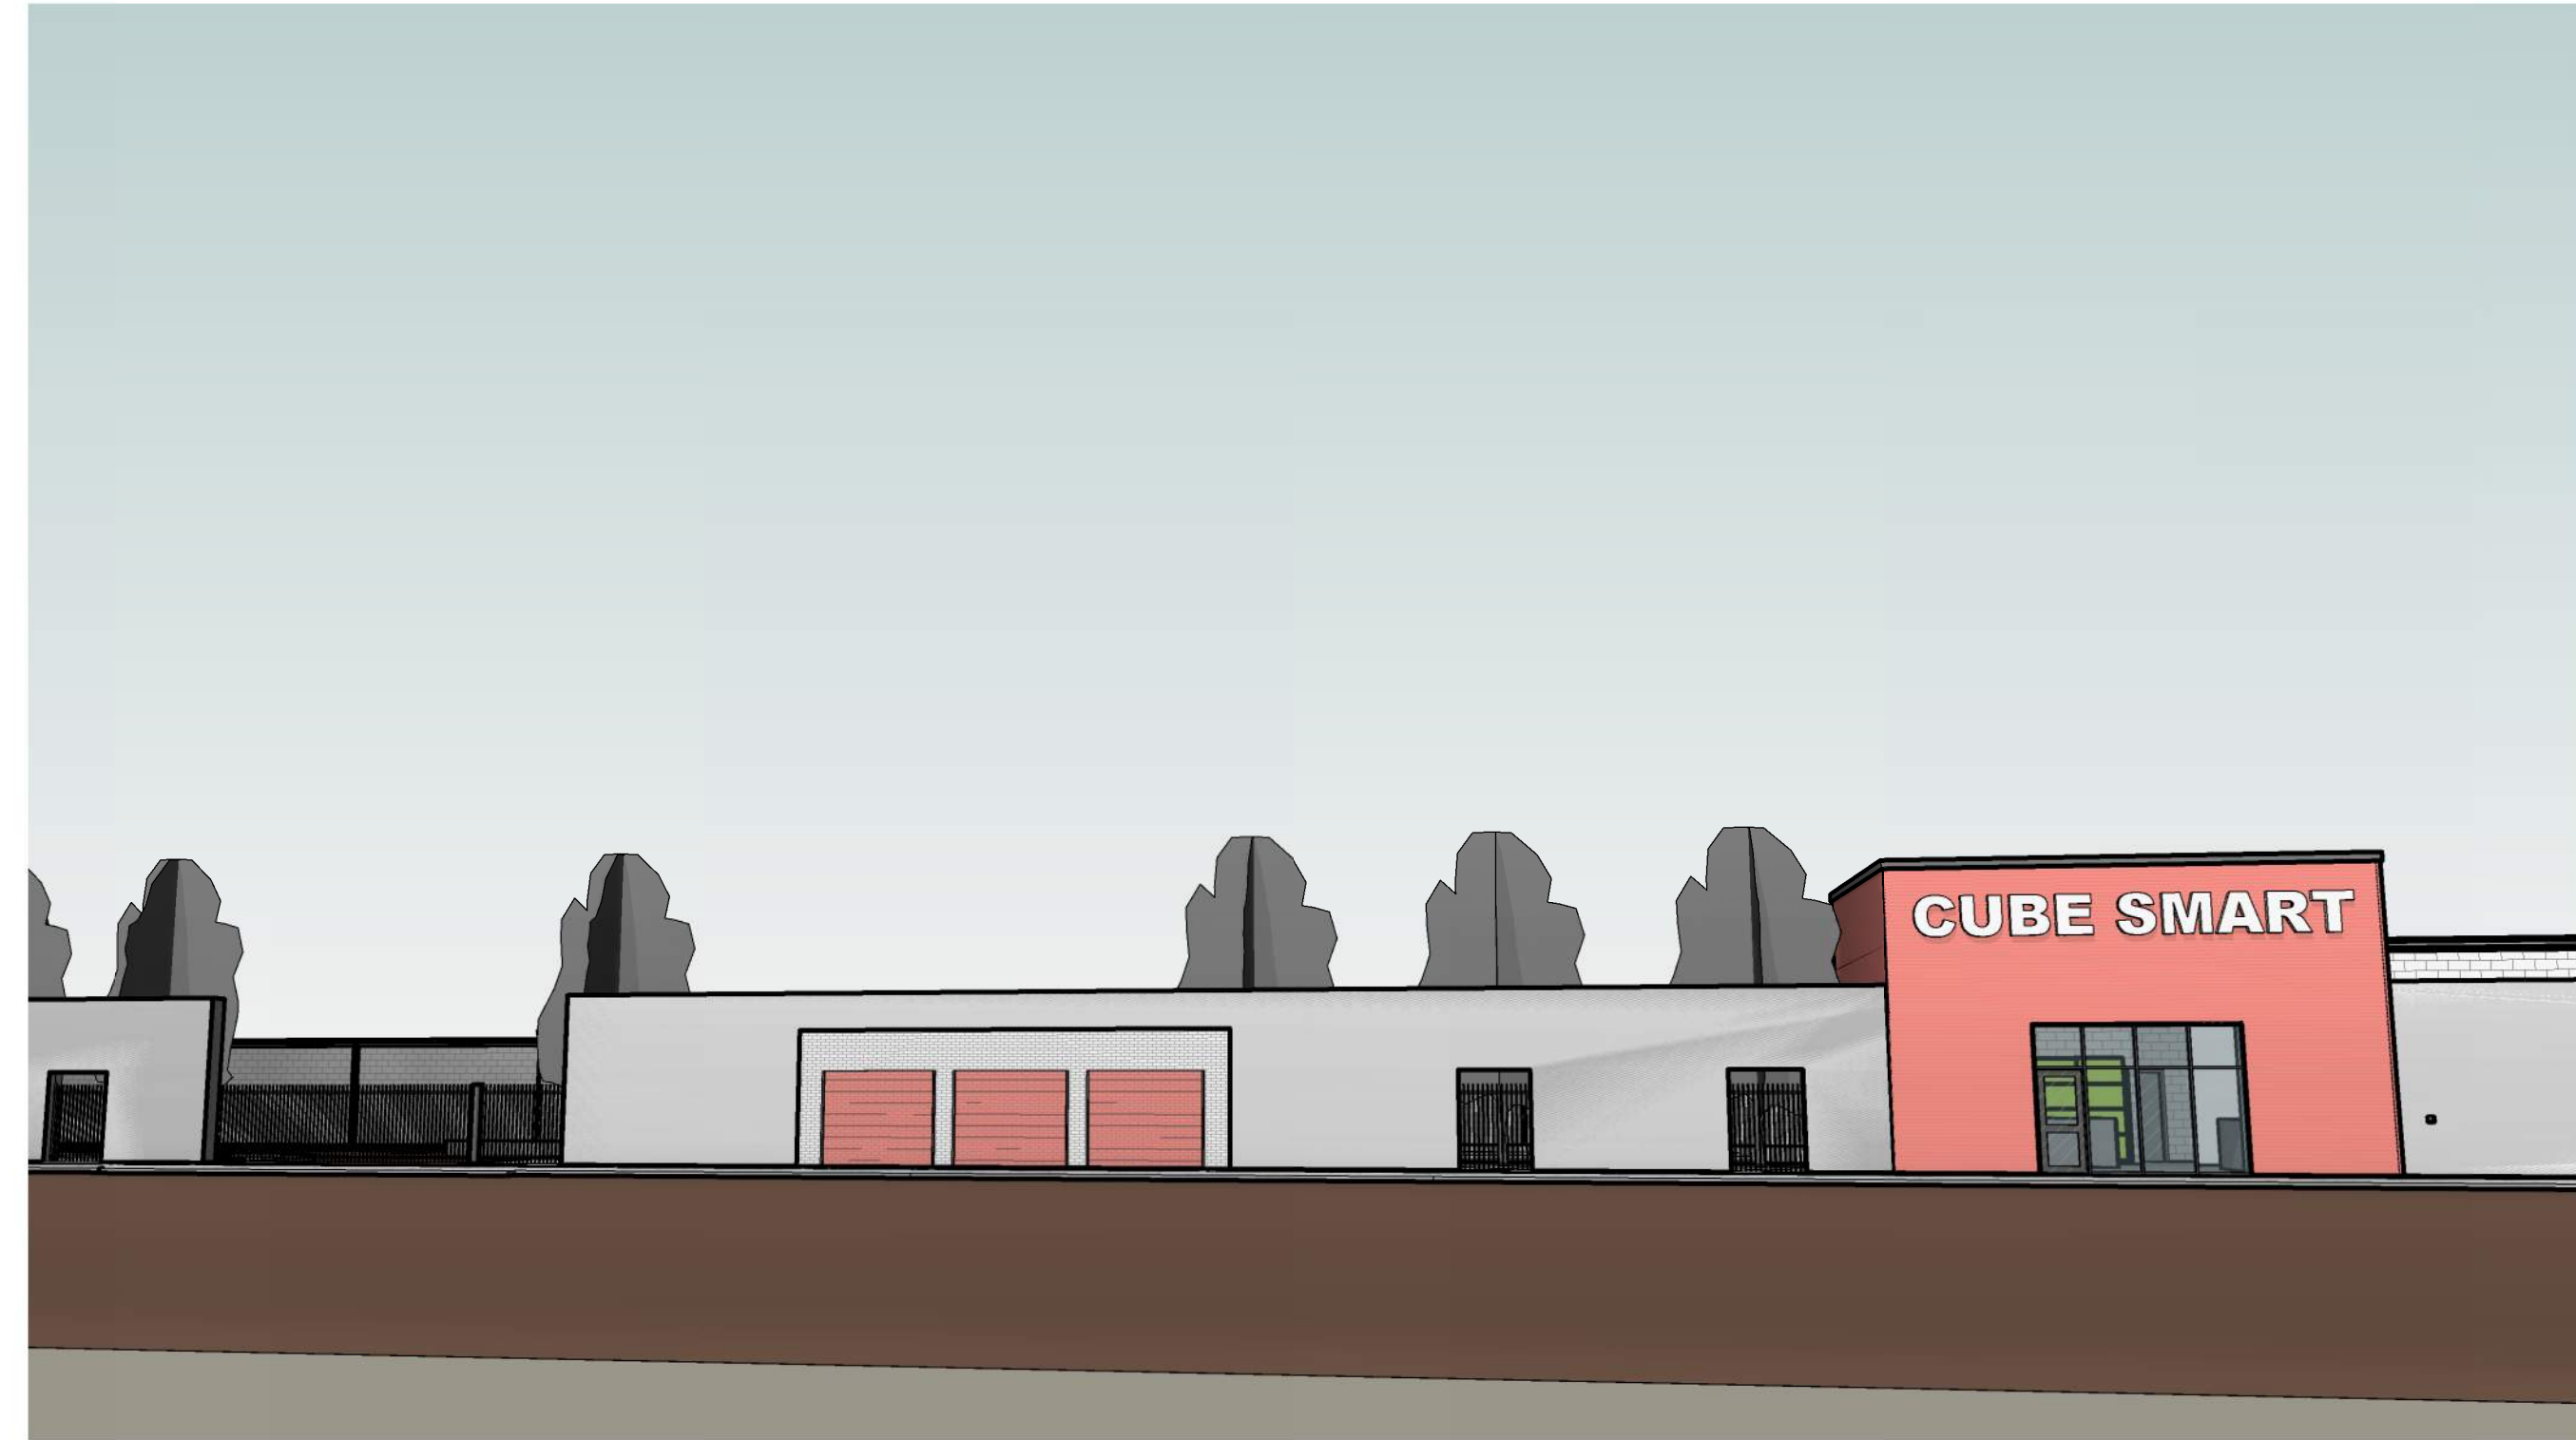

26 North Elevation




24 NW Corner

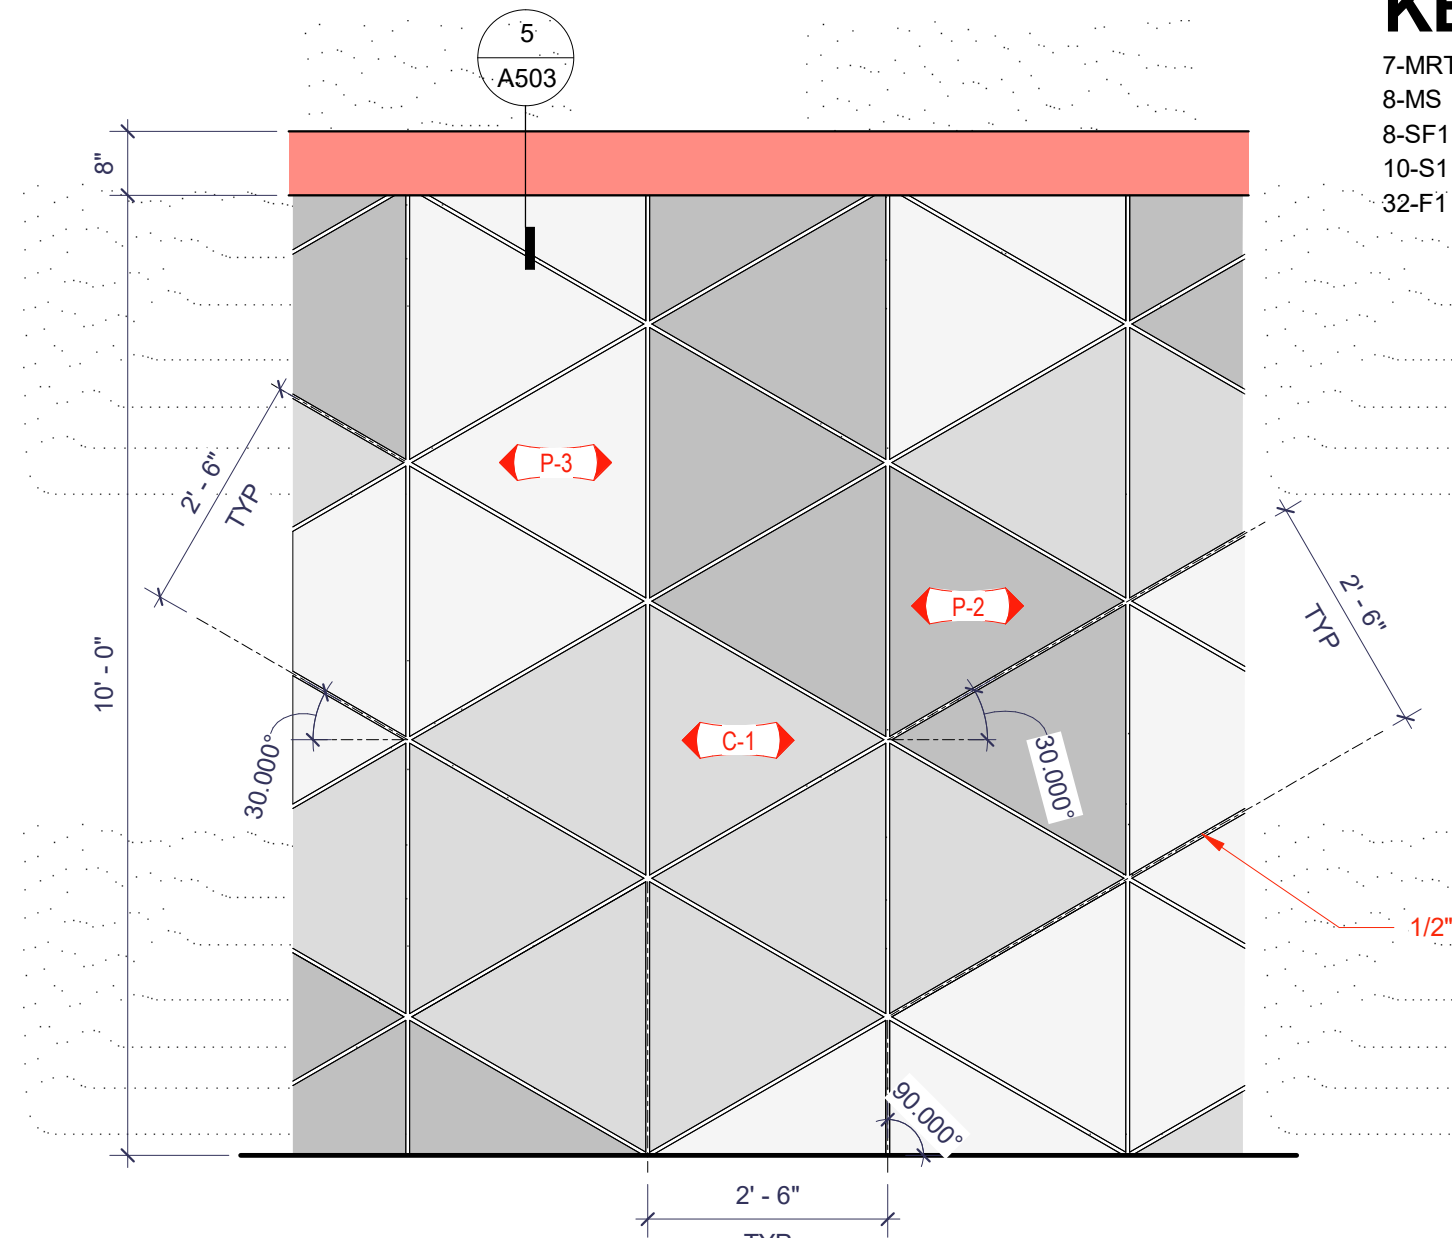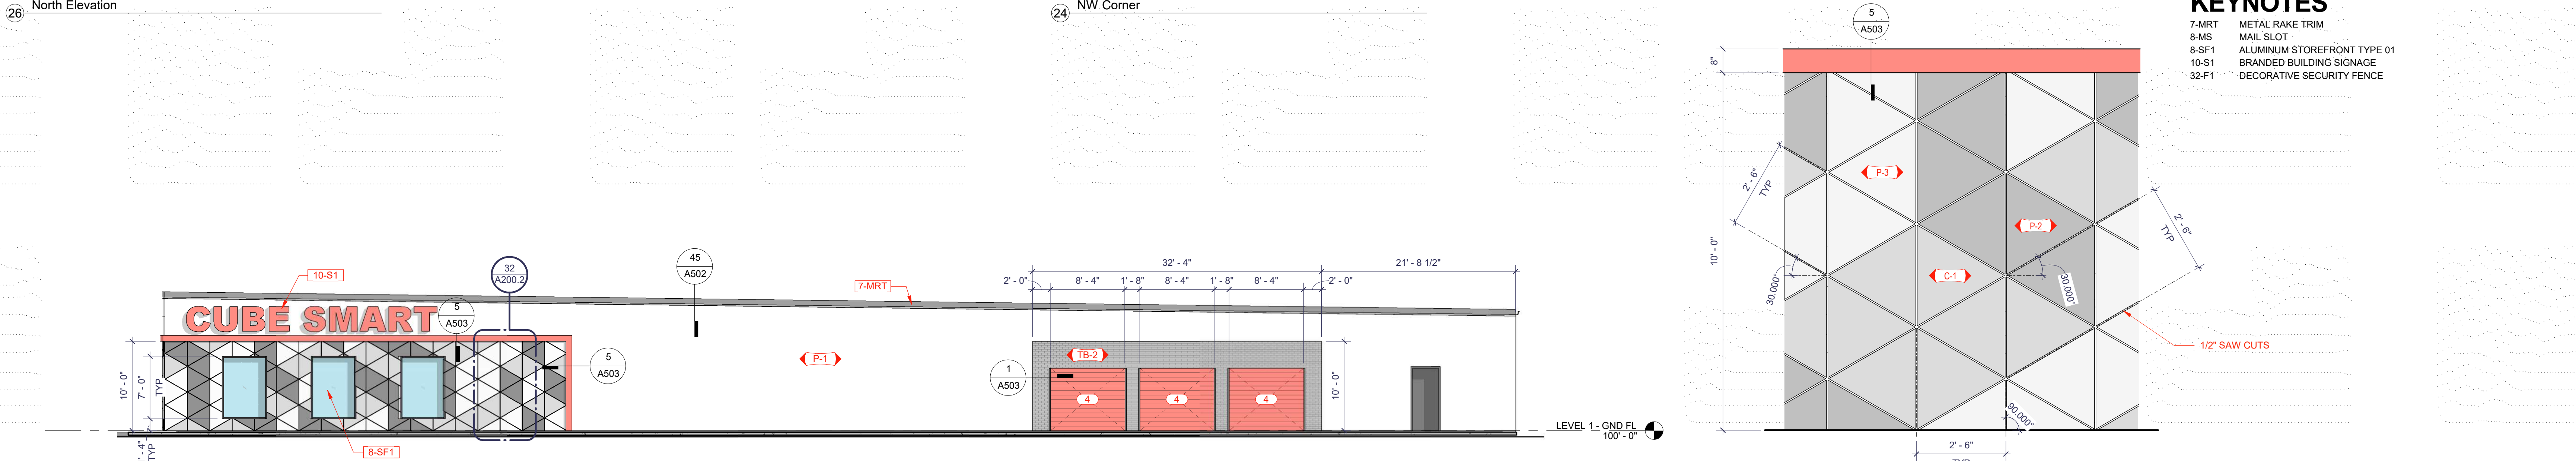

NEBE

No. Date Description

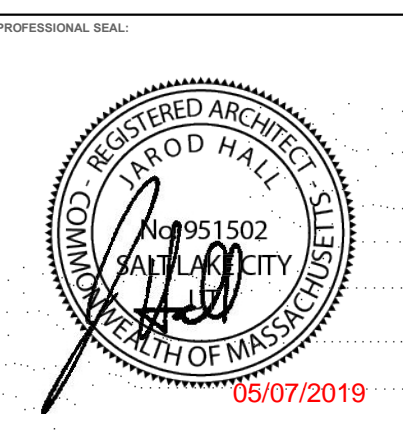

PROJECT ADDRESS: 8 WASHBURN NEW BEDFORD, MA 02740

ARCHITECT: JDH

DATE PUBLISHED: 07 MARCH 2019


SHEET SCALE: As indicated

EXTERIOR ELEVATIONS

PROJECT NUMBER: A200.2

DATE: 5/7/2019 10:21:58 PM

DESIGNER: DIVELLEPT DESIGN LLC © 2019

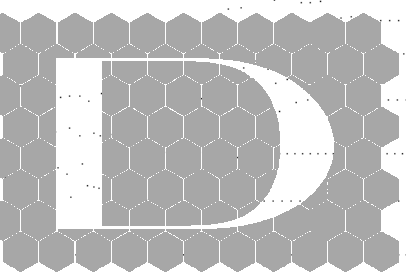

divelept
 454 N 600 W, SLC, UT 84116
 e: howdy@divelept.com
 p: 801-660-4485
 w: www.divelept.com

EXT. ELEVATION NOTES

- ALL FIXTURES MOUNTED TO EXTERIOR WALL TO BE ALIGNED VERTICALLY WHERE APPLICABLE.
- THESE ELEVATIONS WHEN PRINTED IN COLOR ARE INTENDED TO REPRESENT THE FINISH COLORS OF SIDING AND TRIM TO ILLUSTRATE DESIGN INTENT. NOT ALL TRIM ON THE PROJECT IS SHOWN. IF CONFLICTS BETWEEN THE COLORS SHOWN AND THE DRAWING INSTRUCTIONS, THE ARCHITECT IS TO BE NOTIFIED SO THAT A CLARIFICATION CAN BE ISSUED. EXTERIOR FINISH COLOR INSTRUCTIONS U.N.O.
- EXPOSED TRIMS AND/OR FLASHINGS TO MATCH PAINT COLOR OF ADJACENT SIDING. IF ADJACENT TO TWO OR MORE COLORS AND NO FURTHER DIRECTION IS GIVEN, THE ARCHITECT IS TO BE NOTIFIED SO THAT A CLARIFICATION CAN BE ISSUED.
 - HOLLOW METAL MAN DOORS AND FRAMES PAINT TO MATCH ADJACENT SIDING
 - HORIZONTAL FLASHING TRIM AT FLOOR LINES (WHERE EXIST) SHALL BE COLOR MC-1
 - WINDOW SURROUND TRIMS AND FLASHING SHALL BE COLOR MC-1
 - METAL OUTSIDE CORNER TRIM IS TO MATCH ADJACENT SIDING AT EACH LEVEL OF THE BUILDING. SIDING ON EITHER SIDE OF THE TRIM SHOULD BE THE SAME COLOR
 - METAL INSIDE CORNER TRIM WHEN ADJACENT TO COLOR MC-1 ON EITHER SIDE SHALL BE COLOR MC-1
 - PARAPET CAP, ROOF CAP, GUTTERS AND DOWNSPOUTS TO BE COLOR MC-1
 - PAINTED CMU TO MATCH CORRESPONDING METAL COLOR AS SHOWN


COLORS

(SEE FINISH KEY ON SHEET A600 FOR FINISH COLOR DEFINITIONS)


- MC-1
- P-1
- P-2
- P-3
- TB-1
- TB-2
- C-1
- C-2

KEYNOTES


- 7-MCT METAL CAP TRIM
- 7-MD METAL DOWNSPOUT
- 7-MRG METAL ROOF GUTTER
- 8-D MAN DOOR
- 8-OD OVERHEAD DOOR
- 8-SF1 ALUMINUM STOREFRONT TYPE 01

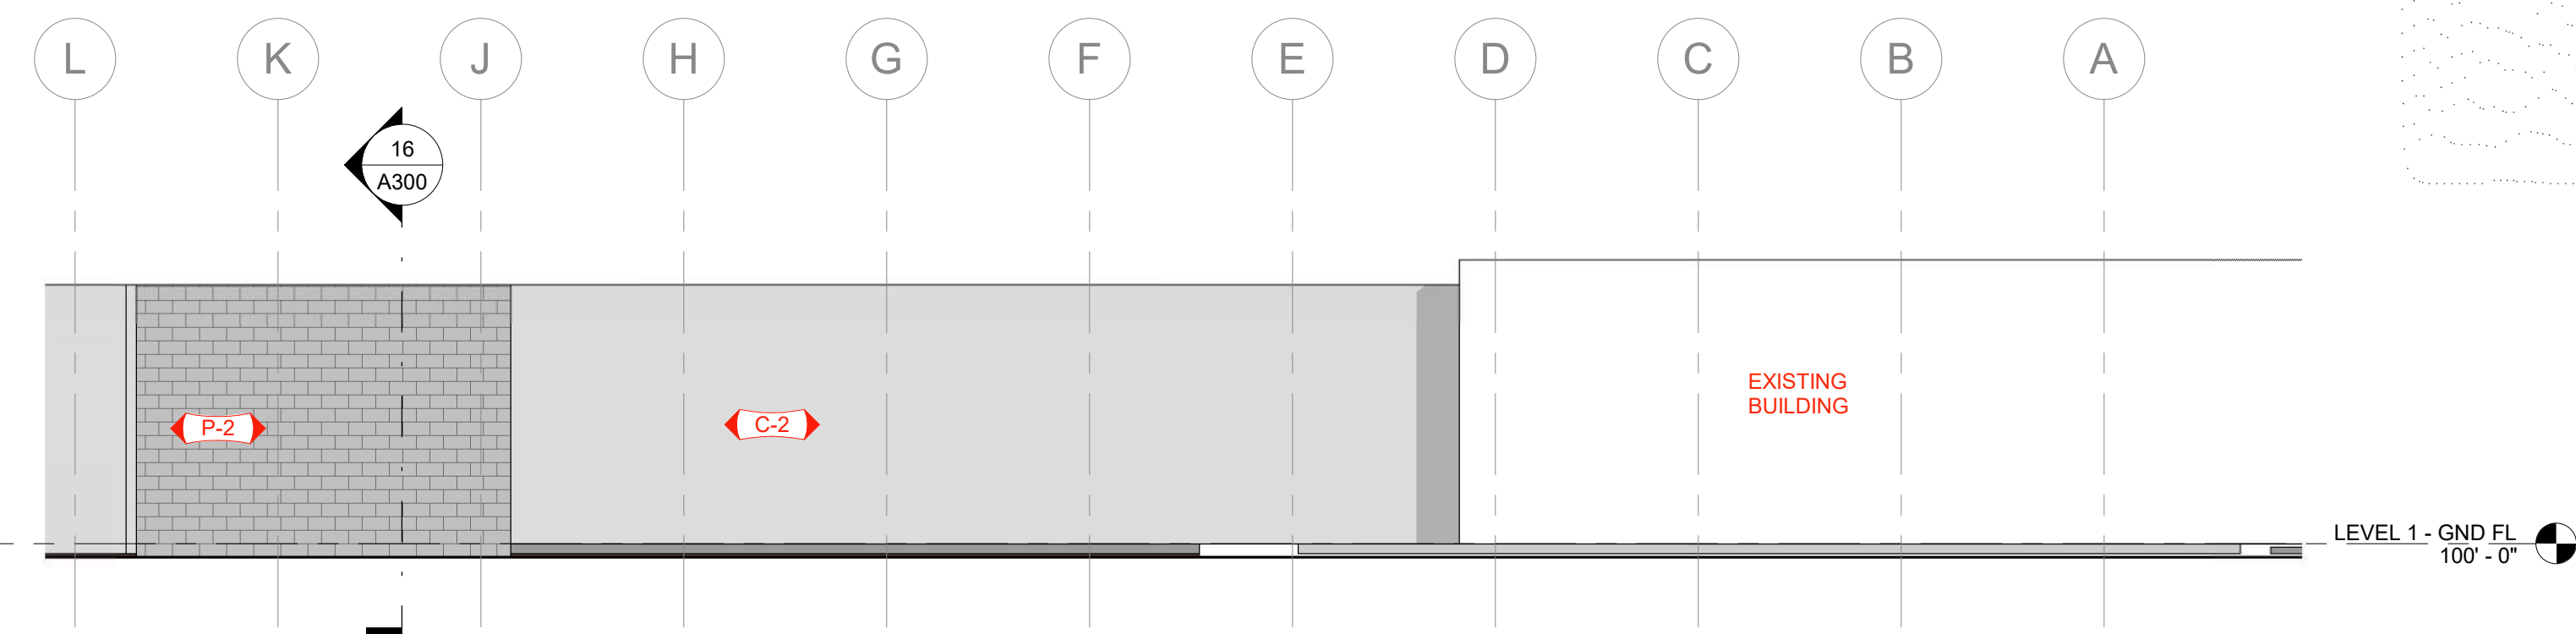


16 EAST ELEVATION
1/8" = 1'-0"

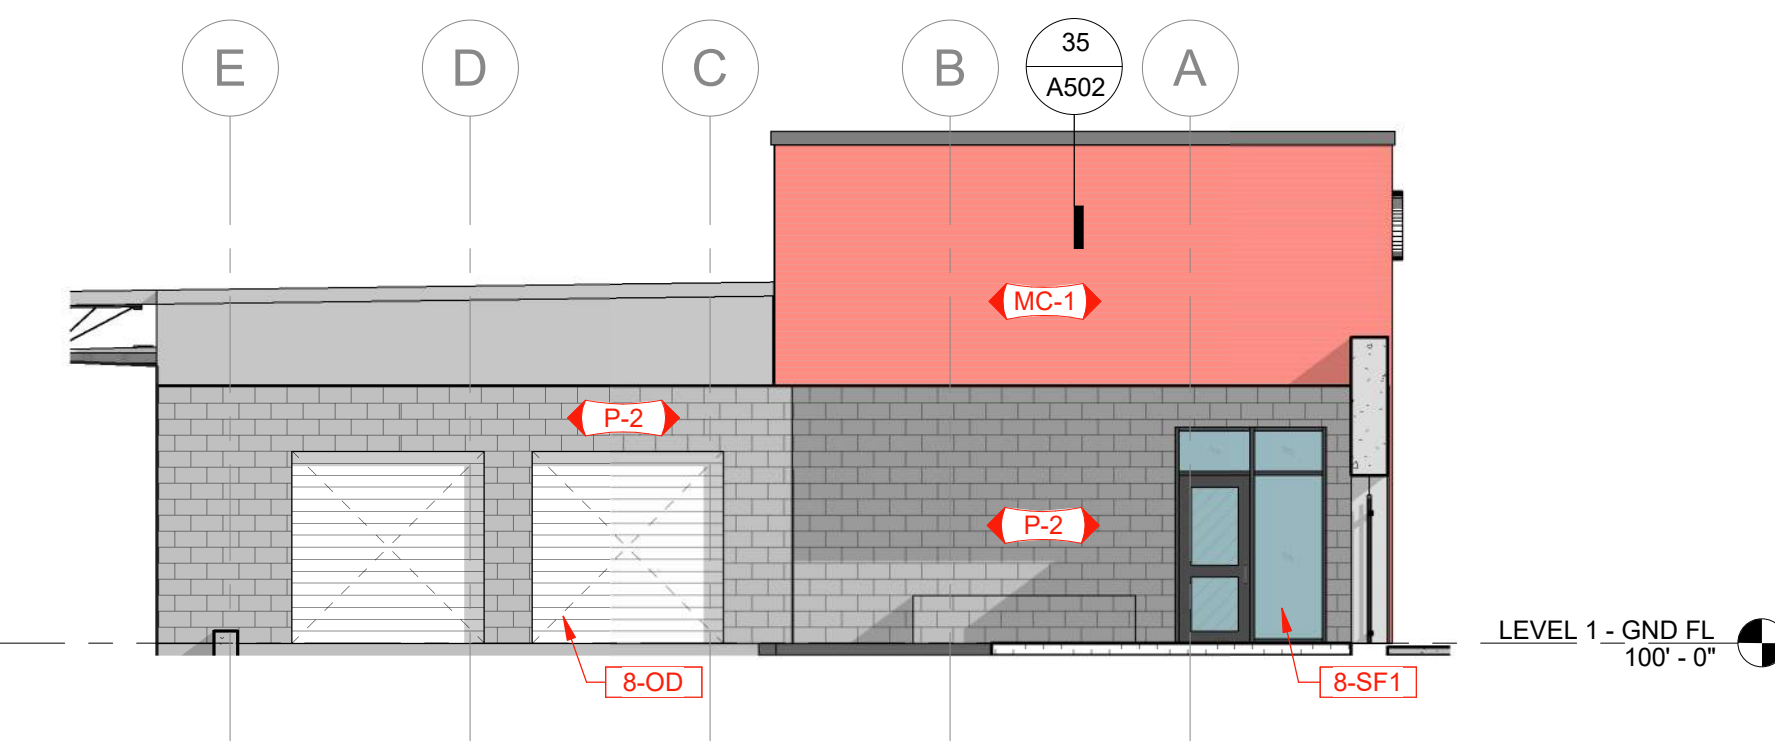


13 COURTYARD EAST ELEVATION
1/8" = 1'-0"

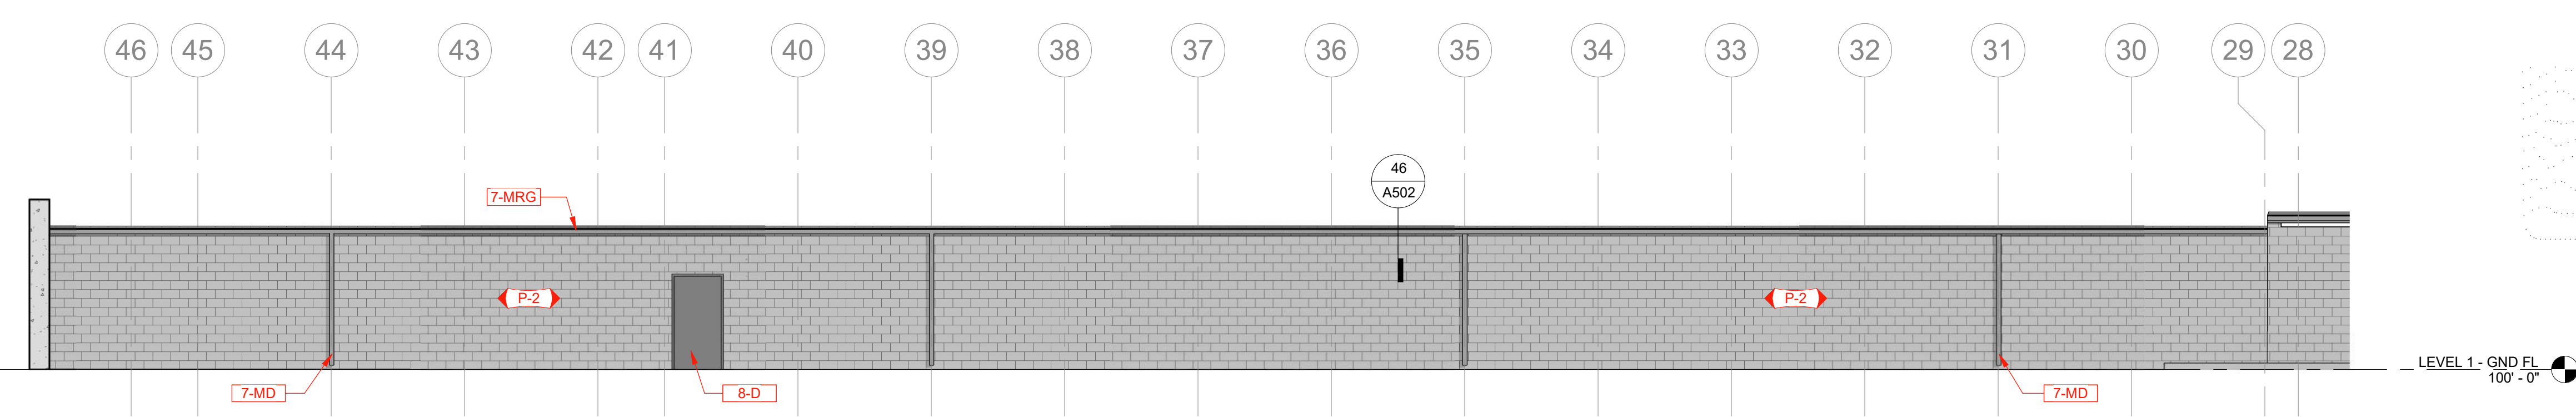


26 COURTYARD NORTH ELEV (EAST END)
1/8" = 1'-0"

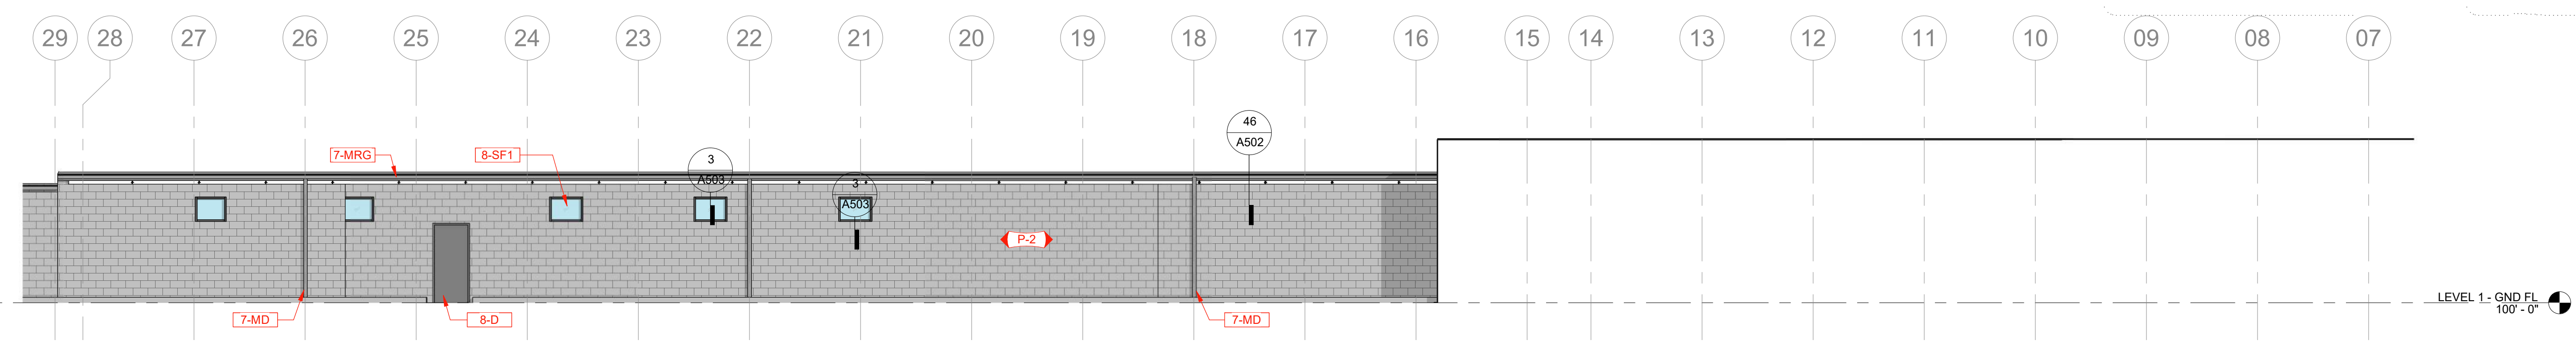

36 COURTYARD NORTH ELEV (WEST END)
1/8" = 1'-0"

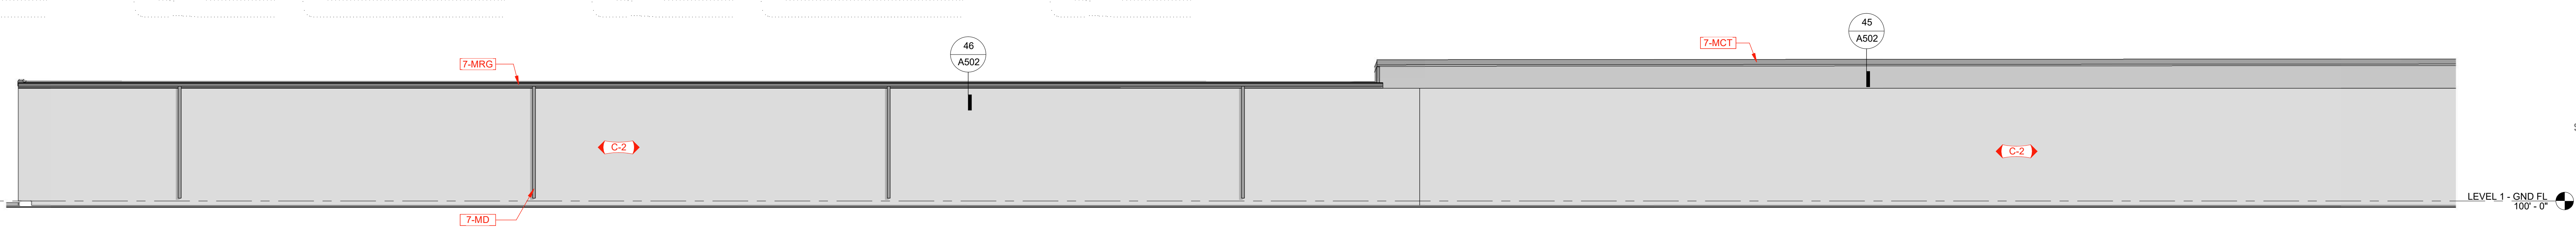

46 SOUTH ELEVATION (WEST END)
1/8" = 1'-0"

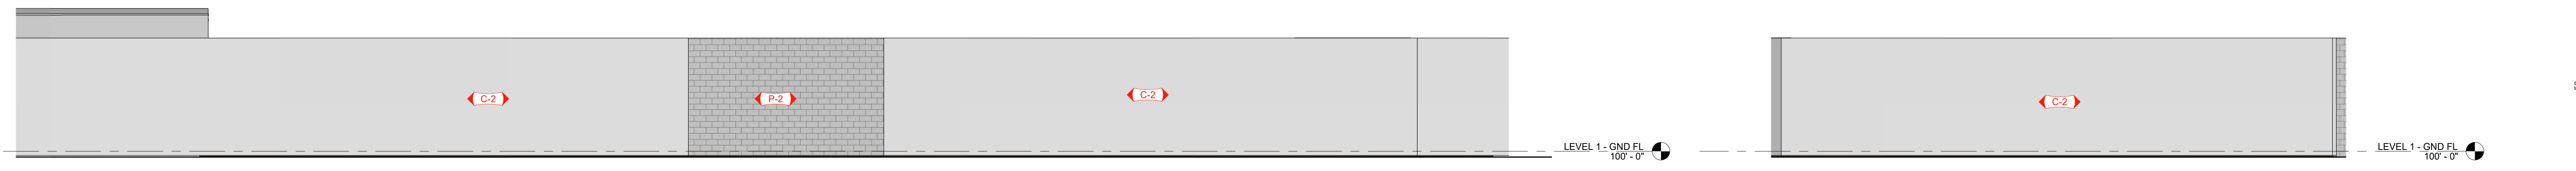


56 SOUTH ELEVATION (EAST END)
1/8" = 1'-0"

52 SOUTHEAST ELEVATION
1/8" = 1'-0"

NEBE

No.	Date	Description

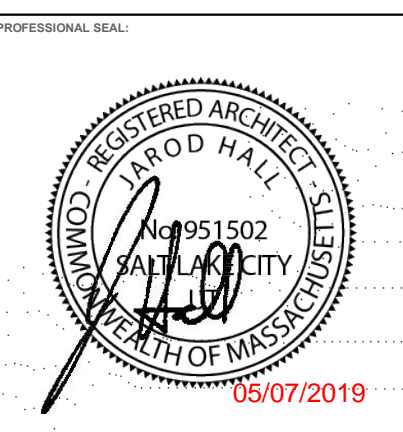

PROJECT ADDRESS:	8 WASHBURN NEW BEDFORD, MA 02740
ARCHITECT:	18-18
DATE:	JDH
PHASE:	INITIAL SUBMITTAL
DATE PUBLISHED:	07 MARCH 2019
SHEET SCALE:	As indicated

EXTERIOR ELEVATIONS

A201.2

DIVELEPT DESIGN LLC © 2019