Proposed Commercial/ Residential Development 117 Union Street New Bedford, MA 02740

DRAWING LIST			
NO.	DRAWING NAME	DATED	
CIVIL			
C-1	EXISTING CONDITIONS & DEMOLITION PLAN	MARCH 21, 2019	
C-2	SITE LAYOUT & UTILITIES PLAN	MARCH 21, 2019	
C-3	SITE DETAILS	MARCH 21, 2019	
C-4	SITE DETAILS	MARCH 21, 2019	
ARCHITECTURE			
A-101	FLOOR PLAN - LEVEL 1	MARCH 21, 2019	
A-102	FLOOR PLAN - LEVEL 2	MARCH 21, 2019	
A-103	FLOOR PLAN - LEVEL 3	MARCH 21, 2019	
A-104	FLOOR PLAN - LEVEL 4	MARCH 21, 2019	
A-105	FLOOR PLAN - LEVEL 5	MARCH 21, 2019	
A-106	ROOF PLAN	MARCH 21, 2019	
A-201	ELEVATIONS - NORTH & SOUTH	MARCH 21, 2019	
A-202	ELEVATIONS - EAST & WEST	MARCH 21, 2019	
A-211	BUILDING SECTIONS	MARCH 21, 2019	

ZONING TABLE

Mixed Use Business

Downtown Business Overlay District

New Bedford Landing Waterfront Historic Distric

	Existing	Allowed/Required	Proposed
Lot Area (sq ft)	10,173 s.f.	15,000 s.f.	10,173 s.f.
Lot Width (ft)	70 ft	0 s.f.	70 ft
Number of Dwelling Units Max.	0	No standard	42
Total Gross Floor Area (sq ft)	8,157 s.f.	N/A	42,650 s.f.
Residential Gross Floor Area (sq ft)	0 s.f.	N/A	33,265 s.f.
Non-Residential Gross Floor Area (sq ft)	8,157 s.f.	N/A	8,497s.f.
Building Height (ft)	15 ft	100 ft	61 ft
Front Setback (ft)	0 ft	0 ft	0 ft
Side Setback (ft)	N/A	10 ft	N/A
Side Setback (ft)	N/A	12 ft	N/A
Rear Setback (ft)	0 ft	30 ft	0 ft
Max. Lot Coverage by Buildings (% of Lot Area)	80.2%	40 %	91.6%
Min. Permeable Open Space (% of Lot Area)	0%	40%	0%
Min. Green Space (% of Lot Area)	0%	0%	0%
Off-Street Parking Spaces	5	106	1
Van Accessible Handicap	0	1	1
Long-Term Bicycle Parking Spaces	0	0	20
Short-Term Bicycle Parking Spaces	0	0	20
Loading Bays	0	2	0

PROJECT TEAM

DEVELOPER:

117 Union Street, LLC 128 Union Street, Fourth Floor New Bedford, MA 02740 Contact:

Michael Galasso tel: (619) 316-5895

email: mbgalasso@baronegalasso.com

ARCHITECT:


STANTEC Stantec Architecture and Engineering P.C. 311 Summer Street Boston, MA 02210-1723 Contact:

> Louis Kraft tel: (617) 234-3149 email: louis.kraft@stantec.com

ENGINEER:

PRIME ENGINEERING P.O. BOX 1088 Lakeville, MA 02347

> Richard Rheaume, P.E. tel: (508) 947-0050 email: rich@primeengineering.org

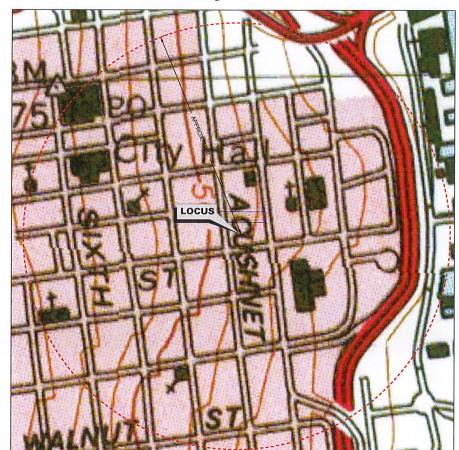



Registry of Deeds Book 1838 Page 1144 & Book 1707 Page 903 Owners: Paul A. Piva and Gail Florek


SITE LOCUS






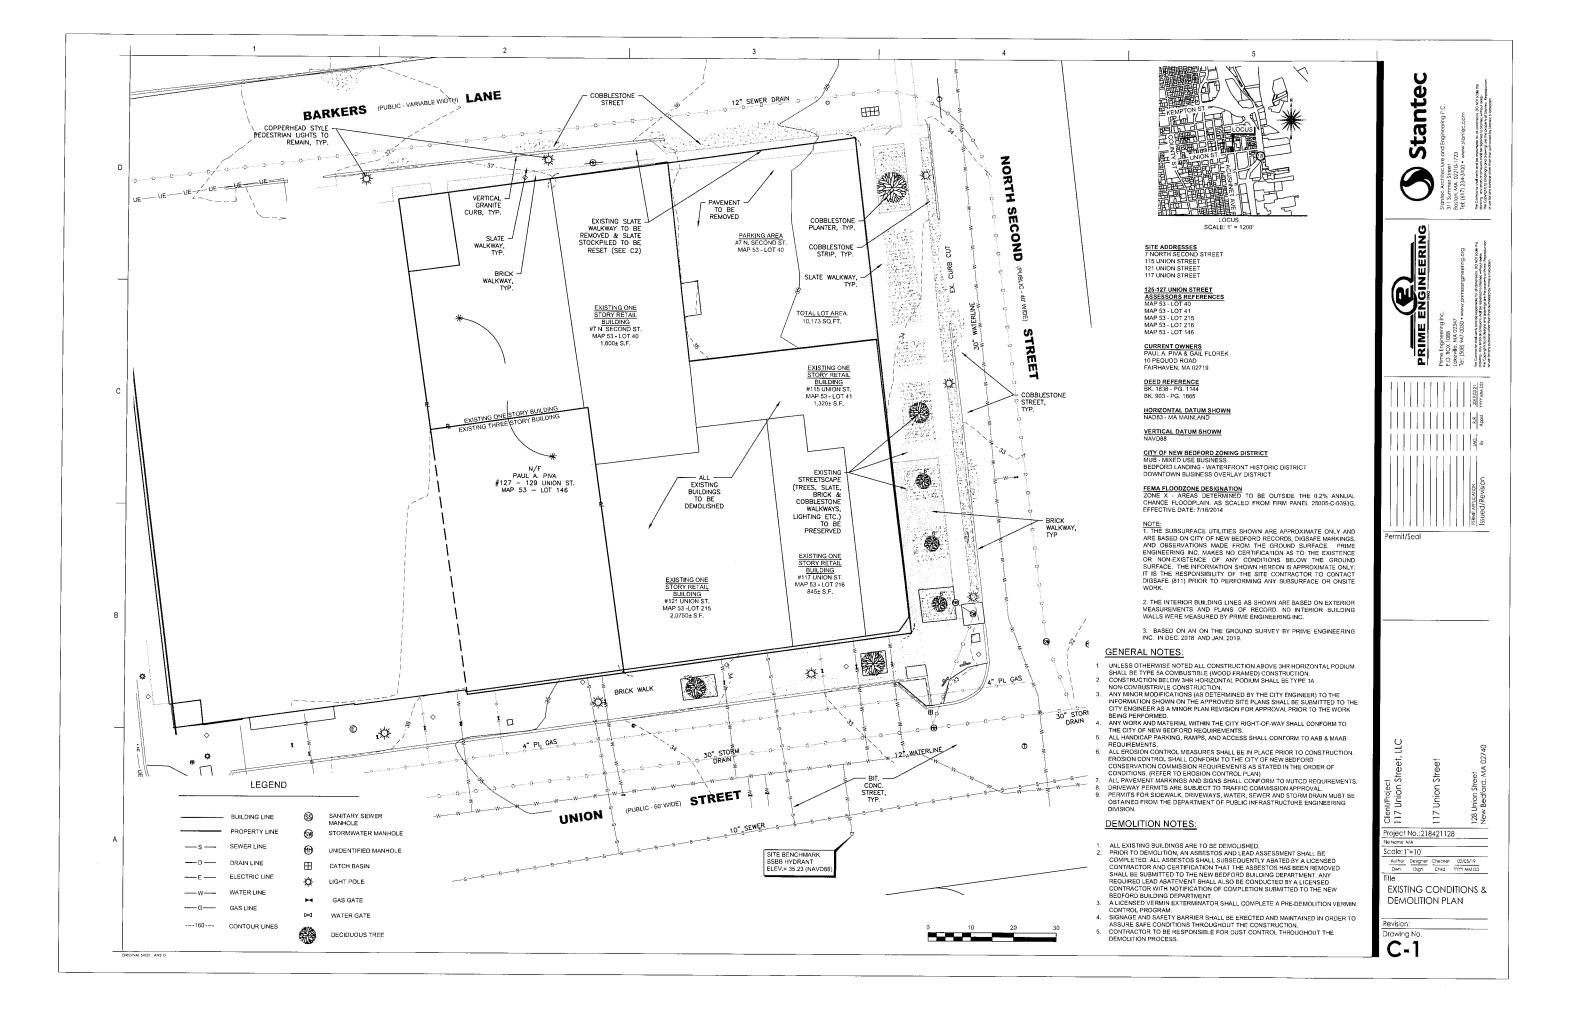

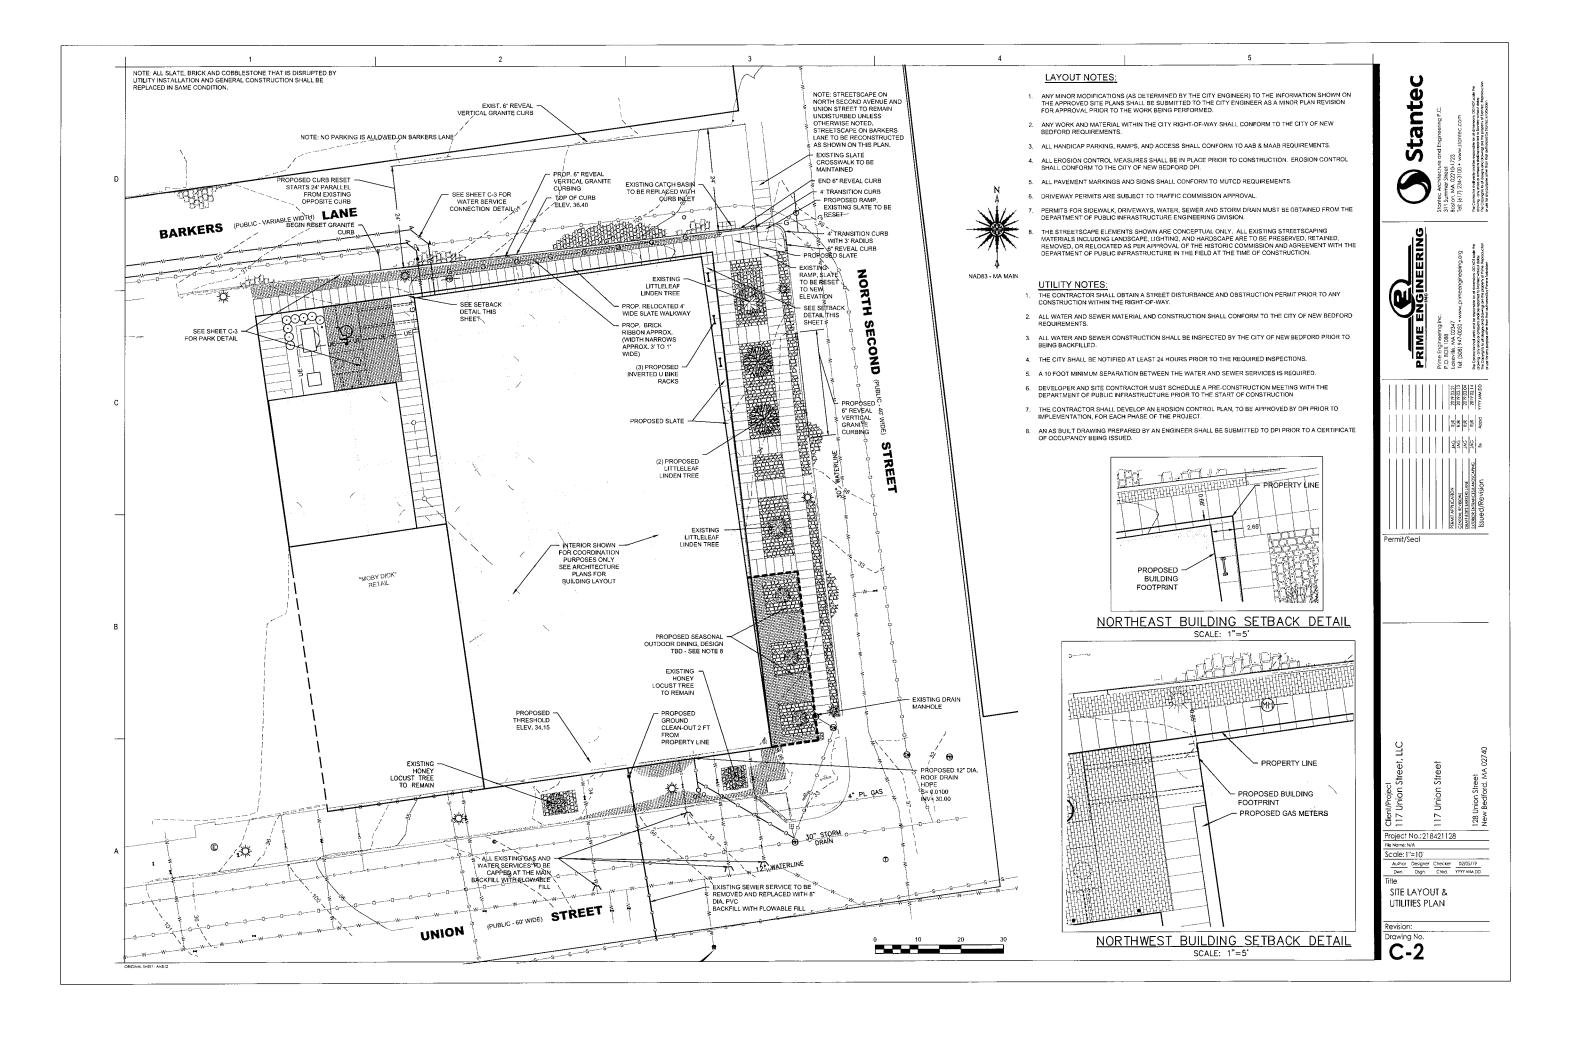

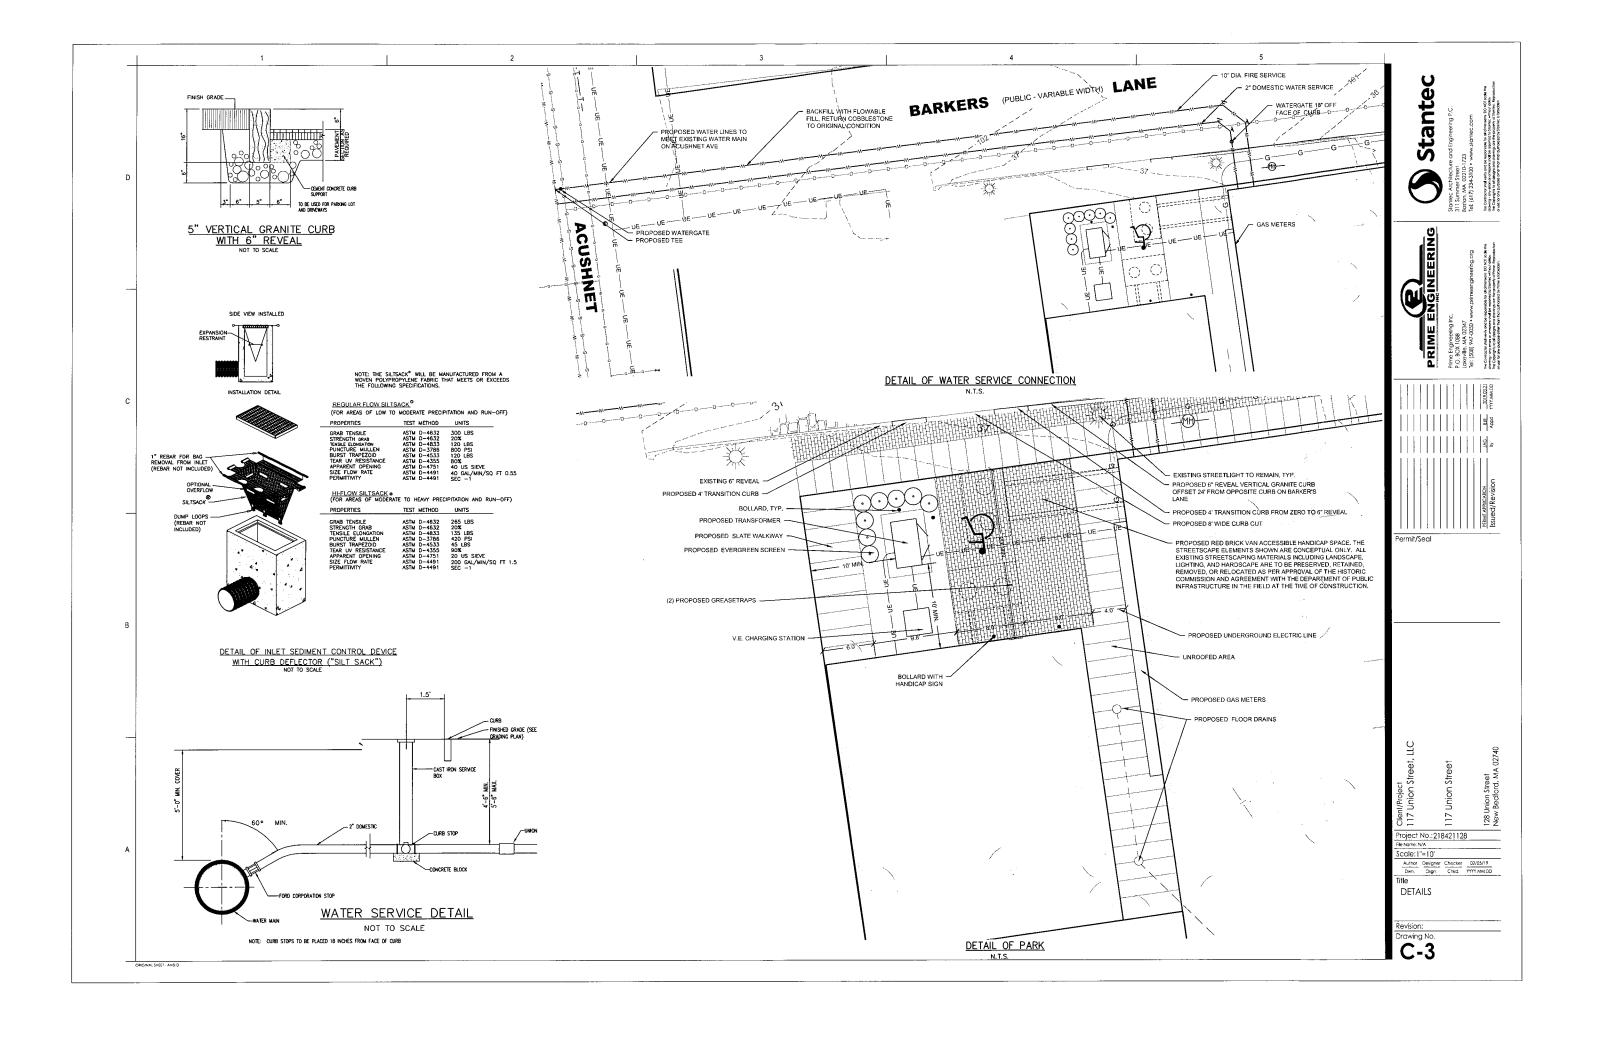

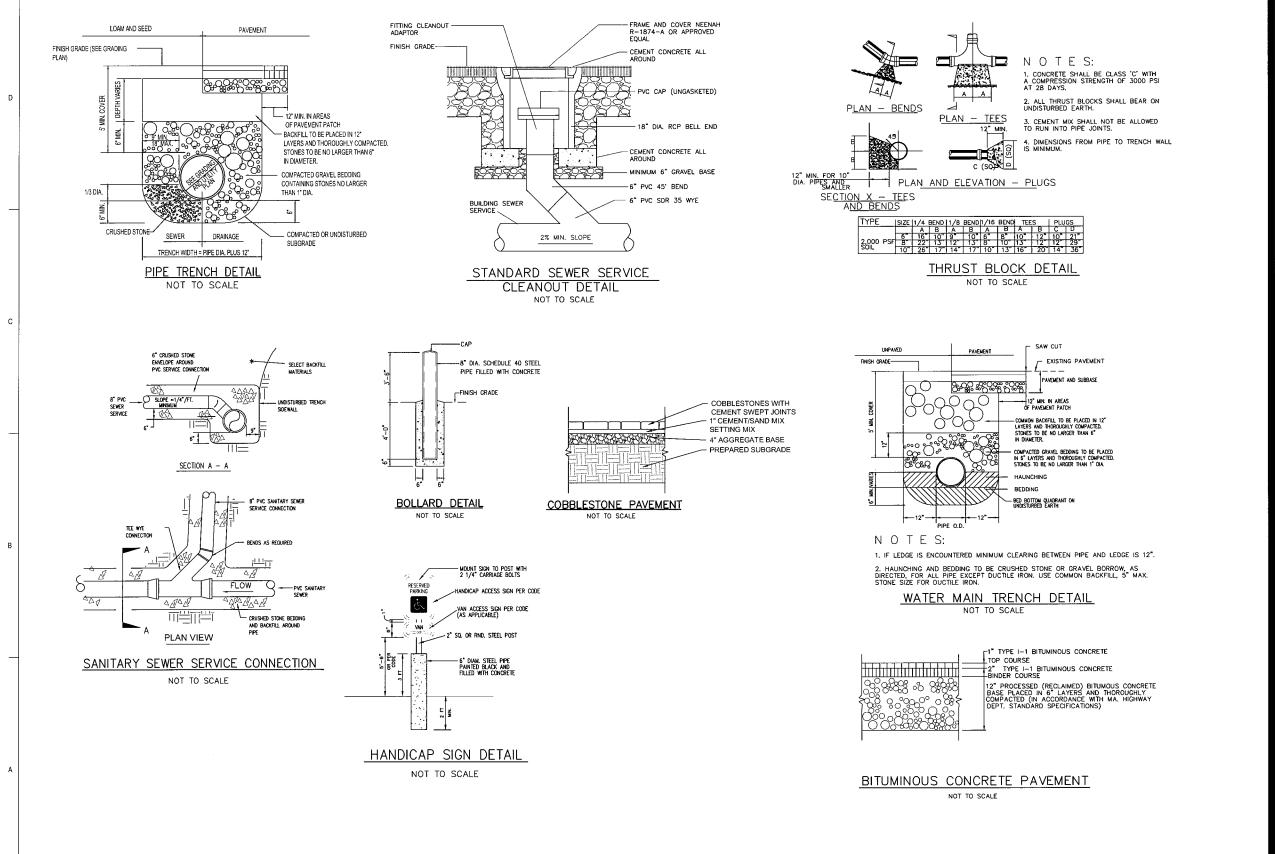


Stanted


§ 81


Project No.:218421128 Scale:1"=10"


DETAILS


Drawing No

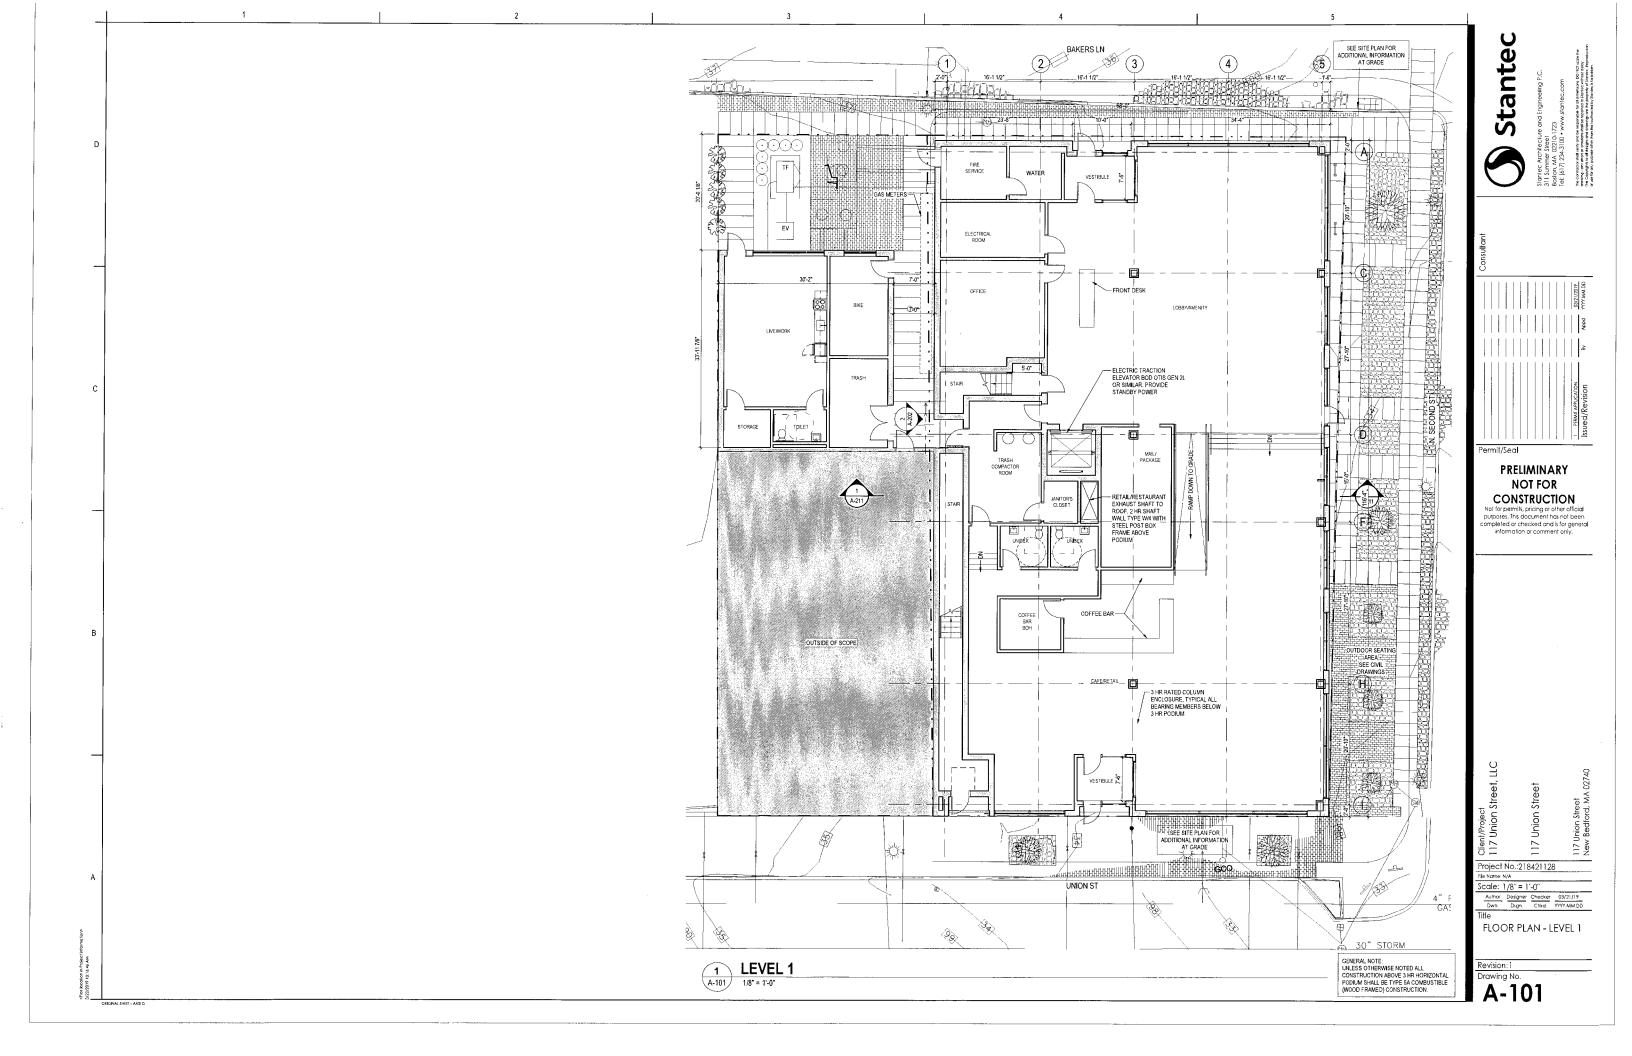


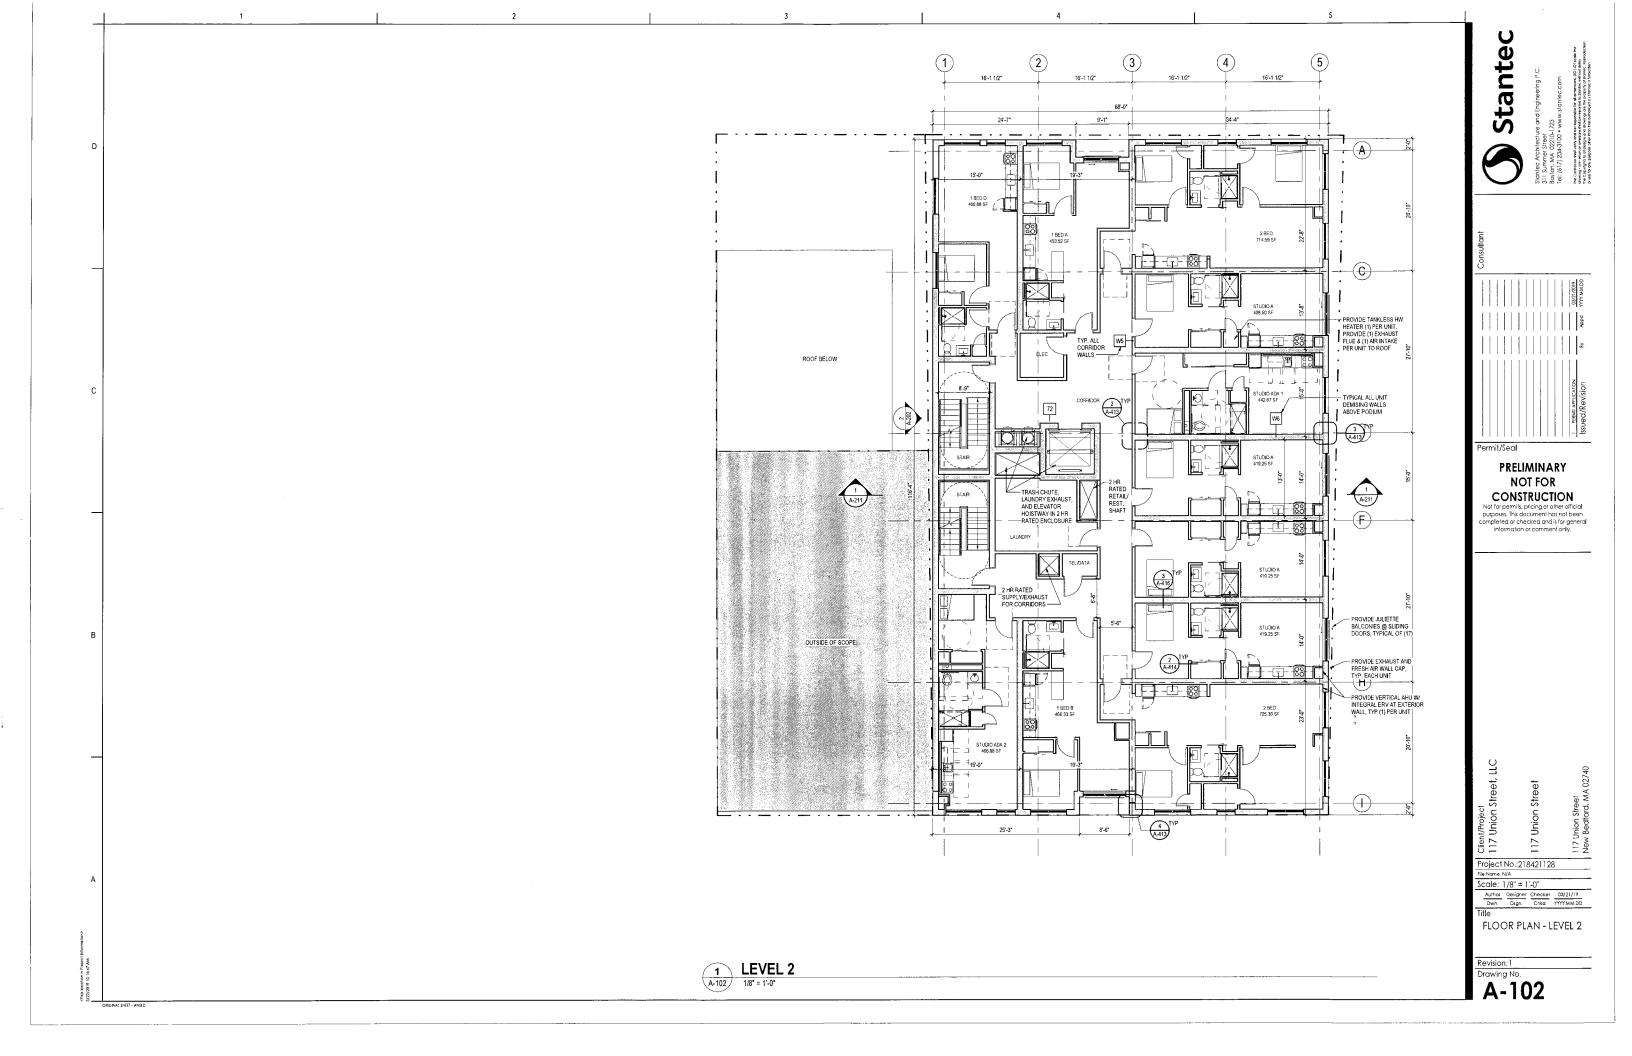

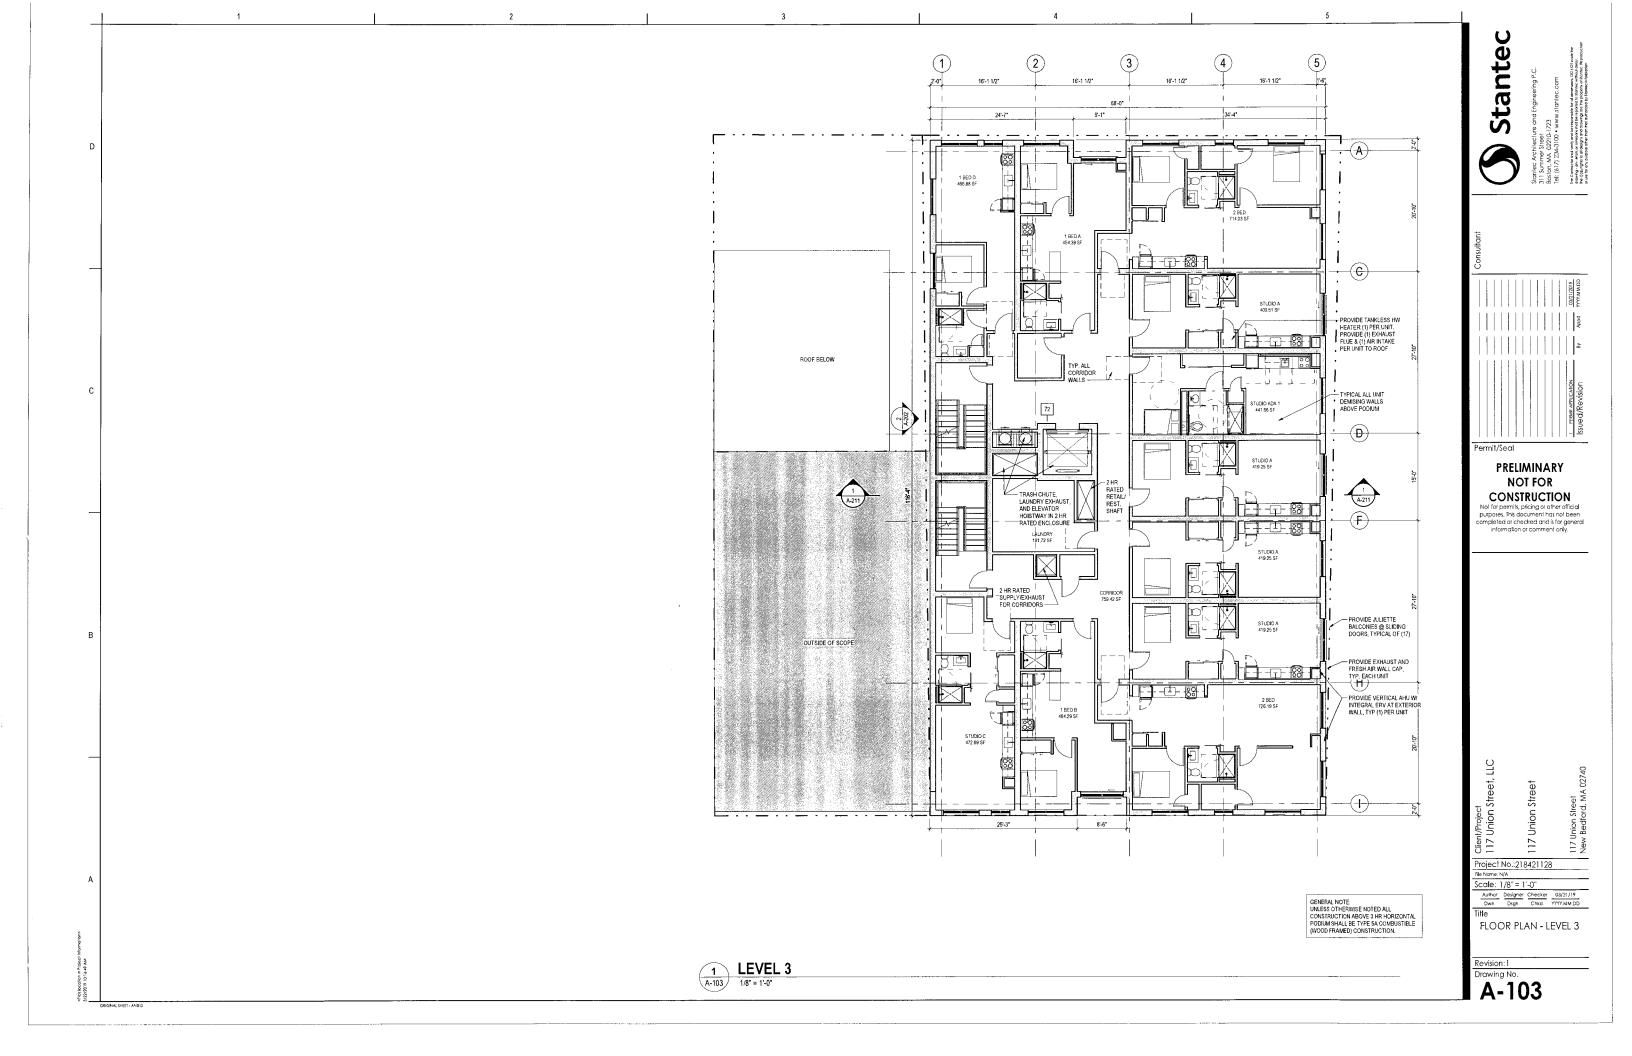

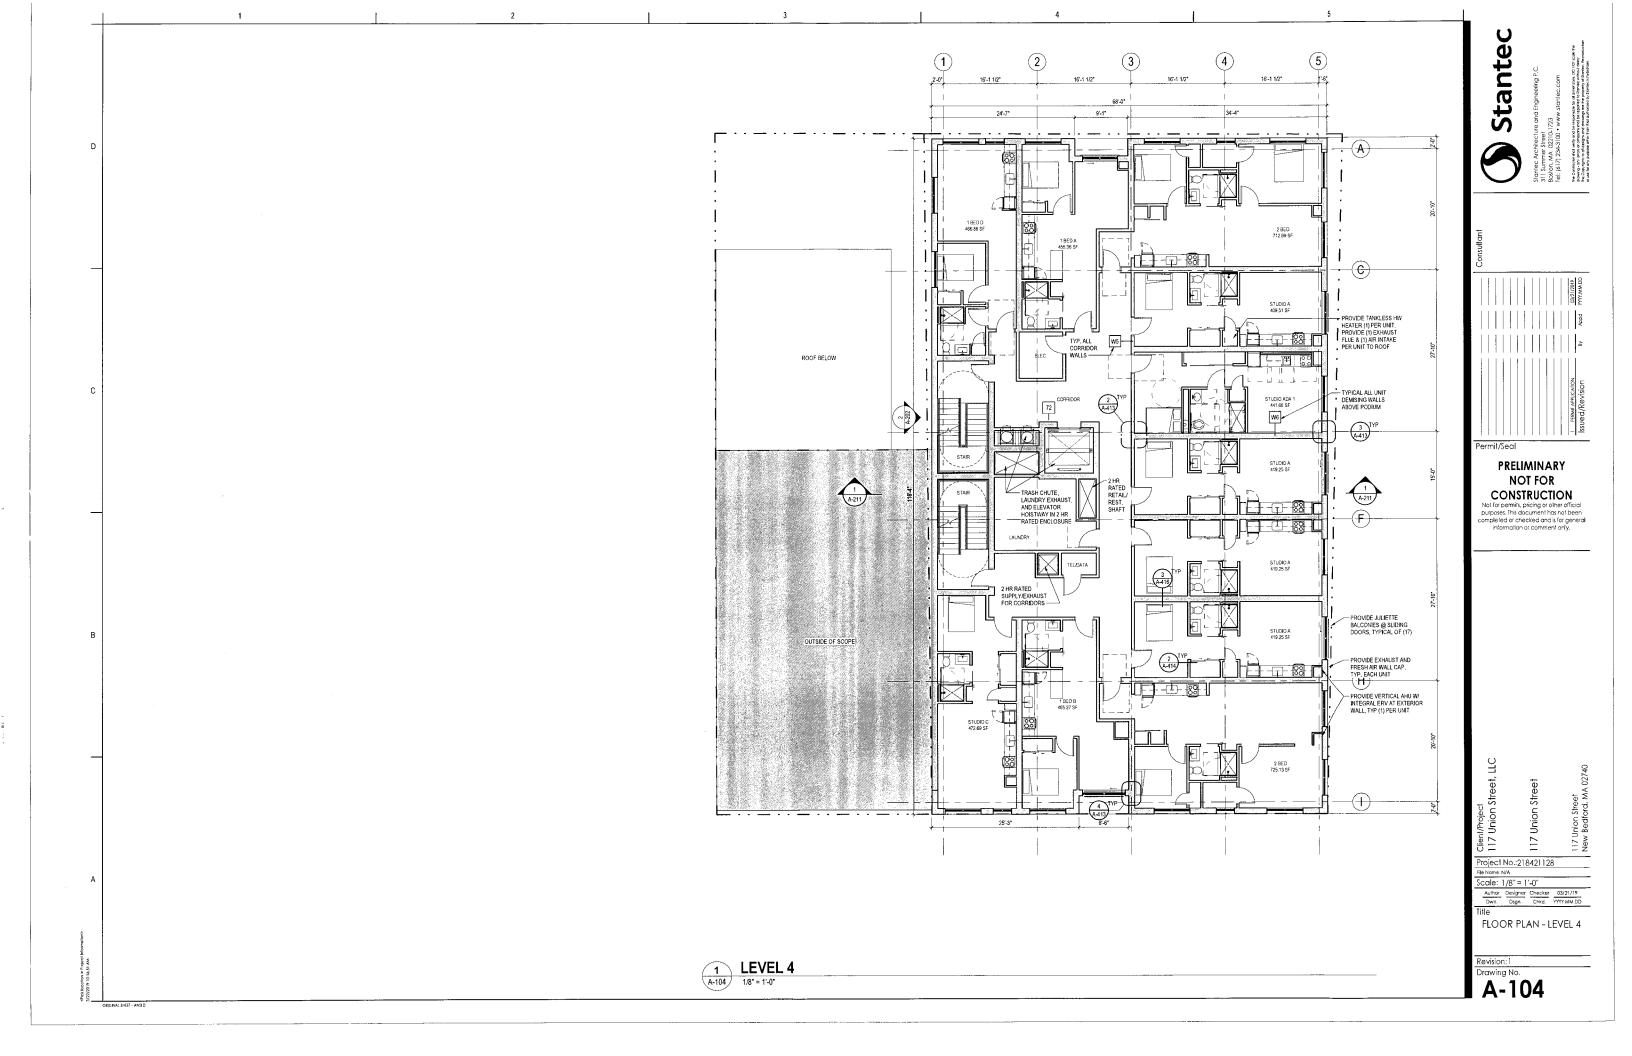

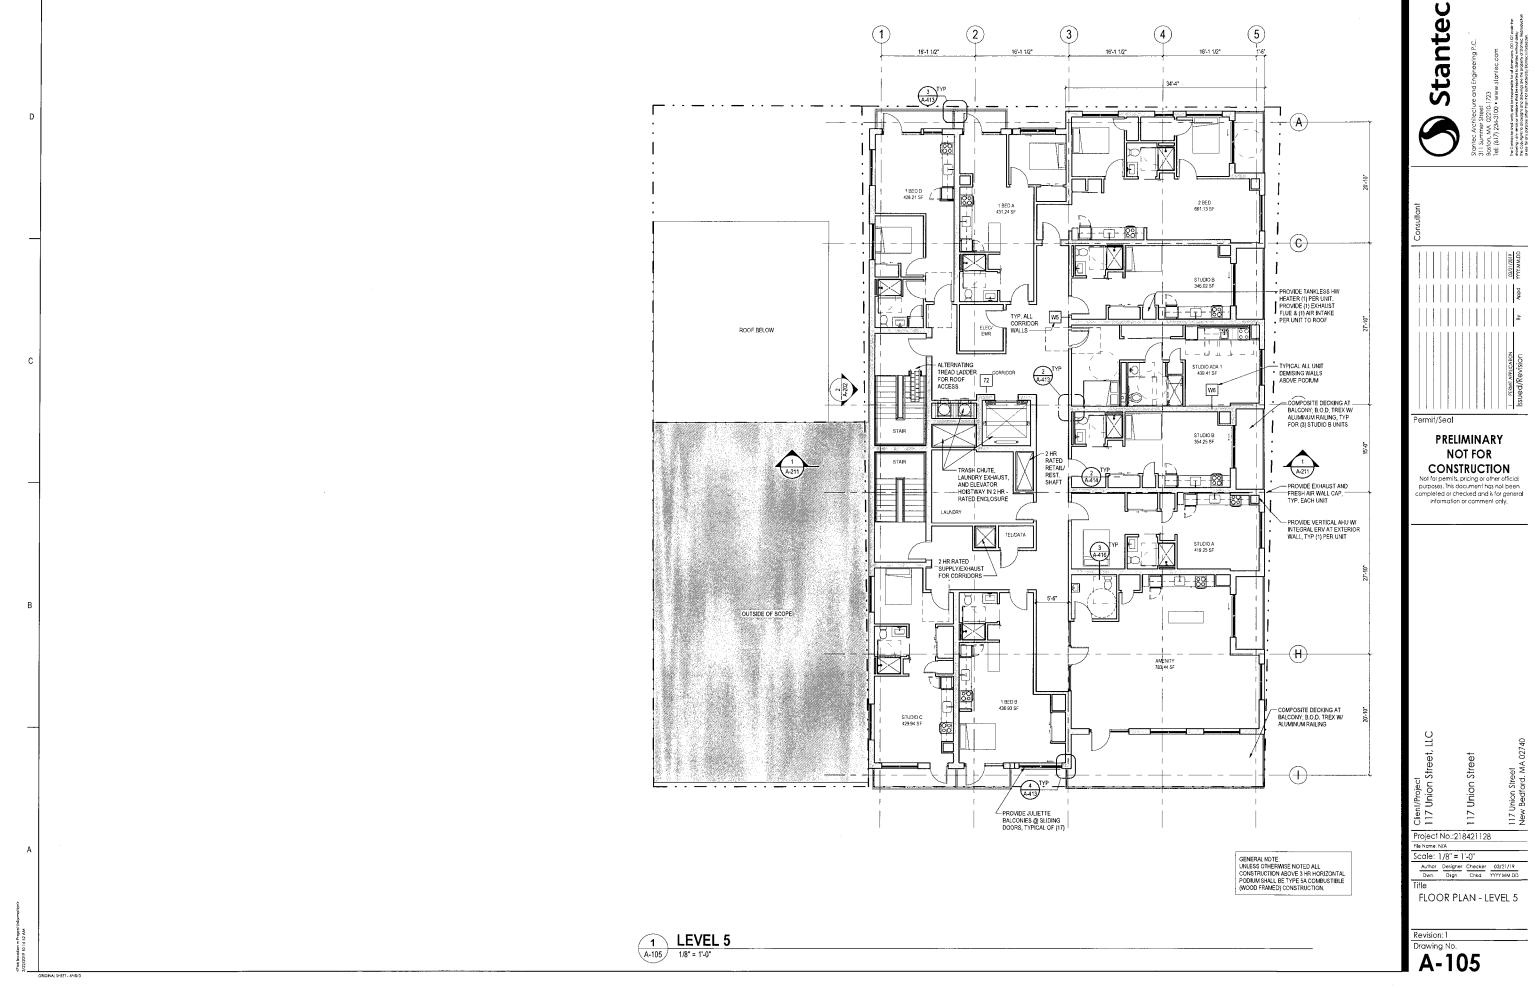

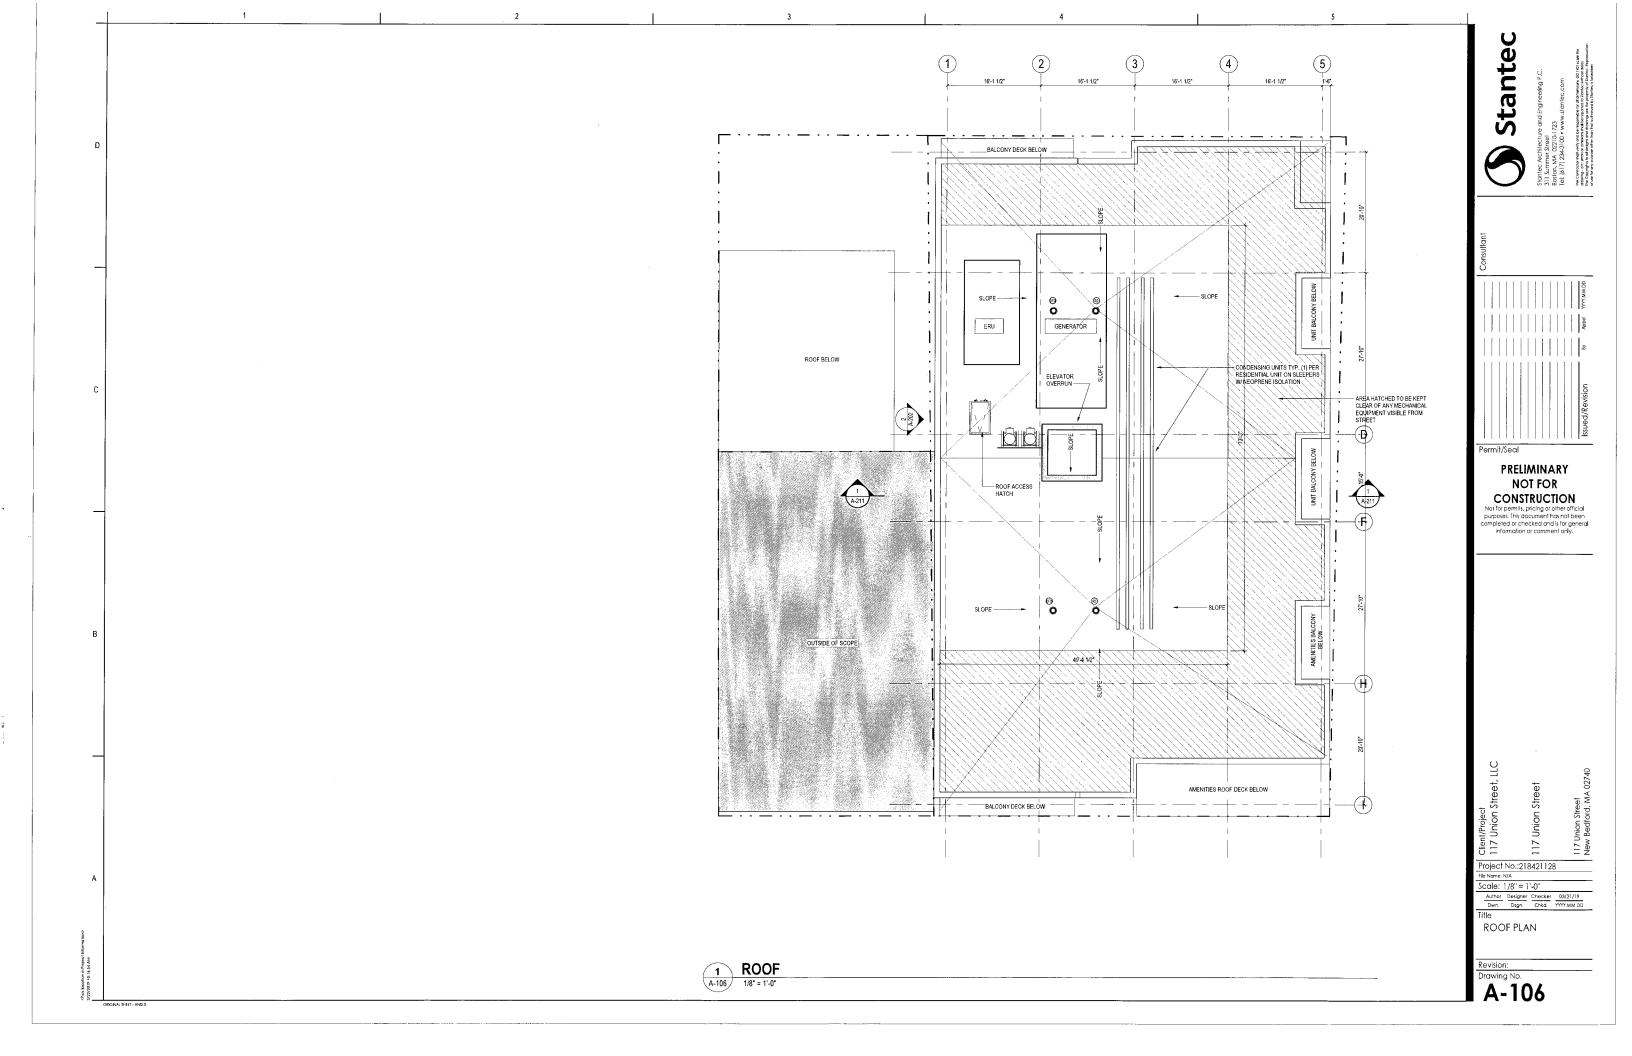



Stantec

Sta

Permit/Seal

PRELIMINARY NOT FOR CONSTRUCTION

Not for permits, pricing or other official purposes. This document has not been completed or checked and is for general information or comment only.

African Company

117 Union Street,

Project No.:218421128

Project No.:218421128
File Name: N/A

Scale: 1/8" = 1'-0"

Author Designer Checker 0:

 Author
 Designer
 Checker
 03/21/19

 Dwn.
 Dsgn.
 Chkd.
 YYYY.MM.DD

ELEVATIONS - NORTH & SOUTH

Revision: 1
Drawing No.

A-201



FIBER CEMENT PANEL TYPE FC-1 SEE PLANS FOR EXTERIOR WALL RECESS AT UPPER LEVEL COMPOSITE FIBER CEMENT RAINSCREEN
PANELS RETURN ON TO WEST FACADE
(NOT SHOWN); PRIMARY CLADDING
MATERIAL (EXCEPT FOR MASONRY
RETURNS AS NOTED) COLOR-FINISH FLANGED FIBERGLASS PATIO — DOOR BASIS OF DESIGN: FIBER FRAME COMFORT LINE 2101 MATCH TO SW 7675V SEALSKIN: PERFORMANCE GRADE 30 - ALUMINUM JULIET BALCONY RAILING SYSTEM, ARCHITECTURAL GRADE; POWDER COAT FINISH LOW-E ARGON GLAZING NO JULIET RAILING AT UPPER LEVEL DECK LEVEL 4 FACE BRICK MASONRY VENEER CLADDING, MODULAR SIZE, BASIS OF DESIGN BELDEN MODULAR CONCORD BLEND A, MODIFIED 14-22 ALUMINUM JULIET BALCONY RAILING SYSTEM, ARCHITECTURAL GRADE; POWDER COAT FINISH DOOR BASIS OF DESIGN: FIBER FRAME
COMFORT LINE 2100 MATCH TO SW 7515
HOMESTEAD BROWN, PERFORMANCE GRADE
30; LOW-E ARGON GLAZING - COLOR FINISH FLANGED SINGLE-HUNG FIBERGLASS WINDOW INCLUDES STUD POCKET BASIS OF DESIGN: FIBER FRAME SIGNAGE EXTENTS TBD -COMFORT LINE 2101 MATCH TO SW 7515 HOMESTEAD BROWN PERFORMANCE GRADE 5
LOW-E ARGON GLAZING FOOD RETAIL ENTRY PORTAL BEYOND -AND DECEMBER OF - ALUMINUM STOREFRONT SYSTEM BASIS OF DESIGN: KAWNEER PERMAFLOUR - UC 109850 CLASSIC BRONZE; GLAZING BASIS OF DESIGN SOLARBAN 60 CLEAR

1 ELEVATION - EAST
1/8" = 1'-0"

A-202 1/8" = 1'-0"

Stantec



Consultant

| FEBUIL APPLICATION | SQUITTOPS |

PRELIMINARY NOT FOR CONSTRUCTION

Permit/Seal

Not for permits, pricing or other official purposes. This document has not been completed or checked and is for general information or comment only.

ent/Project 7 Union Street, LLC

Project No.:218421128

Scale: 1/8" = 1'-0"

Author Designer Checker 03/21/19
Dsgn. Chkd. YYYY.MM.DD

Title

ELEVATIONS - EAST & WEST

Revision: 1
Drawing No.

A-202

k location in Project Information> 72019 10:17:01 AM

ORIGINAL SHEET - ANSI D

