Proposed Commercial/ Residential Development 117 Union Street New Bedford, MA 02740

DRAWING LIST			
NO.	DRAWING NAME	DATED	
CIVIL			
C-1	EXISTING CONDITIONS & DEMOLITION PLAN	FEB. 1, 2019	
C-2	SITE LAYOUT & UTILITIES PLAN	FEB. 1, 2019	
C-3	SITE DETAILS	FEB. 1, 2019	
C-4	SITE DETAILS	FEB. 1, 2019	
ARCHITECTURE			
A-101	FLOOR PLAN - LEVEL 1 & LEVEL 2	FEB. 1, 2019	
A-102	FLOOR PLAN - LEVEL 3 & LEVEL 4	FEB. 1, 2019	
A-103	LEVEL 5 & ROOF	FEB. 1, 2019	
A-201	ELEVATIONS - NORTH & SOUTH	FEB. 1, 2019	
A-202	ELEVATIONS - EAST & WEST	FEB. 1, 2019	
A-211	BUILDING SECTIONS	FEB. 1, 2019	

	Existing	Allowed/Required	Proposed
Lot Area (sq ft)	8,200 s.f.	15,000 s.f.	8,200 s.f.
Lot Width (ft)	70 ft	0 s.f.	70 ft
Number of Dwelling Units Max.	0	No standard	42
Total Gross Floor Area (sq ft)	6,130 s.f.	N/A	41,000 s.f.
Residential Gross Floor Area (sq ft)	0 s.f.	N/A	32,600 s.f
Non-Residential Gross Floor Area (sq ft)	6,180 s.f.	N/A	8,200 s.f.
Building Height (ft)	15 ft	100 ft	61 ft
Front Setback (ft)	0 ft	0 ft	0 ft
Side Setback (ft)	N/A	10 ft	N/A

Mixed Use Business

Short-Term Bicycle Parking Spaces

11,000 s.f. Side Setback (ft) 100% Max. Lot Coverage by Buildings (% of Lot Area) 74.8% Min. Permeable Open Space (% of Lot Area) 0% Min. Green Space (% of Lot Area) Off-Street Parking Spaces Long-Term Bicycle Parking Spaces 20

20

PROJECT TEAM

DEVELOPER:

117 Union Street, LLC 128 Union Street, Fourth Floor New Bedford, MA 02740 Contact:

Michael Galasso tel: (619) 316-5895 email: mbgalasso@baronegalasso.com

ARCHITECT:


STANTEC Stantec Architecture and Engineering P.C. 311 Summer Street Boston, MA 02210-1723 Contact:

> Louis Kraft tel: (617) 234-3149 email: louis.kraft@stantec.com

ENGINEER:

PRIME ENGINEERING P.O. BOX 1088 Lakeville, MA 02347 Contact:

> Richard Rheaume, P.E. tel: (508) 947-0050 email: rich@primeengineering.org

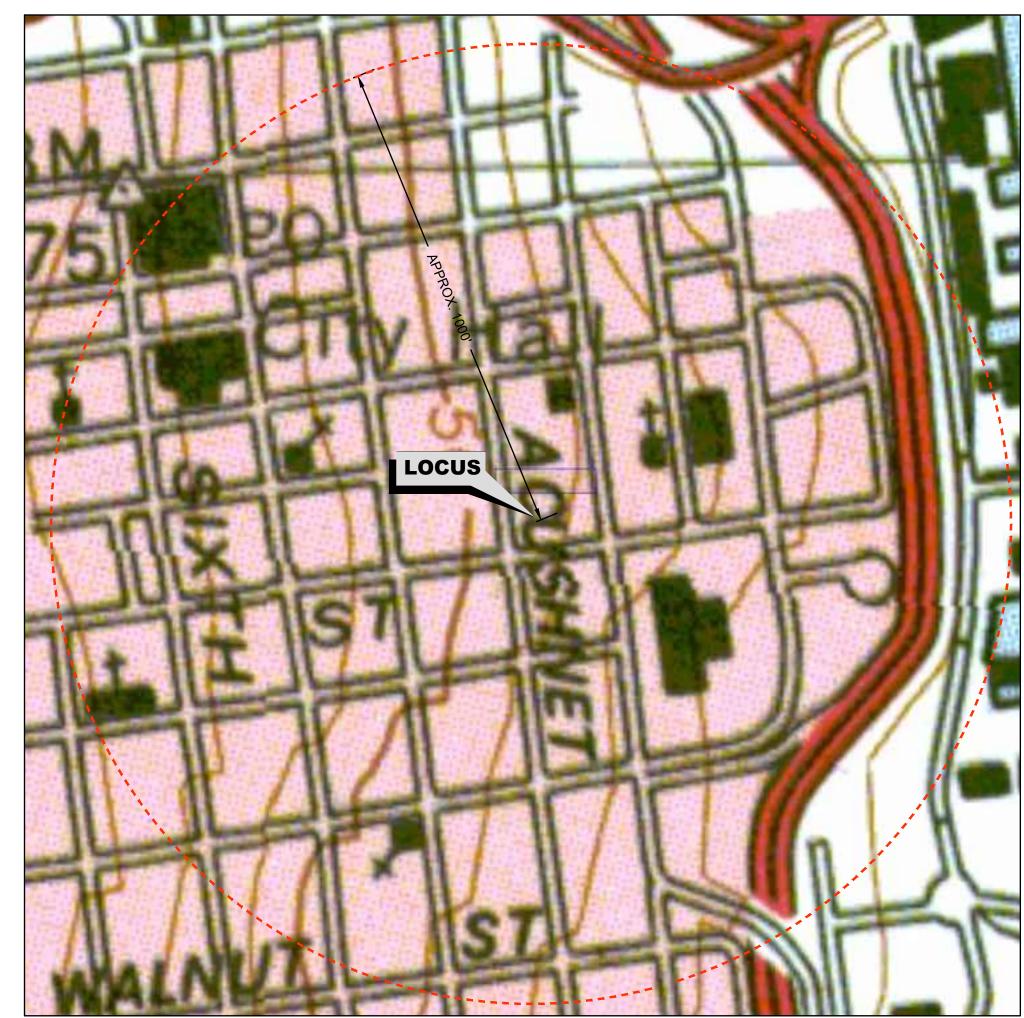


Site Locus is 117 Union Street
Assessor's Map 53, Lots 40, 41, 215 & 216
Registry of Deeds Book 1838 Page 1144
Owners: Paul A. Piva and Gail Florek


SITE LOCUS






February 1, 2019

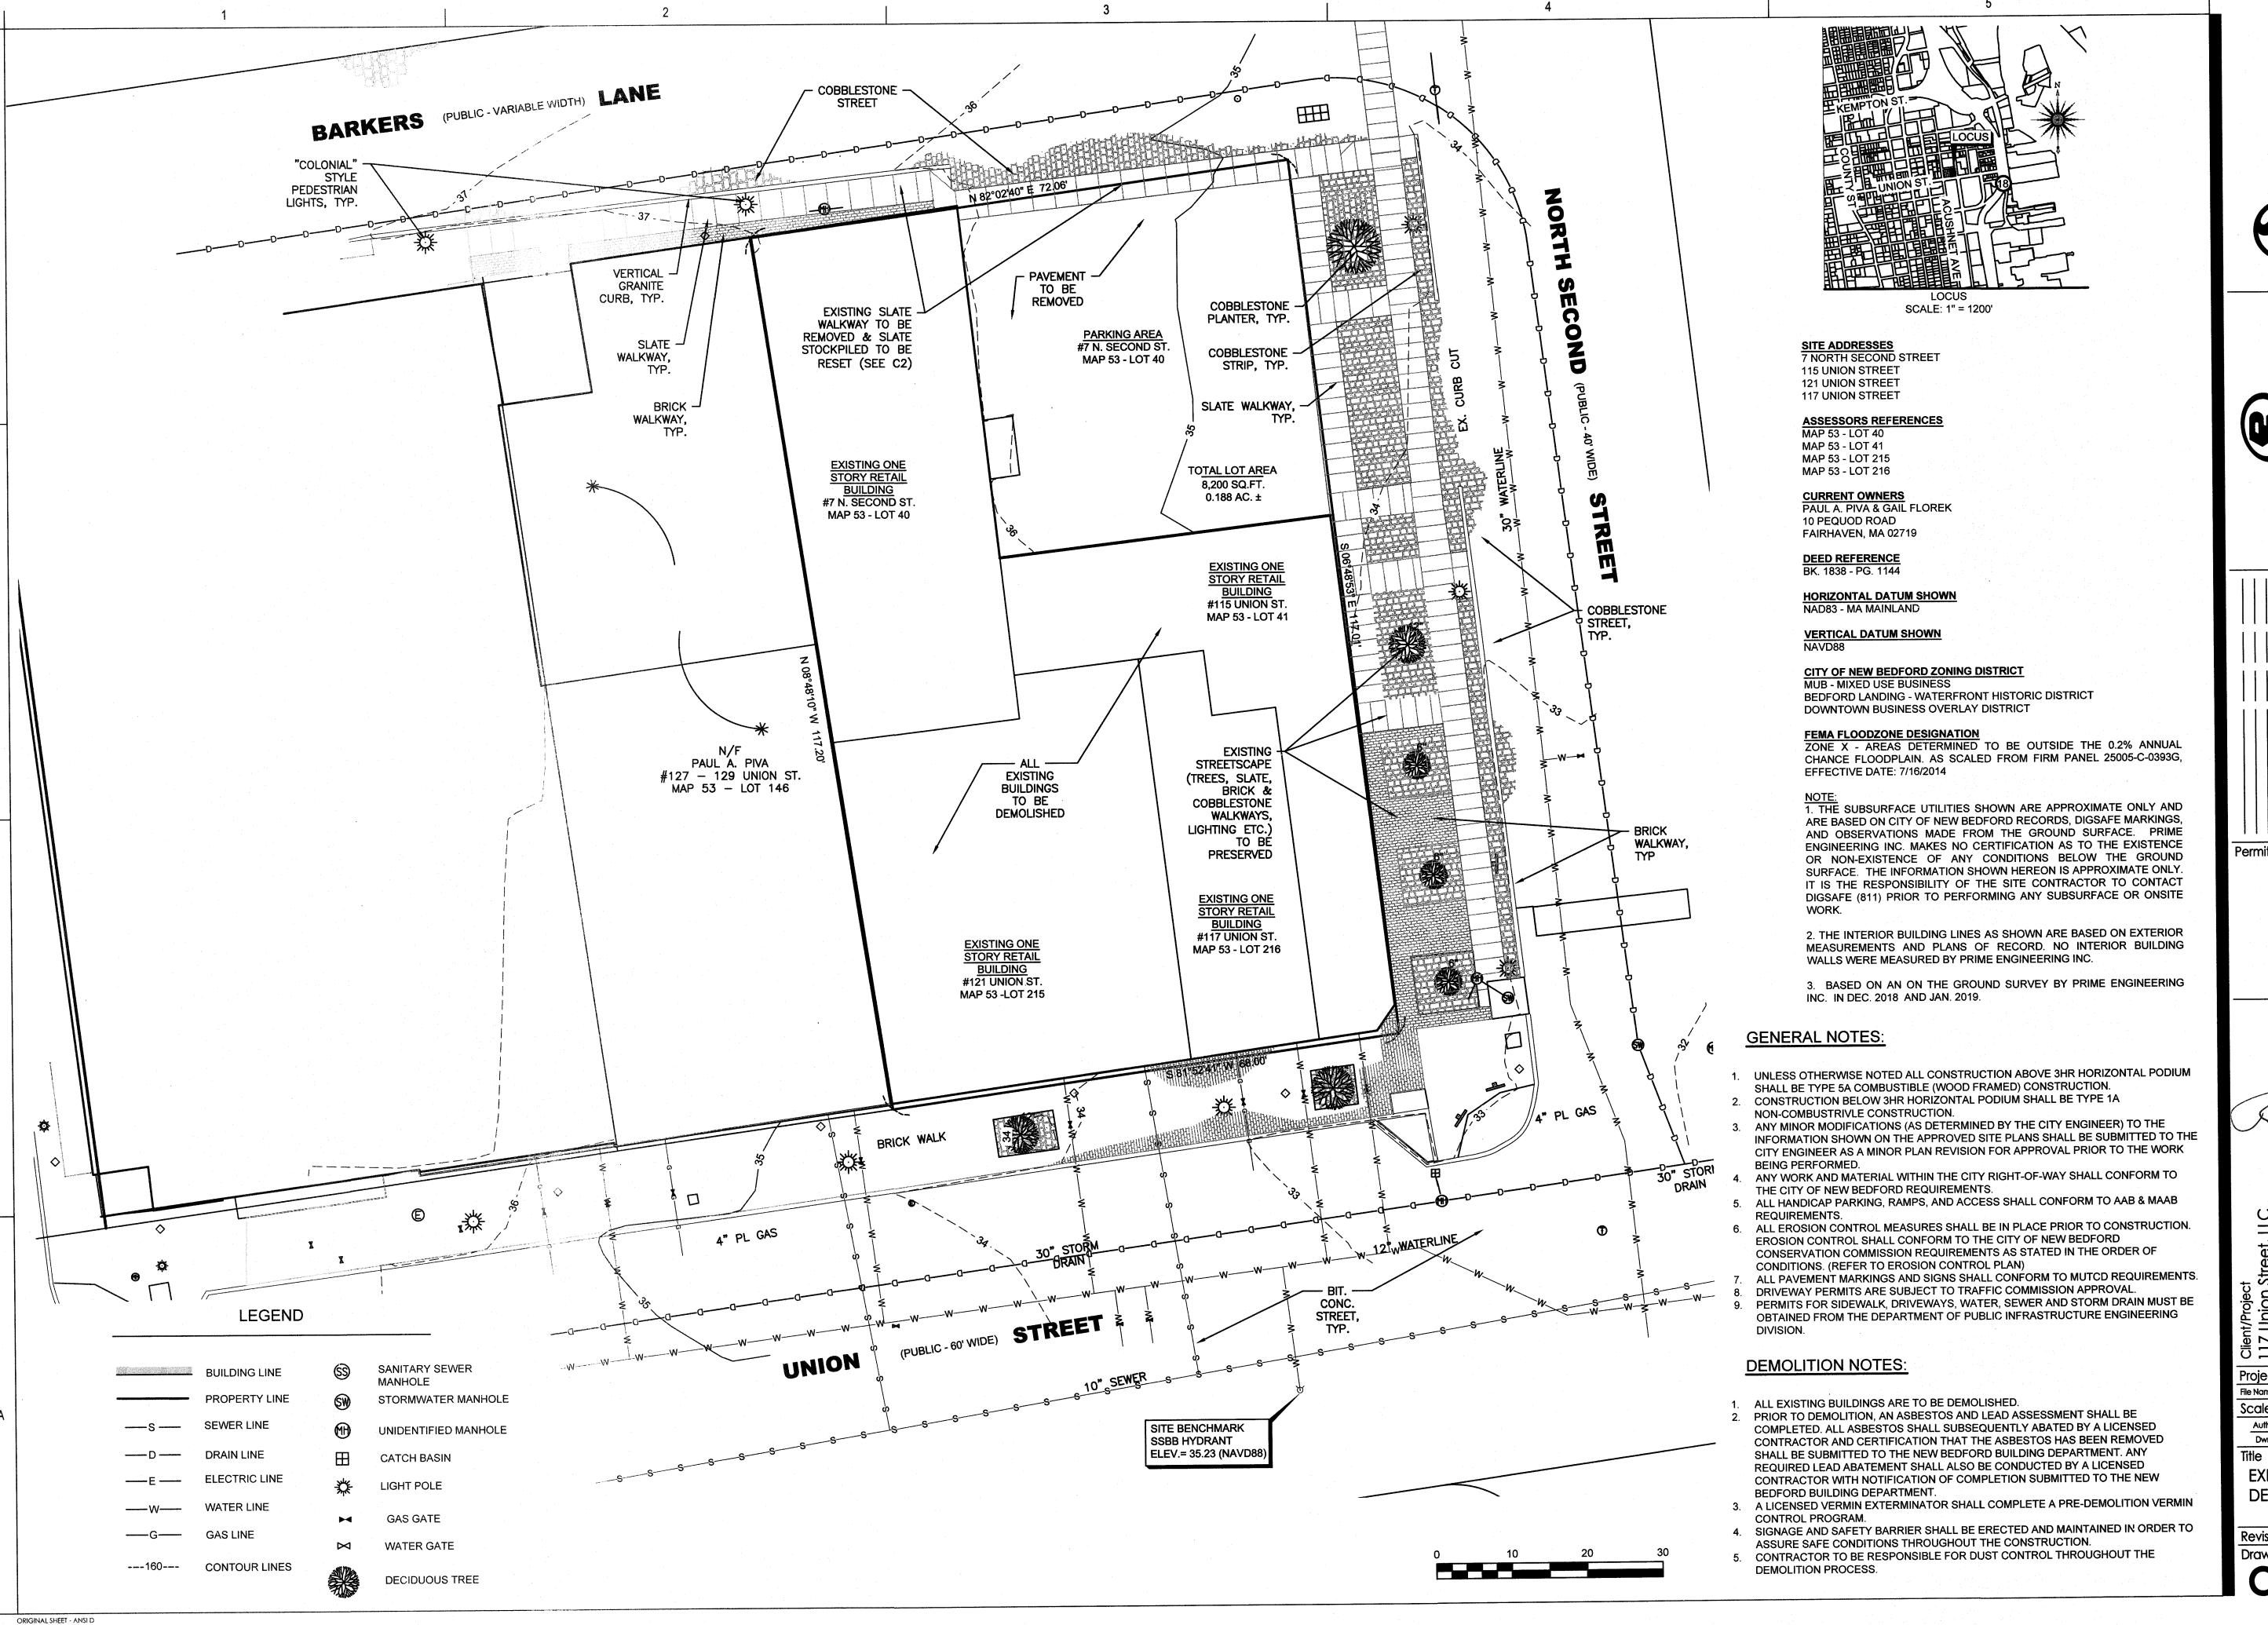

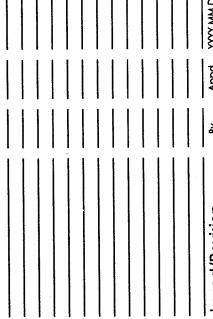

ISSUED FOR **PERMIT**

FEB. 1, 2019

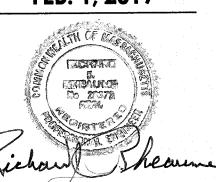


Project No.:218421128 File Name: N/A

Scale:1"=10"

Author Designer Checker 02/05/19 Dwn. Dsgn. Chkd. YYYY.MM.DD

EXISTING CONDITIONS & DEMOLITION PLAN

Revision: Drawing No.

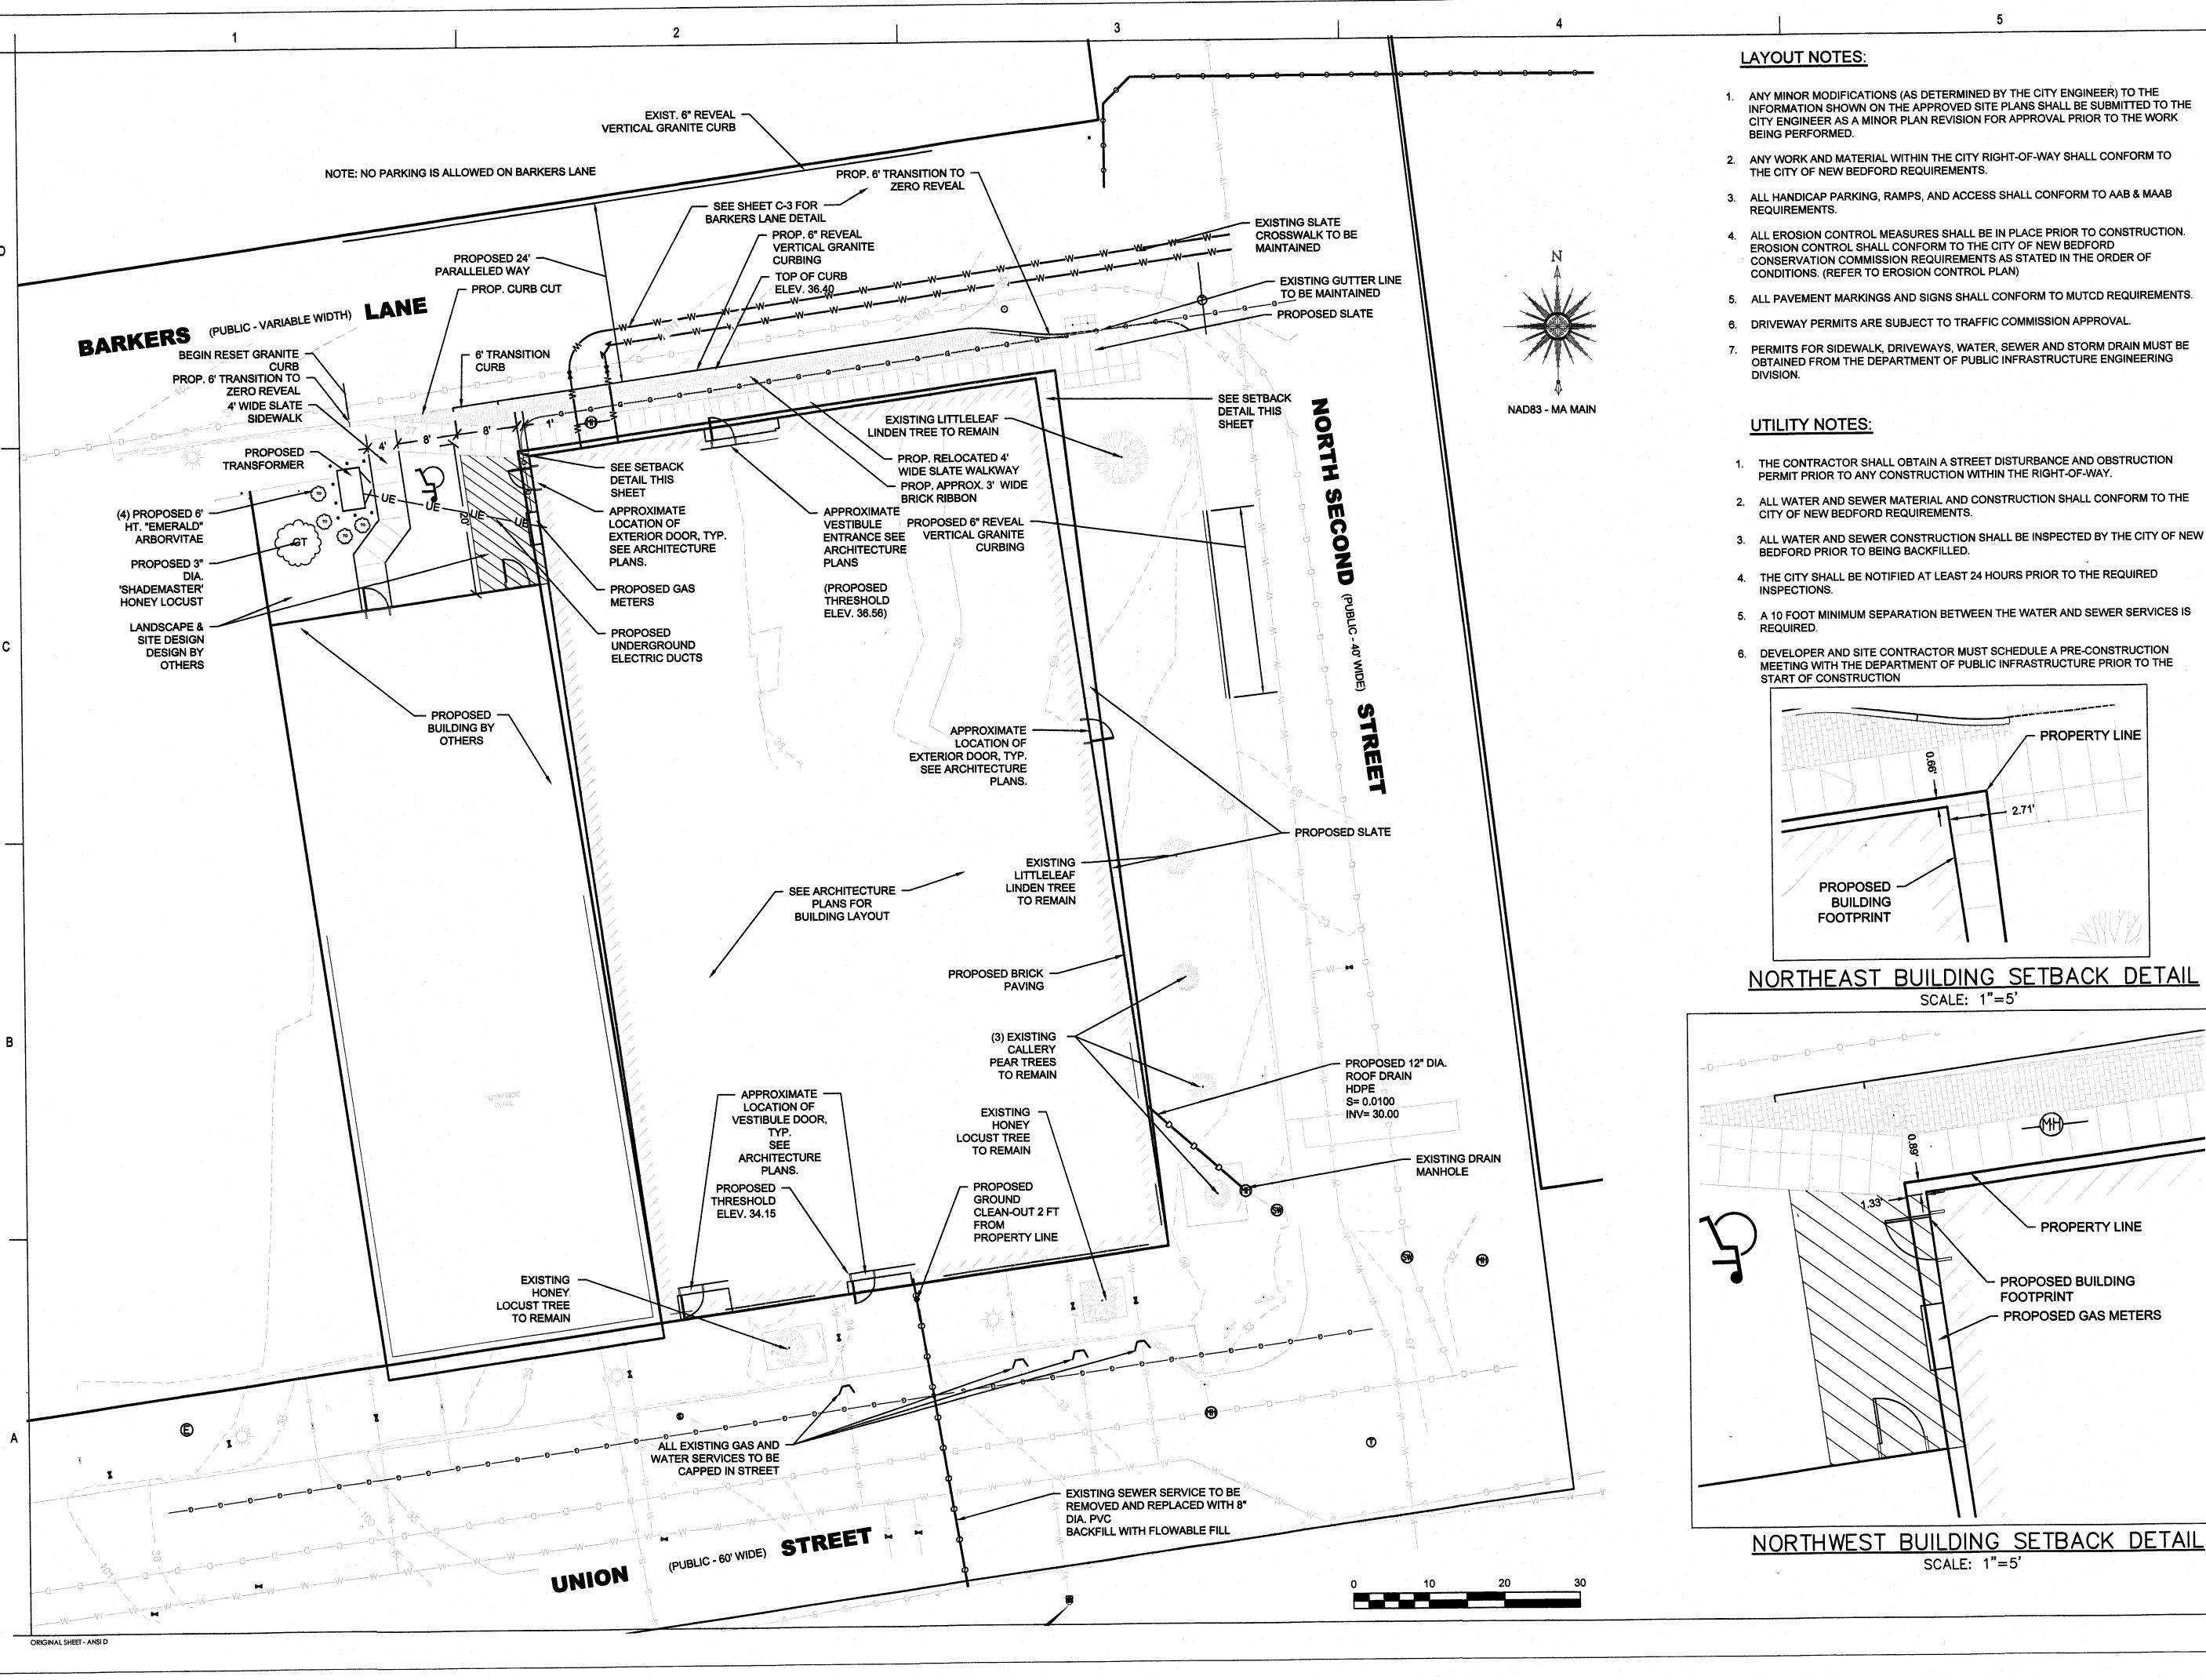


ANY MINOR MODIFICATIONS (AS DETERMINED BY THE CITY ENGINEER) TO THE INFORMATION SHOWN ON THE APPROVED SITE PLANS SHALL BE SUBMITTED TO THE CITY ENGINEER AS A MINOR PLAN REVISION FOR APPROVAL PRIOR TO THE WORK

4. ALL EROSION CONTROL MEASURES SHALL BE IN PLACE PRIOR TO CONSTRUCTION. EROSION CONTROL SHALL CONFORM TO THE CITY OF NEW BEDFORD CONSERVATION COMMISSION REQUIREMENTS AS STATED IN THE ORDER OF


7. PERMITS FOR SIDEWALK, DRIVEWAYS, WATER, SEWER AND STORM DRAIN MUST BE OBTAINED FROM THE DEPARTMENT OF PUBLIC INFRASTRUCTURE ENGINEERING

- 1. THE CONTRACTOR SHALL OBTAIN A STREET DISTURBANCE AND OBSTRUCTION

- 5. A 10 FOOT MINIMUM SEPARATION BETWEEN THE WATER AND SEWER SERVICES IS
- 6. DEVELOPER AND SITE CONTRACTOR MUST SCHEDULE A PRE-CONSTRUCTION MEETING WITH THE DEPARTMENT OF PUBLIC INFRASTRUCTURE PRIOR TO THE

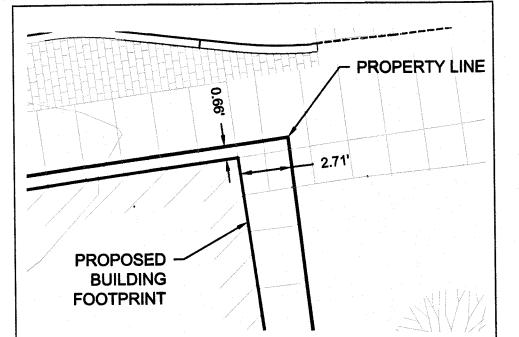

NORTHEAST BUILDING SETBACK DETAIL

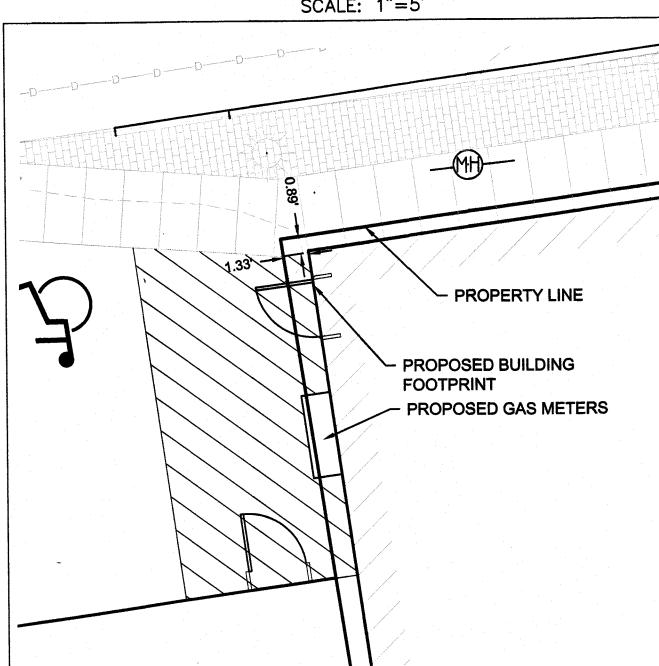

Permit/Seal

ISSUED FOR

PERMIT

FEB. 1, 2019




Project No.:218421128 ile Name: N/A Scale:1"=10'


Author Designer Checker 02/05/19


Dwn. Dsgn. Chkd. YYYY.MM.DD SITE LAYOUT & **UTILITIES PLAN**

Revision:


Drawing No.

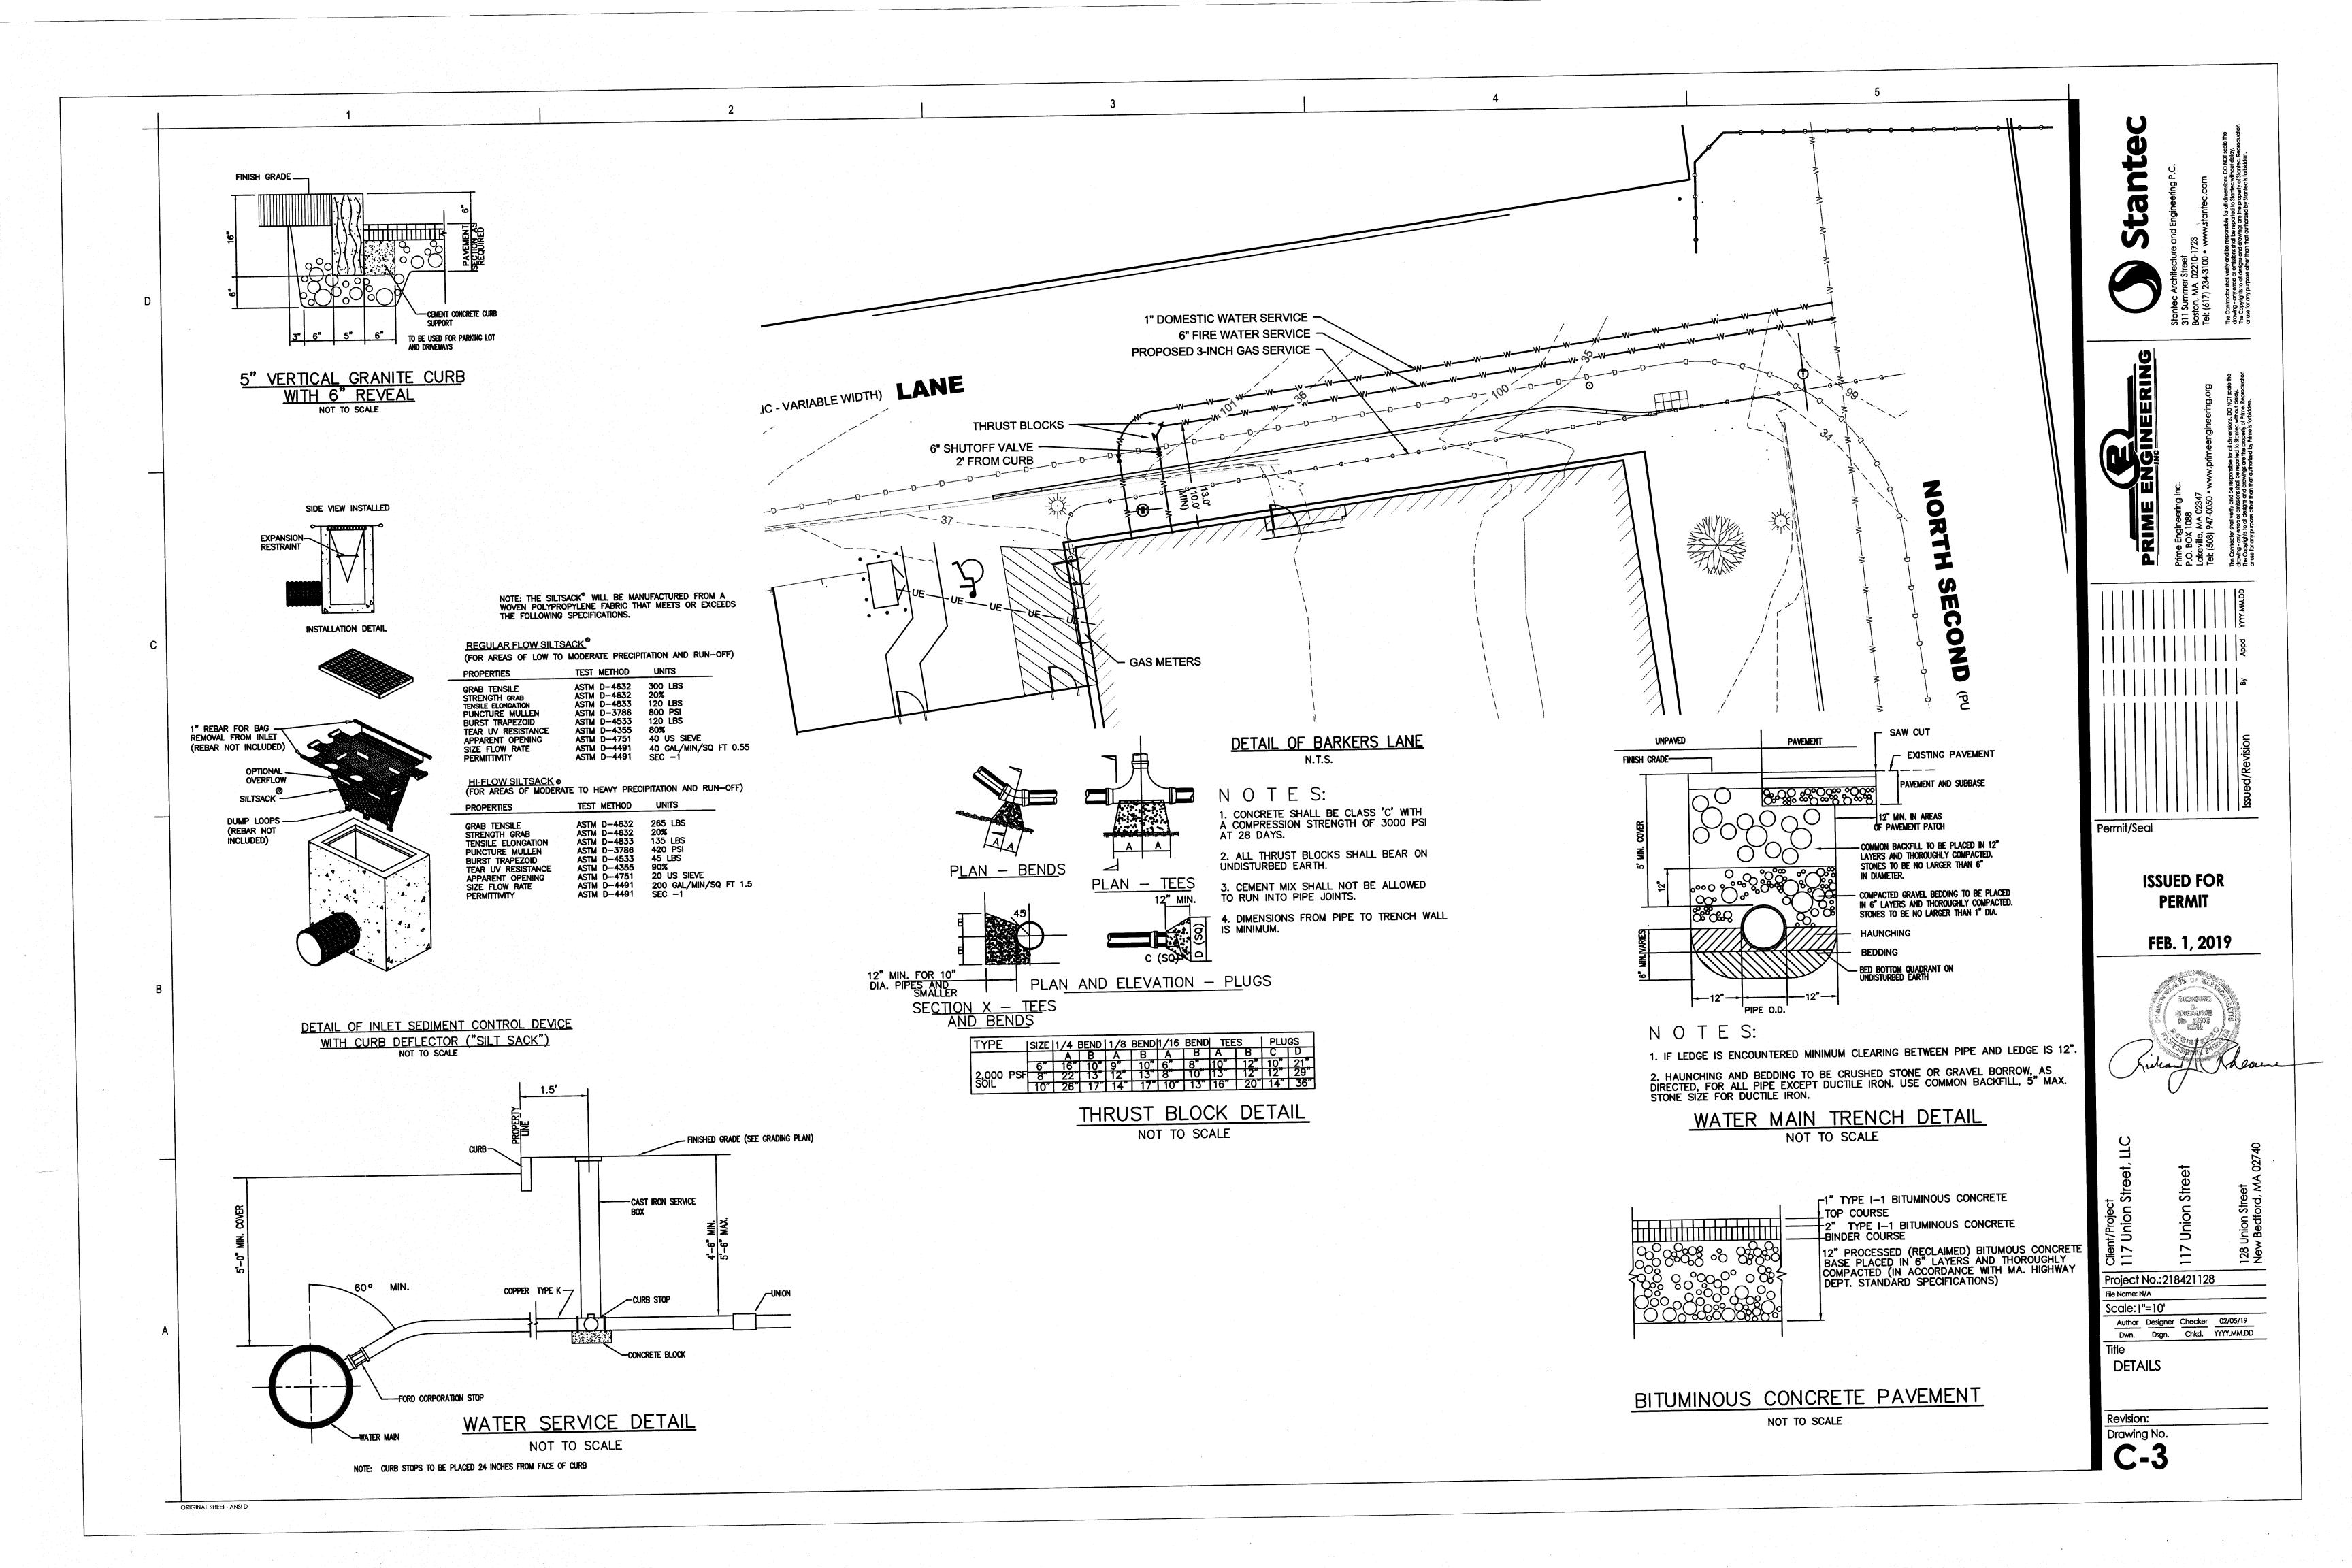

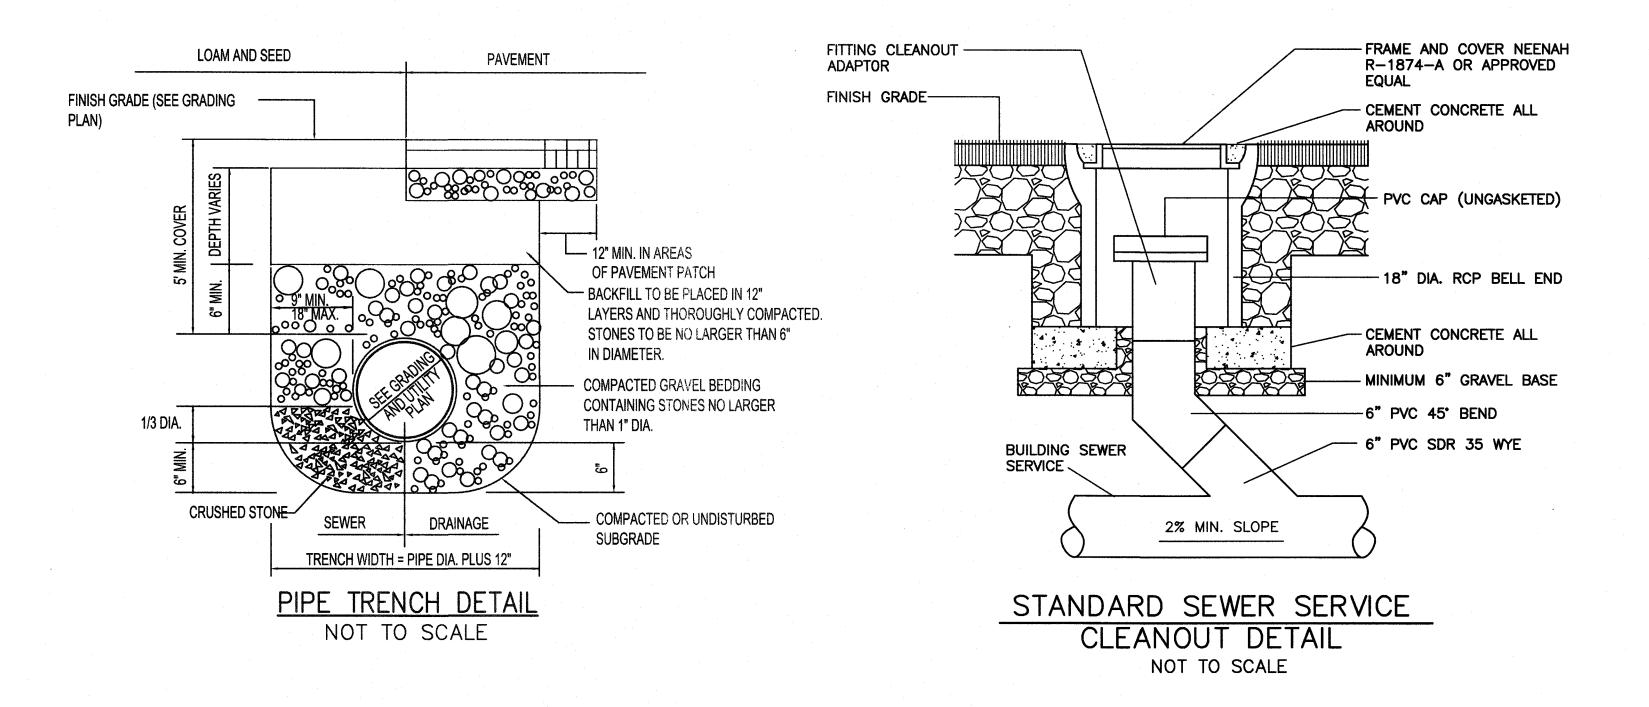

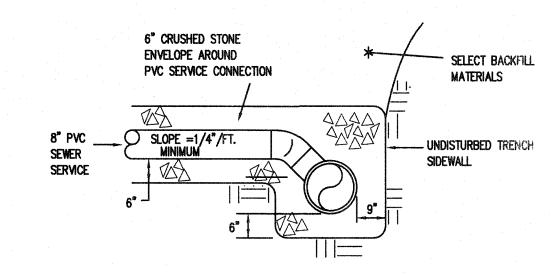


SECTION A - A

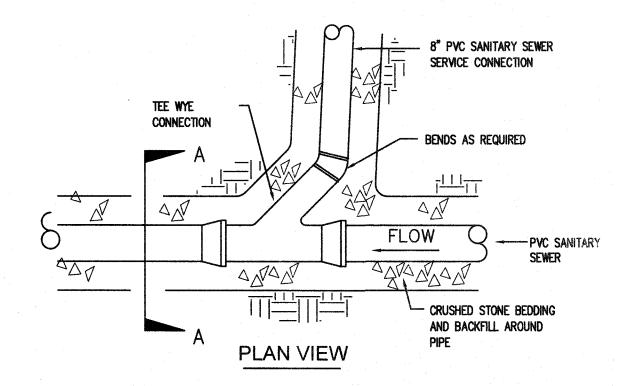



SANITARY SEWER SERVICE CONNECTION


NOT TO SCALE

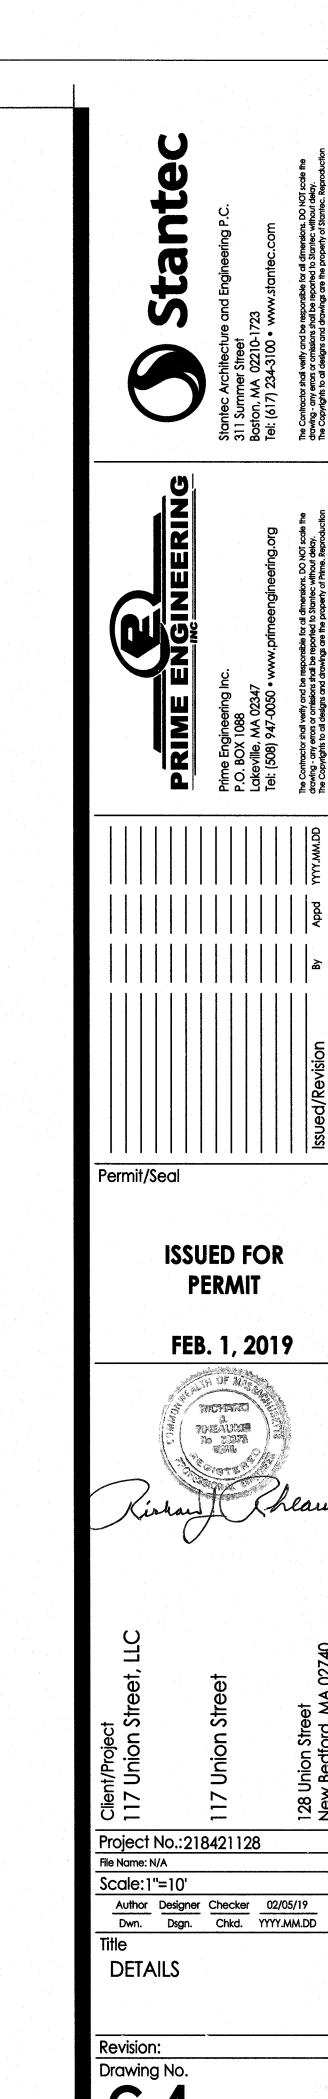

ORIGINAL SHEET - ANSI D

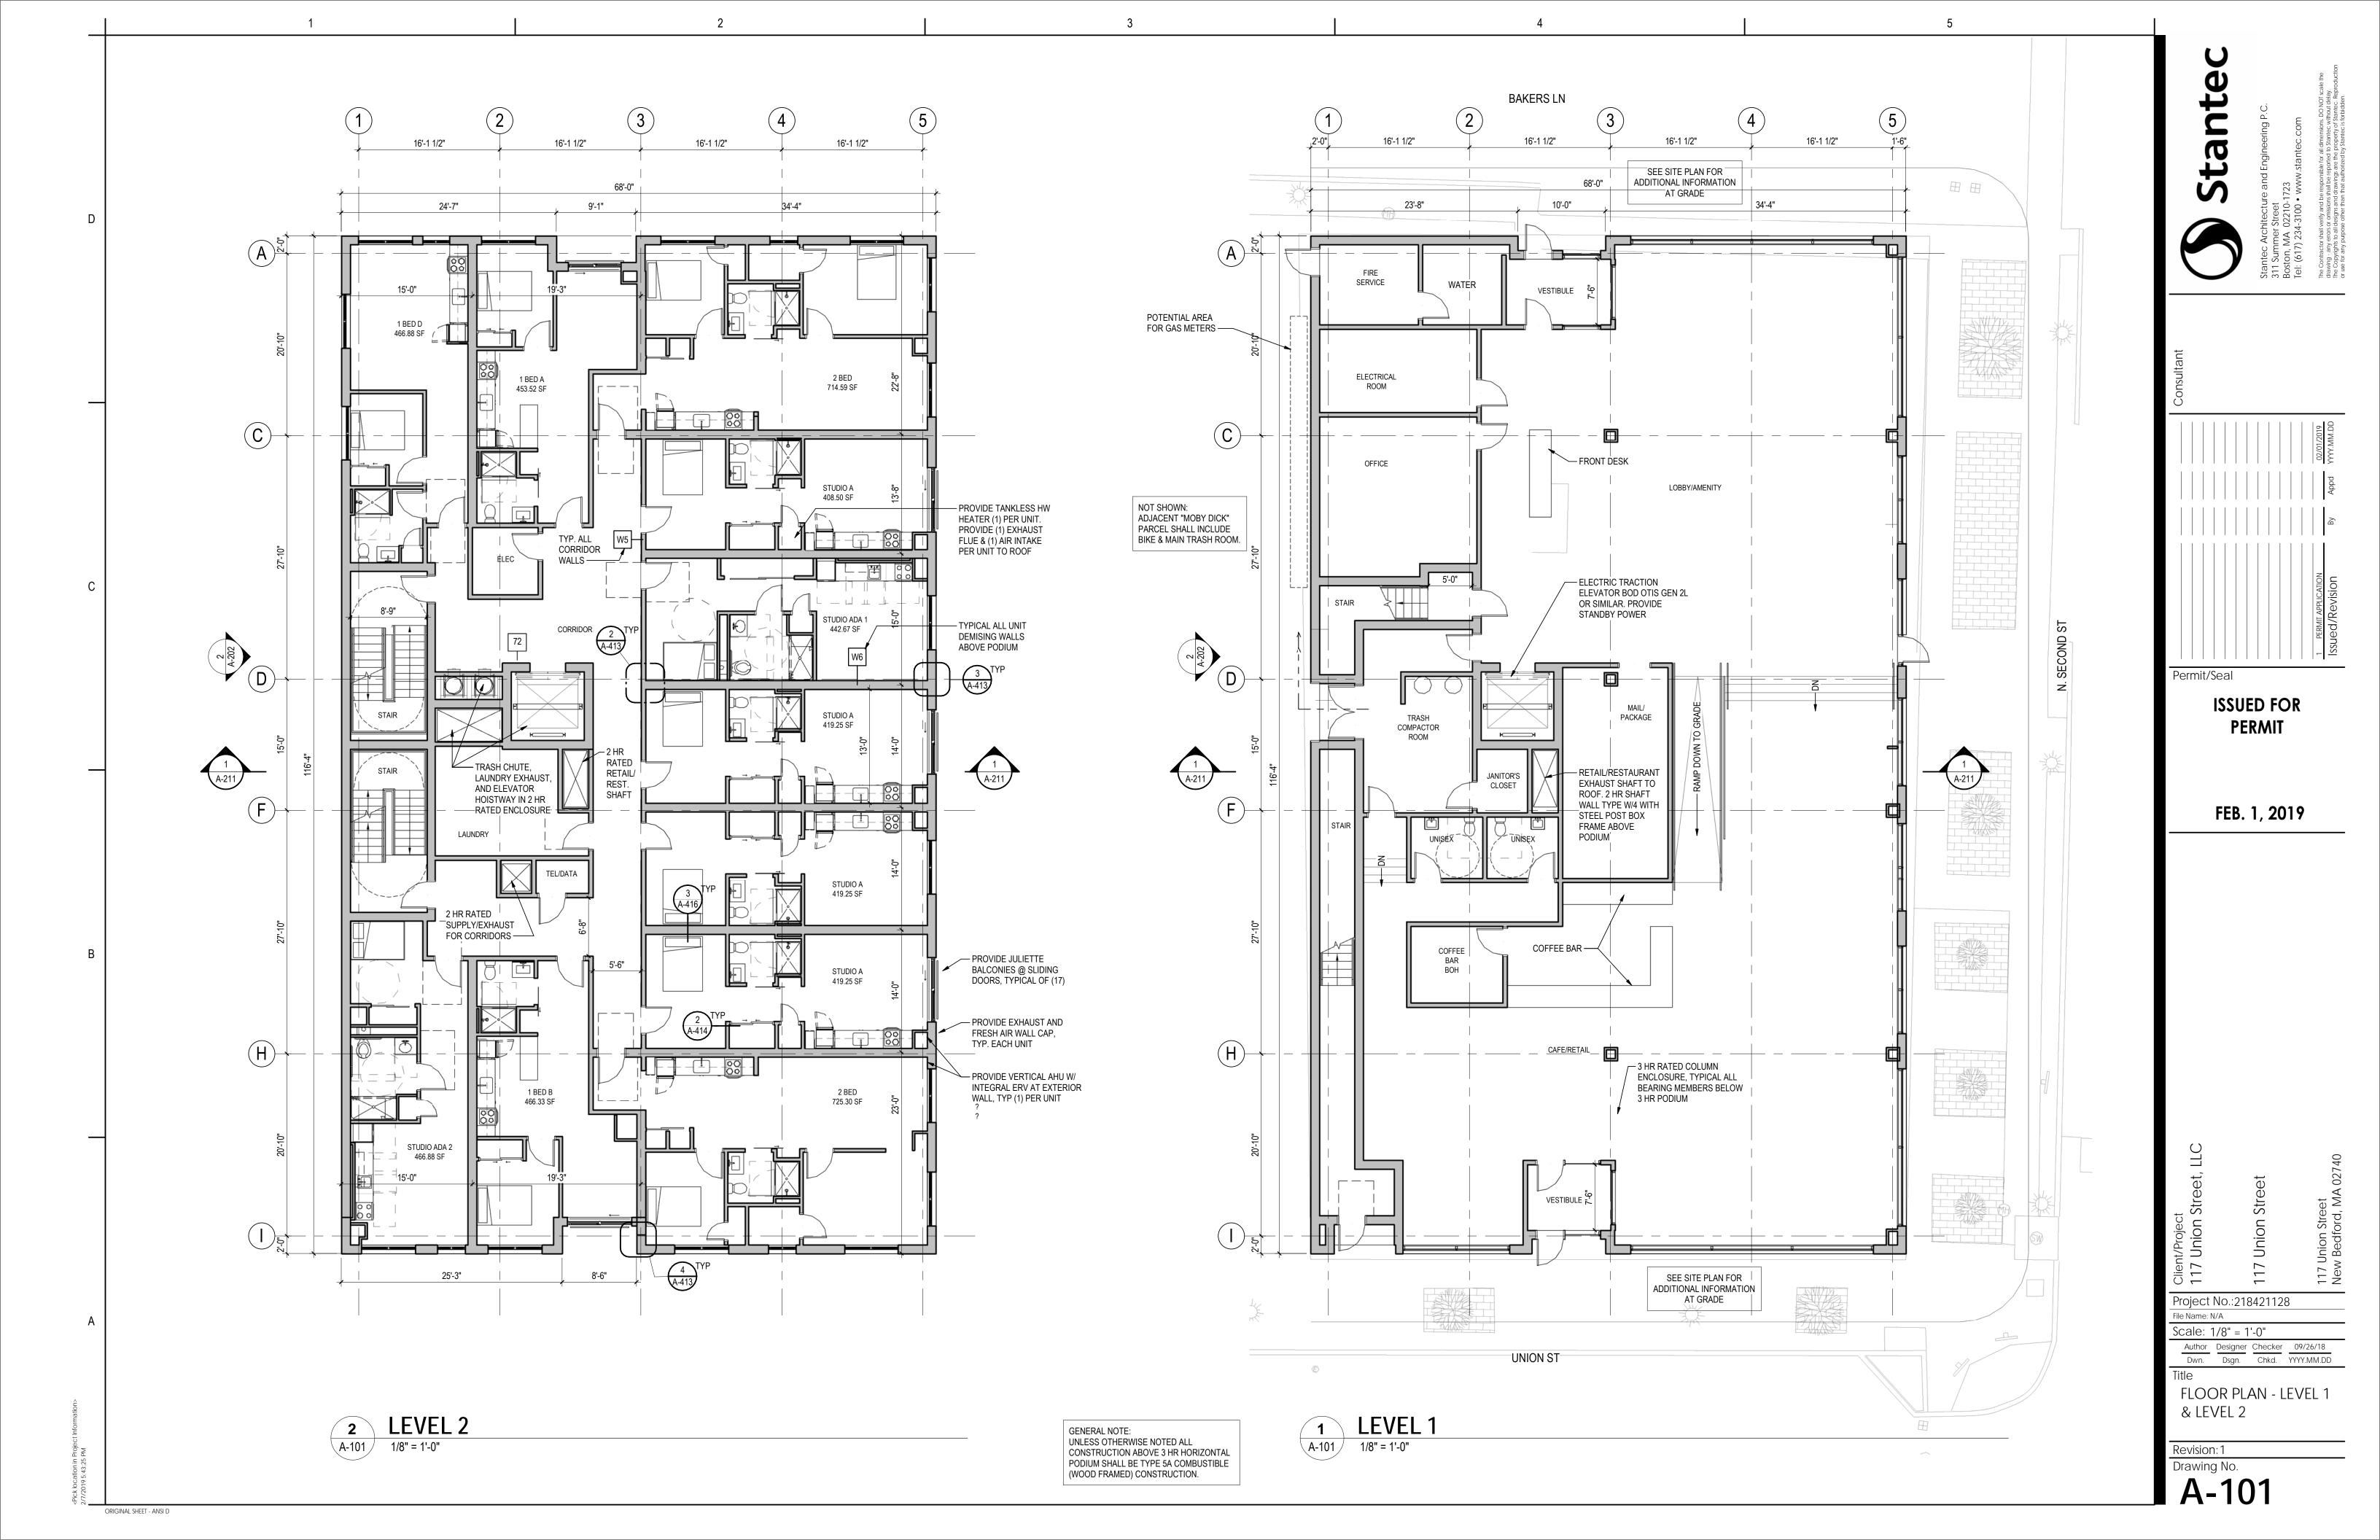

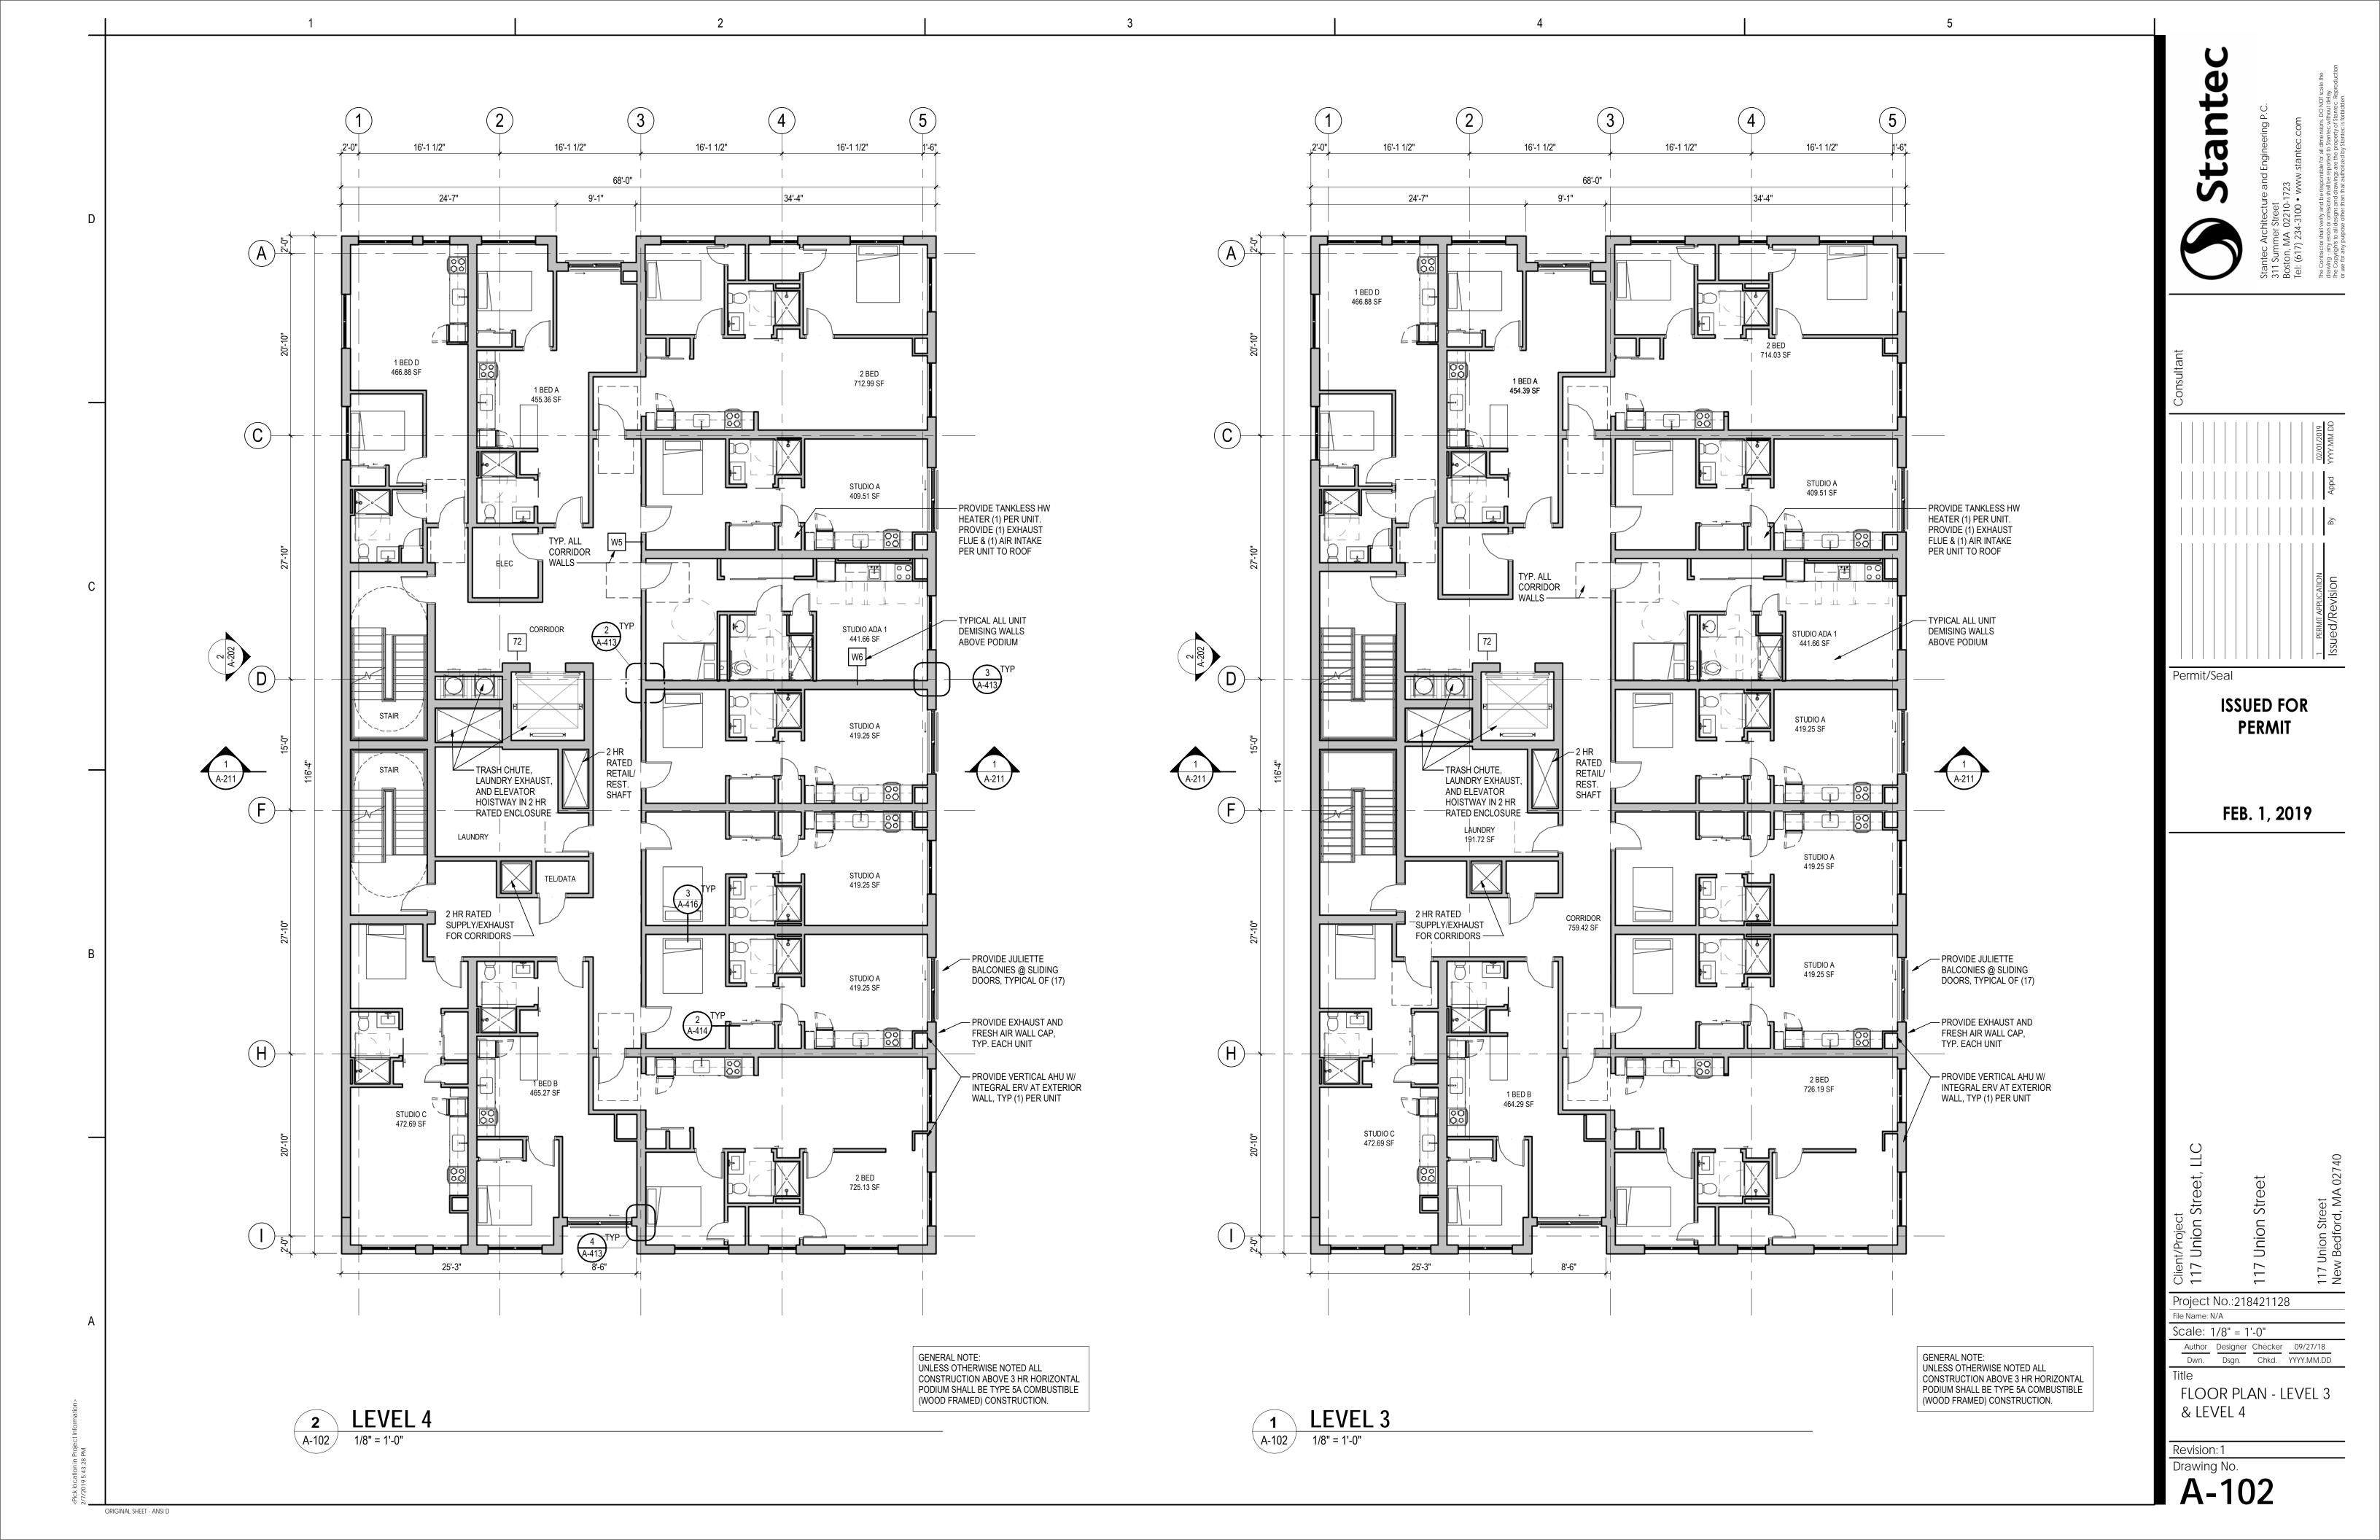

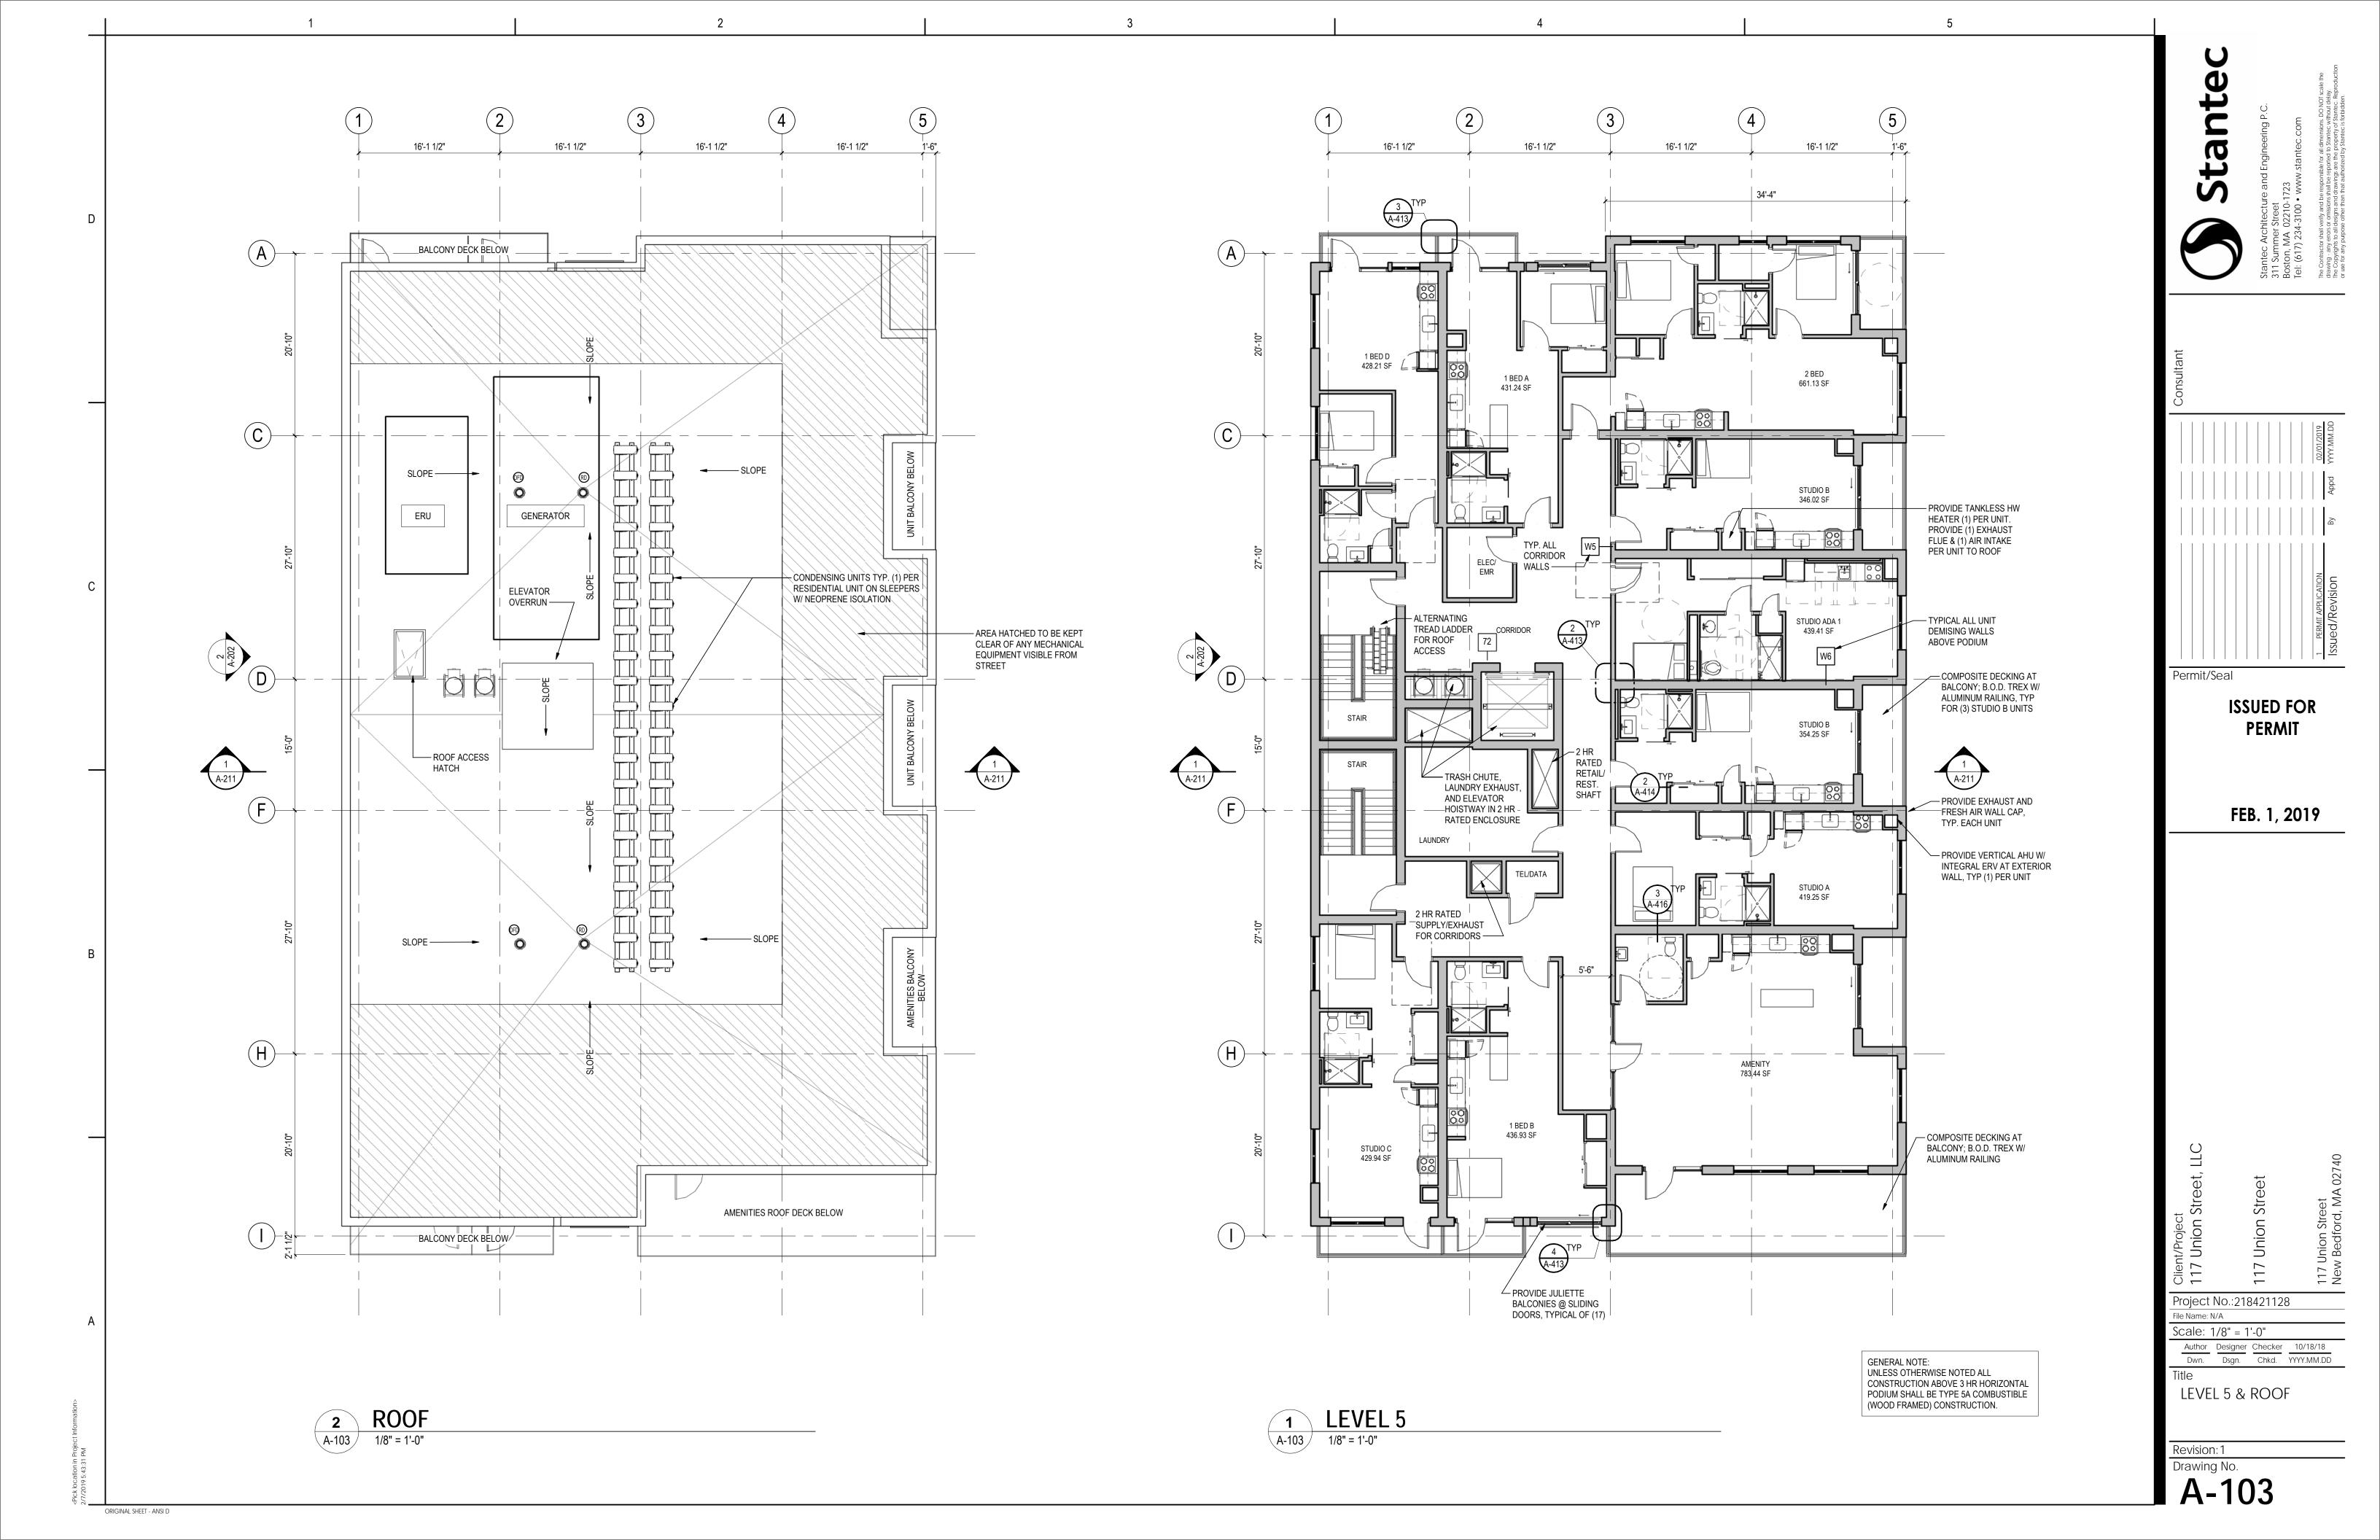





PERMIT

FEB. 1, 2019


Project No.:218421128

Scale: 1/8" = 1'-0"

ELEVATIONS - NORTH &

A-201



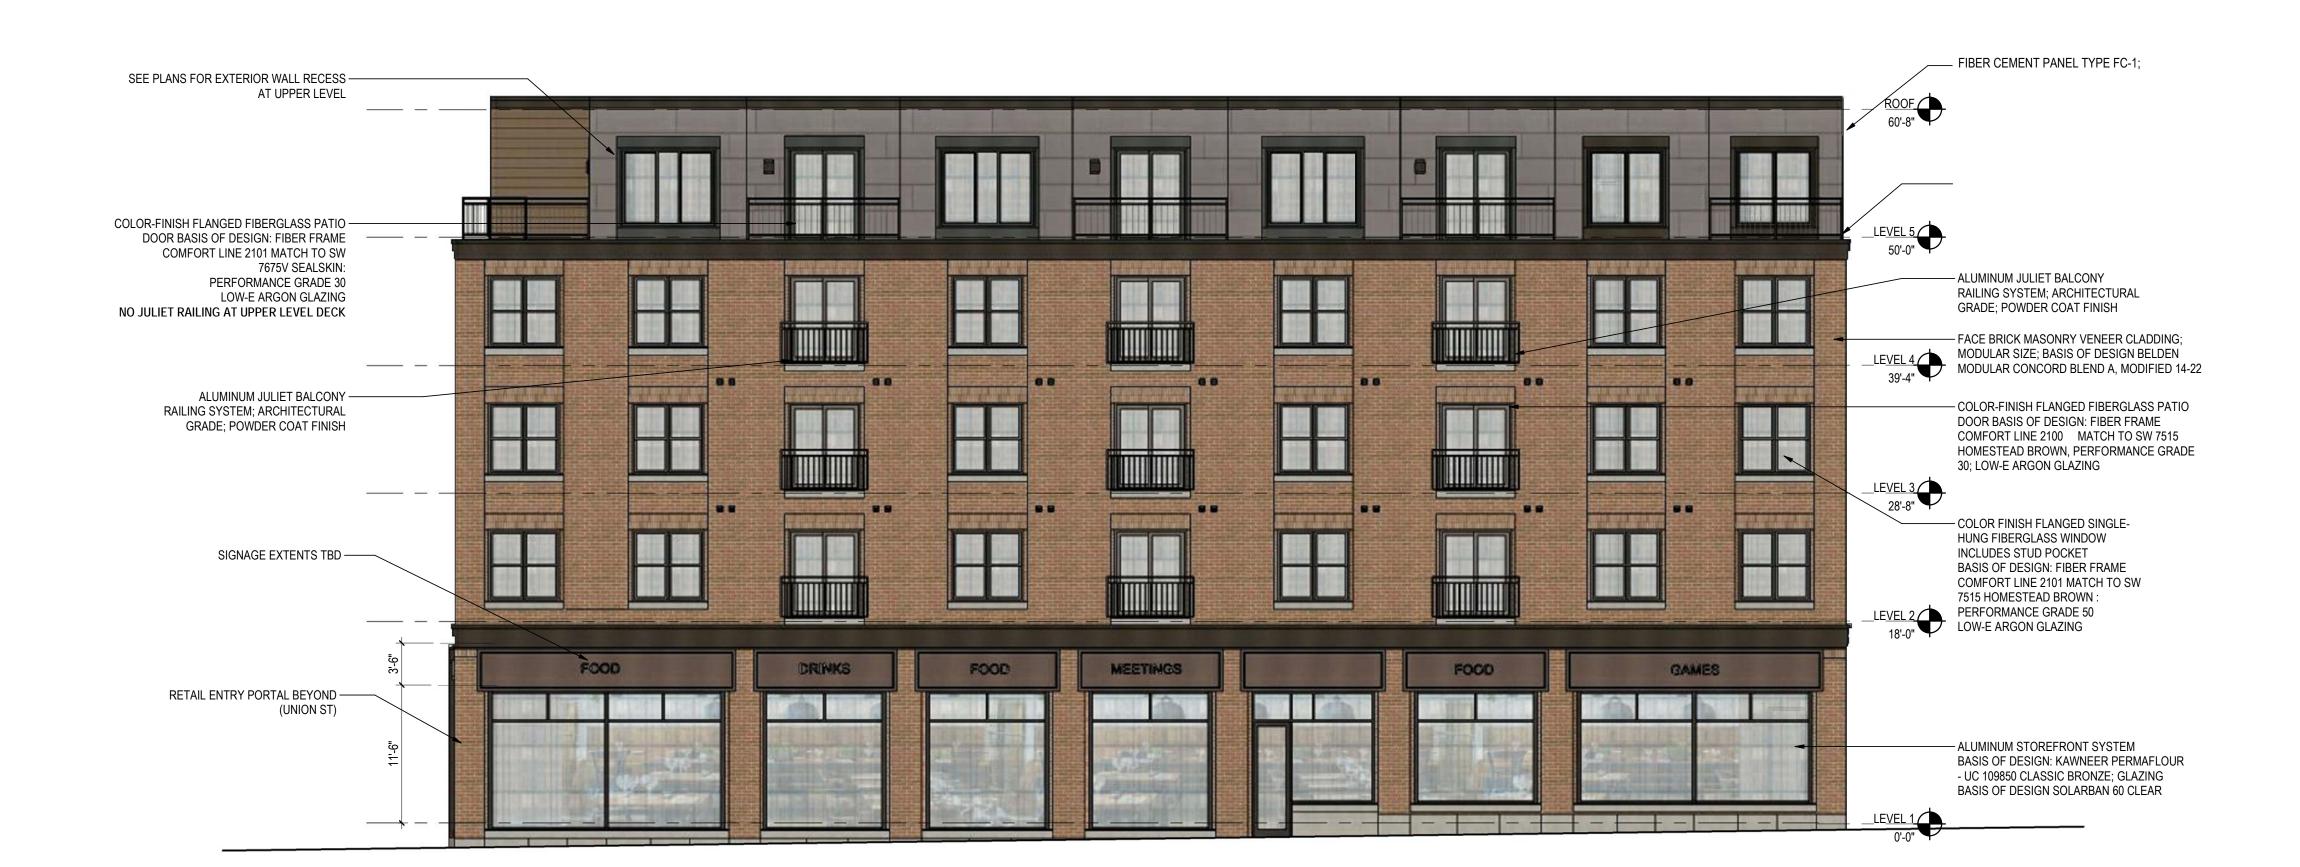

Stante Permit/Seal **ISSUED FOR PERMIT** FEB. 1, 2019 Project No.:218421128 File Name: N/A Scale: 1/8" = 1'-0"

Author Designer Checker 10/18/18

Dwn. Dsgn. Chkd. YYYY.MM.DD

ELEVATIONS - EAST &

Revision: 1 Drawing No.

A-202

1/8" = 1'-0"

ELEVATION - EAST

A-202

1/8" = 1'-0"

