PROPOSED PARKING LOT/DRIVE THRU IMPROVEMENTS

BANK FIVE

160 COUNTY STREET
NEW BEDFORD, MASSACHUSETTS

SITE PLANS



CRITERIA	REQUIRED	PROVIDED
LOT AREA (SF)	0	19567
LOT WIDTH (FT)	0	105
BUILDING HEIGHT (FT)	100	<25
FRONT SETBACK (FT)	0	0
SIDE SETBACK (FT)	0	N/A
REAR SETBACK (FT)	10	27
OFF-STREET PARKING SPACES	23	23*
VAN ACCESSIBLE HC SPACES	1	1
HANDICAP SPACES	1	1
LONG TERM BICYCLE PARKING SPACES	0	0
SHORT TERM BICYCLE PARKING SPACES	0	0

ZONING SUMMARY

*4550 SF/200 SF = 22.75 SPACES REQUIRED

*18 PARKING SPACES ARE PROVIDED ON THIS SITE AND 5 PARKING SPACES ARE PROVIDED IN THE EXISTING PARKING LOT ACROSS COUNTY STREET WHICH IS OWNED BY BANKFIVE.

NOTES:

1. THE CONTRACTOR SHALL OBTAIN A STREET DISTURBANCE AND OBSTRUCTION PERMIT PRIOR TO ANY CONSTRUCTION WITHIN THE RIGHT-OF-WAY.

2. ALL MATERIAL AND CONSTRUCTION WITHIN THE STREET LAYOUTS SHALL CONFORM TO THE CITY OF NEW REFERRING REQUIREMENTS.

ALL CONSTRUCTION WITHIN THE STREET LAYOUTS SHALL BE INSPECTED BY THE CITY OF NEW BEDFORD PRIOR TO BEING BACKFILLED.

4. THE CITY SHALL BE NOTIFIED AT LEAST 24 HOURS PRIOR TO THE REQUIRED INSPECTIONS.

5. DEVELOPER AND SITE CONTRACTOR MUST SCHEDULE A PRE-CONSTRUCTION MEETING WITH THE DEPARTMENT OF PUBLIC INFRASTRUCTURE PRIOR TO THE START OF CONSTRUCTION

SITE LOCUS IS REFERENCED AS NEW BEDFORD ASSESSOR'S MAP 30 LOT 245, 246, 247, 313, 320, AND 371.

SEE BOOK 1330/ PAGE 580

SEE BOOK 626/ PAGE 333

SEE BOOK 1503/ PAGE 335

SEE BOOK 1916/ PAGE 572

IN THE BRISTOL COUNTY REGISTRY OF DEEDS, IN NEW BEDFORD.


THE SITE IS LOCATED IN THE MIXED USE BUSINESS ZONING DISTRICT



APPROVED BY THE CITY OF NEW BEDFORD PLANNING BOARD

CITY OF NEW BEDFORD PLANNING BOARD

APPROVED _____ ENDORSED_

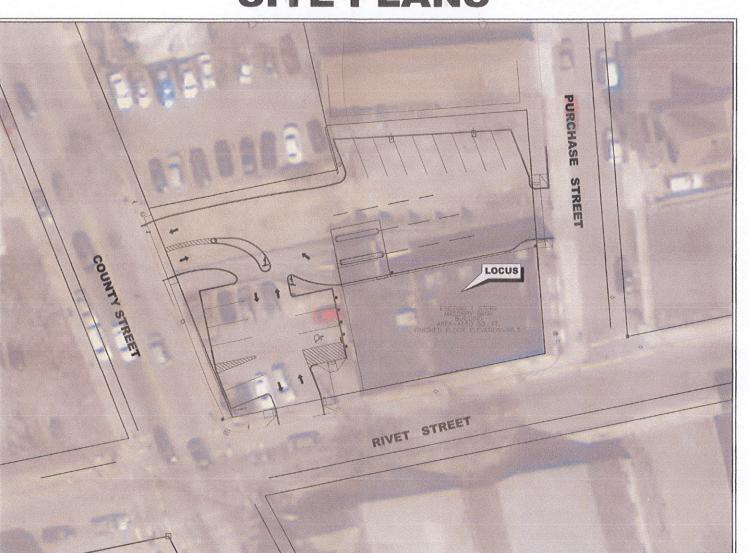

NEIGHBORHOOD LOCUS PLAN SCALE: 1"=20'

APRIL 3, 2018

SCHEDULE OF DRAWINGS

SHEET NUMBER	PLAN TITLE
	COVER SHEET
1.	EXISTING CONDITIONS PLAN
2.	SITE LAYOUT
3.	GRADING & DRAINAGE PLAN
4.	LANDSCAPE & LIGHTING PLAN
5.	EROSION CONTROL PLAN
6.	DETAILS 1
7.	DETAILS 2

DEVELOPMENT TEAM

FUNCTION

TEAM MEMBER

OWNER/DEVELOPER

FALL RIVER FIVE CENT SAVINGS

79 NORTH MAIN STREET FALL RIVER, MA 02720

ARCHITECT

CIVITECTS 66 TROY STREET

FALL RIVER, MA 02720


SITE DESIGN ENGINEER


PRIME ENGINEERING, INC. P.O. BOX 1088 LAKEVILLE, MA 02347


PREPARED BY:




CIVIL ENGINEERING—LAND SURVEYING—ENVIRONMENTAL ASSESSMENT P.O. BOX 1088, 350 BEDFORD STREET, LAKEVILLE, MA 02347 TEL: 508.947.0050 FAX: 508.947.2004

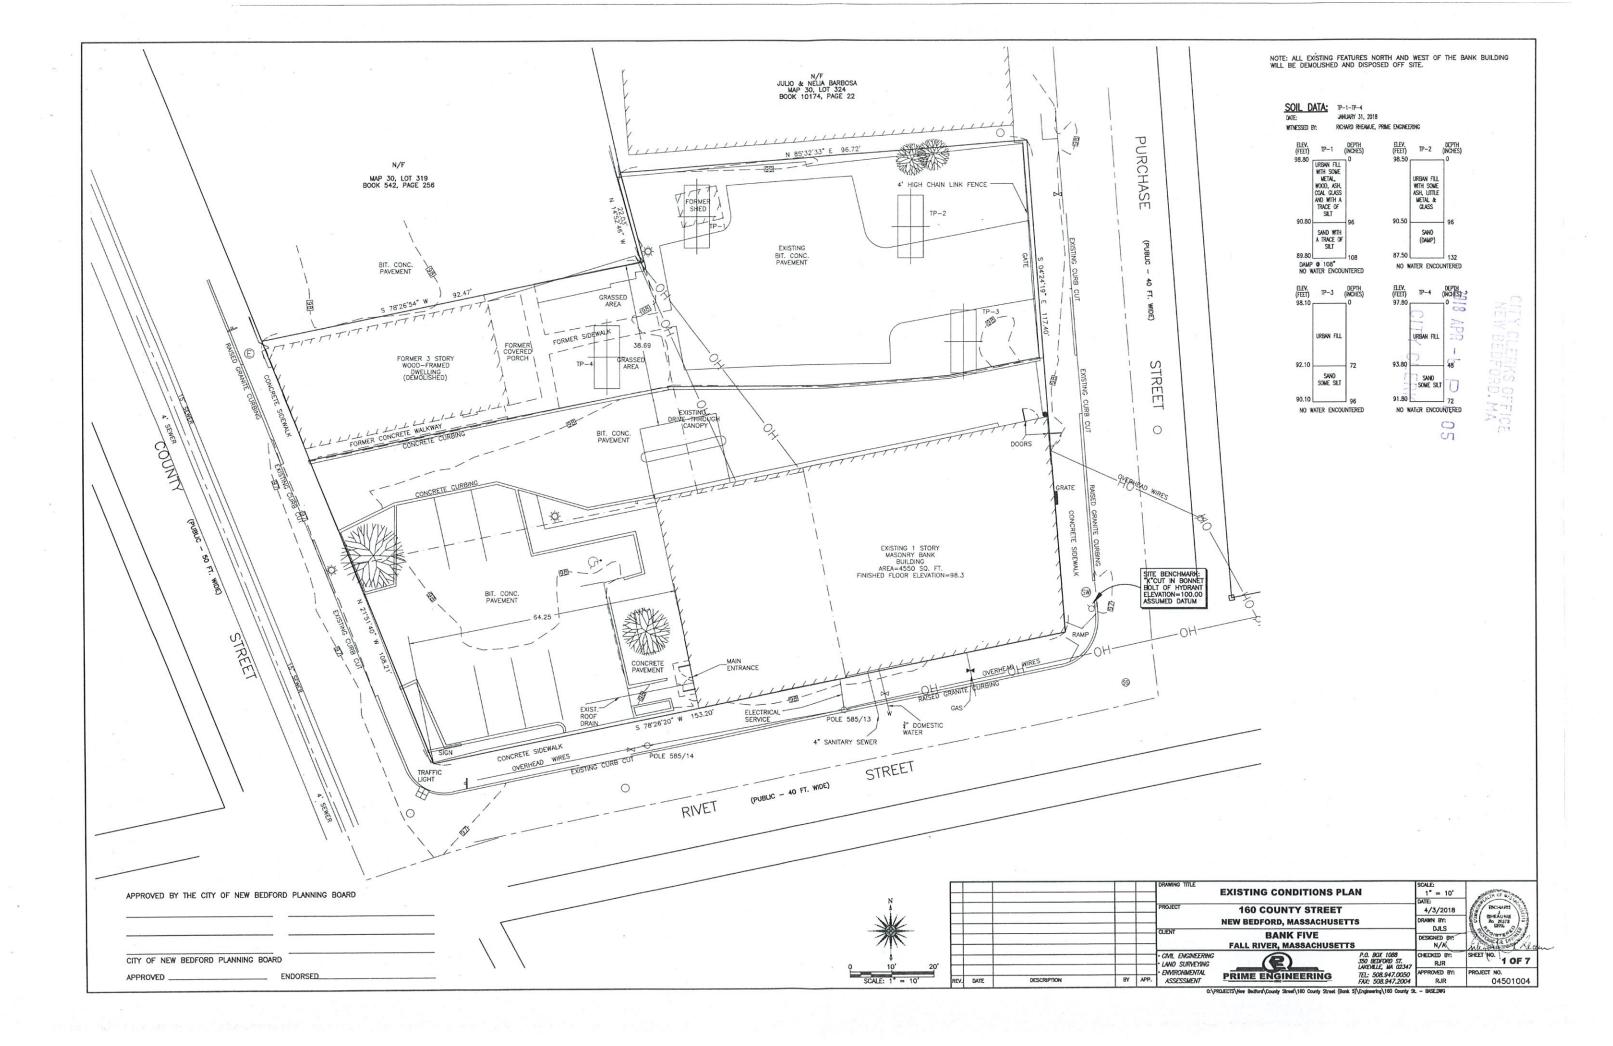

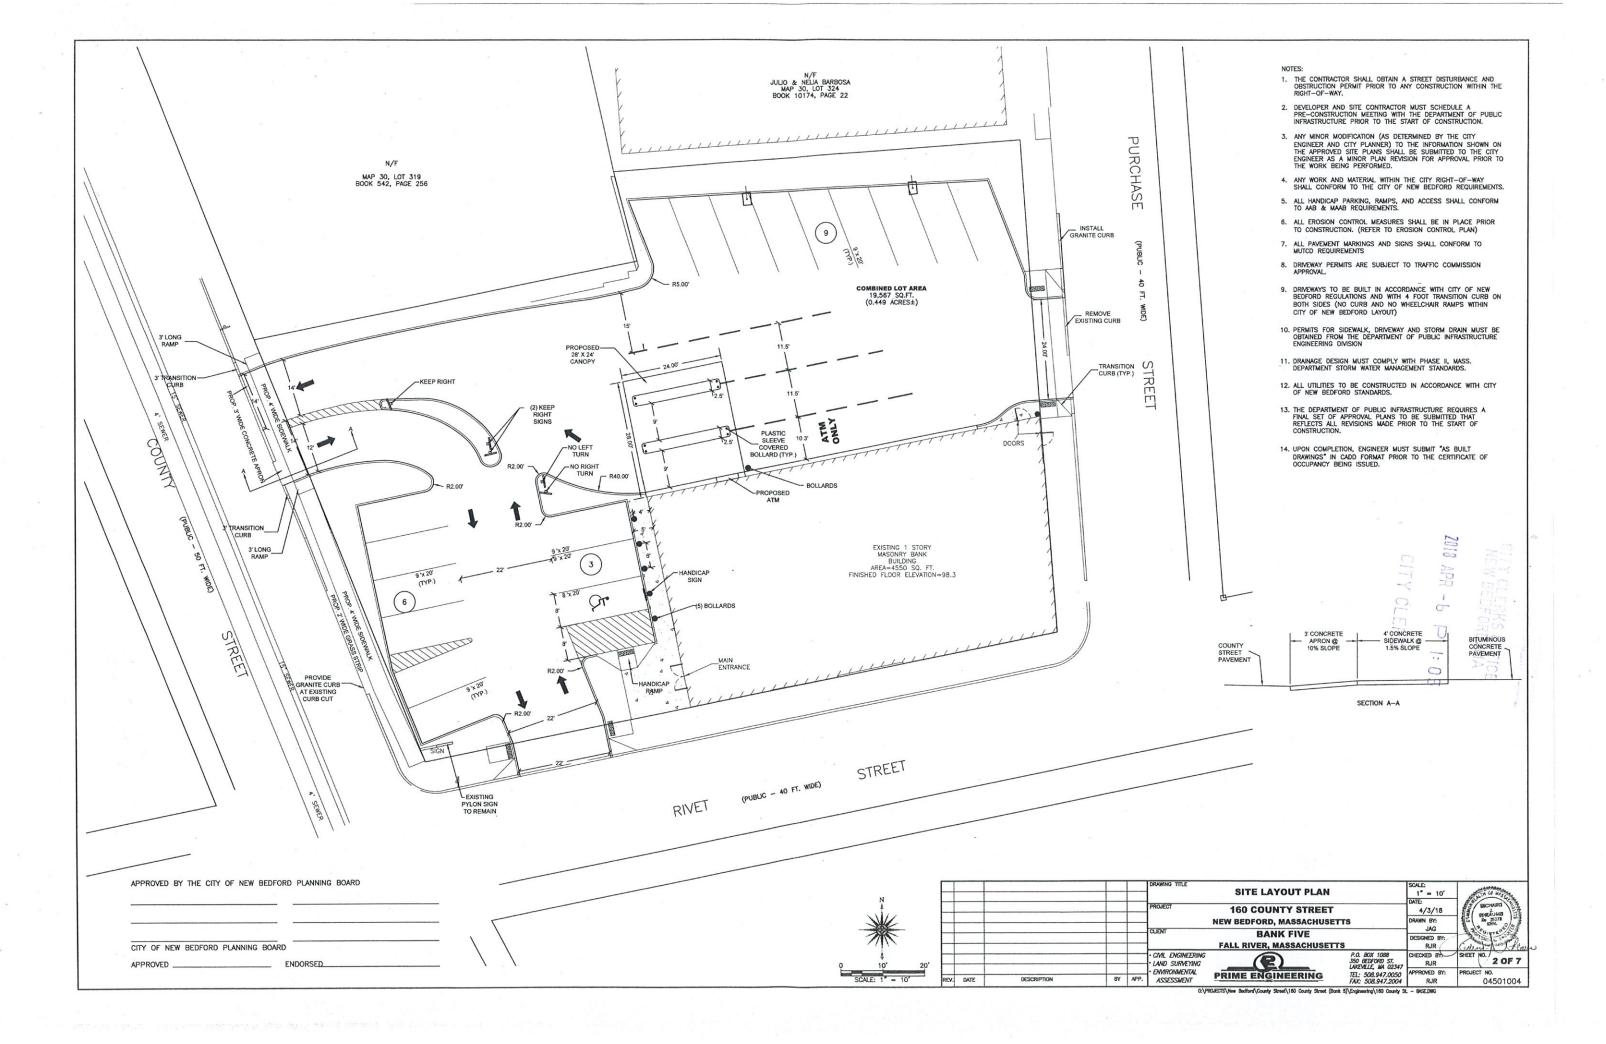

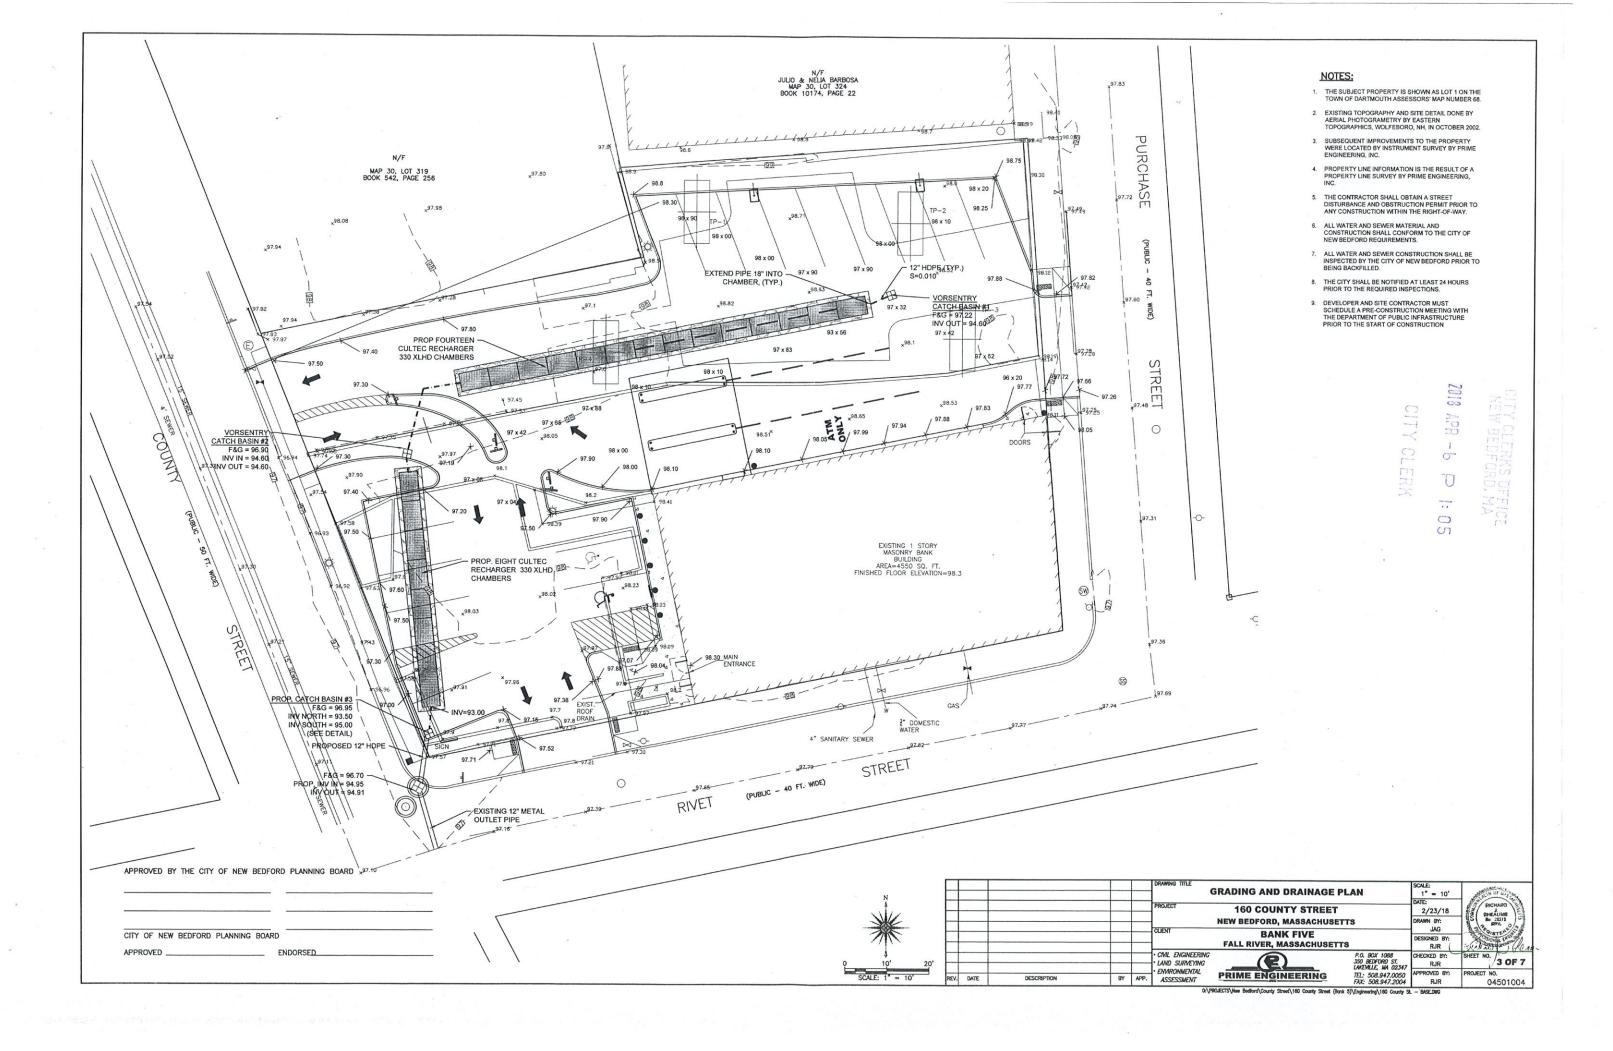

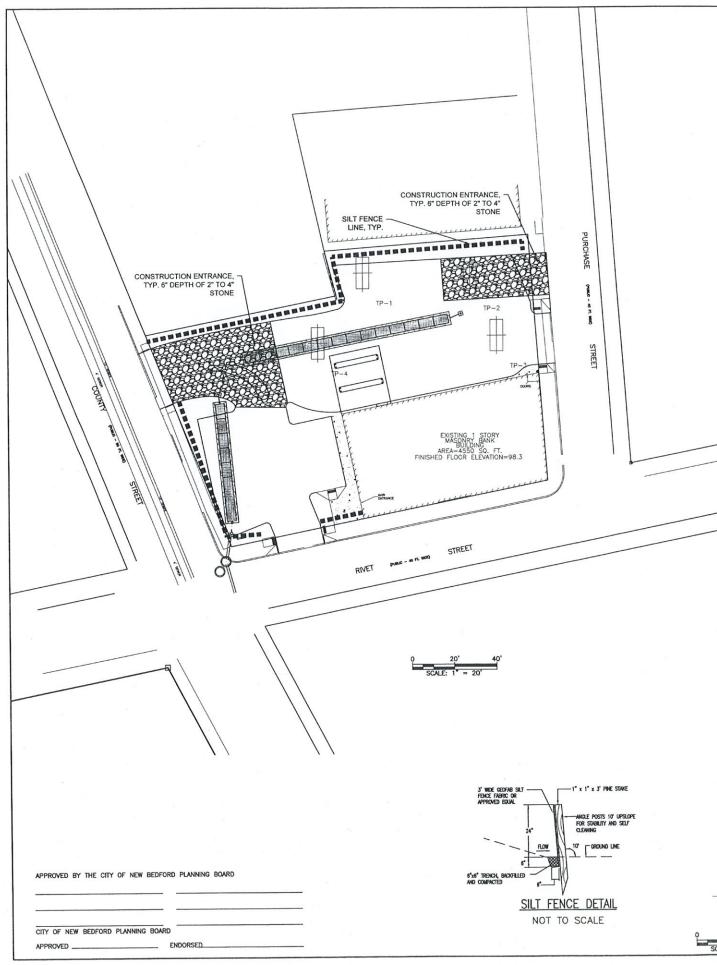

EROSION & SEDIMENT CONTROL NOTES:

IT IS THE CONTRACTOR'S RESPONSIBILITY TO CONTROL EROSION AND PREVENT SEDIMENTATION WITHIN 25' OF RESQUIRCE AREAS OR OFFSITE PROPERTIES. IT IS INTENDED THAT THE IMPLEMENTATION OF THE FOLLOWING MEASURES WILL MEET THIS GOAL. WHEN IT IS CLEAR TO THE DESIGNER THAT EROSION AND SEDIMENTATION HAVE BEEN ADEQUATELY CONTROLLED WITHOUT THE IMPLEMENTATION OF EVERY MEASURE, ADDITIONAL, MEASURES NEED NOT BE IMPLEMENTED. ALTERNATIVELY, IF ALL OF THE FOLLOWING MEASURES HAVE BEEN IMPLEMENTED. AD THE CONTRACTOR MUST EMPLOY SUFFICIENT SUPPLEMENTAL MEASURES BEYOND THE SCOPE OF THIS FLAN.

1. EROSION AND SEDIMENT CONTROL MEASURES WILL BE INSTALLED PRIOR TO CONSTRUCTION. STABILIZATION OF ALL REGRADED AND SOIL STOCKPILE AREAS WILL BE INITIATED AND MAINTAINED DURING ALL PHASES OF CONSTRUCTION.

ALL EROSION AND SEDIMENT CONTROL MEASURES WILL BE CONSTRUCTED IN ACCORDANCE WITH LOCAL MUNICIPAL REQULATIONS. ALL EROSION CONTROL MEASURES ARE TO BE MAINTAINED AND UPGRADED AS REQUIRED TO ACHIEVE PROPER SEDIMENT CONTROL DIRINAL CONSTRUCTION.

3. ADDITIONAL CONTROL MEASURES WILL BE INSTALLED DURING THE CONSTRUCTION PERIOD, IF DEEMED NECESSARY BY THE OWNER OR AGENTS OF THE OWNER.

4. CATCH BASINS WILL BE PROTECTED WITH HAYBALE FILTERS THROUGHOUT THE CONSTRUCTION PERIOD UNTIL ALL DISTURBED AREAS ARE THOROUGHLY STABILIZED. SILT SOCKS SHOULD BE INSTALLED UNDER GRATE OPENING UNTIL PAVEMENT IS IN PLACE AND GROUND SURFACE IS STABILIZED.

5. SEEDING MIXTURE FOR FINISHED GRASSED AREAS WILL BE AS FOLLOWS:

KENTUCKY BLUE GRASS CREEPING RED FESCUE PERENNIAL RYEGRASS

SEED TO BE APPLIED AT A RATE OF 4 LBS./1000 SQ. FT.
PLANTING SEASONS SHALL BE APRIL 1 TO JUNE 1 AND AUGUST 1 TO OCTOBER 15. AFTER
OCTOBER 15, AREAS WILL BE STABILIZED WITH HAYBALE CHECK, FILTER FABRIC, OR
WOODCHIP MULCH, AS REQUIRED, TO CONTROL EROSION.

6. AREAS THAT ARE NOT THE LOCATION OF ACTIVE CONSTRUCTION WHICH ARE TO BE LEFT BARE FOR OVER ONE MONTH BEFORE FINISHED GRADING AND SEEDING IS ACHIEVED, SHALL BE MULCHED OR RECEVE TEMPORARY STABILIZATION SUCH AS JUTE NETTING OR SHALL RECEIVE A TEMPORARY SEEDING OF PERENNIAL RYEGRASS APPLIED TO A RATE OF 2 LBS./1,000 SQ. FT. LIMESTONE (EQUIVALENT TO BE 50 PERCENT CALCIUM PLUS MAGNESIUM OXIDE) SHALL BE APPLIED AS SEEDBED PREPARATION AT A RATE OF 90 LBS./1,000 SQ. FT. PLANTING SEASONS SHALL BE APRIL 17 O JUNE 1 AND AUGUST 1 TO COTOBER 1, AREAS TO BE LEFT BARE BEFORE FINISH GRADING AND SEEDING OUTSIDE OF PLANTING SEASONS SHALL BE APRIL 17 OUTSIDE OF PLANTING SEASONS SHALL RECEIVE AN AIR—DRIED WOOD CHIP MULCH, FREE OF COARSE MATTER.

7. AT ALL PROPOSED FILL AREAS WHICH ARE NOT CURRENTLY SHOWN ON THESE PLANS, THE CONTRACTOR SHALL ESTABLISH AN EROSION CONTROL LINE (HAYBALE CHECK OR FILTER FABRIC) ABOUT TEN (10") FEET FROM TOE TO SLOPE OF PROPOSED FILL AREAS PRIOR TO BEGINNING FILL INSTALLATION. STABILIZATION OF SLOPES IN FILL AREAS (USING MULCH OR GRASS) SHALL BE INITIATED WITHIN THIRTY (30) DAYS OF COMMENCEMENT OF FILL INSTALLATION.

8. STABILIZATION OF SLOPES IN CUT AREAS (USING MULCH OR GRASS) AND THE INSTALLATION OF CONTROL LINE (HAYBALE CHECK OR FILTER FABRIC) AT THE TOE OF SLOPE SHALL BE INITIATED WITHIN THIRTY (30) DAYS OF COMPLETION.

9. SEDIMENT REMOVED FROM CONTROL STRUCTURES WILL BE DISPOSED IN A MANNER WHICH IS CONSISTENT WITH THE INTENT OF THE PLAN. ALL HAYBALES OR SILT FENCE RETAINING SEDIMENT OVER 1/2 THEIR HEIGHT SHALL HAVE THE SEDIMENT REMOVED AND ALL DAMAGED EROSION CONTROLS SHALL BE REPAIRED OR REPLACED.

10. CONTRACTOR WILL BE ASSIGNED THE RESPONSIBILITY FOR IMPLEMENTING THIS EROSION AND SEDIMENT CONTROL PLAN, THIS RESPONSIBILITY INCLUDES THE INSTALLATION AND MAINTENANCE OF CONTROL MEASURES, INFORMING ALL PARTIES ENGAGED ON THE CONSTRUCTION SITE OF THE REQUIREMENTS AND OBJECTIVES OF THE PLAN, AND NOTIFYING THE PLANNING BOARD OF ANY TRANSFER OF THIS RESPONSIBILITY. THE OWNER SHALL BE RESPONSIBLE FOR CONVEYING A COPY OF THE EROSION AND SEDIMENT CONTROL PLAN IF THE TITLE TO THE LAND IS TRANSFERRED.

11. THE CONTRACTOR SHALL VERIFY IN THE FIELD THAT THE CONTROLS REQUIRED BY THIS PLAN ARE PROPERLY INSTALLED, SHALL WAKE INSPECTION OF SUCH FACILITIES NOT LESS FREQUENTLY THAN EVERY 14 DAYS OR AFTER A RANFALL IN EXCESS OF 1/2 INCH, WHICHEVER OCCURS FIRST. THE INSPECTION REPORTS SHALL BE SUBMITTED TO THE PLANNING DEPARTMENT AND CONSERVATION COMMISSION OFFICE ON A MONTHLY BASIS.

12. STOCKPILES OF SOIL SHALL BE SURROUNDED BY A SEDIMENT BARRIER. SOIL STOCKPILES TO BE LEFT BARE FOR MORE THAN THIRTY (30) DAYS SHALL BE STABILIZED WITH TEMPORARY VEGETATION OR MULCH. IF SOIL STOCKPILES ARE TO REMAIN FOR MORE THAN SIXTY (60) DAYS, FILTER FABRIC SHALL BE USED IN PLACE OF HAYBALES. SIDE SLOPES SHALL NOT EXCEED 2:1.

13. THE CONTRACTOR SHALL BE RESPONSIBLE TO CONTROL DUST AND WIND EROSION THROUGHOUT THE LIFE OF HIS CONTRACT, DUST CONTROL SHALL INCLUDE, BUT IS NOT LIMITED TO SPRINKLING OF WATER ON EXPOSED SOILS AND HAUL ROADS. CONTRACTOR SHALL CONTROL DUST TO PREVENT A HAZARD TO TRAFFIC.


14. WHERE DEWATERING IS NECESSARY, THERE SHALL NOT BE A DISCHARGE DIRECTLY INTO WETLANDS OR WATERCOURSES. PROPER METHODS AND DEVICES SHALL BE UTILIZED TO THE EXTENT PERMITTED BY LAW, SUCH AS PUMPING WATER INTO A TEMPORARY SEDIMENTATION BOWL, PROVIDING SURCE PROTECTION AT THE INITIAL TAND THE OUTLET OF PUMPS, OR FLOATING THE INTAKE OF THE PUMP, OR OTHER METHODS TO MINIMIZE AND RETAIN THE SUSPENDED SOLIDS. IF A PUMPING OPERATION IS CAUSING TURBIDITY PROBLEMS, SUD OPERATION SHALL CEASE UNTIL SUCH TIME AS FEASIBLE MEANS OF CONTROLLING TURBIDITY PARE DETERMINED AND INPLEMENTED. SAID DISCHARGE POINTS SHALL BE LOCATED OVER 100 FEET FROM THE DELINEATED WETLANDS AS INDICATED ON THIS PLAN.

15. SILT SACKS OR OTHER EQUIVALENT ARE TO BE PLACED IN THE FIRST DOWNSTREAM CATCH BASINS FROM THE SITE.

16. ALL BMP EROSION CONTROL MEASURES SHALL BE IN PLACE PRIOR TO DEMOLITION OR ANY SITE WORK.


17. EROSION CONTROL BMPS SHALL CONFORM-TO US EPA, NPDES, MA DEP AND MASSACHUSETTS EROSION AND SEDIMENTATION CONTROL GUIDELINES FOR URBAN AND SUBURBAN AREAS.

18. ALL EROSION AND SEDIMENTATION CONTROL MEASURES SHALL BE MAINTAINED THROUGHOUT THE CONSTRUCTION PROCESS UNTIL THE SITE HAS BEEN FULLY STABILIZED. THE MAINTENANCE SHALL INCLUDE REPLACEMENT OF THE BMP IF NECESSARY.

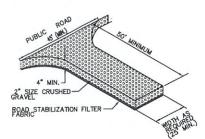

CONSTRUCTION ENTRANCE


NOT TO SCALE

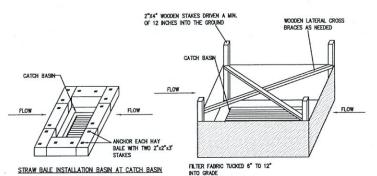

SILT FENCE INSTALLATION AT CATCH BASINS

SEDIMENT AND EROSION CONTROL AT CATCH BASINS


TO BE INSTALLED IF SPECIFIED BY FIELD ENGINEER NOT TO SCALE

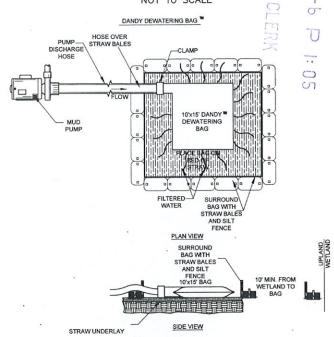


DEWATERING BAG DETAIL NOT TO SCALE




					DRAWING TITLE	EROSION CONTROL PLAN		SCALE: 1" = 20' DATE:	AULIN OF WAS
					PROJECT	160 COUNTY STREET NEW BEDFORD, MASSACHUSETT	rs	4/3/2018 DRAWN BY: JAG	SECHARD SEC
H					CLIENT	BANK FIVE FALL RIVER, MASSACHUSETTS	1	DESIGNED BY:	SISTES SALL
					· CIVIL ENGINEERING · LAND SURVEYING		P.O. BOX 1088 350 BEDFORD ST. LAKEVILLE, MA 02347	CHECKED BY:	SHEET NO. 4 OF 7
REV.	DATE	DESCRIPTION	BY	APP.	• ENVIRONMENTAL ASSESSMENT	PRIME ENGINEERING	TEL: 508.947.0050 FAX: 508.947.2004	APPROVED BY: RJR	PROJECT NO. 04501004

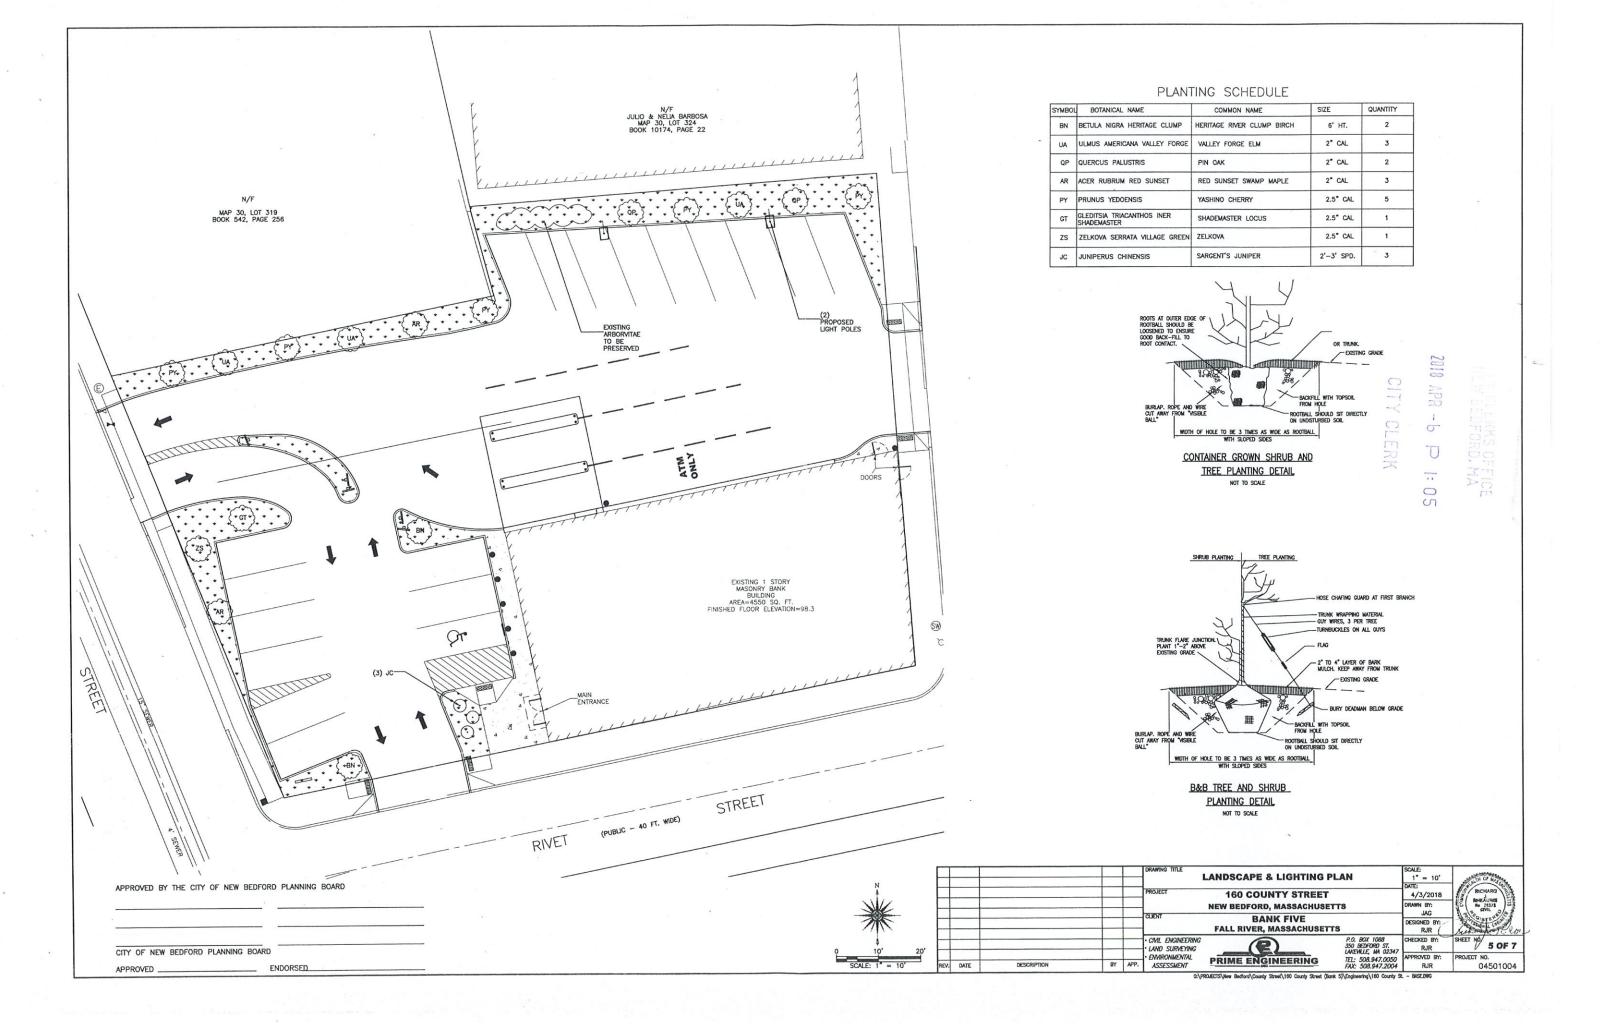


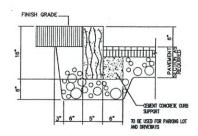



5" VERTICAL GRANITE CURB WITH 6" REVEAL

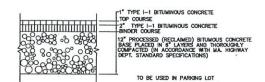


BITUMINOUS CONCRETE PAVEMENT

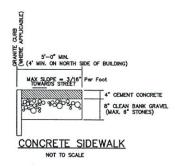

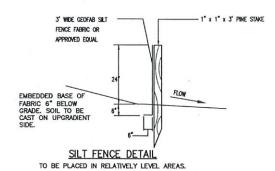

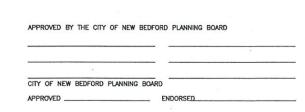

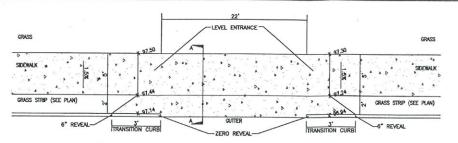


PLAN




CROSS SECTION A-A


AT COUNTY STREET ENTRANCE DRIVE NOT TO SCALE

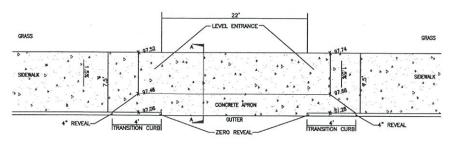


PLAN

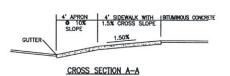

CEMENT CONCRETE APRON
AT RIVET STREET ENTRANCE DRIVE
NOT TO SCALE

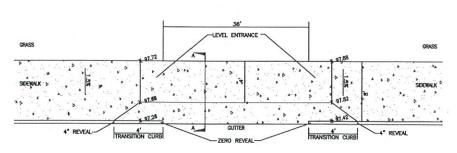


PLAN

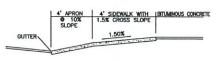



CROSS SECTION A-A

CEMENT CONCRETE APRON
AT PURCHASE STREET ENTRANCE DRIVE
NOT TO SCALE

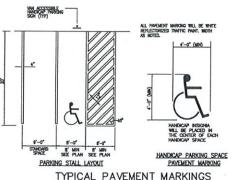

TYPICAL PAVEMENT MARKINGS NOT TO SCALE

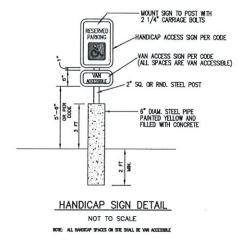


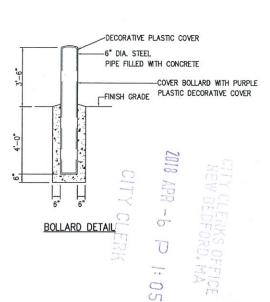


ALL UTILITY WORK SHALL BE DONE IN CONFORMANCE WITH NEW BEDFORD DEPARTMENT OF PUBLIC INFRASTRUCTURE CONSTRUCTION STANDARDS AND SPECIFICATIONS DATED MARCH, 2012


Е					DETAILS - 1			SCALE: AS NOTED DATE:	Sulm or water
H			1			160 COUNTY STREET W BEDFORD, MASSACHUS	ETTS	4/3/2018 DRAWN BY:	BIGHARD SHEALINE BOOK SEPTE
H			+			BANK FIVE FALL RIVER, MASSACHUSE	TTS	JAG DESIGNED BY: RJR	Cular Maria
F			-		· CIVIL ENGINEERING · LAND SURVEYING		P.O. BOX 1088 350 BEDFORD ST. LAKEVILLE, MA 02347	CHECKED BY:	SHEET NO 6 OF 7
REV.	DATE	DESCRIPTION	BY	APP.	• ENVIRONMENTAL ASSESSMENT	PRIME ENGINEERING	TEL: 508.947.0050 FAX: 508.947.2004	APPROVED BY: RJR	PROJECT NO. 04501004

O:\PROJECTS\New Bedford\County Street\180 County Street (Bank 5)\Engineering\180 County St. - BASE.DWG

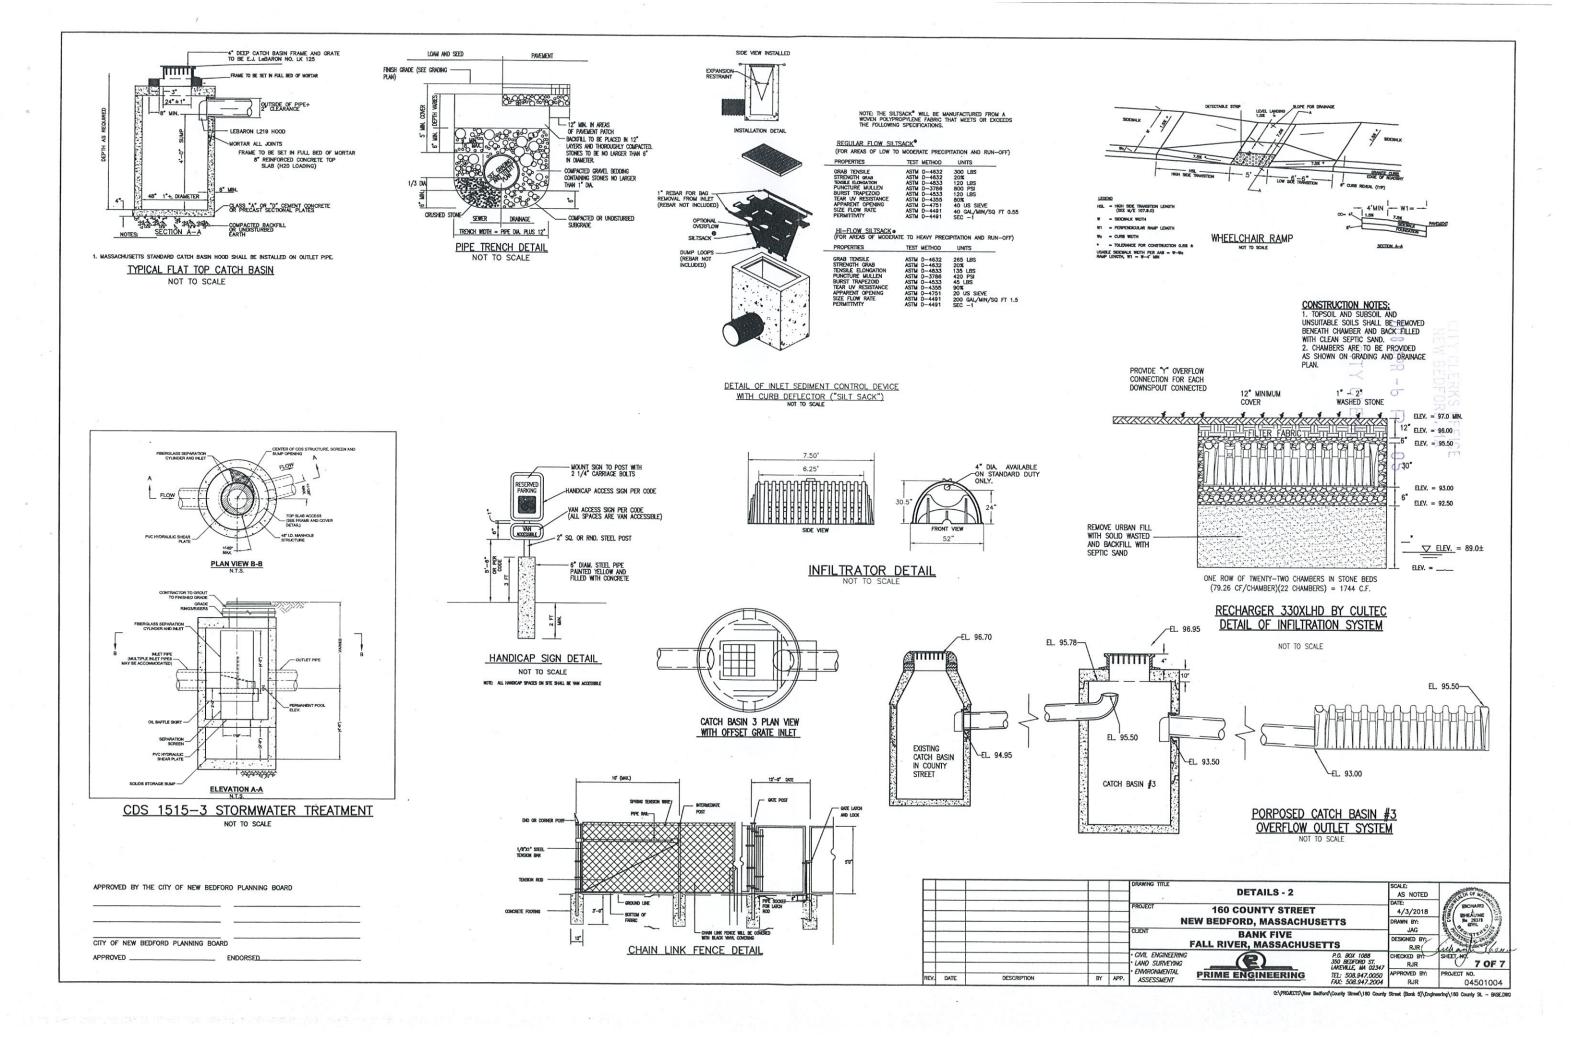

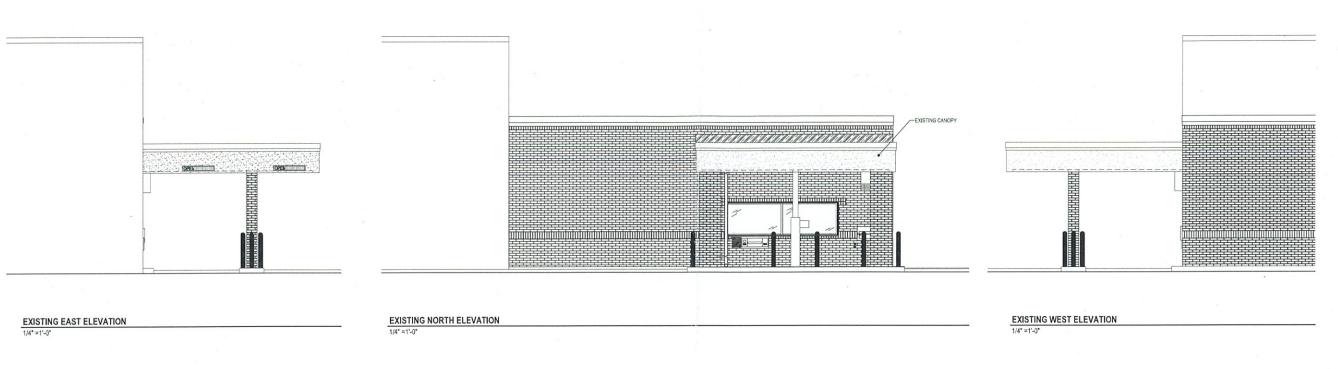

24 43

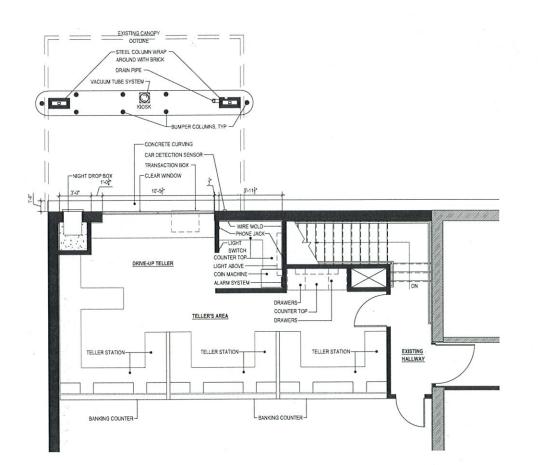

EXISTING PARTIAL FLOOR PLAN
1/4" =1"-0"

CIVITECTS

ARCHITECTURE
PROFESSIONAL CORPORATION
66 TROY STREET FALL RIVER MA 02220
T.774,355,5555 F.774,955,5167

CITY CLERK

1:05

A1.01

