
AUDREY ROSE FARMS DEFINITIVE SUBDIVISION PLAN ASSESSORS PLOT 80 - LOTS 140 & 141 NEW BEDFORD, MASSACHUSETTS

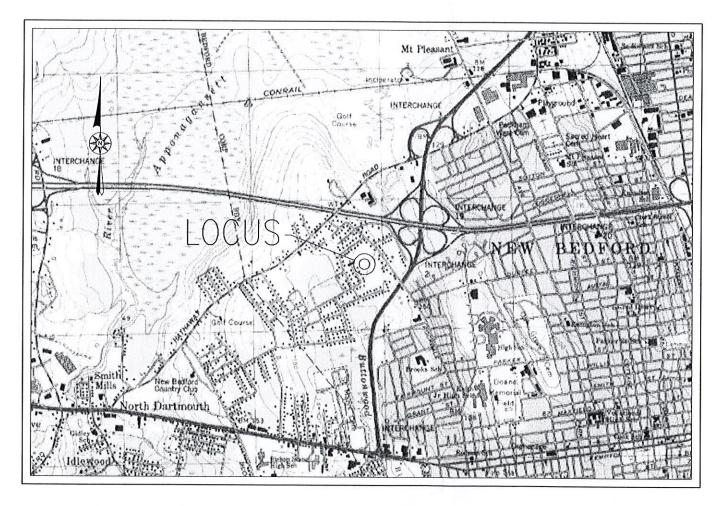

DESCRIPTION EXISTING CONDITIONS SITE DEVELOPMENT DETAILS DETAILS (CONT.) NOTES & LEGEND

SCALE: 1"=1000

ARTICLE VII. (B-2) - STREET IMPROVEMENTS REQUEST: — TO ALLOW A TWENTY-FOUR (24) FOOT WIDE PAVED ROADWAY IN LIEU OF THE REQUIRED THIRTY-FOUR (34) FOOT WIDE PAVED ROADWAY.

REQUEST: — WAIVER REQUESTED FOR SIDEWALKS DUE TO SMALL FOUR LOT SUBDIMISION AND THERE BEING NO SIDEWALKS ABUTTING OR NEAR THE

CITY CLERKS OFFIC NEW BEDFORD, MA

2017 MAY 12 P 2: 13

CITY CLERK

I CERTIFY THAT THIS PLAN COMPLIES WITH THE RULES AND REGULATIONS OF THE REGISTRY OF DEEDS.

NEW BEDFORD PLANNING BOARD APPROVAL IS REQUIRED UNDER THE SUBDIVISION CONTROL LAW.

DATE APPROVED:

I CERTIFY THAT 20 DAYS HAVE PASSED SINCE PLANNING BOARD APPROVAL AND NO APPEAL HAS

DATE ENDORSED:

CITY CLERK OF NEW BEDFORD

- ZONING DATA -

DISTRICT: RESIDENTIAL A

DESCRIPTION LOT AREA 8,000 S.F. LOT FRONTAGE 75 FT FRONT SETBACK SIDE SETBACK 10/12 FT REAR SETBACK

BUILDING COVERAGE (MAXIMUM)

ANNING

MAY 12 2017 DEPARTMENT

DEED REFERENCES: BOOK 3612 PAGE 12 BOOK 6067 PAGE 229 BOOK 6067 PAGE 231 BOOK 8883 PAGE 154

PLAN REFERENCES:
PLAN BOOK 70 PAGE 10
PLAN BOOK 114 PAGE 12
PLAN BOOK 118 PAGE 44

RECORD OWNERS: ASSESSORS PLOT 80 - LOT 141 KATHY M. DENHER 1259 ROCKDALE AVENUE NEW BEDFORD, MA 02740 BOOK 6067 PAGE 231

CHRISTIAN A. & ELIZABETH R. FARLAND 555 LANTERN LANE NEW BEDFORD, MA 02740





401 COUNTY STREET NEW BEDFORD, MA 0274 P.508.717.3479 OFFICES IN: MARLBOROUGH

DRAWN BY: MJW/CAF

DESIGNED BY: CAF

WARWICK, RI


CHECKED BY: CAF/BJM

ASSESSORS MAP 80 LOTS 140 & NEW BEDFORD, MASSACHUSETTS


SCALE: AS NOTED JOB NO. 17-345

LATEST REVISION:


COVER SHEET 1 OF 7

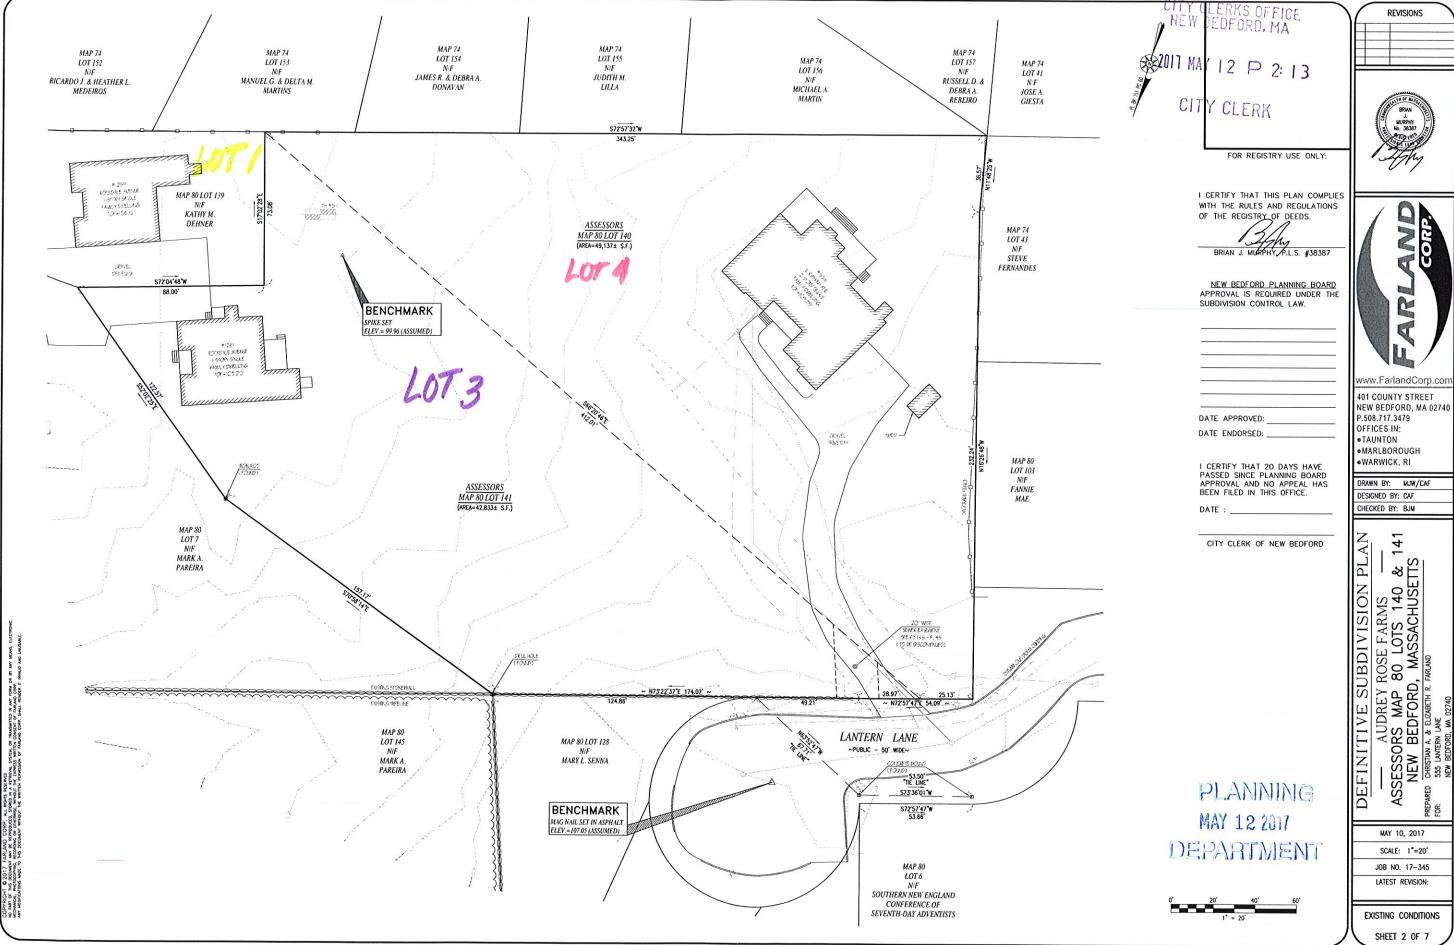


CA66 25-17

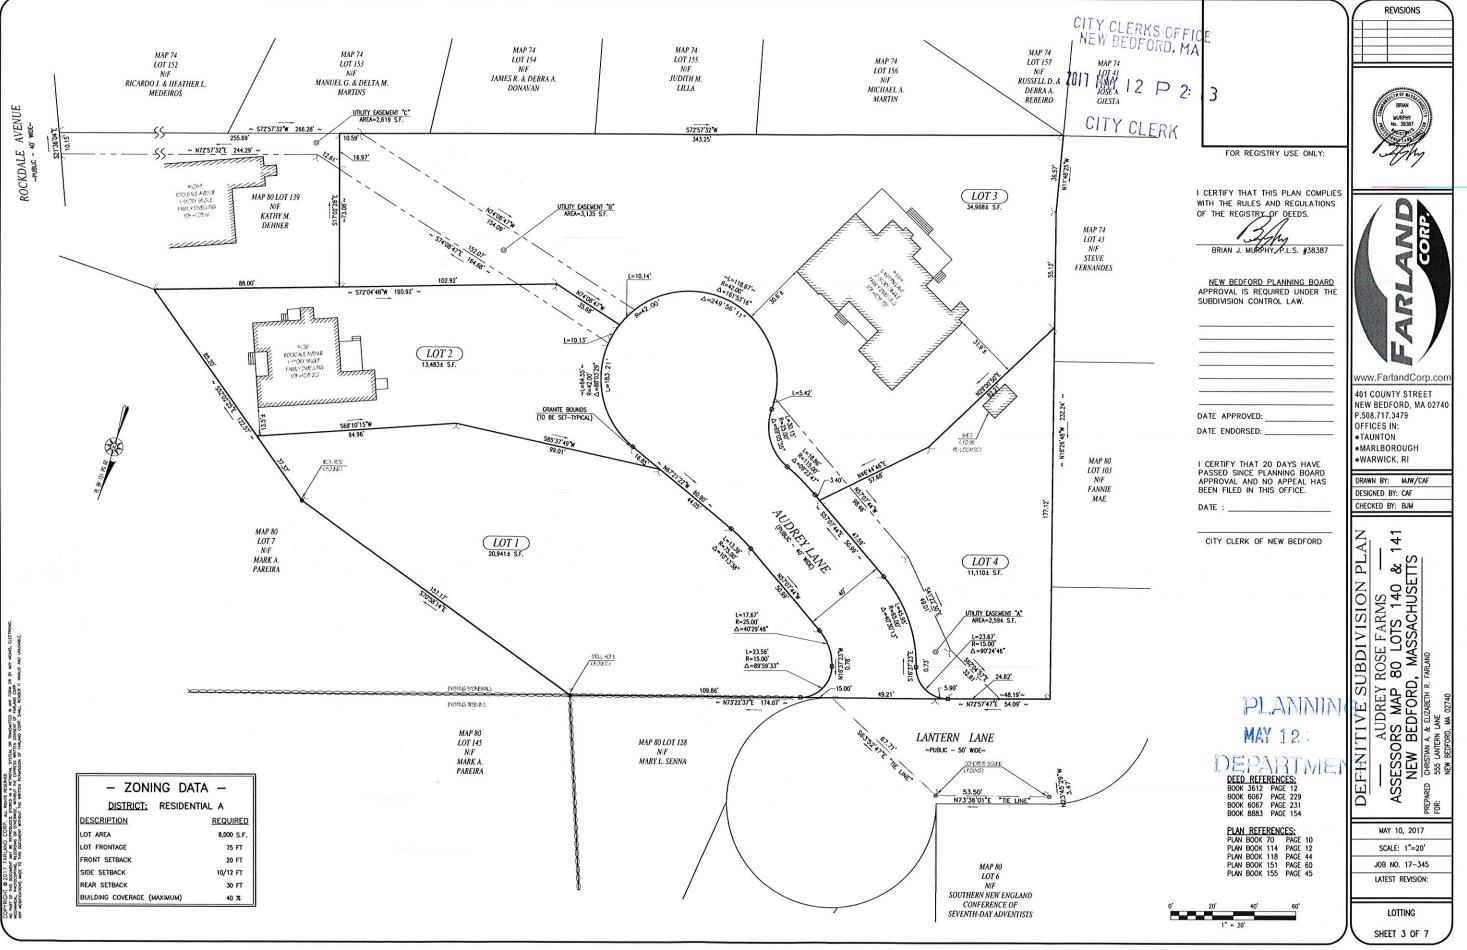



CASE 25-17

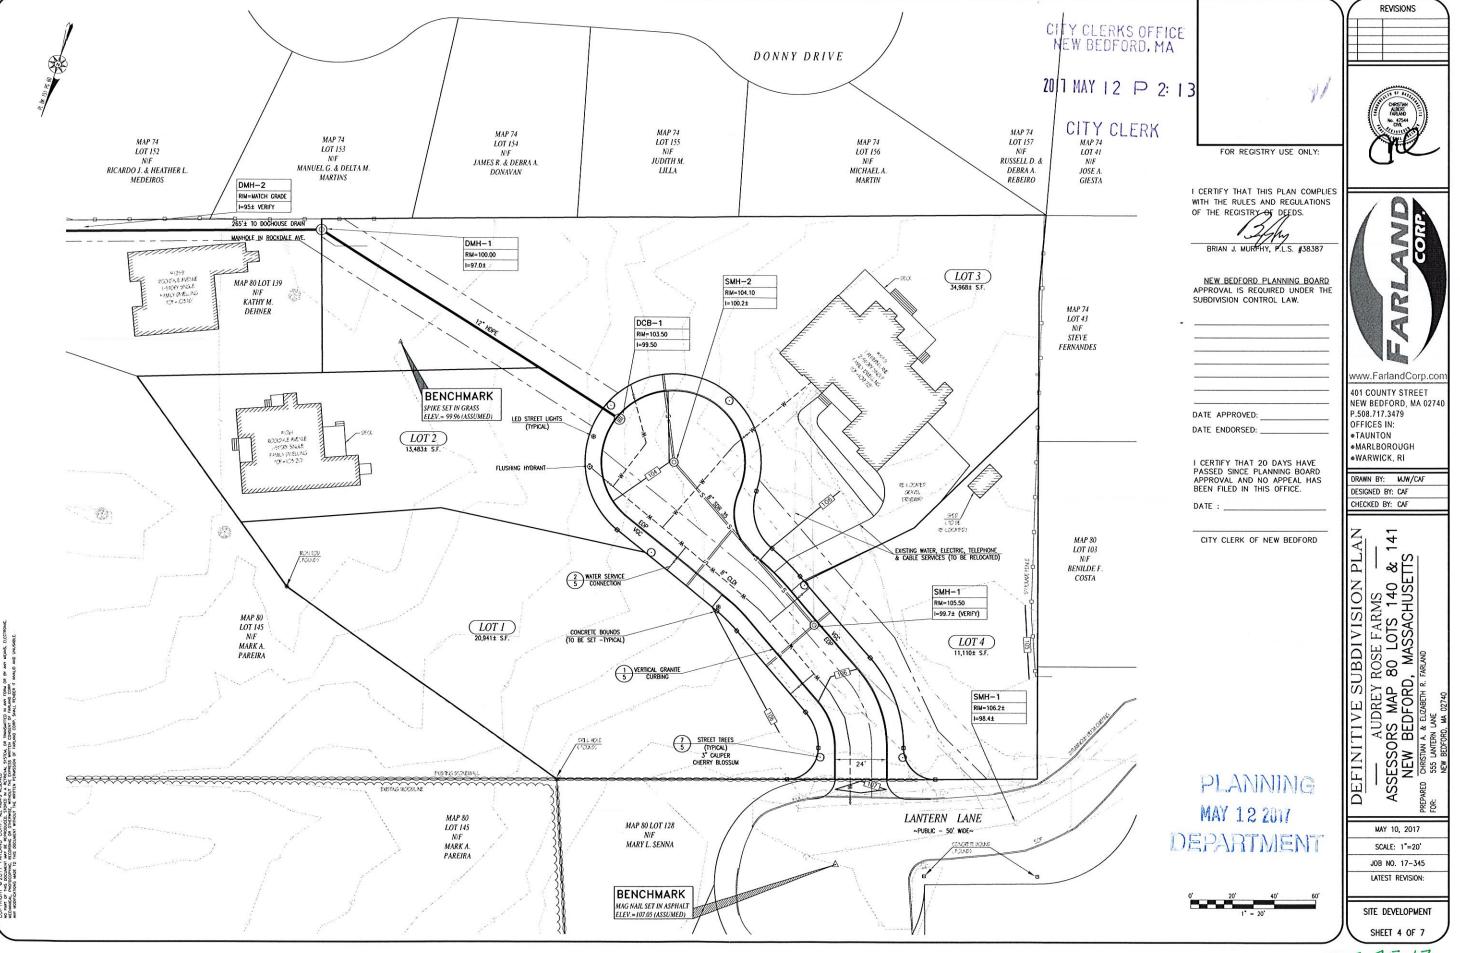

CASE 25-17

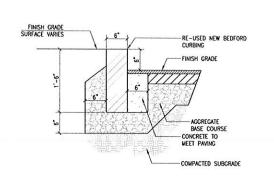

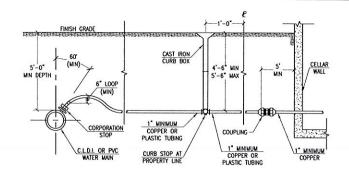

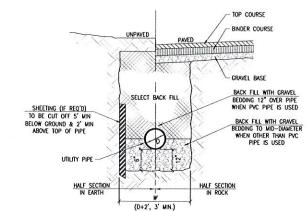



SEE PLANS FOR FINAL GRADING

EXISTING GROUND SURFACE -


TYPE-A GRAVEL BORROW COMPACTED TO 95% MAX. DRY

PROTECTION ZONE, SAND OR TYPE-C GRAVEL BORROW COMPACTED AS SPECIFIED ABOVE


MAXIMUM STONE SIZE - 2"


COMPACTED CRUSHED STONE BEDDING AGAINST UNDISTURBED

EARTH 1-1/2" MAX. STONE SIZE

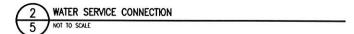




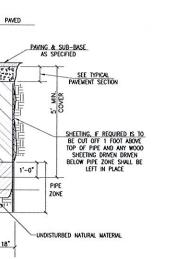

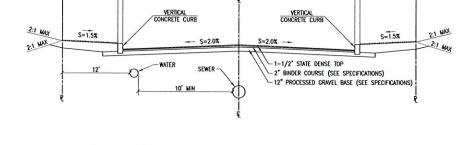


LEDGE 4 TYPICAL WATER TRENCH 5 NOT TO SCALE

ROADWAY CROSS SECTION

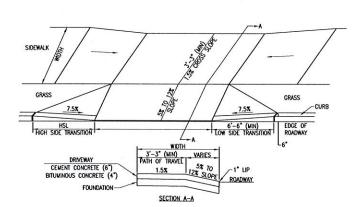

DRIVEWAY CURB CUT WITH GRASS STRIP NOT TO SCALE

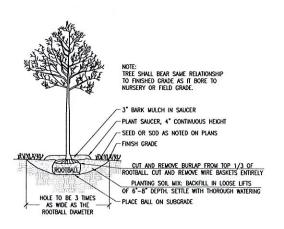

TREE PLANTING

CITY CLE RKS OFFICE FORD, MA NEW BE

2017 MAY 12 P 2: 13

CITY CLERK

FOR REGISTRY USE ONLY:

I CERTIFY THAT THIS PLAN COMPLIES WITH THE RULES AND REGULATIONS OF THE REGISTRY OF DEEDS.

BRIAN J. MURPHY, P.L.S. #38387

NEW BEDFORD PLANNING BOARD APPROVAL IS REQUIRED UNDER THE SUBDIVISION CONTROL LAW.

DATE APPROVED:

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DATE ENDORSED:

CITY CLERK OF NEW BEDFORD

CORF B

REVISIONS

CHRISTIAN ALBERT FARLAND No. 47544 CML

www.FarlandCorp.com **401 COUNTY STREET** NEW BEDFORD, MA 02740 P.508.717.3479 OFFICES IN: TAUNTON ◆MARLBOROUGH «WARWICK, RI

DRAWN BY: MJW/CAF DESIGNED BY: CAF

CHECKED BY: CAF 141

. ₹ TS AUDREY ROSE FARMS -ASSESSORS MAP 80 LOTS 140 &
NEW BEDFORD, MASSACHUSETT:
PREPARED CHRISTIAN A & ELZABETH R. FARLAND
FOR: 555 LANTERN LANE
NEW REFRESSORS

PLANNING MAY 12 2017 DEPARTMENT

SHEET 5 OF 7 CHER 25-17

MAY 10, 2017 SCALE: AS NOTED


JOB NO. 17-345

LATEST REVISION:

DETAILS

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NO MAIN OF THIS DOCUMENT WITH ERPRODUCED, STORED IN A METERNUL STYLE, OR THEMSELFED IN ANY TOWN OR ITH MANAGEMENT OF THEMSELFED WHITH COMPANY OF THEMSELFED WHITH COMPANY WENT OF THEMSELFED OF THEMSELFED WITH COMPANY OF MALLION OF THEMSELFED WITH STANDING THEMSELFED WIT

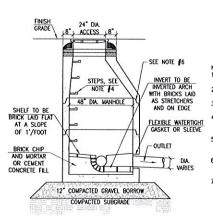

SANITARY SEWER MANHOLE

NOT TO SCALE

24" DIA. ACCESS 48" DIA MANHOLE ALTERNATE TOP SLAB (STEEL REINFORCED FOR HS-20 LOADING)

NOTES:
1. BASE SECTION SHALL BE MONOLITHIC WITH

1. BASE SECTION SHALL BE MONOUTHIC WITH A 48" INSDE DAMETER.
2. AL SECTIONS SHALL BE DESIGNED FOR INS-20 LOADING.
3. CONCRETE SHALL BE COMPRESSME STRENGTH 4000 PSI TYPE II CEMENT.
4. COPOLYMER MANHOLE STEPS SHALL BE INSTALLED AT 12" O.C. FOR THE FULL DEPTH OF THE STRUCTURE.
5. ALL EXTERIOR SURFACES SHALL BE GMEN TWO COATS OF BITUINHOUS WATER PROOFING MATERIAL.
6. JOINT STAUANT BETWEEN PRECAST SECTIONS SHALL BE PREFORMED BUTVL RUBBER.
7. STAMADAD SEWER MANHOLE FRAME SHALL BE SET IN FULL MORTAR BED. ADJUST TO GRADE WITH CLAY BRICK AND MORTAR (2 BRICK COURSES MX.)


COURSES WAX.)

DIA. ACCESS FINISH GRADE — OUTLET

- NON-SHRINK GROUT 12" COMPACTED GRAVEL - COMPACTED SUBGRADE

CEMENT CONCRETE INVERT

AND LARGER)

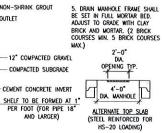

NOTES: 1. ALL SECTIONS SHALL BE DESIGNED FOR HS-20 LOADING.

2. PROVIDE "V" KNOCKOUTS FOR PIPES WITH 1" MAX. CLEARANCE TO OUTSIDE OF PIPE. MORTAR ALL PIPE CONNECTIONS

3. COPOLYMER MANHOLE STEPS SHALL BE INSTALLED AT 12" O.C. FOR THE FULL DEPTH OF THE STRUCTURE

4. JOINT SEALANT BETWEEN PRECAST SECTIONS SHALL BE PREFORMED BUTYL RUBBER.

CATCH BASIN NOT TO SCALE


6

DRAIN MANHOLE NOT TO SCALE


6

1-1/2" TOP COURSE (CLASS 1) 2" BINDER COURSE (TYPE I-1) 12" MIN RECLAIMED GRAVEL BASI COMPACTED SUBGRADE

BITUMINOUS CONCRETE PAVEMENT - RECLAIMED

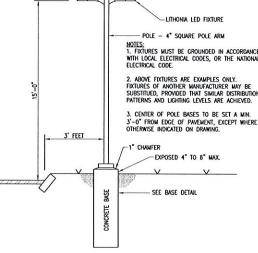

LIGHT POLE NOT TO SCALE

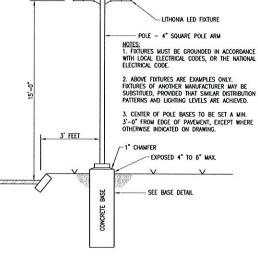


CONCRETE BOUND 6 NOT TO SCALE

NOTES: 1. ALL SECTIONS SHALL BE DESIGNED FOR HS-20 LOADING.

3. JOINT SEALANT BETWEEN PRECAST SECTIONS SHALL BE PREFORMED BUTYL RUBBER.

2. PROVIDE "V" KNOCKOUTS FOR PIPES WITH 1" MAX. CLEARANCE TO OUTSIDE OF PIPE. MORTAR ALL PIPE CONNECTIONS.

4. CATCH BASIN FRAME SHALL BE SET IN FULL MORTAR BED. ADJUST TO GRADE WITH CLAY BRICK AND MORTAR. (2 BRICK COURSES MIN. 5 BRICK COURSES MAX.)

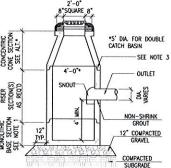

DIA. CATCH BASIN ALTERNATE TOP SLAB (STEEL REINFORCED FOR HS-20 LOADING)

3/8"DRILL HOLE

2"-0" SQUARE OPENING TYP.

5. FRAME AND GRATE TO BE EQUAL TO LEBARON LK 120 (3 FLANGE) OR LK 121 (4 FLANGE)

WITH SG-1 GRATE.

DOUBLE FRAME AND GRATE SHALL

BE LEBARON TYPE R-3531 B OR

APPROVED EQUAL BY THE

ENGINEER.

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BRIAN J. MURPHY, P.L.S. #38387

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DATE:

PLANNING

MAY 12 2011

DEPARTMENT

DATE ENDORSED:

CITY CLERK OF NEW BEDFORD

CHRISTIAN ALBERT FARLAND No. 47544 CML

REVISIONS



401 COUNTY STREET NEW BEDFORD, MA 02740 P.508.717.3479 OFFICES IN: •TAUNTON

•MARLBOROUGH WARWICK, RI DRAWN BY: MJW/CAF

DESIGNED BY: CAF CHECKED BY: CAF

ASSESSORS MAP 80 LOTS 140 & 141 PREPARED PHOREY ROSE FARMS 140 & 141 PREPARED CHRSTINS MASSACHUSETTS

PREPARED CHRSTINN A. & ELIZABETH R. FARLAND V. W. COLDEST M. SSS LUMBETH R. FARLAND V. W. COLDEST M. COLDEST M

MAY 10, 2017 SCALE: AS NOTED JOB NO. 17-345 LATEST REVISION:

> DETAILS SHEET 6 OF 7

GENERAL CONSTRUCTION NOTES

- 1. THE CONTRACTOR IS SPECIFICALLY CAUTIONED THAT THE LOCATION AND/OR ELEVATION OF EXISTING UTILITIES AND STRUCTURES AS SHOWN ON THESE PLANS IS BASED ON RECORDS OF VARIOUS UTILITY COMPANIES AND WHERE POSSIBLE, MUSUREMENTS TAKEN IN THE FELD. THIS INFORMATION IS NOT TO BE RELIED ON AS BEING EXACT OR COMPLETE. THE LOCATION OF ALL LINDREROROUND UTILITIES AND STRUCTURES SHALL BE VERHED IN THE FIELD BY THE CONTRACTOR PRIOR TO THE START OF CONSTRUCTION. THE CONTRACTOR WIST CONTRACT HE PROPRIED HEILTY COMPANY, ANY CONFERNING PERMITTING AUTHORITY, AND DID SAFE AT LEAST 72 HOURS PRIOR TO ANY EXCAMION WORK TO REQUEST EXACT FEEL LOCATION OF UTILIES INTREFERENCE WITH THE PROPOSED CONSTRUCTION AND APPROPRIATE REMEDUAL ACTION TAKEN BEFORE PROCEEDING WITH THE WORK. IT SHALL BE THE RESPONSIBILITY OF THE CONTRACTOR TO RELOCATE ALL EXISTING UTILITIES WHICH CONFIDED WITH THE PROPOSED DIFFORMED SHOWN ON THE PLAN.

 2. TOPOGORPHIC AND PROPERTY LINE SURVEY PERFORMED BY THOMPSON FARLAND, INC. IN APRIL OF 2015.

 3. ALL CONSTRUCTION SHALL BE IN ACCORDANCE WITH ALL APPLICABLE STATE AND LOCAL STANDARDS AND REGULATIONS.

- REGULATIONS.

 THE CONTRACTOR SHALL BE RESPONSIBLE FOR ESTABLISHING AND MAINTAINING ALL CONTROL POINTS AND BENCH MARKS NECESSARY FOR THE WORK.

 WHERE PROPOSED PARVENT AND WALS ARE TO MEET EXISTING, THE CONTRACTOR SHALL SAWCUT A NEAT LINE AND MATCH GRODE. SEA, ALL JOINTS WITH HOT BITUMINOUS ASPHALT JOINT SEALER.

 CURRING TO BE AS INDICATED ON THE PLANS.

 ALL EXISTING TREES, SHRUBS AND GROUND COVER WHERE NATURAL GRADE IS TO BE RETAINED SHALL BE KEPT IN THEIR EXISTING STATE UNLESS REMOVAL IS REQUIRED FOR CONSTRUCTION PURPOSES.

 ALL AREAS DISTURBED BY CONSTRUCTION AND NOT TO BE PARVE OR OTHERWISE TREATED AS NOTED ON PLAN SHALL BE TREATED WAS INCIDENCE.
- PLAN SHALL BE TREATED WITH 4" OF LOAM, SEEDED AND HAY MULCHED FOR EROSION CONTROL. STREET SHALL CONFORM TO A.D.A. SPECIFICATIONS. LIGHTIMS SHALL BE DIRECTED ON SITE AND AWAY FROM TRAFFIC INTERFERENCE.
- TEST PITS AND/OR BORINGS WERE TAKEN FOR THE PURPOSE OF DESIGN AND SHOW CONDITIONS AT BORING POINTS ONLY. THEY DO NOT NECESSARILY SHOW THE NATURE OF ALL MATERIALS TO BE ENCOUNTERED DURING CONSTRUCTION.
- ENCOUNTERED DURNO CONSTRUCTION.

 1. THE CONTRACTOR SHALL PROTECT AND/OR CAP OFF ALL EXISTING ON-SITE UTILITY SERVICES ACCORDING

 10 THE LOCAL AUTHORITY'S SPECIFICATIONS. SERVICES SHALL BE CAPPED OFF WHERE SAME ENTER THE

 PERMETER OF THE PROPERTY LINE.

 13. CONTRACTOR SHALL THOROUGHLY FAMILIARIZE THEMSELVES WITH ALL CONSTRUCTION DOCUMENTS,

 SPECIFICATIONS AND SITE CONDITIONS PRIOR TO BIDDING AND PRIOR TO CONSTRUCTION.

 1. ANY DISCREPANCES BETWEEN DEAWNINGS, SPECIFICATIONS AND SITE CONDITIONS SHALL BE REPORTED

 IMMEDIATELY TO THE OWNER'S REPRESENTATIVE FOR CLARIFICATION AND RESOLUTION PRIOR TO BIDDING OR

 CONSTRUCTION.

- CONSTRUCTION.

 THESE PLANS ARE PERMITTING PLANS AND SHALL NOT TO BE USED FOR CONSTRUCTION. A FINAL SET OF STAMPED PLANS FOR CONSTRUCTION WILL BE ISSUED AFTER RECEMING FINAL APPROVAL FROM THE LOCAL AND/OR STATE DEPARTMENTS.

GENERAL PLANTING NOTES

- ALL PLANT MATERIAL SHALL CONFORM TO THE STANDARDS OF THE AMERICAN ASSOCIATION OF NURSERYMEN OR THE PLANT MATERIAL WILL BE UNACCEPTABLE. ALL PLANT MATERIAL SHALL BE TRUE TO SPECIES, VARIETY, SIZE AND BE CERTIFIED DESEASE AND INSECT FREE. THE OWNER AND/OR THE UNDSCAPE ARCHITECT RESERVES THE RIGHT TO APPROVE ALL PLANT MATERIAL ON SITE PRIOR TO
- LANDSCAPE ARCHITECT RESERVES THE RICHT TO APPROVE ALL PLANT MATERIAL ON SITE PRIOR TO INSTILLATION.

 ALL PLANT MATERIAL SHALL BE PROPERLY GLYDE, STAKED, WRAPPED, AND PLANTED IN CONFORMANCE WITH THE THPICAL PLANTING DETAILS. GLY WIRES SHALL BE ATTACHED TO THE TERE TA FEGERT OF TWO—THERDS THE HEIGHT OF THE TREE AND SHOULD BE LOCATED AT POINTS SO AS NOT TO SPLIT THE TRUNK OF MULTI-STEMBLED TREES. PROVIDE THEE STAKES PER TIREE UNILESS NOTED OTHERWISE INSTILL ALL PLANT MATERIAL ON UNDISTURBED GRADE. PROVIDE BURLAP WRAPPING WITH A 50% OVERLAP. CUT AND REMOVE BURLAP FROM TOP DONE—THIRD OF THE ROOT BULL PLANTING PITS WITH ONE PART EACH OF TOP SOIL, PEAT MOSS, AND PARENT MATERIAL. IF WET SOIL CONDITIONS EXIST THEN PLANTING PITS SHALL BE EXCANATED AN ADDITIONAL 12" AND FILLED WITH SAND.

 NEWLY INSTALLED PLANT MATERIAL. SHALL BE WATERED AT THE TIME OF INSTALLATION AND SHALL BE SUBSEQUENTLY SHOULD WITH SAND.

- NEWLT INSTALLED PLANT MATERIAL SHALL BE WAITED AT THE TIME OF INSTALLATION AND SHALL BE SUBSEQUENTLY FLOODED THE WENT THE STABLISHENT, GROWTH AND SURVIVAL OF ALL PLANTS. SHALL BE PROVIDED TO ENSURE THE ESTABLISHENT, GROWTH AND SURVIVAL OF ALL PLANTS. ALL PLANT MATERIAL SHALL BE GUARANTEED FOR ONE YEAR ATTER THE DATE OF FINAL ACCEPTANCE. ANY PLANT MATERIAL THAT DIES WITHIN THAT TIME PERIOD SHALL BE REMOVED, INCLUDING THE STUMP, AND REPLACED WITH MATERIAL OF SIMILAR SIZE AND SPECIES AT THE EXPENSE OF THE DEVELOPER. THE REPLACED FLANT MATERIAL SHALL BE GUARANTEED FOR ONE YEAR ATTER THE REPLACEMENT DATE.
- REPLACED PLAIT MATERIAL SHALL BE CURRANTEED FOR ONE YEAR AFTER THE REPLACEMENT DATE.

 6. THE LANGEOCRE CONTROLCTOR SHALL PROVIDE A MINIMUM A* LAYER OF TOPSOIL IN ALL LAWN AREAS AND
 A MINIMUM OF 6* OF TOPSOIL IN ALL PLAITING AREAS. A FULL SOIL ANALYSIS SHALL BE COMDUCTED
 A THER CONSTRUCTION AND PRIOR TO PLAITING TO DETERMINE THE EXTENT OF SOIL AMENDMENT REQUIRED.

 7. ALL DISTURBED LAWN AREAS SHALL BE STABILIZED WITH ETHER SOOL ON SEED. SEED SHALL CONSIST OF A MIXTURE COMPLANT WITH COVERNING REGULATIONS. ALL DISTURBED LAWN AREAS SHALL BE TOP SOILED, LIMED, FRETILIZED, AND FINE GRADED PROOR TO LAWN INSTILLATION.

 8. ALL PLAITING BEDS SHALL RECEIVE 3* OF SHREODED PINE, CEDAR OR HEMLOCK BARK.

 9. ALL SHRUB MASSES SHALL BE PLANTED IN CONTINUOUS MULCHED BEDS.

 10. ALL TREES ARE TO BE GUYED, 3 EACH, UNLESS OTHERWISE MOTED ON PLAN.

 11. ALL DECIDIOUS TREES ARE TO BE WRAPPED, WITH TREE WRAP, UP TO THE FIRST BRANCHING AND SECURED.

- 12. THE LANDSCAPE CONTRACTOR IS TO PERFORM ALL CONTRACTED WORK IN A REASONABLE PERIOD OF
- THE LANDSCAPE CONTRACTOR IS TO MAINTAIN PLANT MATERIAL WHILE THE PROJECT IS UNDERWAY AND FOR A PERIOD OF TWO WEEKS AFTER THE COMPLETION OF THE PROJECT UNLESS OTHERWISE SPECIFIED.

 14. THE CONTRACTOR IS TO CLEAN UP AND REMOVE ANY DEBRIS FROM THE SITE, CAUSED BY THE LANDSCAPE CONTRACTOR.

UTILITY AND GRADING NOTES

- ALL ON-SITE STORM DRAINAGE PIPES SHALL BE HIGH DENSITY POLYETHYLENE PIPE (HDPE) OR RCP, UNLESS NOTED OTHERWISE.
 HDDE PIPE SHALL CONFORM WITH AMSHTO DESIGNATIONS M294 AND M252, SHALL BE MANUFACTURED WITH HIGH DENSITY POLYETHYLENE PLASTIC AND SHALL BE ADS N-12 PIPE AS MANUFACTURED BY ADVANCE DRAINAGE SYSTEM, INC. OR HANCOR HI Q PIPE AS MANUFACTURED BY HANCOR, INC. OR APPROVED EQUAL UNLESS OTHERWISE MOTED OR DETAILED.
- A MINIMUM OF 18" VERTICAL CLEARANCE SHALL BE MAINTAINED WHERE WATER SERVICES CROSS STORM
- ALL SERVICE CONNECTIONS SHALL BE INSTALLED TO A POINT OF 10 FEET FROM THE BUILDING WALL UNLESS OTHERWISE NOTED OR DETAILED
- ONLESS CHECKINGS WILLD OR DISTALLED WITH A MINIMUM OF 5 FEET OF COVER AND A MAXIMUM OF 6
 FEET OF COVER EXCEPT AS NOTED OR DETAILED OTHERWISE. GREATER DEPTHS ARE PERMITTED WHERE
 REQUIRED TO AVOID CONTLICTS WITH OTHER UTILITIES.

 GENERALLY, WATER MAIN FITTINGS IDENTIFIED ON THIS DRAWING ARE SHOWN FOR INSTALLATION LOCATION
- PURPOSE. THE CONTRACTOR SHALL NOTE THAT NOT ALL FITTINGS ARE NOTED, SHOWN OR INDICATED.

 7. ALL WATER MAIN FITTINGS, TEES, BENDS, HYDRANTS, ETC. SHALL BE RESTRAINED WITH CONCRETE THRUST
- ALL HIDRANTS SHALL BE INSTALLED WITH A 6" CL.D.I. RUNOUT AND SHALL BE INSTALLED WITH PROPRIETLY SIZED GATE VIACE, BOX, AND THE FITTING. ALL HYDRANTS SHALL MET LOCAL MUNICIPAL SPECIFICATION REQUIREMENTS AND SHALL BE INSTALLED IN ACCORDANCE WITH ALL LOCAL MUNICIPAL

- SPECIFICATION REQUIREMENTS AND SMALL BE INSTALLED IN ACCORDANCE WITH ALL LOCAL MUNICIPAL REQUIREMENTS.

 9. DOMESTIC WAITER SERVICES 2.5° AND SMALLER SHALL BE TYPE K COPPER TUBING AND SHALL BE INSTALLED WITH APPROPRIATELY SUZED CORPORATION STOP AND APPROVED SADDLE CURB STOP, AND BOX, USING MATERIALS SPECIFIED BY THE MUNICIPAL WRITE DEPARTMENT OR COMPANY.

 10. ALL WAITER MAINS 3° AND LARGER SHALL BE CEMENT LINED DUCTLE IRON CLASS 52, AND SHALL BE INSTALLED WITH APPROPRIATELY SUZED ITTITIOS AND CATE VALVES.

 11. ALL WAITER MAIN APPURIEMANCES, MATERIALS, METHODS OF INSTALLATION AND TESTING REQUIREMENTS.

 12. PRESSURE AND LEAVAGE TEST, DISINFECTION AND FLUSHING SHALL BE IN ACCORDANCE WITH ALL LOCAL MUNICIPAL REQUIREMENTS.

 13. PRIMARY WAITER METER AND BACKFLOWNES OF SHALL BE CASEONSIBLE FOR ALL COSTS IN CONNECTION WITH UTILITY TESTS, FLUSHING AND INSPECTIONS SHALL BE RESPONSIBLE FOR ALL COSTS IN CONNECTION WITH UTILITY TESTS, FLUSHING AND INSPECTIONS AS REQUIRED BY THE LOCAL MUNICIPALITY.

 13. PRIMARY WAITER METER AND BACKFLOW PREVENTER SHALL BE LOCATED AT THE POINT WHERE THE WAITER LINE ENTIRES THE BUILDING UNLESS OTHERWISE NOTED OR DETIALED ON THE DRAWNINGS.

 14. ALL GRAWIT SEWER PIPE SHALL BE POOP FOR FAILS BE LOCATED ON THE PORTING.

 15. WHERE SAMITARY SEWERS FOR SEVERY SHALL BE LAID AT SUCH AN ELEVATION THAT THE CROWN OF THE SEWER IS AT LEAST BIOHTEEN INCHES BELOW THE METERT OF THE WAITER MAN. IF THE ELEVATION OF THE SEWER IS AT LEAST BIOHTEEN INCHES BELOW THE METER OF THE WAITER MAN. IF THE ELEVATION OF THE SEWER SO THAT BOTH JOINTS WILL BE AS FAR AS THE SEWER AS POSSIBLE. IF MEETING OF THE SEWER SO THAT BOTH JOINTS WILL BE AS FAR AS THE SEWER AS POSSIBLE. IF MEETINGLE JOINT AND AND ASSISTED OF THE SEWER. ON THE WAITER MAN SHALL BE CENTERED OVER THE SEWER SO THAT BOTH JOINTS WILL BE AS FAR AS THE SEWER AS POSSIBLE. IF MEEHANGLE, JOINT PIPE IS NOT USED OF THE SEWER. ON THE WAITER MAN SHALL BE CENTERED WORT THE SERVER ON THAT FORM JOINTS MILL BE AS FAR AS THE SEWER SO THAT BOTH JOINTS WILL BE AS FAR AS THE SEW
- OR DETAILED.

 THE EOVELOPMENT SITE IS GRADED, THE AREA OF THE DRAINAGE BASINS SHOULD BE FENCED
 OFF TO PREVENT HEAVY EQUIPMENT FROM COMPACTING THE UNDERLYING SOIL.

 WHERE PROPOSED GRADES MEET INSTING GRADES, CONTACTOR SHALL BLEND GRADES TO PROVIDE A
 SMOOTH TRANSITION BETWEEN EXISTING AND NEW WORK. PONDING AT TRANSITION AREAS WILL NOT BE
- SMOOTH INMOSTREE EASTING AND RET WORK TO ALLOWED.

 19. CONTRACTOR SHALL MAINTAIN POSITIVE DRAINAGE AWAY FROM ALL BUILDING FOUNDATIONS AND
- STRUCTURES.

 O MAXIMUM SLOPE IN DISTURBED AREAS SHALL NOT EXCEED 3:1, UNLESS OTHERWISE NOTED.

 CONTRACTOR SHALL VERIFY EXISTING GRADES AND NOTIFY OWNER'S REPRESENTATIVE OF ANY

- 21. CONTRACTOR SHALL VERIFY EXISTING GRADES AND NOTIFY OWNER'S REPRESENTATINE OF ANY DISCREPANCIES.
 22. CONTRACTOR SHALL ADJUST UTILITY ELEMENT MEANT TO BE FLUSH WITH GRADE THAT IS AFFECTED BY SITE WORK OR GRADE CHANGES, WHETHER SPECIFICALLY NOTIED ON PLANS OR NOT.
 23. WHERE AN EXISTING UTILITY IS FOUND TO CONFLICT WITH THE PROPOSED WORK, THE LOCATION, ELEVATION AND SIZE OF THE UTILITY SHALL BE ACCURATELY DETERMINED WITHOUT DELAY BY THE CONTRACTOR, AND THE INFORMATION FUNNISHED TO THE OWNER'S REPRESENTATIME FOR RESOLUTION OF THE CONCIL.
 24. THE CONTRACTOR SHALL MAKE ALL ARRANGEMENTS FOR THE ALTERATION AND ADJUSTMENT OF ALL GAS, ELECTRIC, TELEPHONE AND DAY OTHER PRAYALE UTILITIES BY THE UTILITY COMPANIES.
 25. ELECTRICAL DUCT BANK LOCATION IS SHOWN FOR COORDINATION PURPOSES, REFER TO ELECTRICAL PLANS FOR SECTIONS AND DETAILS OF THE UTILITY DUCT BANK.
 26. THE LOCATION, SIZE, DEPTH AND SPECIFICATIONS FOR CONSTRUCTION OF PRIVATE UTILITY SERVICES SHALL BE INSTALLED ACCORDING TO THE REQUIREMENTS PROVIDED BY AND APPROVED BY THE RESPECTIVE UTILITY COMPANY (CAS, TELEPHONE AND ELECTRICAL), FINAL DESIGN AND LOCATIONS AT THE BUILDING
- UTILITY COMPANY (GAS, TELEPHONE AND ELECTRICAL). FINAL DESIGN AND LOCATIONS OF THE BUILDING WILL BE PROVIDED BY THE ARCHITECT. THE COMPACIOR SHALL CORRINATE THE INSTALLATION OF THE UTILITY CONSTRUCTION.

LEGEND

21421113		I NOI OSED
	CONTOUR LINE	101
#CH	SPOT GRADE	+101.1
EP	EDGE OF PAVEMENT	EOP
v%	VERTICAL GRANITE CURB	VGC
5X	SLOPED GRANITE CURB	SGC
ISS.	VERTICAL CONCRETE CURB	VCC
92	BITUMINOUS CONCRETE CURB	BCC
503	CAPE COD BERM	CCB
- 2000000000000000000000000000000000000	STONE WALL	- *************************************
×	CHAIN LINK FENCE	— x — x
ΔΔ	IRON FENCE	<u> </u>
	POST & RAIL FENCE	
	STOCKADE FENCE	
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DETAIL NUMBER

NOT TO SCALE

2

SAMPLE DETAIL

NUMBER REFERENCES WHAT SHEET THE DETAIL

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CCD	CAPE COD BERM	CCB
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FOR REGISTRY USE ONLY:
I CERTIFY THAT THIS PLAN COMP WITH THE RULES AND REGULATION OF THE REGISTRY OF DEEDS.
Zyphy
BRIAN J. MURPHY, P.L.S. #38387 NEW BEDFORD PLANNING BOAR APPROVAL IS REQUIRED UNDER T SUBDIVISION CONTROL LAW.
-
DATE APPROVED: DATE ENDORSED:
I CERTIFY THAT 20 DAYS HAVE PASSED SINCE PLANNING BOARD
APPROVAL AND NO APPEAL HAS BEEN FILED IN THIS OFFICE.

CHRISTIAN ALBERT FARLAND No. 47544 CML GISTRY USE ONLY T THIS PLAN COMPLIES ES AND REGULATIONS TRY OF DEEDS. COR JF/Hy JRPHY, P.L.S. #38387 ORD PLANNING BOARD REQUIRED UNDER THE

REVISIONS

ww.FarlandCorp.co 401 COUNTY STREET NEW BEDFORD, MA 02740 P.508.717.3479

C

OFFICES IN: TAUNTON MARLBOROUGH .WARWICK, RI

DATE :

CITY CLERK OF NEW BEDFORD

PLANNING

MAY 12 2017

DEPARTMENT

DRAWN B	MJW/CAF	_
DESIGNED BY!	CAF [T]	
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1/24 BDIVISION

AUDREY ROSE FARMS, AUDREY ROSE FARMS, AND BO LOTS 140 ET 16 PREPARED CHRISTIAN A ELIZABETH R. FARLAND ASSACHUSETTS SSS LAWIER LAWE NEW BEFFERD AND A SSS LAWIER LAWIER LAWE NEW BEFFERD AND A SSS LAWIER LAW

> MAY 10, 2017 SCALE: AS NOTED JOB NO. 17-345 LATEST REVISION:

NOTES & LEGEND SHEET 7 OF 7

SOIL EROSION AND SEDIMENT CONTROL NOTES

- SOIL EROSION AND SEDIMENT CONTROL PRACTICES IN THE PLAN SHALL BE CONSTRUCTED IN ACCORDANCE WITH THE PLANS AND SPECIFICATIONS
- ALL APPLICABLE SOIL EROSION AND SEDIMENT CONTROL PRACTICES SHALL BE IN PLACE PRIOR TO ANY DEMOLITION GRADING OPERATIONS AND/OR INSTALLATION OF PROPOSED

- 2. STRUCTURES OR LITTLESS.

 3. ALL APPLICABLE SOIL EROSION AND SEDIMENT CONTROL PRACTICES SHALL BE LEFT IN PLACE UNITL CONSTRUCTION IS COMPLETED AND/OR THE AREA IS STABILIZED.

 4. ALL SOIL EROSION AND SEDIMENT CONTROL STRUCTURES SHALL BE INSPECTED AND MAINTAINED ON A REQUIAR BASIS AND AFTER VERY STORM EVENT.

 5. THE MAINTENANCE OF SOIL EROSION AND SEDIMENT CONTROL MEASURES AND FACILITIES DURING AND IMMEDIATELY AFTER CONSTRUCTION RESIS WITH THE GENERAL CONTRACTOR.

 1. DIPON ACCEPTIANCE OF THE PROJECT, THE OWNER SHALL BECOVER RESPONSIBLE FOR MAINTENANCE OF CONSTRUCTION RESIS WITH THE GENERAL CONTRACTOR.

 2. DIPON MICCEPTIANCE OF THE PROJECT, THE OWNER SHALL BECOVER RESPONSIBLE FOR MAINTENANCE OF MAINTENANCE PAREAS SHALL BE PROTECTED FROM EXCAPATION AND FILLING OPERATIONS AT ALL TIMES.

 3. THE CONTRACTOR SHALL UTILIZE ALL METHODS NECESSARY TO PREVENT BLOWING AND MOVEMENT OF DUST FROM THE EXPOSED SOIL SURFACES.

 4. PAMED RODOMAN'S MUST BE KEDT CLEAN AT ALL TIMES.

 5. THE CONTRACTOR SHALL BE PROTECTED FROM EXCAPATION AND FINANCE EXISTS.

 5. ALL CATCH BASIN NILLES SHALL BE PROTECTED BY AN EXPOLED ON THE PLAN, IF APPLICABLE.

 6. ALL CATCH BASIN NILLES SHALL BE PROTECTED BY AN EXPOLED ON THE PLAN, IF APPLICABLE.

 7. ALL CATCH BASIN NILLES SHALL BE PROTECTED BY AN EXCOUNTED HORSING DISCHARCE POINTS BECOME OPERATIONAL.

 7. ALL LATCH BASIN NILLES SHALL BE PROTECTED BY AN EXCOUNTED HEREON BEFORE DISCHARCE POINTS BECOME OPERATIONAL.

 7. ALL CATCH BASIN NILLES SHALL BE PROTECTED AND RECOVER THE PLAN IF A POLICE OF SHALL BUSINESS.

 7. ALL CATCH BASIN NILLES SHALL BE PROTECTED THAT SHALL BE PROTECTED TO AN EXCOUNTED HEREON BEFORE DISCHARCE POINTS BECOME OPERATIONAL.

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 7. ALL CATCH BASIN NILLES SHALL BE PROTECTED AS REQUIRED HEREON BEFORE DISCHARCE POINTS BECOME OPERATIONAL.

 7. ALL CATCH BASIN DEPARTMENT AND THE LEFT E AND TRAVERLED FROM THOME EXCENS.

 ANY DISTRIBUTED AREA THAT WILL BE LEFT EXPOSED FOR MORE THAN SIXTY (60) DAYS AND NOT SUBJECT TO CONSTRUCTION TRAFFIC SHALL IMMEDIATELY RECEME A TEMPORARY SEEDING AND FERTILIZATION. IF THE SEASON PROHIBITS TEMPORARY SEEDING, THE DISTRIBUTED AREAS SHALL BE MUICHED.

 16. ALL CRITICAL AREAS SUBJECT TO EROSION SHALL RECEME A TEMPORARY SEEDING AND BE MUICHED IN ACCORDANCE WITH THE SPECIFICATIONS IMMEDIATELY FOLLOWING ROUGH GRADING.

- GRADING.

 17. IMMEDIATELY AFTER COMPLETION OF STRIPPING AND STOCKPILING OF TOPSOIL, SEED THE STOCKPILE WITH ANNUAL RYE GRASS. STABILIZE TOPSOIL STOCKPILES WITH STRAW MULCH FOR PROTECTION IF THE SEASON DOES NOT PERMIT THE APPLICATION AND ESTABLISHMENT OF TEMPORARY SEEDING.

 18. SOIL STOCKPILES ARE NOT TO BE LOCALED WITHIN FIFTY (50) FEET OF WETLANDS, THE FLOODERUN, SLOPE, ROJAWAY OR DRAINAGE FACILITIES. THE BASE OF ALL STOCKPILES SHALL BE PROTECTED BY A HAY BALL BRABTER OR SEDIMENT FENCE.

 19. MAXIMUM SIDE SLOPES OF ALL DEPOSED SURFACES SHALL NOT BE CONSTRUCTED STEEPER THAN 3-11 UNLESS OTHERWISE APPROVED BY THE DISTRICT.

 20. ALL AREAS NOT STABLEDE BY CONSTRUCTION, SODOING OF LANDSCAPING SHALL BE SEEDED AND STABILIZED IN ACCORDANCE WITH THE SEEDING AND MULCHING SPECIFICATIONS.

 21. MULCHING IS REQUIRED ON ALL SEEDED AREAS TO INSURE AGAINST EROSON BEFORE GRASS IS ESTABLISHED TO PROMOTE EARLIER VEGETATIVE COVER.

 22. ALL DEWARTERING OPERATIONS MULST DESCHARED SECHARE DEPOSED AND STABLIZED WITH THE SEDIMENT AND BE PLACED SO AS NOT TO CAUSE EROSION OF THE DOWNSTREAM AREA.