PROPOSED MODIFICATION TO


CITY CLERKS OFFICE

2017 FEB 10 P 2: 14

DEFINITIVE SUBDIVISION PLANK

NORTHSIDE FARM

NEW BEDFORD, MA 02745

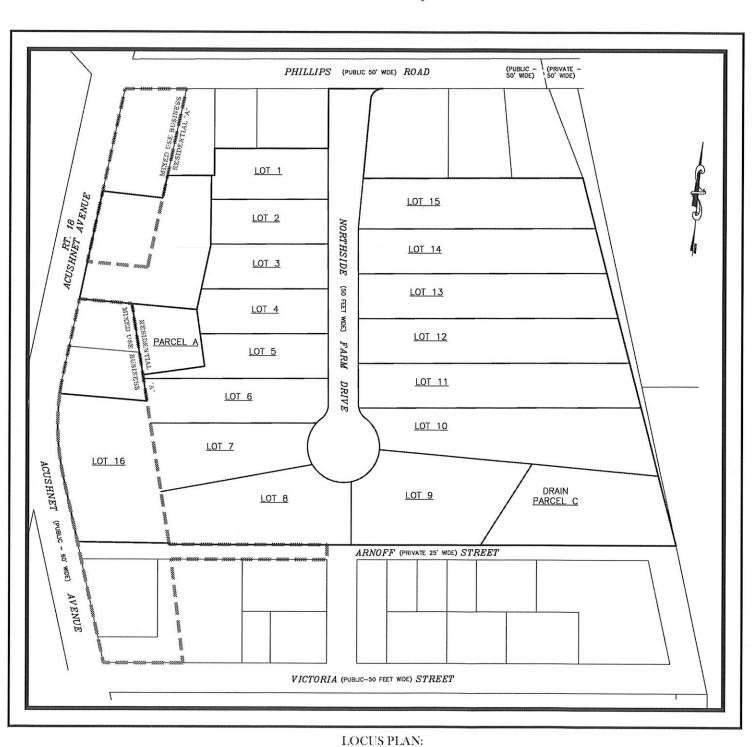

SCALE: 1" = 80'

SITE SUMMARY:

OWNER/APPLICANT: NEW BEDFORD COUSINS LLC P.O. BOX 36

ASSESSORS INFORMATION: MAP 130 BLOCK D LOTS

USE BUSINESS

SHEET INDEX:

TITLE SHEET - TS (SHEET 1 OF 10)

EXISTING CONDITIONS - EC (SHEET 2 OF 10)

LOT LAYOUT - LL (SHEET 3 OF 10)

GRADING & DRAINAGE - GD (SHEET 4 OF 10) DRAINAGE LAYOUT - DL (SHEET 5 OF 10)

ROADWAY PROFILE - RP (SHEET 6 OF 10) DETAIL SHEET I - DTI (SHEET 7 OF 10)

DETAIL SHEET II - DTII (SHEET 8 OF 10)

DETAIL SHEET III - DTIII (SHEET 9 OF 10)

STREET TREES & LIGHTING - TL (SHEET 10 OF 10)

ZONING DISTRICT:

SCITUATE, MA 02066

117, 379-387, 392-419

RESIDENTIAL A & MIXED

I HEARBY CERTIFY THAT 20 DAYS HAVE ELAPSED

CITY OF NEW BEDFORD CLERK

FOR REGISTRY USE ONLY

SEE COVENANT DATED _ RECORDED IN BOOK _____ PAGE ___

ZONING REQUIREMENTS:

ITEM	REQUIRED	PROVIDED
LOT AREA	8,000 SF	8,000 S.F. MIN.
UPLAND (80%)	6,400 SF	> 8,000 S.F.
FRONTAGE	75 FT	75 FT MIN.
FRONT SETBACK	20 FT	20 FT
SIDE SETBACK	10 & 12 FT	10 & 12 FT
REAR SETBACK	30 FT	30 FT MIN.
MAX. BLDG. HEIGHT	45 FT	<45 FT
MAX. LOT COVERAGE	30%	<30%
MIN. GREEN SPACE	35%	>35%

I HEREBY CERTIFY THAT THIS PLAN HAS BEEN PREPARED IN CONFORMANCE WITH THE RULES AND

2/9/17





DRAWING REVISIONS

LAND COURT PLAN #23553-A

BOARD OF SURVEY PLAN #S: 24, 39, 398, 390, 80

MASS HIGHWAY DEPT. FIELD BOOK #'S:

BOAR



NORTHSIDE FAR **MODIFICATIO**

TITLE SHEET

CAVANARO CONSULTI

687 MAIN STREET P.O. BOX 5175

NORWELL, MASSACHUSETTS 02061 PHONE: 781.659.8187 FAX: 781.659.8186

OWNER/APPLICANT:

NEW BEDFORD COUSIN P.O. BOX 36 SCITUATE, MA 0206


PROJECT NO. : 5005 DRAWING

SCALE : AS SHOWN DATE: 2/9/17

DESIGNED BY : BPS

DRAWN BY : BPS

Case 07-17 02/10/2017

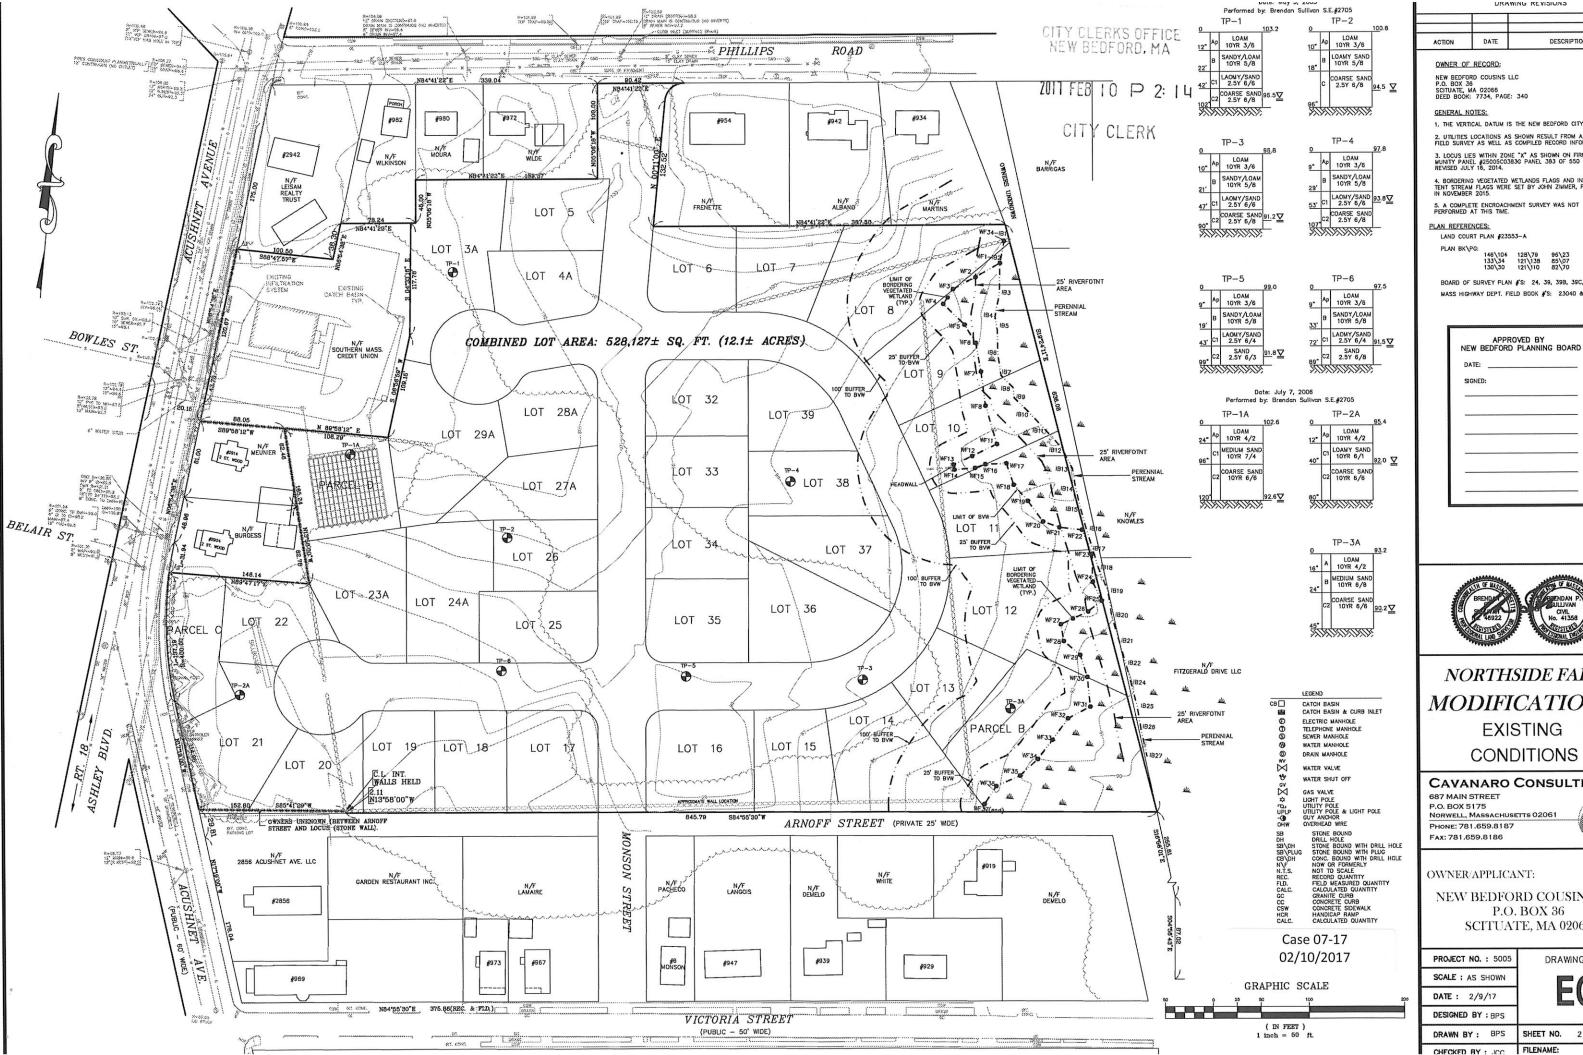

DATE

OWNER OF RECORD:

1. THE VERTICAL DATUM IS THE NEW BEDFORD CITY

PLAN REFERENCES:

LAND COURT PLAN #23553-

BOARD OF SURVEY PLAN #S: 24, 39, 398, 390,

APPROVED BY



NORTHSIDE FAI **MODIFICATIO EXISTING**

CONDITIONS

CAVANARO CONSULTI

P.O. BOX 5175


NORWELL, MASSACHUSETTS 02061 PHONE: 781.659.8187

FAX: 781.659.8186

OWNER/APPLICANT:

NEW BEDFORD COUSIN P.O. BOX 36 SCITUATE, MA 0206

PROJECT NO.: 5005 DRAWING SCALE : AS SHOWN DATE: 2/9/17 DESIGNED BY : BPS SHEET NO.

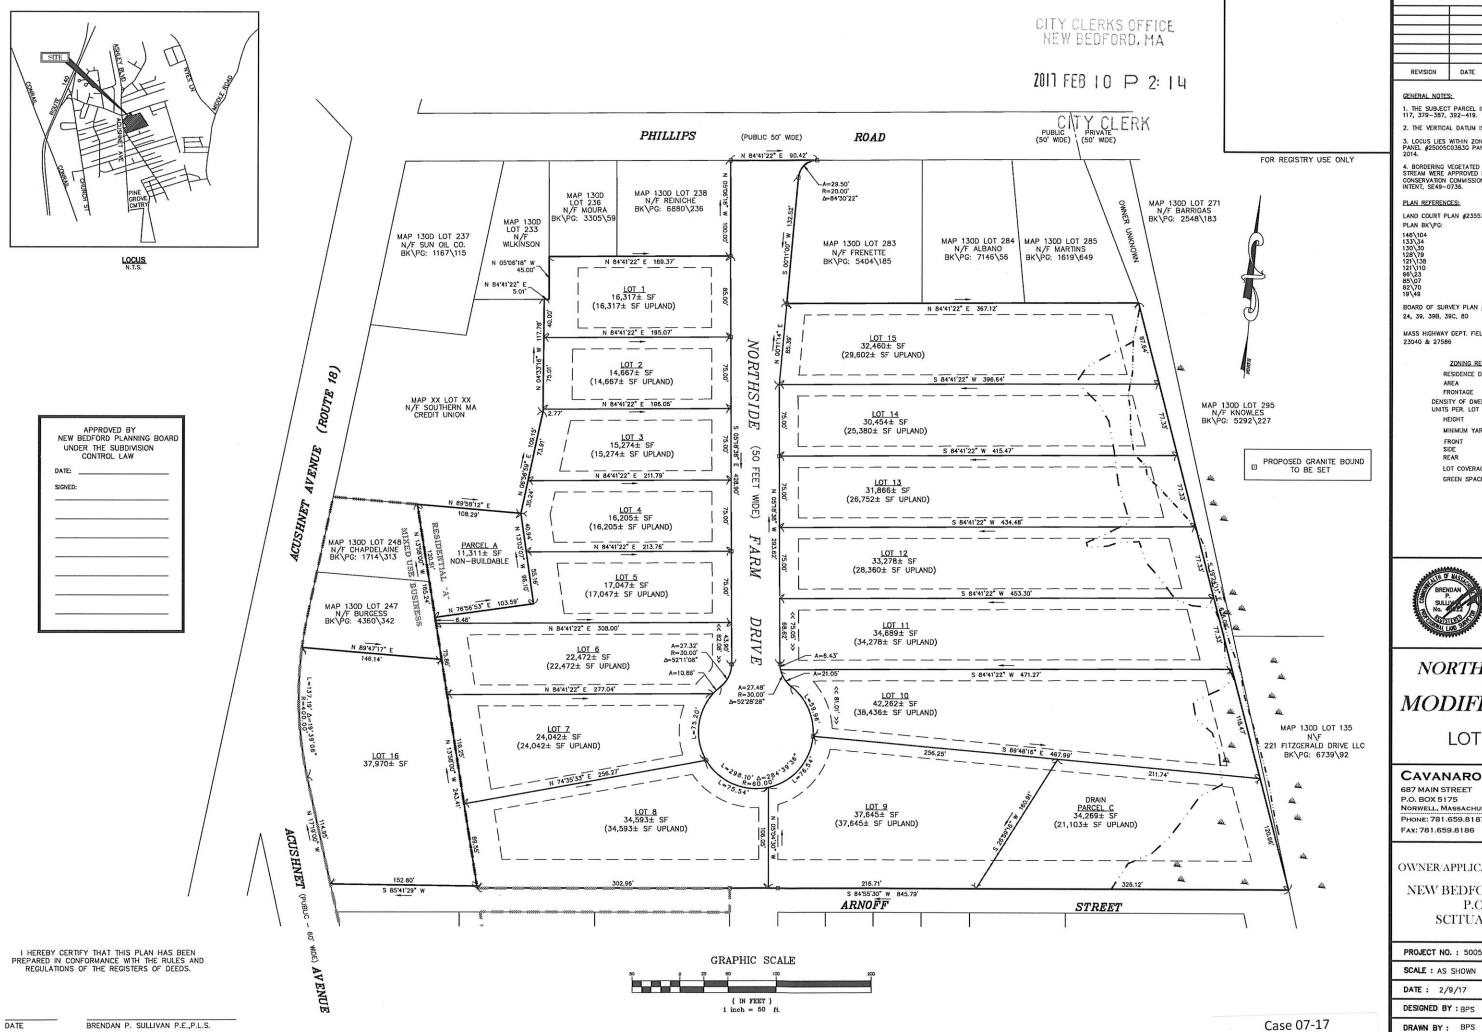

DRAWING REVISIONS

GENERAL NOTES:

1. THE SUBJECT PARCEL IS SHOWN AS MAP 130 BLC 117, 379-387, 392-419.

DATE

2. THE VERTICAL DATUM IS THE NEW BEDFORD CITY

BORDERING VEGETATED WETLANDS FLAGS AND INT STREAM WERE APPROVED BY THE CITY OF NEW BEDI CONSERVATION COMMISSION ON 6/13/2016 WITH A N INTENT, SE49-0736.

PLAN REFERENCES:

LAND COURT PLAN #23553-A PLAN BK\PG:

BOARD OF SURVEY PLAN #'S:

MASS HIGHWAY DEPT. FIELD BOOK #S: 23040 & 27586

> ZONING REQUIREMENTS: RESIDENCE DISTRICT - RA

AREA 8.000 S.F. FRONTAGE DENSITY OF DWELLING UNITS PER. LOT 1/10,000 S.F HEIGHT 45 FEET MINIMUM YARDS: FRONT SIDE REAR 20 FEET 10' & 12' 30 FEET LOT COVERAGE 30%

35%



GREEN SPACE

NORTHSIDE FAR **MODIFICATIO**

LOT LAYOUT

CAVANARO CONSULTIN

687 MAIN STREET P.O. BOX 5175

PHONE: 781.659.8187

FAX: 781.659.8186


OWNER/APPLICANT:

NEW BEDFORD COUSINS P.O. BOX 36 SCITUATE, MA 02066

DRAWING SCALE : AS SHOWN DATE: 2/9/17 DESIGNED BY : BPS

SHEET NO.

02/10/2017

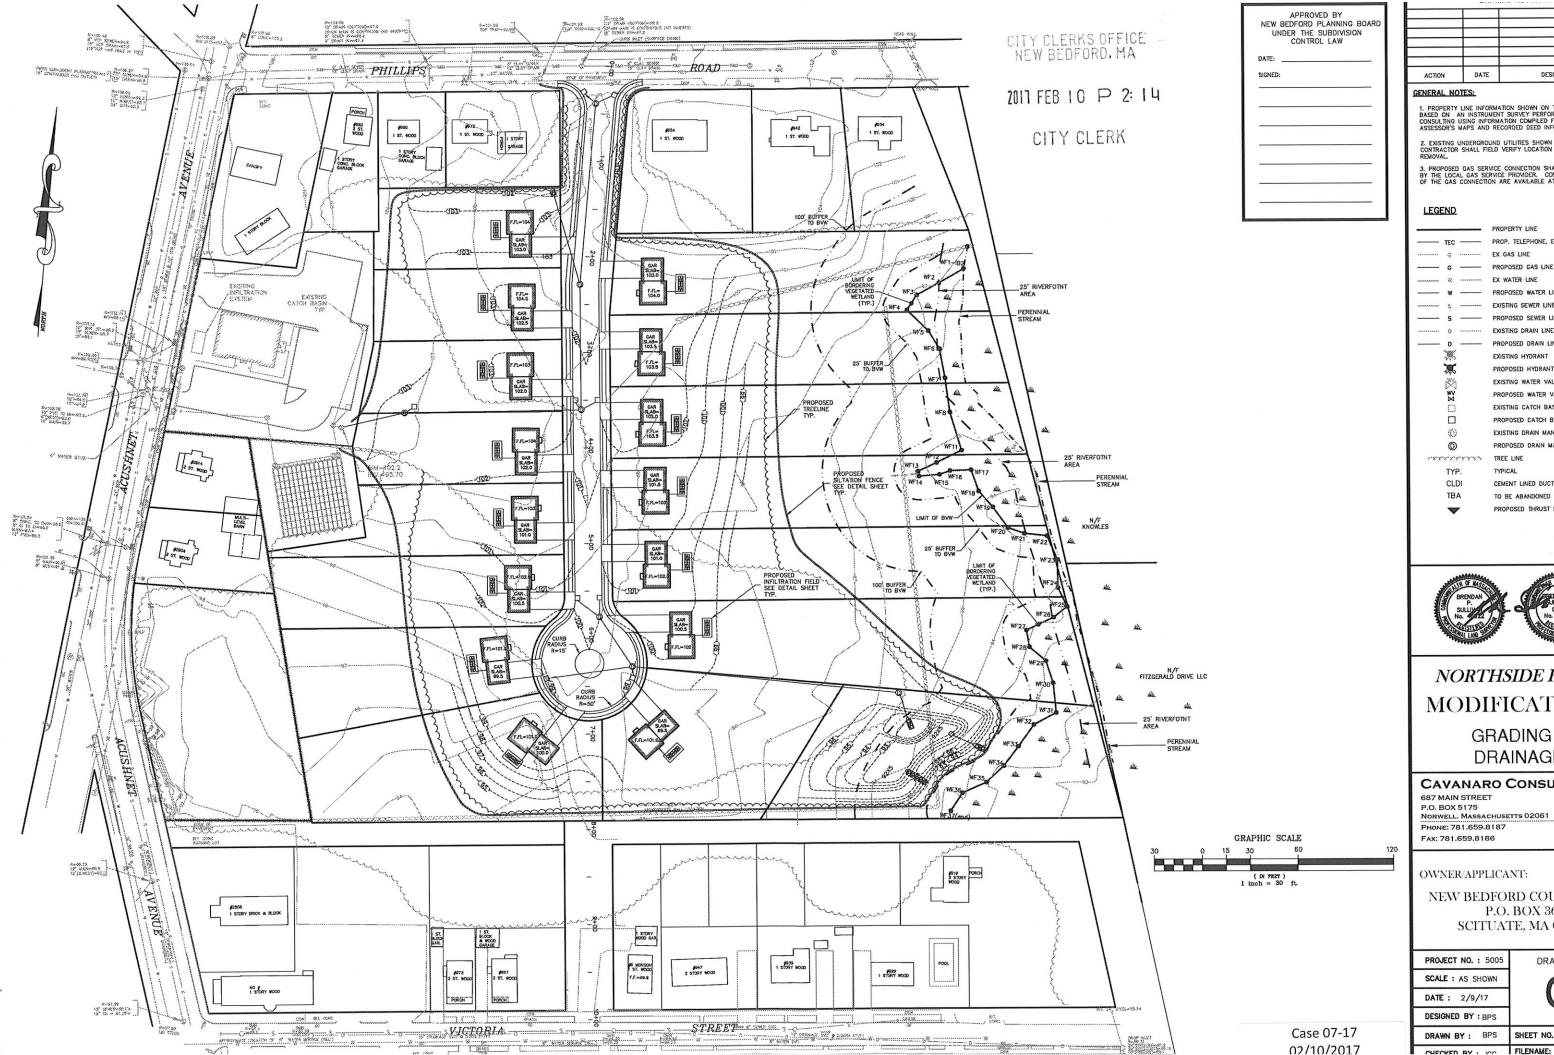

DESCRIPTIO

1. PROPERTY LINE INFORMATION SHOWN ON THIS PI BASED ON AN INSTRUMENT SURVEY PERFORMED B CONSULTING USING INFORMATION COMPILED FROM A ASSESSOR'S MAPS AND RECORDED DEED INFORMATI

3. PROPOSED GAS SERVICE CONNECTION SHALL BE BY THE LOCAL GAS SERVICE PROVIDER. CONSTRU OF THE GAS CONNECTION ARE AVAILABLE AT THE

EX GAS LINE EXISTING WATER VALVE EXISTING CATCH BASIN PROPOSED DRAIN MANHOLE TREE LINE

TYPICAL

CEMENT LINED DUCTILE IS PROPOSED THRUST BLOCK



NORTHSIDE FA **MODIFICATIO**

> **GRADING &** DRAINAGE


CAVANARO CONSULT

687 MAIN STREET P.O. BOX 5175 Norwell, Massachusetts 02061 PHONE: 781.659.8187

OWNER/APPLICANT:

NEW BEDFORD COUSIN P.O. BOX 36 SCITUATE, MA 020

OJECT NO. : 5005	DRAWING
CALE : AS SHOWN	
ATE: 2/9/17	
SIGNED BY : BPS	
RAWN BY : BPS	SHEET NO. 4

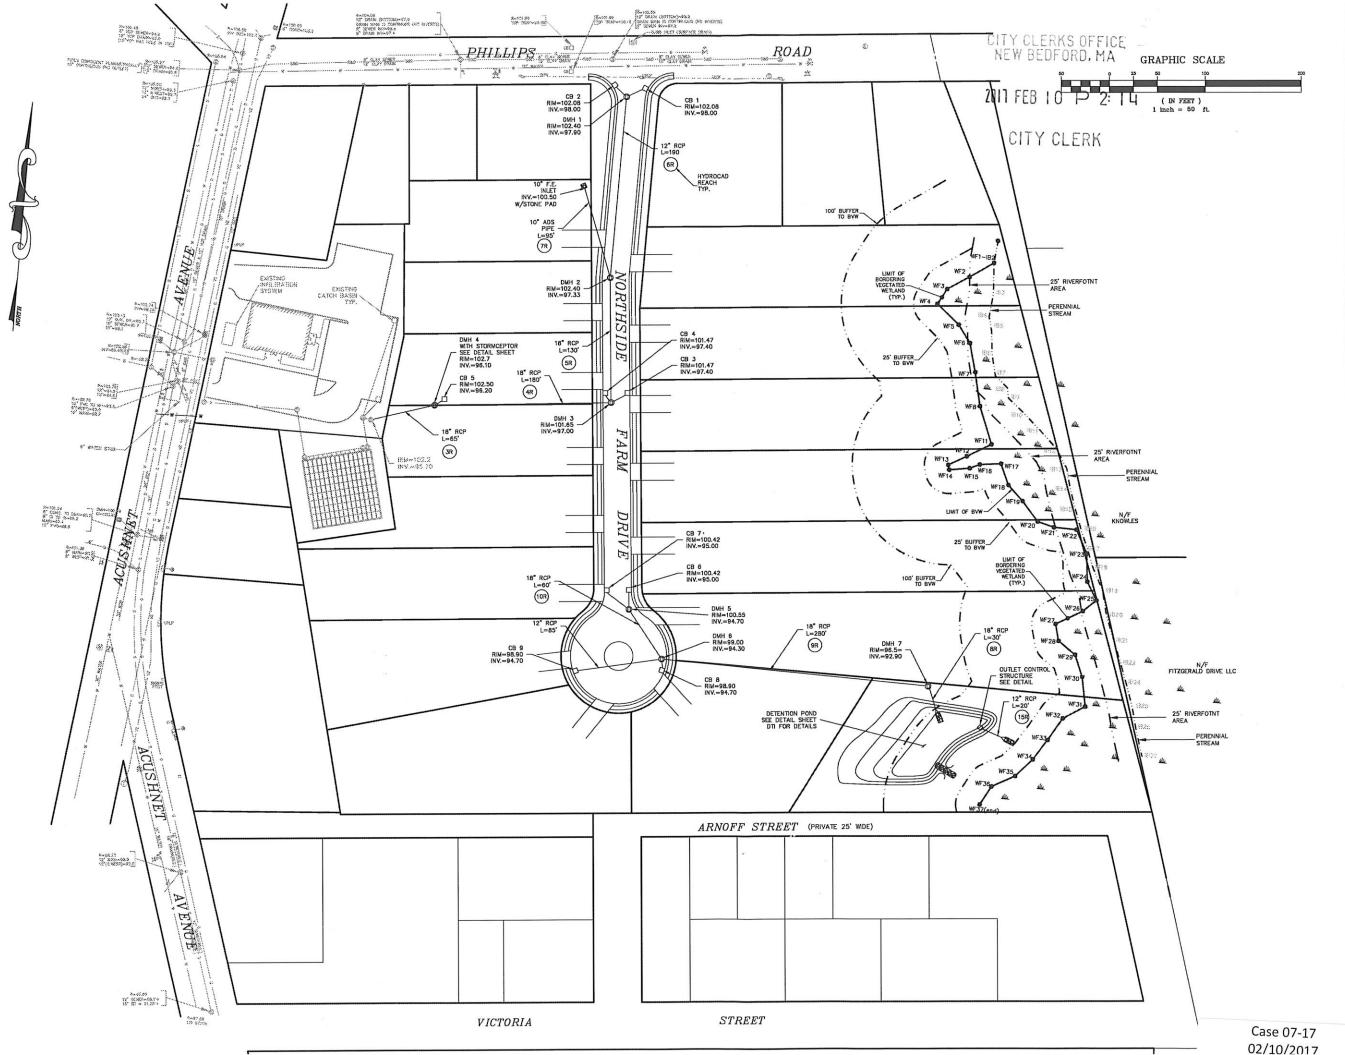

1. PROPERTY LINE INFORMATION SHOWN ON THIS PL ON AN INSTRUMENT SURVEY PERFORMED BY CAVAN CONSULTING USING INFORMATION COMPILED FROM A ASSESSOR'S MAPS AND RECORDED DEED INFORMATI

EXISTING UNDERGROUND UTILITIES SHOWN ARE ALL CONTRACTOR SHALL FIELD VERIFY LOCATION PRIOR REMOVAL.

3. ALL DRAIN LINES ARE 12" UNLESS OTHERWISE N

LEGEND

EXISTING WATER VALVE EXISTING CATCH BASIN PROPOSED CATCH BASE THEE LINE CLDI CEMENT UNED DUCTILE IRON



NORTHSIDE FA **MODIFICATIO**

DRAINAGE LAYOUT

CAVANARO CONSULT

687 MAIN STREET P.O. BOX 5175 NORWELL, MASSACHUSETTS 02061 PHONE: 781.659.8187 FAX: 781.659.8186

OWNER/APPLICANT:

NEW BEDFORD COUSIN P.O. BOX 36 SCITUATE, MA 0206


PROJECT NO.: 5005	DRAWING
SCALE : AS SHOWN	
DATE: 2/9/17	
DESIGNED BY : BPS	
V	

DRAWN BY : BPS SHEET NO. 5

CITY CLERKS OFFICE NEW BEDFORD, MA PVT STA.1+00.00 PVT ELEV.102.84 STA.2+00.00 ELEV.102.76 2017 FEB 10 P 2: 14 PY Y Z Z 100.00VC CREST STA.1+43.13 CREST ELEV.102.95 CITY CLERK EXISTING GRADE MCTORIA STREET PROPOSED GRADE STA, 0+30 SLOPE=0.5% SLOPE=0.69% 100 PROPOSED 12" RCP STORM DRAIN @ 0.5% PROPOSED 18" RCP STORM DRAIN @ 0.5% PROPOSED 10" WATER MAIN PROPOSED 8° SOR 35 SEWER MAIN RIM ELEV - 102.08 INVERT ELEV - 98.00 RIM ELEV = 101.65 INVERT ELEV = 97.00 RIM ELEV. = 99.00
INVERT ELEV.= 94.30
RIM ELEV. = 98.90
INVERT ELEV.= 94.60 PROPOSED 8" SDR 35 SEWER MAIN RIM ELEV. - 100.42 INVERT ELEV. 94.80 PROPOSED 10" WATER MAIN RIM ELEV. = 94.4 MATCH EXISTINVERT ELEV. = 90.5 MATCH EXIST BO.OO

PROFILE - NORTHSIDE FARM DRIVE

SCALE
HORIZONTAL 1" = 40'
VERTICAL 1" = 4'

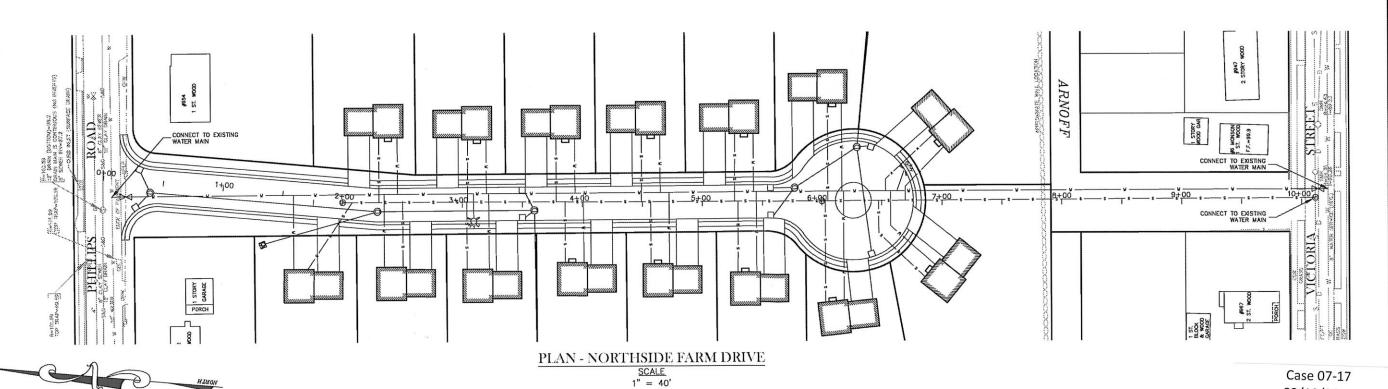

ACTION DATE DESCRIPTION

GENERAL NOTES:

BASED ON AN INSTRUMENT SURVEY PERFORMED CONSULTING USING INFORMATION COMPILED FROM ASSESSOR'S MAPS AND RECORDED DEED INFORMA

2. EXISTING UNDERGROUND UTILITIES SHOWN ARE CONTRACTOR SHALL FIELD VERIFY LOCATION PRICE

OPOSED GAS SERVICE CONNECTION SHALL

4. PROPOSED ELECTRICAL SERVICE CONNECTION NEAREST UTILITY POLE SHALL BE INSTALLED BY

CTRIC SERVICE PROVIDER.

5. PROPOSED WATER SERVICE CONNECTION SHALL E NEAREST MAIN LINE BRANCH IN ACCORDANCE WITH NEW BEDFORD WATER DEPARTMENT STANDARDS.

 ALL SANITARY SEWER CONNECTIONS SHALL BE R APPROVED BY THE CITY OF NEW BEDFORD ENGINEED DEPARTMENT PRIOR TO CONSTRUCTION.

LEGEND

TYP.

CLDI

-		
		PROPERTY LINE
	TEC	PROP. TELEPHONE, ELEC
	ε	EX GAS LINE
	G	PROPOSED GAS LINE
*********	Μ	EX WATER LINE
	w	PROPOSED WATER LINE
	s	EXISTING SEWER LINE
	s ——	PROPOSED SEWER LINE
	ŧ	EXISTING DRAIN LINE
	D —	PROPOSED DRAIN LINE
	*	EXISTING HYDRANT
	黨	PROPOSED HYDRANT
	淡 :	EXISTING WATER VALVE
	₩V M	PROPOSED WATER VALV
		EXISTING CATCH BASIN
		PROPOSED CATCH BASH
	(EXISTING DRAIN MANHOL
	0	PROPOSED DRAIN MANH
/335	*****	TREE LINE



TYPICAL

CEMENT LINED DUCTILE IRC



ROADWAY PROFILE

CAVANARO CONSULT

687 MAIN STREET P.O. BOX 5175

Norwell, Massachusetts 02061 Phone: 781.659.8187 Fax: 781.659.8186

OWNER/APPLICANT:

NEW BEDFORD COUSI P.O. BOX 36 SCITUATE, MA 020


PROJECT NO. : 5005 DRAWING

DATE: 2/9/17

DESIGNED BY : BPS

DRAWN BY : BPS SHEET NO. 6

02/10/2017

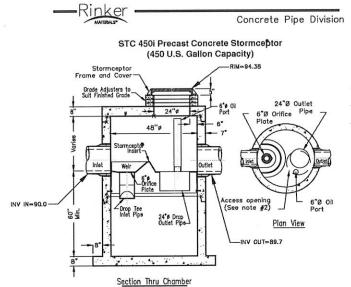

- Notes:


 1. The Use Of Flexble Connection is Recommended at The Inlet and Outlet Where Applicable.

 2. The Cover Should be Positioned Over The Outlet Drop Pipe and The Oil Port.

 3. The Stormceptor System is protected by one or more of the following U.S. Patents: \$4985148, \$5498513, \$752760, \$757315, \$5898181, \$5068705, \$6371690.


 4. Contact a Concrete Pipe Division representative for further details not listed on this drawing.

STORMCEPTOR DETAIL
NOT TO SCALE

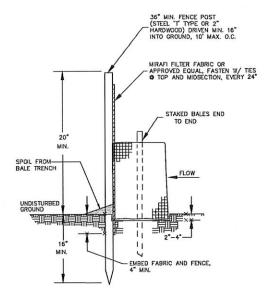


- BALES TO BE TIED W/ ORGANIC FIBER TWINE ONLY, NO PLASTIC OR WIRE.
- HAY BALES TO BE SECURED W/ MIN. TWO (2) 2"X2" WOOD STAKES PER BALE, DRIVEN 18" MIN. INTO GRADE.

HAYBALE WITH SILTFENCE NOT TO SCALE

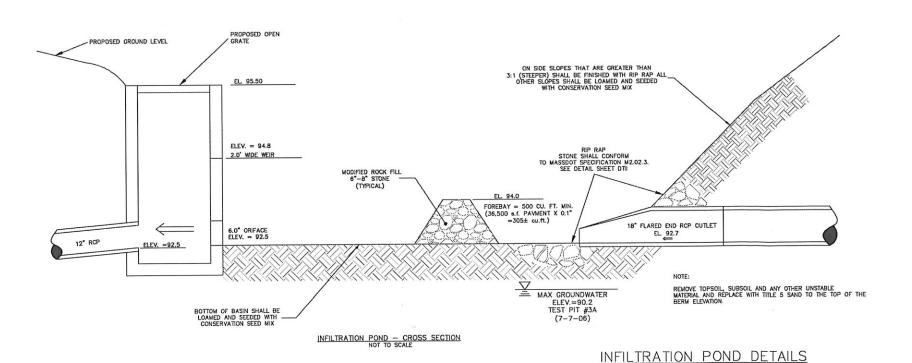


CITY CLERKS OFFICE NEW BEDFORD, MA 2011 FEB TO P. 2: INILIAN FILTER FABRIC

> CONSTRUCTION ENTRANCE DETAIL NOT TO SCALE

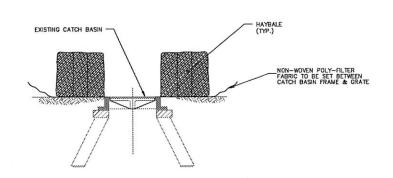

STRAWBALE EROSION CHECK

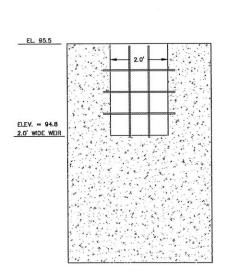

DRAINAGE STRUCTURE - FRONT MEW NOT TO SCALE

Case 07-17



GENERAL NOTES:

6. ALL SANITARY SEWER CONNECTIONS SHALL BE R APPROVED BY THE CITY OF NEW BEDFORD ENGINEE DEPARTMENT PRIOR TO CONSTRUCTION.

LEGEND	
	PROPERTY LINE
ТЕС	PROP. TELEPHONE, ELECT
C	EX GAS LINE
— с —	PROPOSED GAS LINE
үү	EX WATER LINE
w	PROPOSED WATER LINE
 3	EXISTING SEWER LINE
s	PROPOSED SEWER LINE
p	EXISTING DRAIN LINE
D	PROPOSED DRAIN LINE
W.	EXISTING HYDRANT
**	PROPOSED HYDRANT
:27	EXISTING WATER VALVE
WV	PROPOSED WATER VALVE
n	EXISTING CATCH BASIN
	PROPOSED CATCH BASIN
()	EXISTING DRAIN MANHOLE
0	PROPOSED DRAIN MANHO
CONTOCCO	TREE LINE
TYP.	TYPICAL



NORTHSIDE FA **MODIFICATIO**

DETAIL SHEET

CAVANARO CONSULT

687 MAIN STREET P.O. BOX 5175

NORWELL, MASSACHUSETTS 02061


PHONE: 781.659.8187 FAX: 781.659.8186


NEW BEDFORD COUSIN P.O. BOX 36 SCITUATE, MA 0200

PROJECT NO. : 5005 DRAWING SCALE : AS SHOWN DATE: 2/9/17 DESIGNED BY : BPS

DRAWN BY : BPS

SHEET NO.

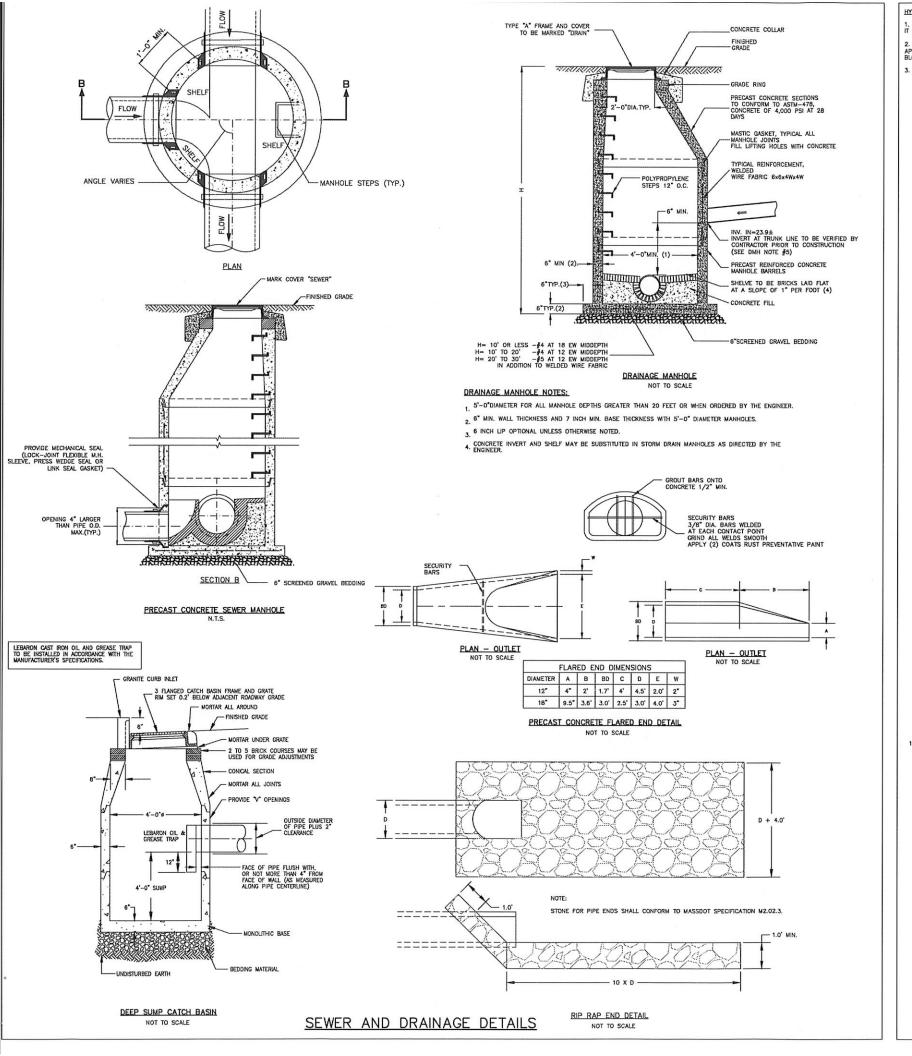

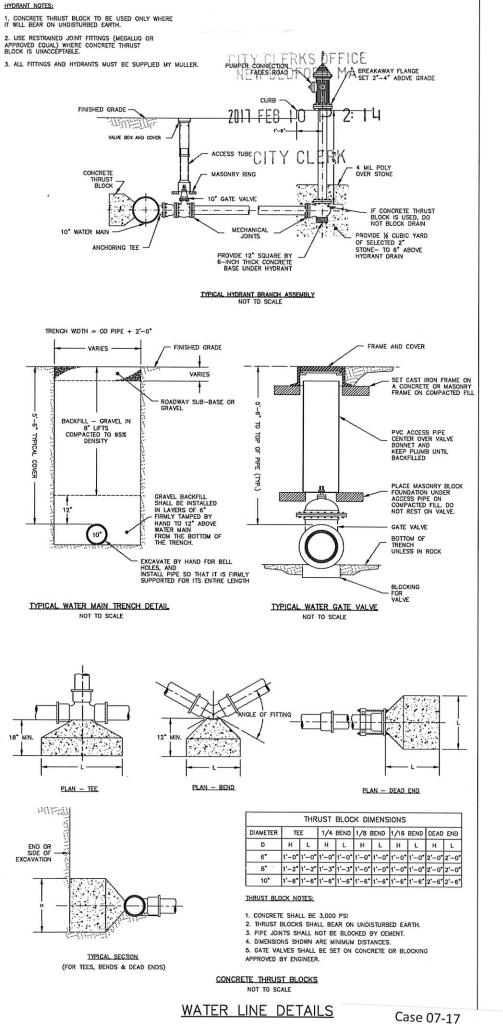

ACTION DESCRIP

GENERAL NOTES:

PROPERTY LINE INFORMATION SHOWN ON THIS BASED ON AN INSTRUMENT SURVEY PERFORMED CONSULTING USING INFORMATION COMPILED FROM ASSESSOR'S MAPS AND RECORDED DEED INFORMATION.

EXISTING UNDERGROUND UTILITIES SHOWN ARE CONTRACTOR SHALL FIELD VERIFY LOCATION PRIO REMOVAL.

3. PROPOSED GAS SERVICE CONNECTION SHALL B BY THE LOCAL GAS SERVICE PROVIDER. CONSTRU OF THE GAS CONNECTION ARE AVAILABLE AT THE

4. PROPOSED ELECTRICAL SERVICE CONNECTION F NEAREST UTILITY POLE SHALL BE INSTALLED BY I ELECTRIC SERVICE PROVIDER.

5. PROPOSED WATER SERVICE CONNECTION SHAL NEAREST MAIN LINE BRANCH IN ACCORDANCE WI NEW BEDFORD WATER DEPARTMENT STANDARDS.

ALL SANITARY SEWER CONNECTIONS SHALL BE APPROVED BY THE CITY OF NEW BEDFORD ENGINE DEPARTMENT PRIOR TO CONSTRUCTION.

PROPERTY LINE

mmmm

TYP.

PROPOSED HYDRANT PROPOSED WATER VALV



TREE LINE

NORTHSIDE FA **MODIFICATIO**

DETAIL SHEET

CAVANARO CONSULT 687 MAIN STREET

P.O. BOX 5175 Norwell, Massachusetts 02061 PHONE: 781.659.8187

Fax: 781.659.8186

OWNER/APPLICANT:


NEW BEDFORD COUSI P.O. BOX 36 SCITUATE, MA 020


PROJECT NO.: 5005 DRAWING SCALE : AS SHOWN DATE: 2/7/17


DRAWN BY : BPS SHEET NO. 8

02/10/2017 FILENAME:

HAYBALE WITH SILTFENCE

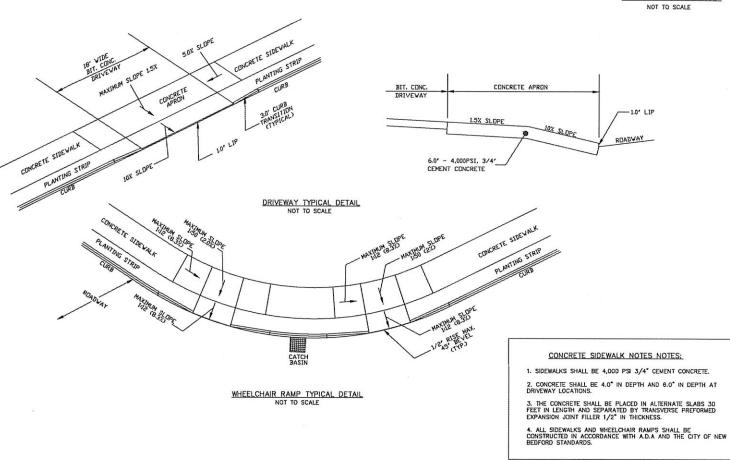


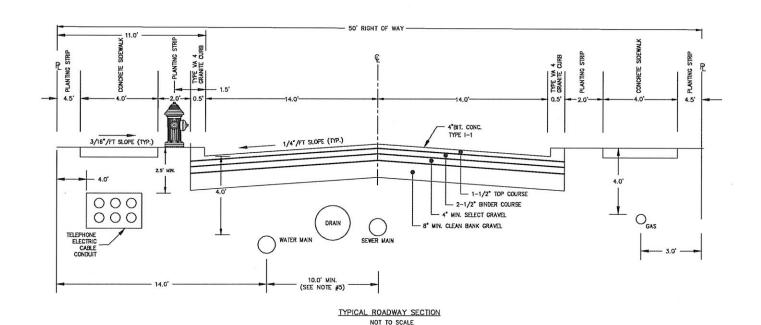

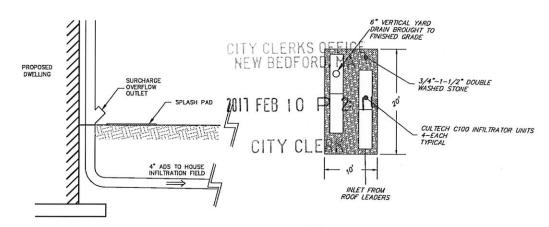


NOTE:
THE AREA AROUND THE VERTICAL OUTLET FOR THE
INDIVIDUAL HOME INFILITATION SYSTEM SHALL BE
GRADED AWAY FROM HOMES AND ADJACENT PROPERTIES.

TYPICAL HOUSE INFILTRATION BED-PLAN VIEW NOT TO SCALE

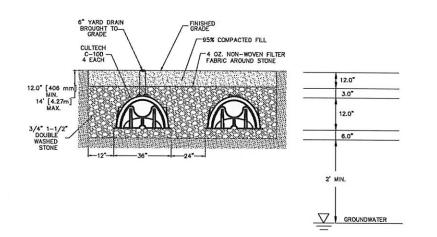

TYPICAL HOUSE INFILTRATION BED - CROSS SECTION

NOT TO SCALE

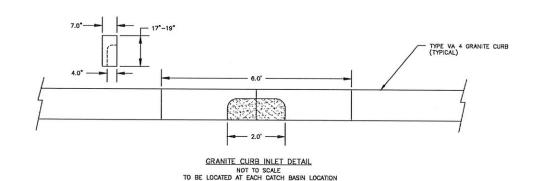

DRAWING REVISIONS DATE DESCRIPTI ACTION

GENERAL NOTES:

1. PROPERTY LINE INFORMATION SHOWN ON THIS P BASED ON AN INSTRUMENT SURVEY PERFORMED E CONSULTING USING INFORMATION COMPILED FROM A ASSESSOR'S MAP'S AND RECORDED DEED INFORMAT

2. EXISTING UNDERGROUND UTILITIES SHOWN ARE A CONTRACTOR SHALL FIELD VERIFY LOCATION PRIOR REMOVAL.

4. PROPOSED ELECTRICAL SERVICE CONNECTION FR NEAREST UTILITY POLE SHALL BE INSTALLED BY TH ELECTRIC SERVICE PROVIDER.

5. PROPOSED WATER SERVICE CONNECTION SHALL NEAREST MAIN LINE BRANCH IN ACCORDANCE WITH NEW BEDFORD WATER DEPARTMENT STANDARDS.

LEGEND	
	PROPERTY LINE
TEC	PROP. TELEPHONE, ELECTR
	EX GAS LINE
— в —	PROPOSED GAS LINE
W	EX WATER LINE
w	PROPOSED WATER LINE
5	EXISTING SEWER LINE
s	PROPOSED SEWER LINE
ŋ	EXISTING DRAIN LINE
D	PROPOSED DRAIN LINE
**	EXISTING HYDRANT
36	PROPOSED HYDRANT
i\(\tilde{\pi}\)	EXISTING WATER VALVE
WV	PROPOSED WATER VALVE
ä	EXISTING CATCH BASIN
	PROPOSED CATCH BASIN
()	EXISTING DRAIN MANHOLE
0	PROPOSED DRAIN MANHOLE
\\\\\\\\\\\\\\\\\\\\\\\\\\\\\\\\\\\\\\	TREE LINE
TYP.	TYPICAL



NORTHSIDE FAI **MODIFICATIO**

DETAIL SHEET

CAVANARO CONSULTI

687 MAIN STREET P.O. BOX 5175 Norwell, Massachusetts 02061 PHONE: 781.659.8187 Fax: 781.659.8186

OWNER/APPLICANT:

NEW BEDFORD COUSIN P.O. BOX 36 SCITUATE, MA 0206


DRAWING

PROJECT NO. : 5005 SCALE : AS SHOWN

DATE: 2/7/17

DESIGNED BY : BPS Case 07-17

SHEET NO. 9 DRAWN BY : BPS 02/10/2017

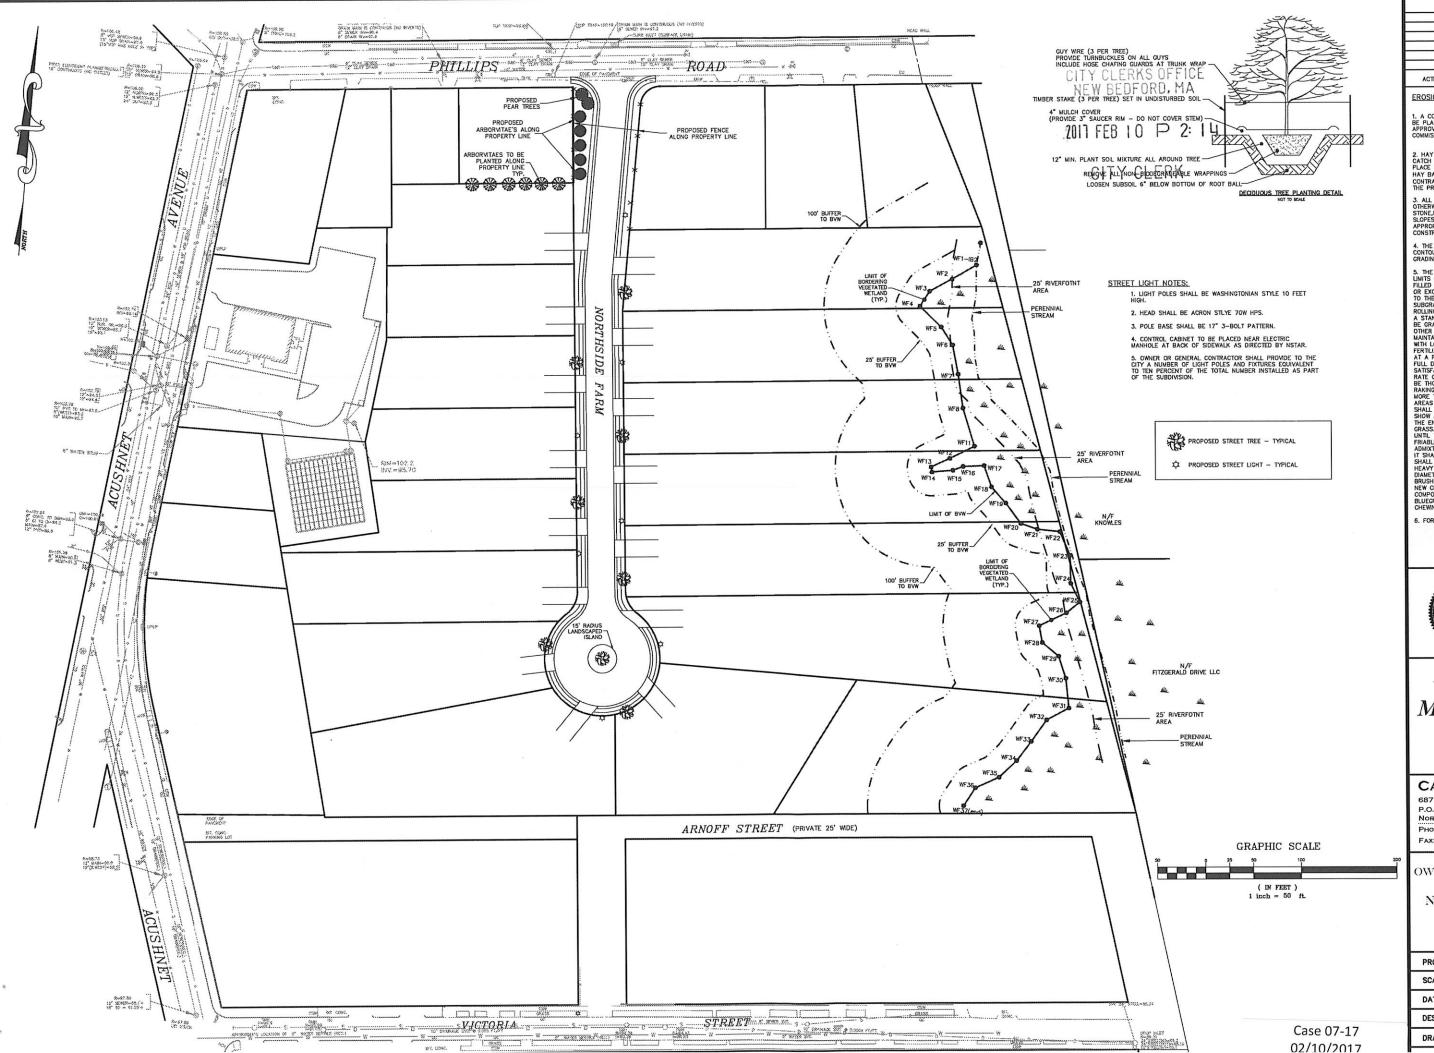

DATE

DRAWING REVISIONS

EROSION CONTROL NOTES:

A CONTINUOUS ROW OF HAY BALES WITH SILT FE BE PLACED, AS SHOWN ON THE NOTICE OF INTENT F APPROVED BY THE CITY OF NEW BEDFORD CONSERV COMMISSION AND ORDER OF CONDITIONS.

2. HAY BALE EROSION CHECKS SHALL BE PLACED A CATCH BASIN INLET DURING CONSTRUCTION AND SH-PLACE UP TO THE TIME OF FINAL PAYEMENT CONST HAY BALES AND/OR SILT FENCE SHALL BE MAINTAIN CONTRACTOR AND/OR OWNER UNTIL ALL DISTURBED THE PROJECT ARE STABLE.

3. ALL DISTURBED AREAS WITHIN THE SITE, NOT PROTHERMSE TREATED (I.E. PAVEMENT, STONE RIP—RAPS STONE, PLANTINGS, ETC...), INCLUDING THE DETENTION SLOPES AND BOTTOM, SHALL BE LOAMED AND SEED AND PROPRIET SEED MIX, AS SOON AS PRACTICABLE CONSTRUCTION, TO REDUCE SOIL EROSION.

CONTOURS AS SHOWN ON THE PLANS, ALLOWING FO GRADING AND LOAMING ABOVE THIS ELEVATION.

5. THE SIDE SLOPES, TREE BELT, AND ALL AREAS Y LIMITS OF THE STREET LINES, WHICH ARE NOT PAVE FILLED TO WITHIN 6" OF FINISHED GRADE WITH RAY OR EXCAVATED MATERIAL, AND THE SURFACE GRAD TO THE FINISHED SHIP ACE LOAM SHALL BE SPREAU SUBGRADE IN SUFFICIENT QUANTITY TO PRODUCE, W ROLLING AND AFTER NATURAL SETTLEWENT HAS THA A STRANDARD DEPTH OF 6" THE SPREAU STREET OF THE STRANDARD DEPTH OF 6" THE SPREAU STREET OF THE SURFACE SMAINTAINED DURING A PERIOD OF SETTLING AND CO WITH LOAM BORROW, AFTER SETTLING HAS TAKEN P FERRILIZER (8"-6"-4" MIXTURE OR EQUIVALENT) SHALL AT A RATE OF TWENTY POUNDS PER 100 SOUARE. FULL DEPTH OF LOAM SHALL BE LOOSENED AND MASATISFACTORY FOR SEEDING, SEED SHALL THEN BE RATE OF 3.6 POUNDS PER 100 SOUARE YARDS. THE ETHOROLIGHLY COVERED WITH A THIN LAYER OF I RAKING AND THEN ROLLED WITH A HAND ROLLER WORKET HAND TO POUNDS PER FOOT OF WIDTH. THE AREAS SHALL BE SPRINKLED WITH WATER ON A DA SHALL BE PROTECTED FROM DAMAGE, ALL AREAS Y SHOW A UNIFORM GROWTH OF GRASS SHALL BE RETHE ENTIRE AREA IS COVERED WITH A THU LAYER OF IT ENTIRED THE PROTECTED FROM DAMAGE, ALL AREAS Y SHOW A UNIFORM GROWTH OF GRASS SHALL BE RETHE ENTIRE AREA IS COVERED WITH A UNIFORM GRASS. SEEDED AREAS SHALL BE MAINTAINED AND UNIT. THE STREET HAS BEEN ACCEPTED. LOAM SHY FRIENDER, OF SUBSOLUTION, REPOSED TO THE POUNTS PER POOT OF WIDTH. THE PROTECTED FROM DAMAGE, ALL AREAS Y SHOW A UNIFORM GROWTH OF GRASS SHALL BE REINFELD AND STREET HAS BEEN ACCEPTED. LOAM SHY FRIENDER, ON THE PROTECTED FROM DAMAGE ALL AREAS Y SHOW A UNIFORM GROWTH OF GRASS SHALL BE REINFELD AND STREET HAS BEEN ACCEPTED. LOAM SHY FRIENDER, ON THE PROTECTED FROM DAMAGE ALL AREAS Y SHOW A UNIFORM GROWTH OF GRASS SHALL BE REINFELD AND STREET HAS BEEN ACCEPTED. LOAM SHY FRIENDER, ON THE PROTECTED FROM CHARMED TO SUBSCEPS. BUECKARS, FANCY SOIL REDTOP, DOMESTIC RYCER BUECKARS, FANCY SOIL REDTOP, DOMESTIC RYCER BUELDER, FOR SUDIES BUILDER OF THE POLLOWAGES SCIES.

6. FOR ADDITIONAL DETAILS, REFER TO DWG.'S DTI,



NORTHSIDE FA **MODIFICATIO**

STREET TREES LIGHTING

CAVANARO CONSULT

687 MAIN STREET P.O. BOX 5175 NORWELL, MASSACHUSETTS 02061 PHONE: 781.659.8187

FAX: 781.659.8186

OWNER/APPLICANT:

NEW BEDFORD COUSIN P.O. BOX 36 SCITUATE, MA 020

PROJECT NO. : 5005 DRAWIN SCALE : AS SHOWN DATE: 2/9/17 DESIGNED BY : BPS

DRAWN BY : BPS SHEET NO.