PROPOSED FAMILY DOLLAR RETAIL STORE

CITY CLERKS OFFICE NEW BEDFORD, MA

2016 NOV 18 P 2: 55


CITY CLERK

ORCHARD STREET NEW BEDFORD, MASSACHUSETTS

ZONING SUMMARY ZONING: MIXED USE BUSINES

CRITERIA	EXISTING	REQUIRED	PROVIDED
LOT AREA (SF)	43,500		43,500
LOT WIDTH (FT)	217.5	0	217.5
# OF DWELLING UNITS	0	0	0
TOTAL GROSS FLOOR AREA (SF)	0	N/A	9180
RESIDENTIAL GROSS FLOOR AREA (SF)	0	N/A	0
NON-RES GROSS FLOOR AREA (SF)	0	N/A	9180
BUILDING HEIGHT (FT)	0	100	25
FRONT SETBACK (FT)	0	0	15
SIDE SETBACK (FT)	0	10	112
SIDE SETBACK (FT)	0	12	83
REAR SETBACK (FT)	0	10	N/A
LOT COVERAGE BY BLDG (% OF LOT)	0	100	21.1
PERMEABLE OPEN SPACE (% OF LOT)	100	0	26
GREEN SPACE (% OF LOT)	100	0	26
OFF-STREET PARKING SPACES	0	46	32
VAN ACCESSIBLE HC SPACES	0	1	2
HANDICAP SPACES	0	2	2
LONG TERM BICYCLE PARKING SPACES	0	0	0
SHORT TERM BICYCLE PARKING SPACES	0	0	0
LOADING BAYS	0	1	1

ISSUED FOR SPECIAL PERMIT

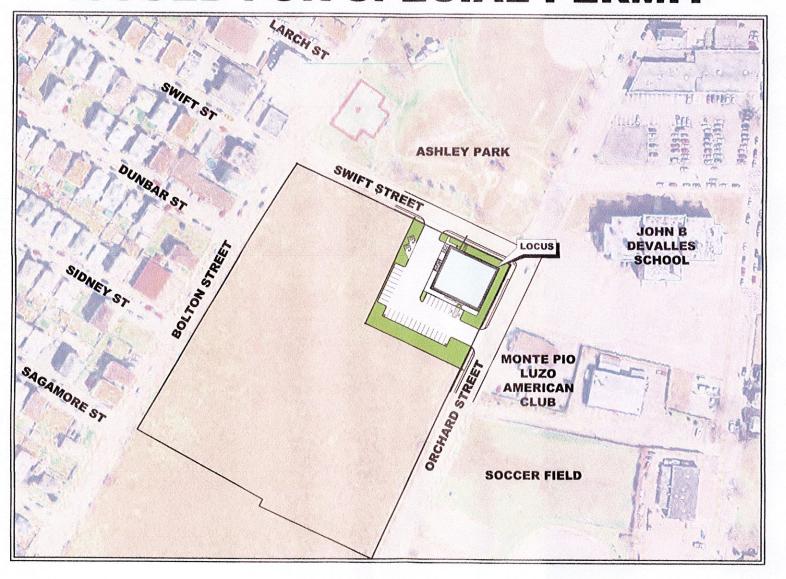

SITE LOCUS IS REFERENCED AS NEW BEDFORD ASSESSOR'S MAP 23 LOT 292. SEE BOOK 7223/ PAGE 263 RECORDED IN THE BRISTOL COUNTY REGISTRY OF DEEDS, IN NEW BEDFORD

THE SITE IS LOCATED IN THE MIXED USE BUSINESS ZONING DISTRICT

NEIGHBORHOOD LOCUS PLAN SCALE: 1"=80'

NOVEMBER 4, 2016

SCHEDULE OF DRAWINGS

SHEET NUMBER	PLAN TITLE
	TITLE SHEET
1.	EXISTING CONDITIONS PLAN
2.	DEMOLITION PLAN
3.	SITE LAYOUT
4.	GRADING & DRAINAGE PLAN
5.	UTILITIES PLAN
6.	LANDSCAPE PLAN
7.	EROSION CONTROL PLAN
8.	DETAILS 1
9.	DETAILS 2
PH-1	LIGHTING PLAN
PH-2	LIGHTING FIXTURE PLAN
A1.0	FLOOR PLAN
A2.0	FRONT ELEVATION
A2.1	SIDE AND REAR ELEVATIONS
R1.0	COLOR ELEVATIONS

DEVELOPMENT TEAM


FUNCTION	TEAM MEMBER
DEVELOPER	HUNT REAL ESTATE SERVICES INC. 5100W KENNEDY BLVD, SUITE 100 TAMPA, FL 33609
ARCHITECT	FWH ARCHITECTS 3336 GRAND BLVD, SUITE 201 HOLIDAY, FL 34690
SITE DESIGN ENGINEER	PRIME ENGINEERING, INC. P.O. BOX 1088 LAKEVILLE, MA 02347
CURRENT OWNER	CLARK COVE DEVELOPMENT CO, LLC 651 ORCHARD ST, SUITE 200 NEW BEDEORD MA 02744

PREPARED BY:



CIVIL ENGINEERING—LAND SURVEYING—ENVIRONMENTAL ASSESSMENT P.O. BOX 1088, 350 BEDFORD STREET, LAKEVILLE, MA 02347 TEL: 508.947.0050 FAX: 508.947.2004

Case 38-16, 39-16 & 40-16 11/18/2016

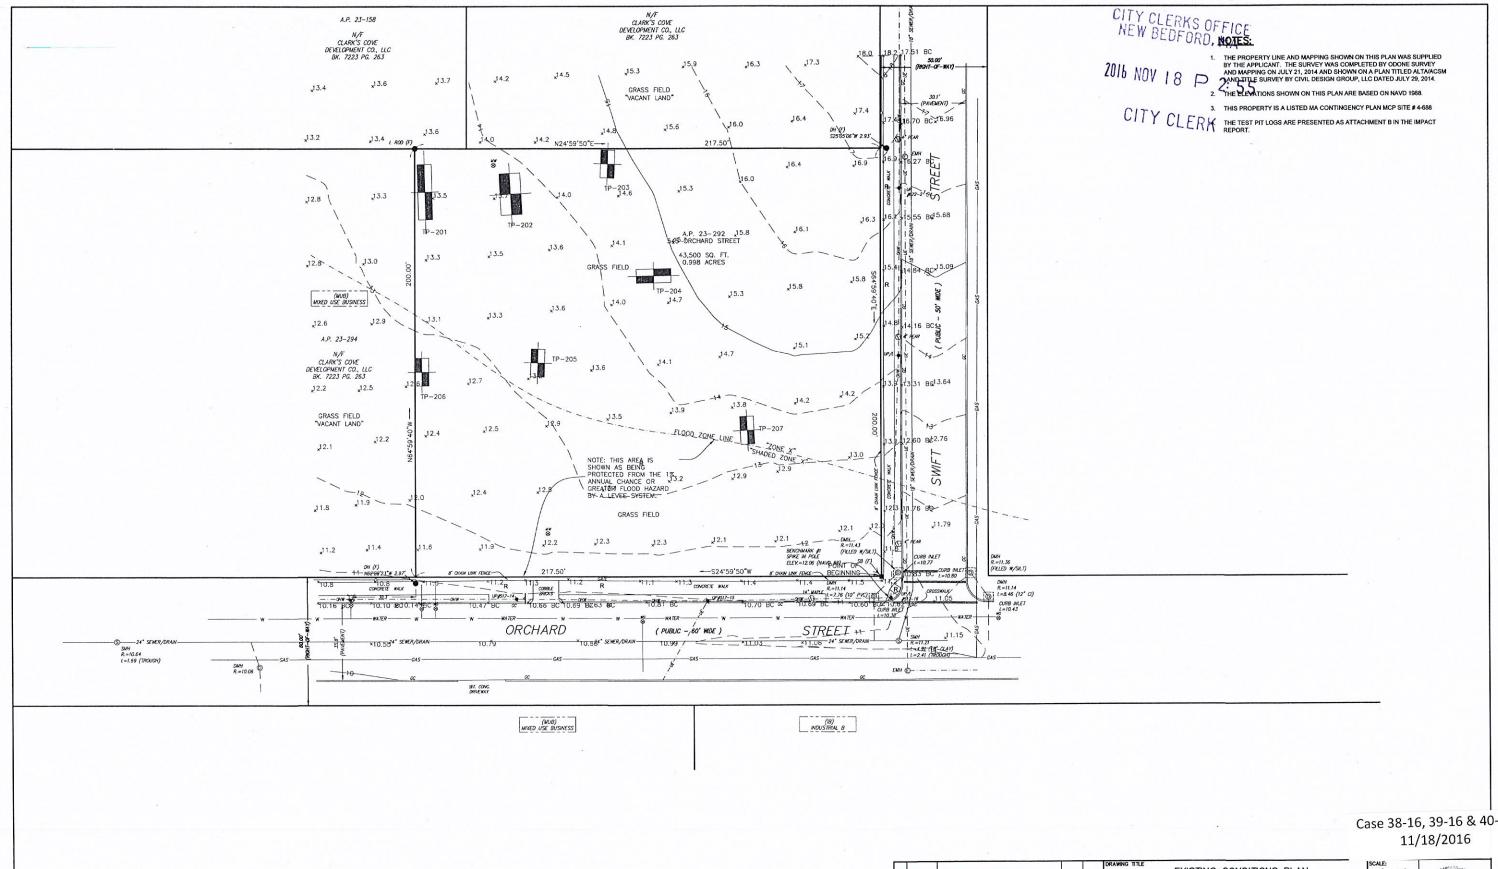

Case 38-16, 39-16 & 40-16

C1.0

17210303

11/4/2016

RAWN BY: EKW

RJR APPROVED BY:

RJR

	12
	0 20' 40'


APPROVED BY THE CITY OF NEW BEDFORD PLANNING BOARD

ENDORSED.

CITY OF NEW BEDFORD PLANNING BOARD

APPROVED .

H					EXISTING CONDITIONS PLAN
					PROJECT FAMILY DOLLAR NEW BEDFORD, MASSACHUSETTS
					CUENT HUNT REAL ESTATE SERVICES, INC. TAMPA, FLORIDA
					CIVIL ENGINEERING LAND SURVEYING FINANCHMENTAL FINANCHMENTAL FINANCHMENTAL
REV.	DATE	DESCRIPTION	BY	APP.	

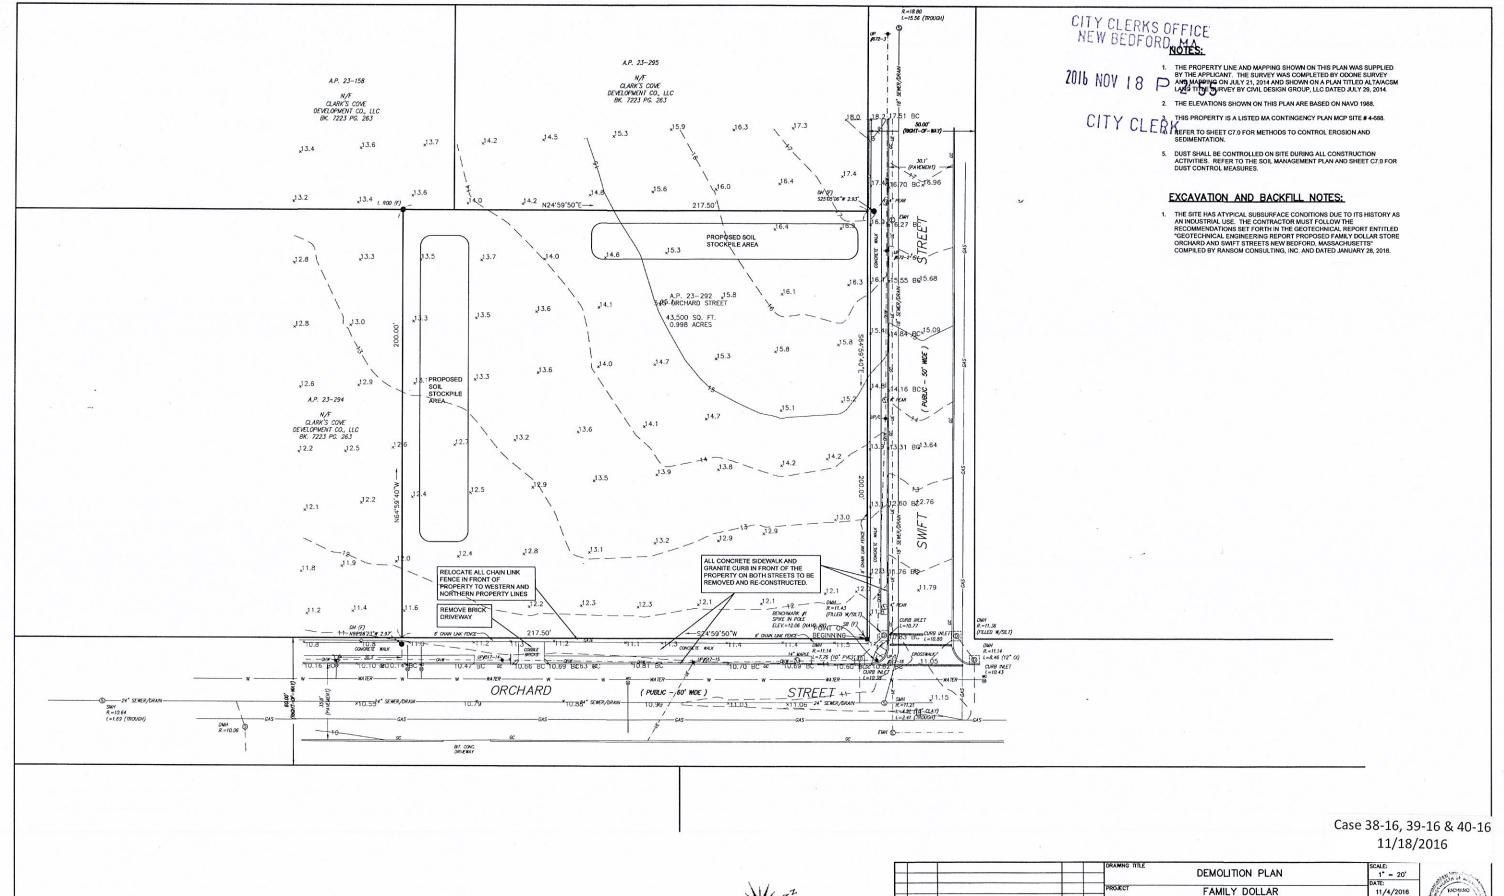

DRAWNING TITLE

DEMOLITION PLAN

T = 20'

PROJECT

FAMILY DOLLAR

NEW BEDFORD, MASSACHUSETTS

CLIENT

HUNT REAL ESTATE SERVICES, INC.

TAMPA, FLORIDA

COVIL ENGINEERING

LAND SURVEYING

DEMONSTRATE

P.C. BOX 1089

SINCE PLANT

SHEET NO. C2.00

CHECKED BY

RIF

SHEET NO. C2.00

CHECKED BY

RIF

SHEET NO. C2.00

SHEET NO. C2.00

SHEET NO. C2.00

PRIME ENGINEERING

PPROVED BY:

TEL: 508.947.0050 FAX: 508.947.2004

· ENVIRONMENTAL


ASSESSMENT


BY APP.





REV. DATE


DESCRIPTION

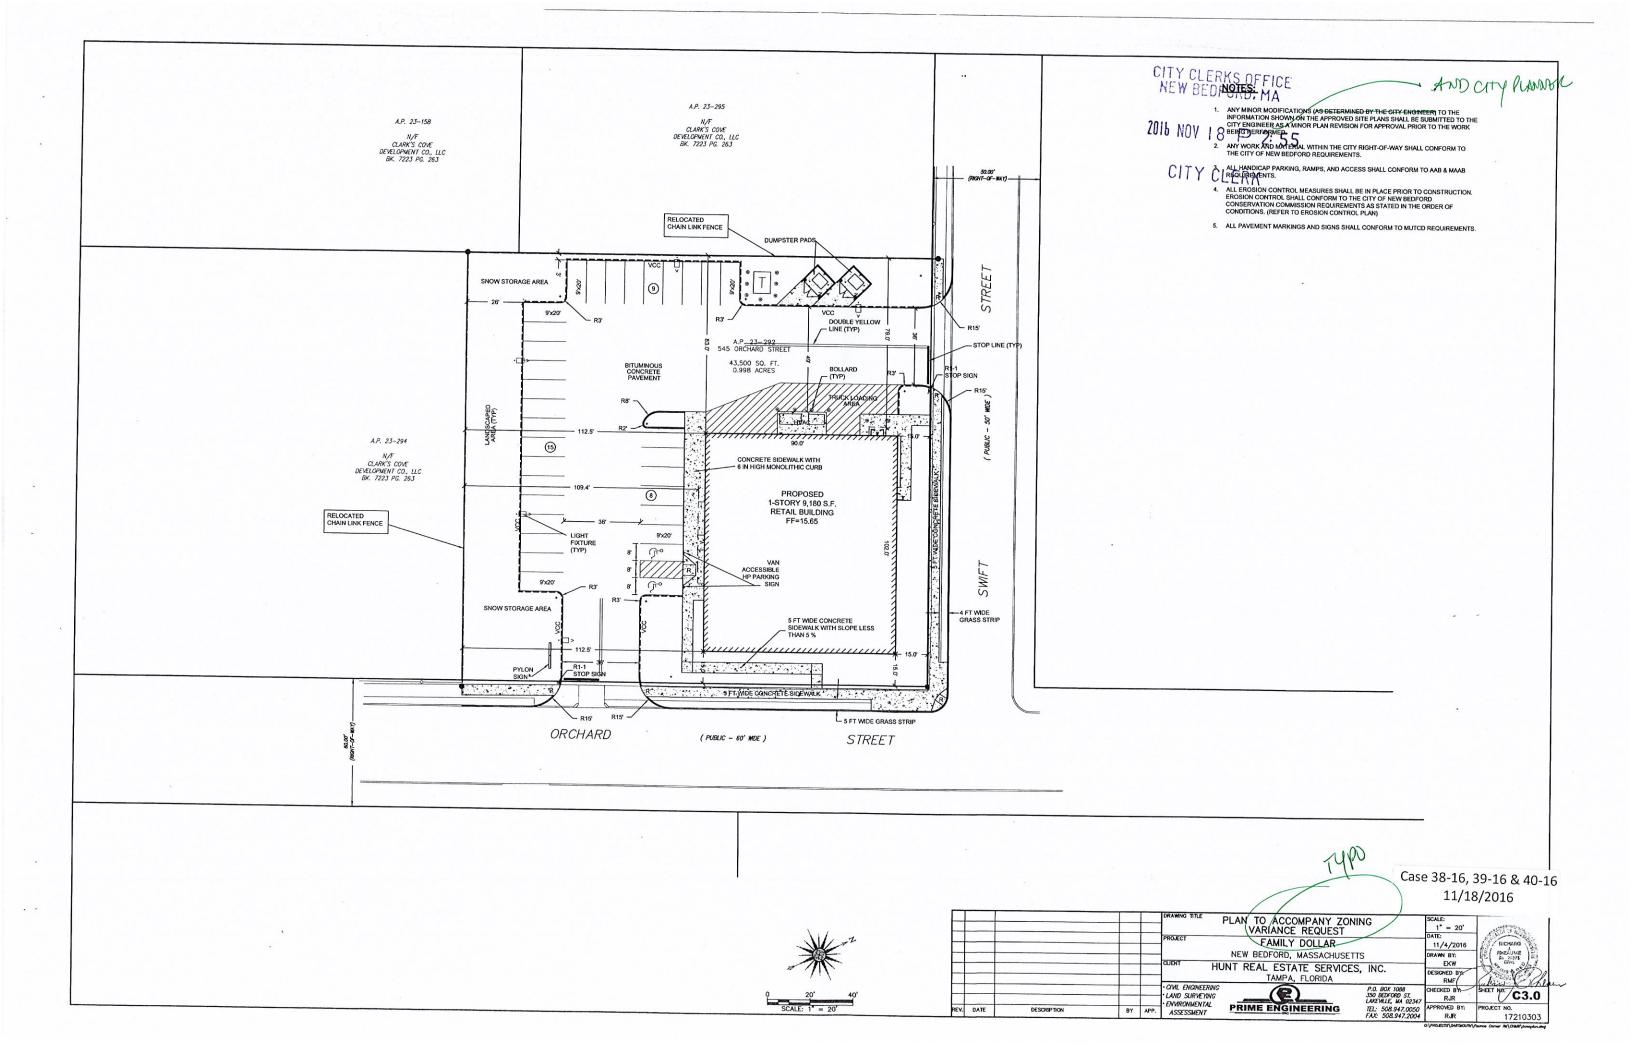

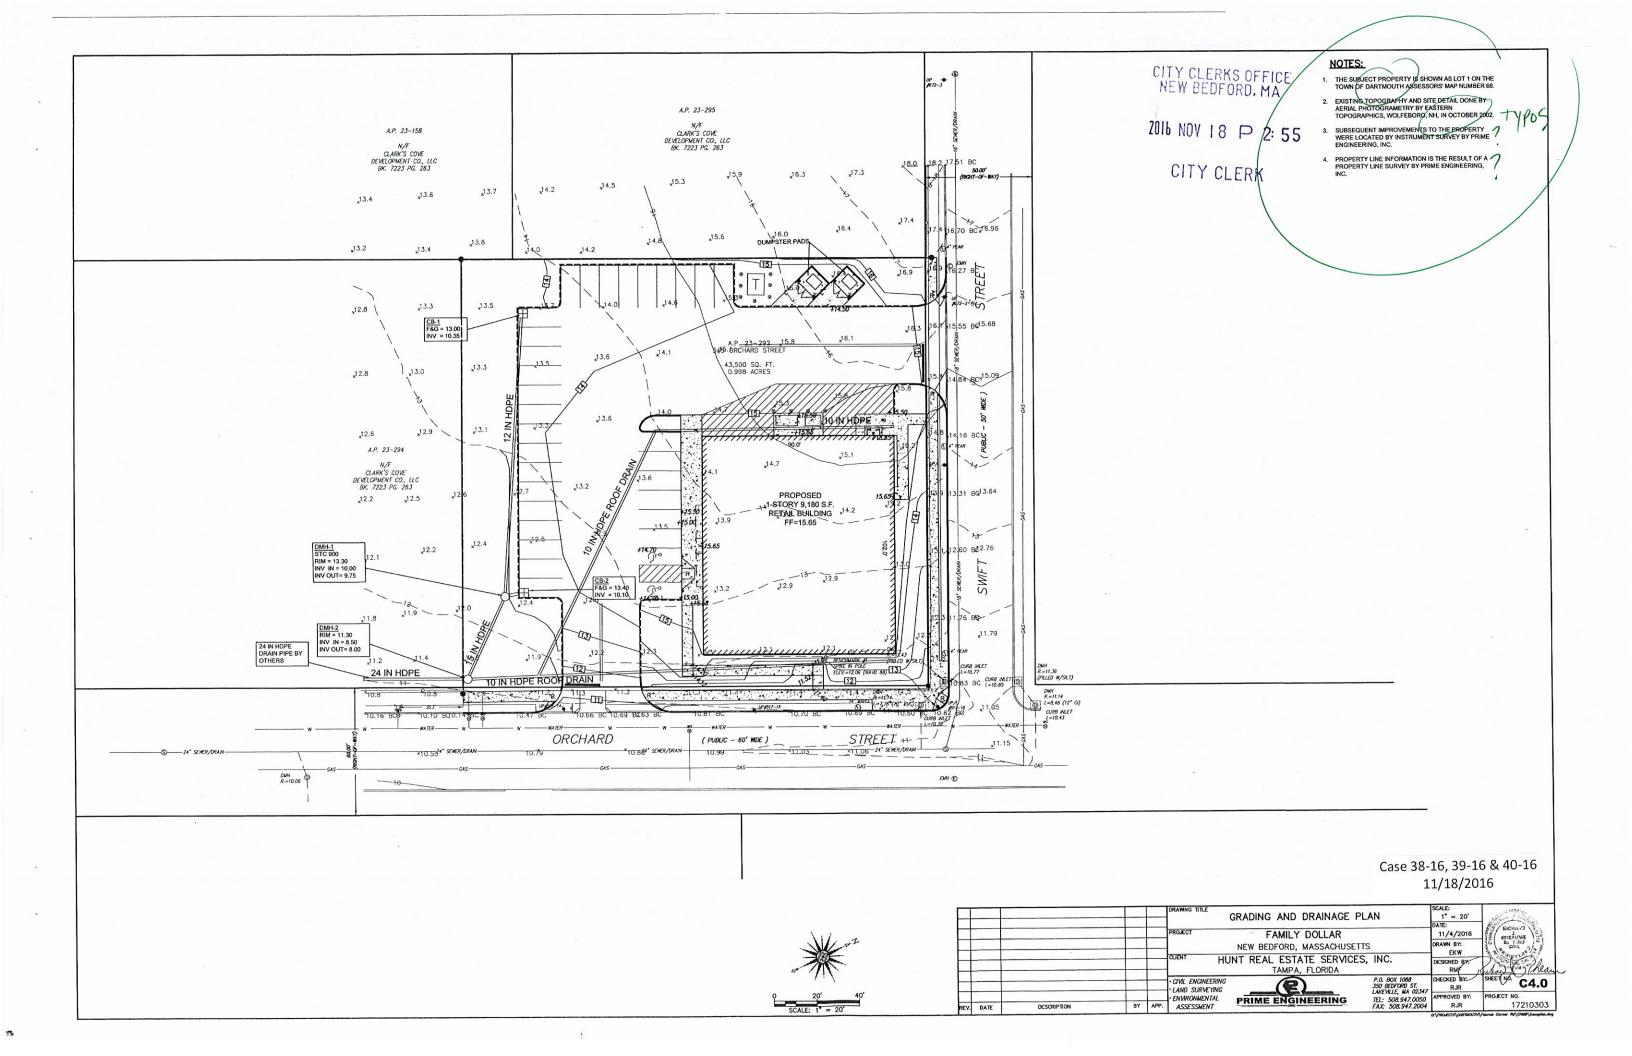

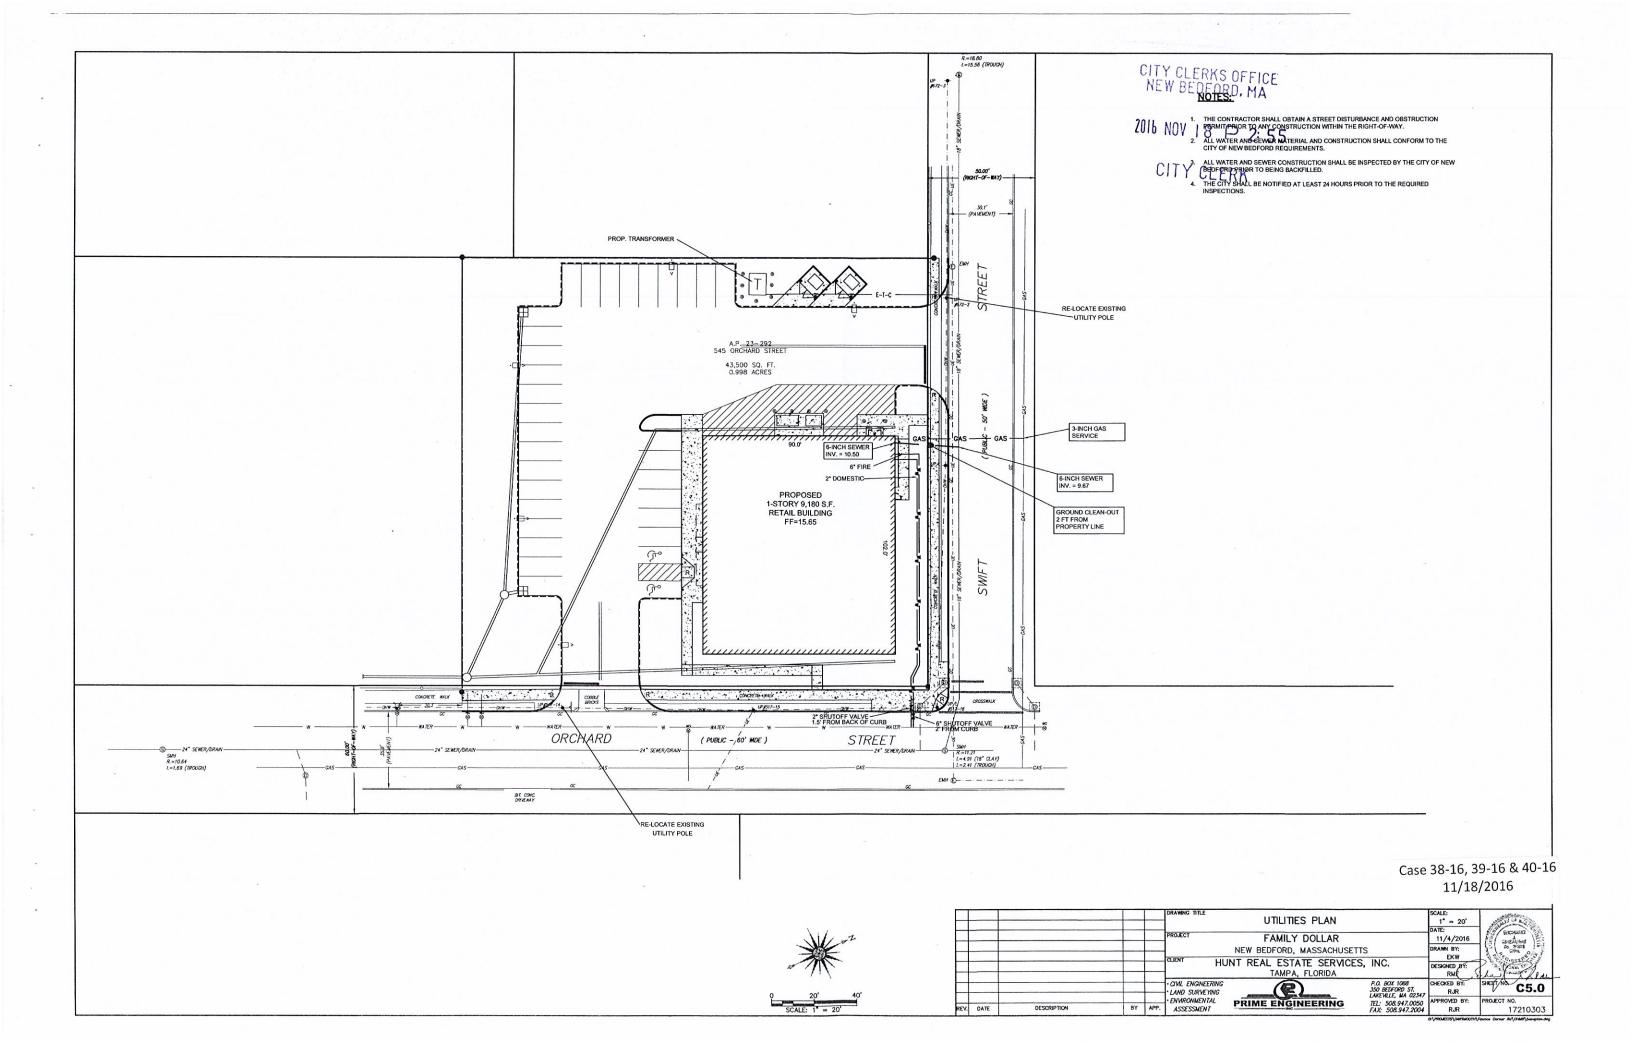

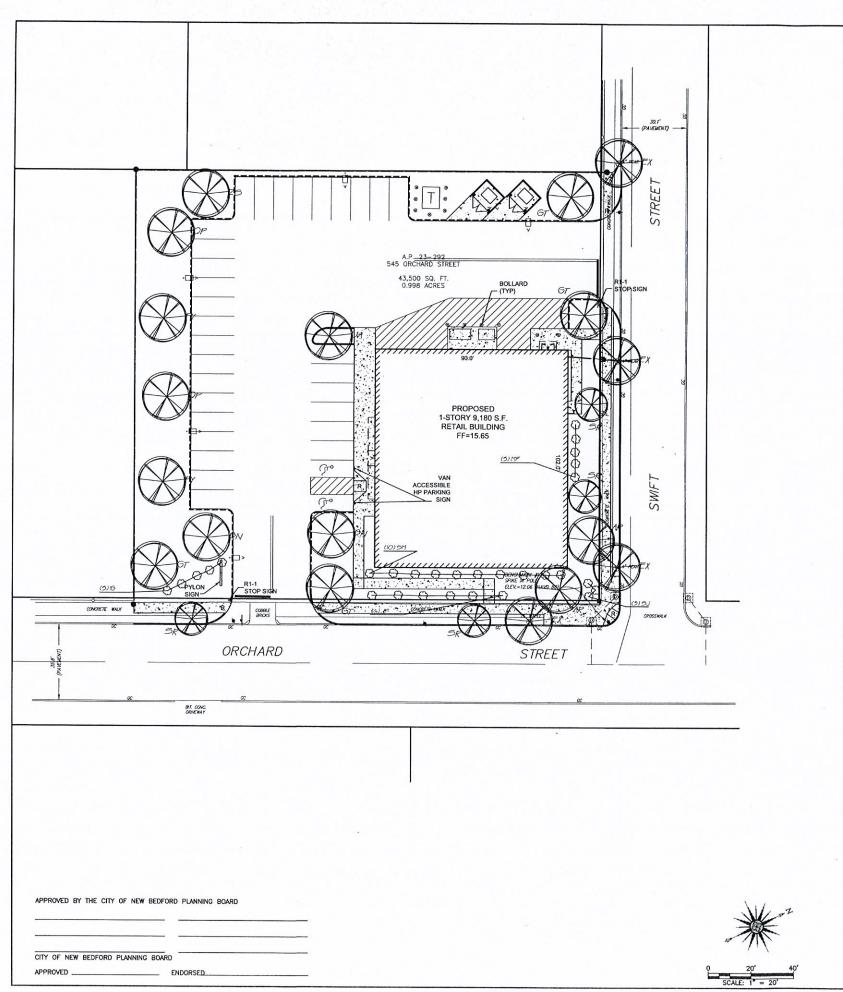


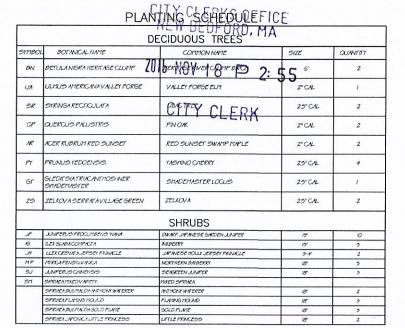




NOTE:

OVERHEAD POWER POLES RESTRICT THE ABILITY FOR LARGE TREES TO PROPERLY MATURE WITHIN THE CITY ROAD LAYOUT. THE FOUR TREES THAT EXIST WITHIN THE LAYOUTMILL BE PRESERVED AND SUPPLEMENTED WITH TWO LILAC TREES (NOT INCLUDED IN THE ABOVE SCHEDULE). EIGHT ADDITIONAL LARGE TREES ARE PROPOSED JUST OUTSIDE THE ROAD LAYOUT FOR A TOTAL OF FOURTEEN TREES THAT WILL LINE THE STREETS.

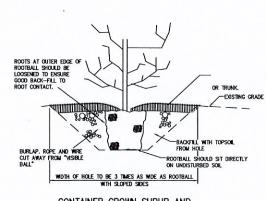


CONTAINER GROWN SHRUB AND TREE PLANTING DETAIL NOT TO SCALE

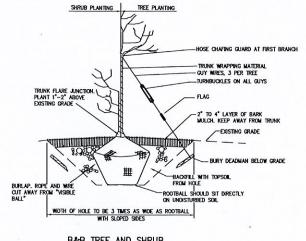

B&B TREE AND SHRUB

PLANTING DETAIL Case 38-16, 39-16 & 40-16 11/18/2016

					DRAWING TITLE LANDSCAPE PLAN	SCALE: 1" = 20'	MENTH OF MES
	_				PROJECT FAMILY DOLLAR NEW BEDFORD, MASSACHUSETTS	11/4/2016 DRAWN BY:	FICHARD EA
	_				CUENT HUNT REAL ESTATE SERVICES, INC. TAMPA, FLORIDA	DESIGNED BY:	
					CIVIL ENGINEERING P.O. BOX 106 S30 BEDFORD LANFAULE W	ST. P.P	SHEET NO. C6.0
REV.	DATE	DESCRIPTION	BY	APP.	ASSESSMENT PRIME ENGINEERING TEL: 508.94 FAX: 508.94	0050 APPROVED BY:	PROJECT NO. 17210303

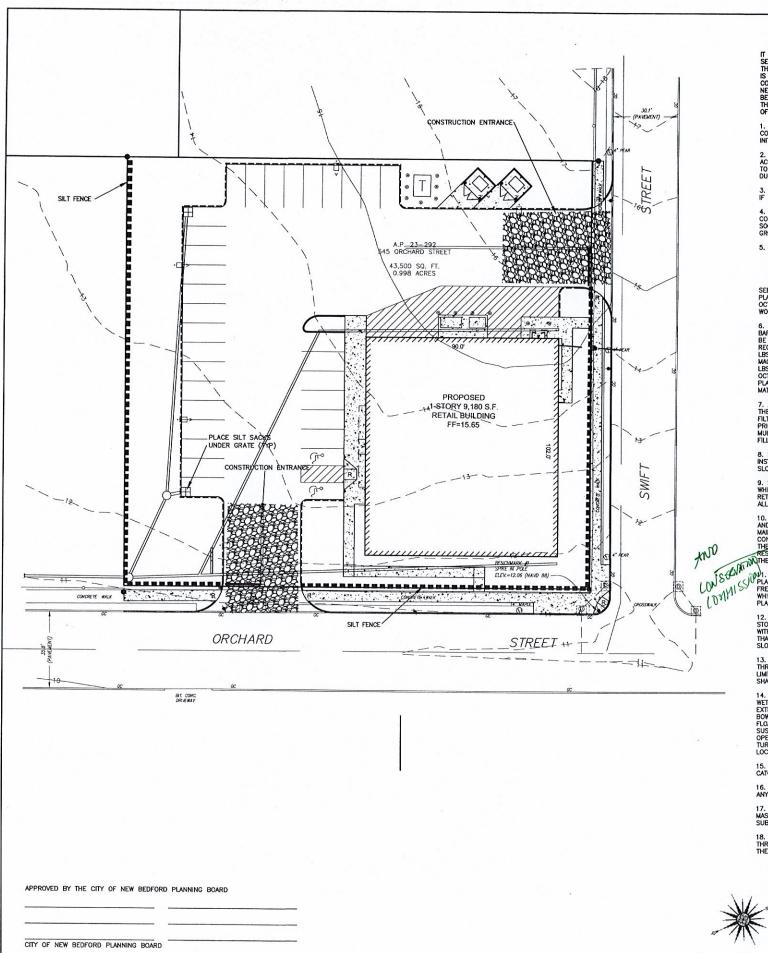

ENDORSED

EROSION & SEDIMENT CONTROL NOTES:

IT IS THE CONTRACTOR'S RESPONSIBILITY TO CONTROL EROSION AND PREVENT SEDIMENTATION WITHIN 25' OF RESOURCE AREAS OR OFFSITE PROPERTIES. IT IS INTENDED THAT THE INPLEMENTATION OF THE FOLLOWING MEASURES WILL MEET THIS COAL. WHEN IT IS CLEAR TO THE DESIGNER THAT EROSION AND SEDIMENTATION HAVE BEEN ADEQUATELY CONTROLLED WITHOUT THE IMPLEMENTATION OF EVERY MEASURE, ADDITIONAL MEASURES NEED NOT BE INPLEMENTED. ALTERNATIVELY, IF ALL OF THE FOLLOWING MEASURES HAVE BEEN INDIVIDUAL DITHE CONTROLLED.

1. EROSION AND SEDIMENT CONTROL MEASURES WILL BE INSTALLED PRIOR TO CONSTRUCTION. STABILIZATION OF ALL REGRADED AND SOIL STOCKPILE AREAS WILL BE INITIATED AND MAINTAINED DURING ALL PHASES OF CONSTRUCTION.

- 2. ALL EROSION AND SEDIMENT CONTROL MEASURES WILL BE CONSTRUCTED IN ACCORDANCE WITH LOCAL MUNICIPAL REGULATIONS. ALL EROSION CONTROL MEASURES ARE TO BE MAINTAINED AND UPGRADED AS REQUIRED TO ACHIEVE PROPER SEDIMENT CONTROL DURING CONSTRUCTION.
- 3. ADDITIONAL CONTROL MEASURES WILL BE INSTALLED DURING THE CONSTRUCTION PERIOD, IF DEEMED NECESSARY BY THE OWNER OR AGENTS OF THE OWNER.
- 4. CATCH BASINS WILL BE PROTECTED WITH HAYBALE FILTERS THROUGHOUT THE CONSTRUCTION PERIOD UNTIL ALL DISTURBED AREAS ARE THOROUGHLY STABILIZED. SILT SOCKS SHOULD BE INSTALLED UNDER GRATE OPENING UNTIL PAVEMENT IS IN PLACE AND GROUND SURFACE IS STABILIZED.
- 5. SEEDING MIXTURE FOR FINISHED GRASSED AREAS WILL BE AS FOLLOWS:

SEED TO BE APPLIED AT A RATE OF 4 LBS./1000 SQ. FT.
PLANTING SEASONS SHALL BE APRIL 1 TO JUNE 1 AND AUGUST 1 TO OCTOBER 15. AFTER
OCTOBER 15, AREAS WILL BE STABILIZED WITH HAYBALE CHECK, FILTER FABRIC, OR
WOODCHIP MULCH, AS REQUIRED, TO CONTROL EROSION.

6. AREAS THAT ARE NOT THE LOCATION OF ACTIVE CONSTRUCTION WHICH ARE TO BE LEFT BARE FOR OVER ONE MONTH BEFORE FINISHED GRADING AND SEEDING IS ACHIEVED, SHALL BE MULCHED OR RECEIVE HEMPORARY STABILIZATION SUCH AS JUTE NETTING OR SHALL RECEIVE A TEMPORARY SEEDING OF PERENNIAL RYEGRASS APPLIED TO A RATE OF 2 LBS./1,000 SQ. FT. LIMESTONE (EQUIVALENT TO BE 50 PERCENT CALCIUM PLUS MAGNESIUM OXIDE) SHALL BE APPLIED AS SEEDBED PREPARATION AT A RATE OF 90 LBS./1,000 SQ. FT. PLANTING SEASONS SHALL BE APRIL 1 TO JUNE 1 AND AUGUST 1 TO COTOBER 1. AREAS TO BE LEFT BARE BEFORE FINISH GRADING AND SEEDING OUTSIDE OF PLANTING SEASONS SHALL RECEIVE AN AIR—DRIED WOOD CHIP MULCH, FREE OF COARSE MATTER.

7. AT ALL PROPOSED FILL AREAS WHICH ARE NOT CURRENTLY SHOWN ON THESE PLANS, THE CONTRACTOR SHALL ESTABLISH AN EROSION CONTROL LINE (HAYBALE CHECK OR FILTER FABRIC) ABOUT TEN (10') FEET FROM TOE TO SLOPE OF PROPOSED FILL AREAS PRIOR TO BEGINNING FILL INSTALLATION. STABILIZATION OF SLOPES IN FILL AREAS (USING MULCH OR GRASS) SHALL BE INITIATED WITHIN THIRTY (30) DAYS OF COMMENCEMENT OF FILL INSTALLATION.

8. STABILIZATION OF SLOPES IN OUT AREAS (USING MULCH OR GRASS) AND THE INSTALLATION OF CONTROL LINE (HAYBALE-CHECK OR FILTER FABRIC) AT THE TOE OF SLOPE SHALL BE INITIATED WITHIN THIRTY (30) DAYS OF COMPLETION.

9. SEDIMENT REMOVED FROM CONTROL STRUCTURES WILL BE DISPOSED IN A MANNER WHICH IS CONSISTENT WITH THE INTENT OF THE PLAN. ALL HAYBALES OR SILT FENCE RETAINING SEDIMENT OVER 1/2 THEIR HEIGHT SHALL HAVE—THE—SEDIMENT REMOVED AND ALL DAMAGED EROSION CONTROLS SHALL BE REPAIRED OR REPLACED.

10. CONTRACTOR WILL BE ASSIGNED THE RESPONSIBILITY INCLUDES THE INSTALLATION AND SEDIMENT CONTROL PLAN. THE RESPONSIBILITY INCLUDES THE INSTALLATION AND SEDIMENT CONTROL PLAN. THIS RESPONSIBILITY INCLUDES THE INSTALLATION AND MAINTENANCE OF CONTROL MEASURES, INFORMING ALL PARTIES ENGAGED ON THE CONSTRUCTION SITE OF THE REQUIREMENTS AND OBJECTIVES OF THE PLAN, AND NOTIFYING THE PLANNING BOARD OF ANY TRANSFER OF THIS RESPONSIBILITY. THE OWNER SHALL BE RESPONSIBLE FOR CONVEYING A COPY OF THE EROSION AND SEDIMENT CONTROL PLAN IF

THE CONTRACTOR SHALL VERIFY IN THE FIELD THAT THE CONTROLS REQUIRED BY THIS PLAN ARE PROPERLY INSTALLED, SHALL MAKE INSPECTION OF SUCH FACILITIES NOT LESS FREQUENTLY THAN EVERY 14 DAYS OR AFTER A RAINFALL IN EXCESS OF 1/2 INCH, WHICHEVER OCCURS FIRST. THE INSPECTION REPORTS SHALL BE SUBMITTED TO THE PLANNING DEPARTMENT AND CONSERVATION COMMISSION OFFICE ON A MONTHLY BASIS.

12. STOCKPILES OF SOIL SHALL BE SURROUNDED BY A SEDIMENT BARRIER. SOIL STOCKPILES TO BE LEFT BARE FOR MORE THAN THIRTY (30) DAYS SHALL BE STABILIZED WITH TEMPORARY VEGETATION OR MULCH. IF SOIL STOCKPILES ARE TO REMAIN FOR MORE THAN SIXTY (60) DAYS, FILTER FABRIC SHALL BE USED IN PLACE OF HAYBALES. SIDE SLOPES SHALL NOT EXCEED 2:1.

13. THE CONTRACTOR SHALL BE RESPONSIBLE TO CONTROL DUST AND WIND EROSION THROUGHOUT THE LIFE OF HIS CONTRACT. DUST CONTROL SHALL INCLUDE, BUT IS NOT LIMITED TO SPRINKLING OF WATER ON EXPOSED SOILS AND HAUL ROADS. CONTRACTOR SHALL CONTROL DUST TO PREVENT A HAZARD TO TRAFFIC.


14. WHERE DEWATERING IS NECESSARY, THERE SHALL NOT BE A DISCHARGE DIRECTLY INTO WETLANDS OR WATERCOURSES, PROPER METHODS AND DEVICES SHALL BE UTILIZED TO THE EXTENT PERMITTED BY LAW, SUCH AS PUMPING WATER INTO A TEMPORARY SEDIMENTATION BOWL, PROVIDING SURCE PROTECTION AT THE INLET AND THE OUTLET OF PUMPS, OR FLOATING THE INTAKE OF THE PUMP, OR OTHER METHODS TO MINIMIZE AND RETAIN THE SUSPENDED SOLIDS. IF A PUMPING OPERATION IS CAUSING TURBIDITY PROBLEMS, SAD OPERATION SHALL CEASE UNTIL SUCH TIME AS FEASIBLE MEANS OF CONTROLLING TURBIDITY PARE DETERMINED AND INPLEMENTED. SADD DISCHARGE POINTS SHALL BE LOCATED OVER 100 FEET FROM THE DELINEATED WETLANDS AS INDICATED ON THIS PLAN.

15. SILT SACKS OR OTHER EQUIVALENT ARE TO BE PLACED IN THE FIRST DOWNSTREAM CATCH BASINS FROM THE SITE.


16. ALL BMP EROSION CONTROL MEASURES SHALL BE IN PLACE PRIOR TO DEMOLITION OR ANY SITE WORK.

17. EROSION CONTROL BMPS SHALL CONFORM TO US EPA, NPDES, MA DEP AND MASSACHUSETTS EROSION AND SEDIMENTATION CONTROL GUIDELINES FOR URBAN AND SUBURBAN AREAS.


18. ALL EROSION AND SEDIMENTATION CONTROL MEASURES SHALL BE MAINTAINED THROUGHOUT THE CONSTRUCTION PROCESS UNTIL THE SITE HAS BEEN FULLY STABILIZED. THE MAINTENANCE SHALL INCLUDE REPLACEMENT OF THE BMP IF NECESSARY.

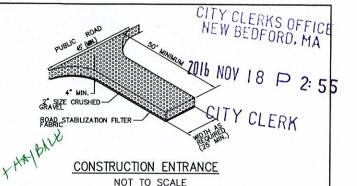

AT CATCH BASINS

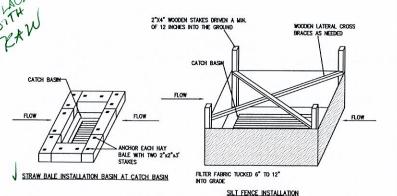


SEDIMENT AND EROSION CONTROL AT CATCH BASINS TO BE INSTALLED IF SPECIFIED BY FIELD ENGINEER NOT TO SCALE

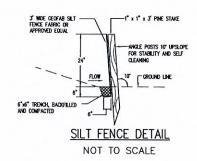

Case 38-16, 39-16 & 40-16 11/18/2016




		11/10/2010
	EROSION CONTROL PLAN	SCALE: 1" = 20'
	FAMILY DOLLAR	DATE: 11/4/2016 DRAWN BY: RICHARD RICHARD RICHARD RICHARD RICHARD RICHARD RICHARD RICHARD
	QUENT HUNT REAL ESTATE SERVICES, INC. TAMPA, FLORIDA	DESIGNED BY:
	LAND SURVEYING ST.	CHECKED BY: SHEET KB. C7.0
DATE DESCRIPTION BY	- ENVIRONMENTAL PRIME ENGINEERING TO SOR OUT ONSO	APPROVED BY: PROJECT NO. RJR 17210303

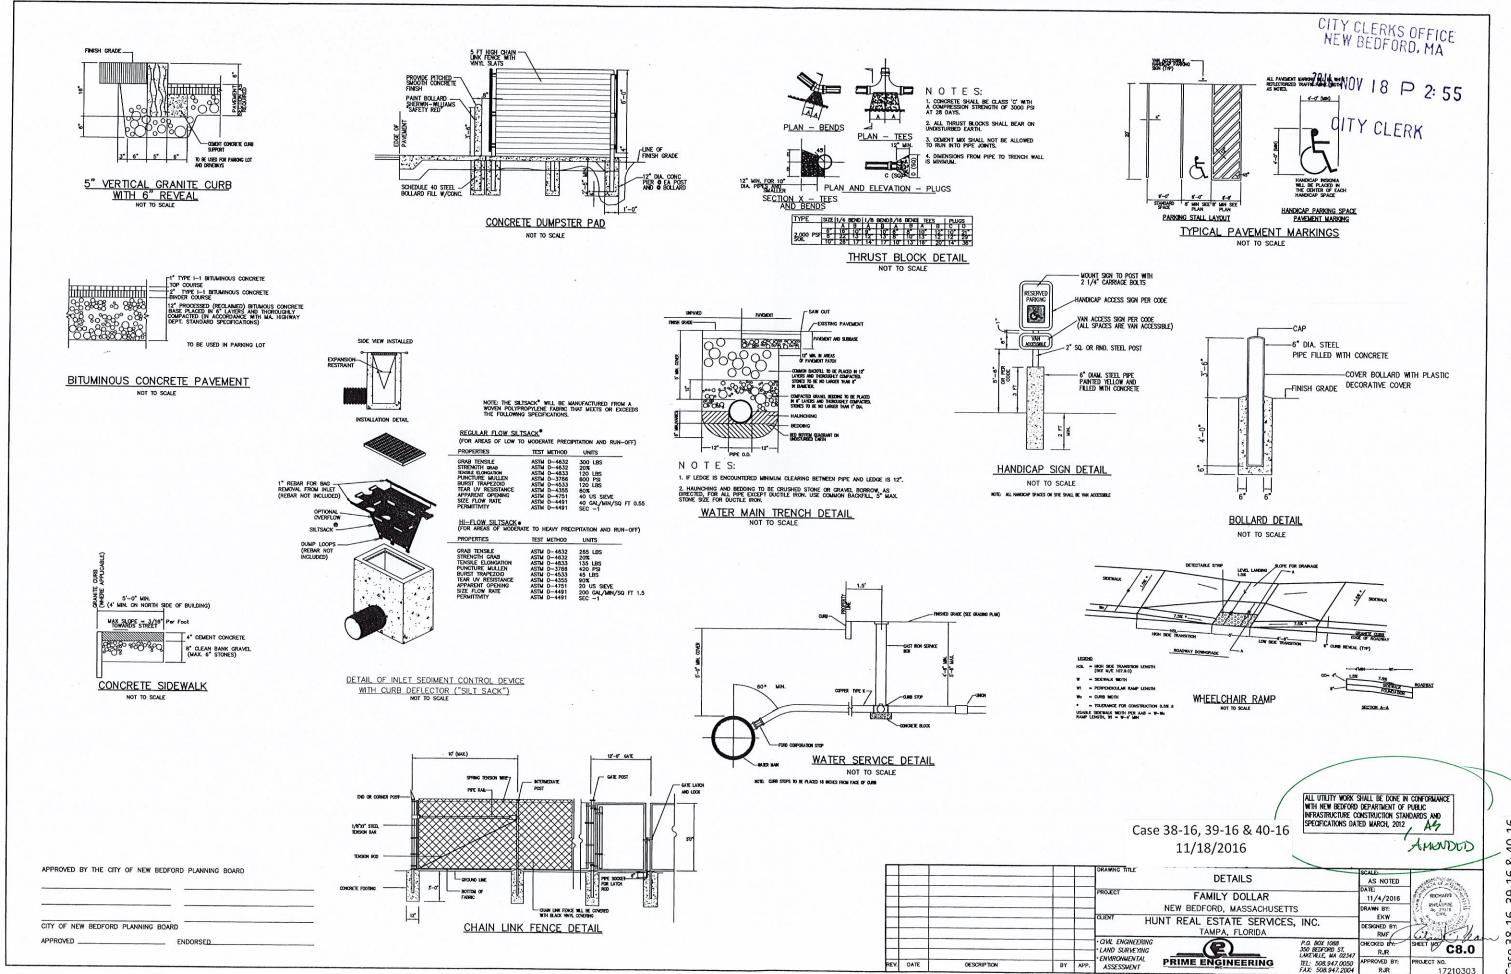


8-16, 39-16 & 2 11/18/2016 38-16,

RJR

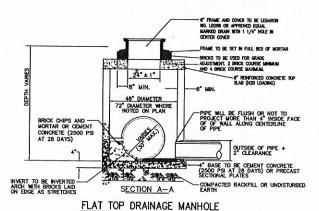


NOT TO SCALE TO BE USED ONLY WHERE SPECIFIED ON THE PLAN VIEW

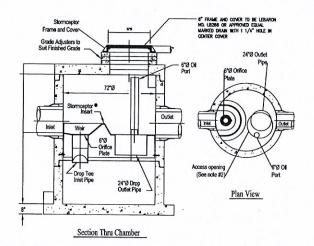


- The Use Of Flexible Connection is Recommended at The Inlet and Outlet Where Applicable.
 The Cover Should be Positioned Over The Outlet Drop Pipe and The Oil Port.
 The Stormceptor System is protected by one or more of the following U.S. Patents: #4985148, #5498331, #5725760, #5753115, #5949181, #6068765, #6371690.
- 4. Contact a Concrete Pipe Division representative for further details not listed on this drawing.

STC 900 Precast Concrete Stormceptor (900 U.S. Gallon Capacity)

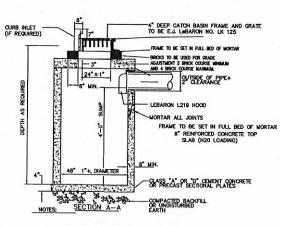


1. MASSACHUSETTS STANDARD CATCH BASIN HOOD SHALL BE INSTALLED ON OUTLET PIPE. TYPICAL FLAT TOP CATCH BASIN NOT TO SCALE

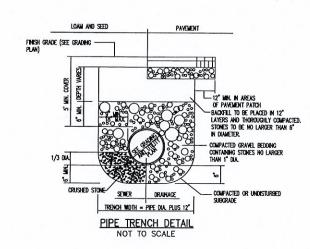


CITY CLERKS OFFICE NEW BEDFORD, MA

2016 NOV 18 P 2: 55


CITY CLERK

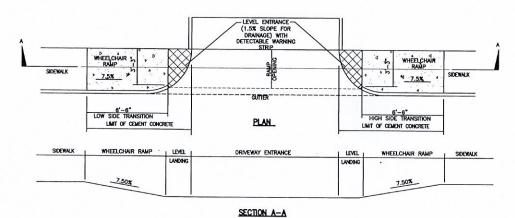


CEMENT CONCRETE WHEELCHAIR RAMP

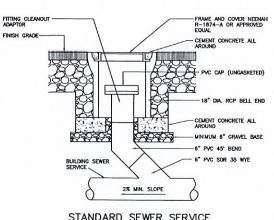

STANDARD SEWER SERVICE CLEANOUT DETAIL

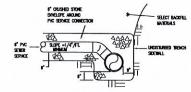

SECTION A - A

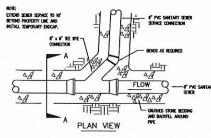

SANITARY SEWER SERVICE CONNECTION NOT TO SCALE

ALL LITELITY WORK SHALL BE DONE IN CONFORMANCE WITH NEW BEDFORD DEPARTMENT OF PUBLIC INFRASTRUCTURE CONSTRUCTION STANDARDS AND SECOND MARCH, 2012 AND 156 CATIONS DATED MARCH AND 156 CATIONS DATED MARCH AND 156

11/18/2016

AMENDED

					DRAWING TITLE	DETAILS		SCALE: AS NOTED DATE:	1500
					PROJECT	FAMILY DOLLAR NEW BEDFORD, MASSACHUSETTS	S	11/4/2016 DRAWN BY:	SYCHARD SHEAUNE RO MOTS CYTE
					CUENT H	JNT REAL ESTATE SERVICES, TAMPA, FLORIDA	, INC.	DESIGNED BY:	Chall Chean
					· CIVIL ENGINEERING · LAND SURVEYING		P.O. BOX 1088 350 BEDFORD ST. LAKEVILLE, MA 02347	CHECKED BY:	SHET HO. C9.0
REV.	DATE	DESCRIPTION	BY	APP.	* ENVIRONMENTAL ASSESSMENT	PRIME ENGINEERING	TEL: 508.947.0050 FAX: 508.947.2004	APPROVED BY: RJR	PROJECT NO. 17210303

APPROVED BY THE CITY OF NEW BEDFORD PLANNING BOARD

CITY OF NEW BEDFORD PLANNING BOARD

____ ENDORSED


38-16, 39-16 & 40-16 11/18/2016

LIGHT POLE SHOP DRAWINGS

INCLIDED WITH THE POLE SHOP DRAWING SUBHITTAL SHALL BE A SIGNED AND SEALED DRAWING OF THE SITE LIGHTING POLE BASE DESIGN SHOWING MINIMAM BASE DEPTH. CALCULATION SHALL BE PERFORMED BY A REGISTERED PROFESSIONAL ENGINEER WITH AN ACTIVE LICENSE IN THE STATE OF MASSACHISETTS. CALCULATION SHALL BE BASED ON SOIL INFORMATION AT ACTUAL SITE.

STATISTICS						
Description	Symbol	Avg	Max	Min	Max/Min	Avg/Min
OVERALL SITE	+	2.8 fc	6.1 fc	0.2 fc	30.5:1	14.0:1
PARKING AREA	*	3.3 fc	5.7 fc	1.9 fc	3.0:1	1.7:1
SPILL LIGHT	+	0.4 fc	1.1 fc	0.0 fc	N/A	N/A

SURFACE SC	HEDULE					
	Reflec	tances		No/mai		
Name	Front	Back	X	Y	Z	Area (ft²)
Structure	0%	0%				

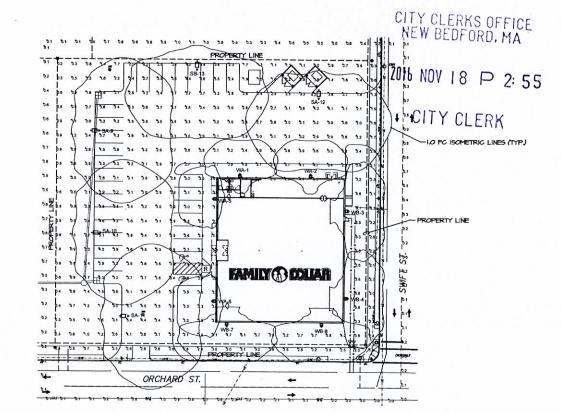

Symbol	Label	Qty	Catalog Number	Description	Lamp	File	Lumens	LLF	Watts
-	SA	4	DSX1 LED 60C 1000 40K T4M MVOLT	DSX1 LED with 60 LEDs @ 1000 mA , 4000K , TYPE 4 MEDIUM OPTICS	LED	DSX1_LED_60 C_1000_40K_T 4M_MVOLT.ie	Absolute	0.90	209
ô	SB	1	DSX1 LED 60C 1000 40K T4M MVOLT HS	DSX1 LED with 60 LEDs @ 1000 mA , 4000K , TYPE 4 MEDIUM OPTICS WITH HOUSE-SIDE SHIELD	LED	DSX1_LED_60 C_1000_40K_T 4M_MVOLT_H S.ies	Absolute	0.90	209
â	WA	4	DSXW1 LED 20C 700 40K T4M MVOLT	DSXWI LED WITH (2) 10 LED LIGHT ENGINES, TYPE T4M OPTIC, 4000K, @ 700mA.	LEO	DSXW1_LED_ 20C_700_40K_ T4M_MVOLT.I	Absolute	0.90	45.7
ê	WB	4	DSXW1 LED 20C 1000 40K T3M MVOLT	DSXW1 LED WITH (2) 10 LED LIGHT ENGINES, TYPE T3M OPTIC, 4000K, @ 1000mA.	LED	DSXW1_LED_ 20C_1000_40K _T3M_MVOLT.	Absolute	0.90	73.2

			Location						Aim	
No.	Label	x	Y	Z	МН	Orientation	Tit	×	Y	z
1	WA	440.2	227.7	10.5	10.5	0.0	0.0	440.2	227.7	0.0
2	WA	489.1	227.7	10.5	10.5	0.0	0.0	489.1	227.7	0.0
- 3	WB	514.9	203.0	10.5	10.5	90.0	0.0	514.9	203.0	0.0
4	WB	514.9	141.5	10.5	10.5	90.0	0.0	514.9	141.5	0.0
5	WA	422.6	212.7	15.0	15.0	-90.0	0.0	422.6	212.7	0.0
6	WA	422.2	135.9	15.0	15.0	-90.0	0.0	422.2	135.9	0.0
7	WB	444.3	123.4	10.5	10.5	180.0	0.0	444.3	123.4	0.0
8	WB	497.7	123.0	10.5	10.5	180.0	0.0	497.7	123.0	0.0
9	SA	334.5	259.0	25.0	25.0	90.0	0.0	336.7	259.0	0.0
10	SA	335.8	187.3	25.0	25.0	90.0	0.0	338.0	187.3	0.0
11	SA	355.9	128.4	25.0	25.0	90.0	0.0	358.1	128.4	0.0
12	SA	494.4	288.5	25 0	25.0	180.0	0.0	494.4	286.2	0.0
13	SB	408.8	308.1	25.0	25.0	180.0	0.0	408.8	305.9	0.0



ALL SITE AND BUILDING LIGHTS PROPOSED ON THIS PROJECT ARE DESIGNED AS FULL CUTOFF CLASSIFICATION WITH ZERO UP LIGHT COMPONENTS.

THESE PHOTOMETRICS ARE INTENDED FOR DESIGN AND EVALUATION PURPOSES ONLY. THE POINT-STY-POINT SHOWN IS BASED ON A COMPUTER LIGHTING PROGRAM WITH APPROXIMATED PARAMETERS. THEREFORE, THESE PHOTOMETRICS MAY VARY FROM ACTUAL FIELD CONDITIONS.



	"REVIEWED"
]	"DISAPPROVED - RESUBMIT"

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SOUHEIL CHEHAYEB, P.E. MA License No. 39553

ST. CORNER SWIFT ST. & ORCHARD BEDFORD, MASSACHUSETTS


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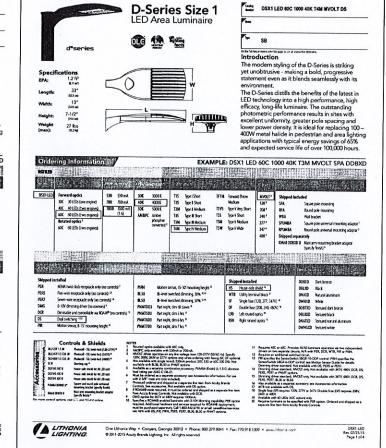
PHOTOMETRIC SITE PLAN


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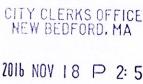
38-16, 39-16 & 4 11/18/2016



DSXW1 LED 20C 700 40K T4M MVOLT



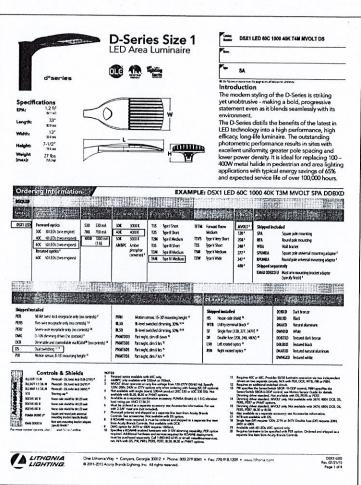

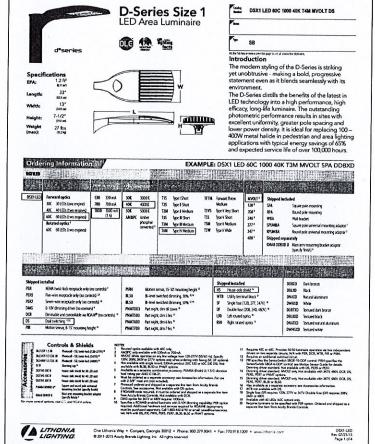

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FIXTURE

INFORMATION

38-16, 39-16 & 4 11/18/2016

Case 3

D-Series Size 1 Catalog DSXW1 LED 20C 1000 40K T3M MVOLT **D-Series Size 1 @** 👁 📹 WB The D-Series Wall luminaire is a stylish, fully The D-Series Wall luminaire is a stylish, fully Specifications Luminaire integrated LED solution for building-mount Back Box (BBW, ELCW) integrated LED solution for building-mount Back Box (BBW, ELCW) applications. It features a sleek, modern design Width: 13-3/4" Weight: 34.9 cm | 10" | 25.4 cm |
 Width:
 13-3/4*
 BBW
 5 lbs

 5490ml
 Weight:
 23 tg

 Depth:
 4*
 ELCW
 10 lbs

 (102 cm)
 Weight:
 #5 tg
 applications. It features a sleek, modern design Width: 13-3/4" (34.9 cm) Depth: 10" (25.4 cm) Width: 13-3/4* BBW (349 on) Weight: Depth: 4* ELCW Weight: and is carefully engineered to provide long-lasting, and is carefully engineered to provide long-lasting, energy-efficient lighting with a variety of optical energy-efficient lighting with a variety of optical 10 lbs #51g Height: 6-3/8* and control options for customized performance Height With an expected service life of over 20 years of With an expected service life of over 20 years of nighttime use and up to 74% in energy savings nighttime use and up to 74% in energy savings over comparable 250W metal halide luminaires, the D-Series Wall is a reliable, low-maintenance over comparable 250W metal halide luminaires the D-Series Wall is a reliable, low-maintenance lighting solution that produces sites that are lighting solution that produces sites that are exceptionally illuminated. exceptionally illuminated. EXAMPLE: DSXW1 LED 20C 1000 40K T3M MYOLT DDBTXD EXAMPLE: DSXW1 LED 20C 1000 40K T3M MVOLT DDBTXD Deligned busined busin September of the control of the cont | DSTWILES | DS | D16h | DS | D50 mA | DS | D000 f | D50 | D50 mA | D50 | D | 100 | 10 | 150 | 150 | 150 | 160 | 160 | Shipped installed PF Photoderon on button on b Shipped Included (blank) Surface mourning bracket BEW Surface-mounted back box (for condust entry) 1 Shipped included (blank) Surface mounting backet BBW Surface-mounted back box (for conclui-entry) * Medium

TAM type N
Medium

TETM forward
Throw
Medium

ASYDF Asymmetic
diffuse Shipped separately BSW Bel-desi-ent spies W6 Wre guard V6 Vancal guard DOL Officed dopless MOUL diver operation on the endang board 12-777 (20 to 12 doing 1) (20, 24, 10 to 27) options only also ordering with Lang (5).

While the property of the pro Accessories One Lithonia Way * Conyers, Georgia 30012 * Phone: 800.279.8041 * Fax: 770.918.1209 * www.ithon.a.com 0.2013-2014 Aguny Branck Lighting Inc. All rights meaned


SOUHEIL CHEHAYEB, P.E. 3702 AZEELE ST. TAMPA, FL 33609 (813) 876-1415 (fux) 876-0913 UC #39553 SOUHEIL CHEHAYEB

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CERTIFICATE OF OCCUPANCY NOTE

G.C. IS RESPONSIBLE FOR THE "CERTIFICATE OF OCCUPANCY". CERTIFICATE TO BE FRAMED AND
MOUNTED IN THE HANAGERS OFFICE OVER THE DOOR. IF HUNICIPALITY DOES NOT ISSUE A CAMO, IT IS
THE RESPONSIBILITY OF THE G.C. TO GET A LETTER FROM THE HUNICIPALITY STATING AS SUCH ON
CITY/ COUNTY LETTERHEAD AND THAT LETTER IS TO BE FRAMED AND MOUNTED IN MANAGER'S OFFICE

CTTY CLET NOTE OF THE PRODUCTION SHALL BE RESPONSIBLE FOR ENSURING THAT ALL CONSTRUCTION IS IN THE WEST OFFICENCE WITH ALL LOCAL, STATE AND NATIONAL CODES GOVERNING THE JURISDICTION, AND HITH THE AMERICANISM WITH DISABILITIES ACT. THE GC SHALL COORDINATE THE VARIOUS CONSTRUCTION DOCUMENTS FOR THE PROJECT. IF CONFLICT OF INFORMATION IS FOUND, THE GC SHALL RESOLVE THE CONFLICTS PRIOR TO PROCEEDING.

COURN LAYOUT NOTE
BUILDING COLUMNS MUST BE LOCATED AS NOT TO INTERFERE WITH DOOR LOCATIONS INDICATED ON

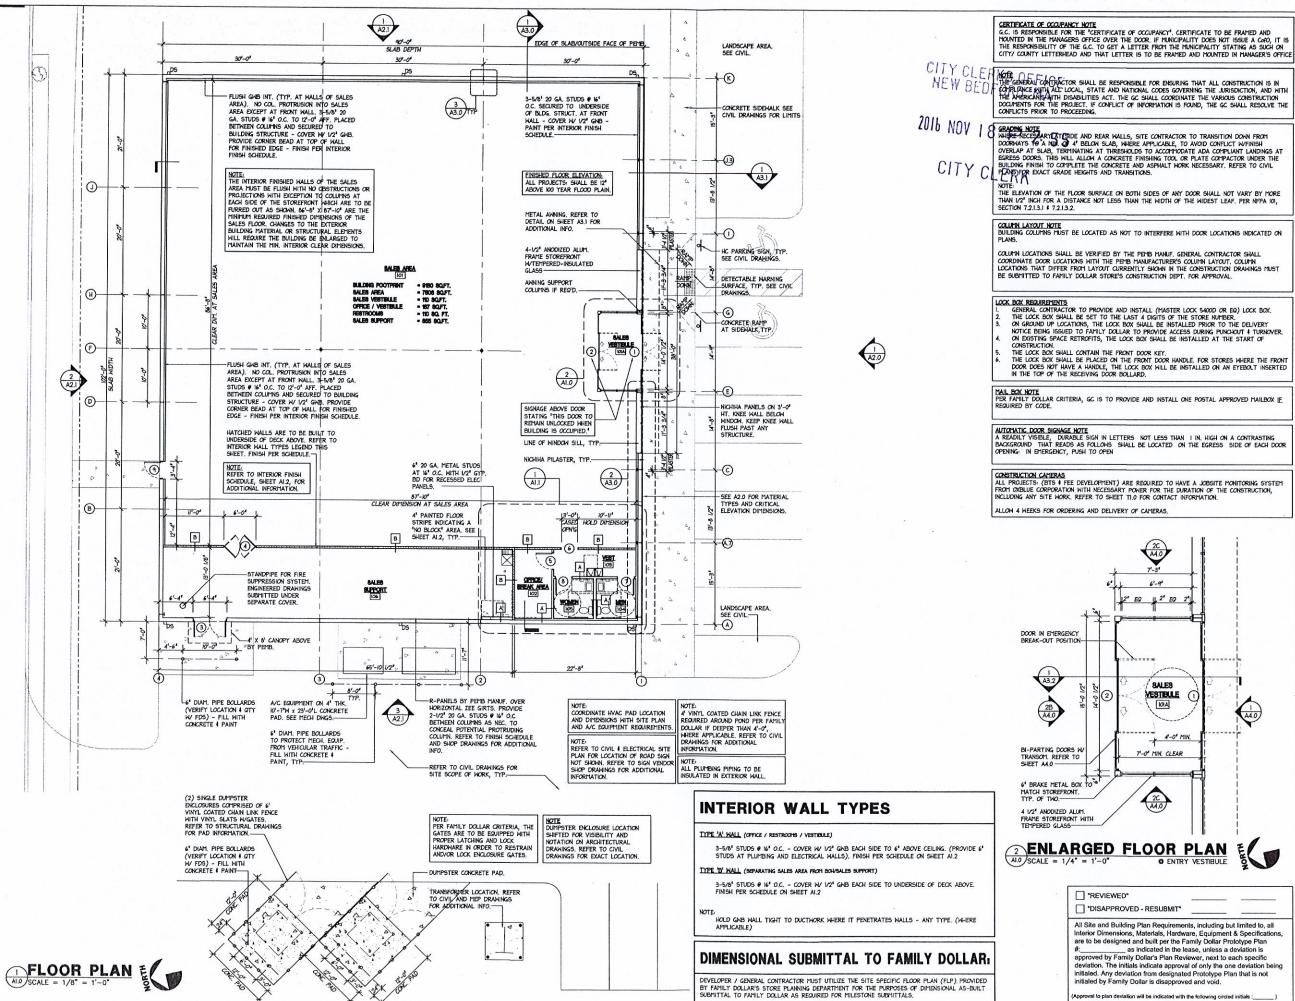COUM'N LOCATIONS SHALL BE VERIFIED BY THE PEMB MANUF, GENERAL CONTRACTOR SHALL COORDINATE DOOR LOCATIONS WITH THE PEMB MANUFACTURER'S COLUMN LAYOUT, COLUMN LOCATIONS THAT DIFFER REVOLUCIATIONS THAT DIFFER REVOLUCIATIONS THAT DIFFER REVOLUCIATIONS THAT DIFFER REVOLUCIATION DEPT. FOR APPROVAL,

- LOCK BOX REQUIREMENTS

 1. GENERAL CONTRACTOR TO PROVIDE AND INSTALL (MASTER LOCK 5400D OR EQ) LOCK BOX.

 2. THE LOCK BOX SHALL BE SET TO THE LOCK BOX GROWN OF THE STORE NUMBER.

 3. ON GROWND UP LOCATIONS, THE LOCK BOX SHALL BE INSTALLED PRIOR TO THE DELIVERY NOTICE BEING ISSUED TO FAMILY DOLLAR TO PROVIDE ACCESS DURING PUNCHOUT I TURNOVER.

 4. ON EXISTING SPACE RETROFITS, THE LOCK BOX SHALL BE INSTALLED AT THE START OF CONSTRUCTION.
- ON EXISTING SPACE RETROFTS, THE LOCK BOX SHALL BE INSTALLED AT THE START OF CONSTRUCTION.

 THE LOCK BOX SHALL CONTAIN THE FRONT DOOR KEY.

 THE LOCK BOX SHALL BE PLACED ON THE FRONT DOOR HANDLE, FOR STORES WHERE THE FRONT DOOR DOES NOT HAVE A HANDLE, THE LOCK BOX WILL BE INSTALLED ON AN EYEBOLT INSERTED IN THE TOP OF THE RECEIVING DOOR BOLLARD.


MAIL BOX NOTE
PER FAMILY DOLLAR CRITERIA, GC IS TO PROVIDE AND INSTALL ONE POSTAL APPROVED MAILBOX IE
REQUIRED BY CODE.

AUTOMATIC DOOR SIGNAGE NOTE

A READILY VISIBLE, DURABLE SIGN IN LETTERS NOT LESS THAN I IN. HIGH ON A CONTRASTING BACKGROUND THAT READS AS FOLLOWS SHALL BE LOCATED ON THE EGRESS SIDE OF EACH DOOR OPENING: IN EMERGENCY, PUSH TO OPEN

CONSTRUCTION CAMERAS
ALL PROJECTS: (BTS) FEE DEVELOPMENT) ARE REQUIRED TO HAVE A JOBSITE MONITORING SYSTEM FROM CABLUE CORPORATION WITH NECESSARY POWER FOR THE DURATION OF THE CONSTRUCTION, INCLUDING ANY SITE WORK. REFER TO SHEET TI.O FOR CONTACT INFORMATION.

ALLOW 4 WEEKS FOR ORDERING AND DELIVERY OF CAMERAS

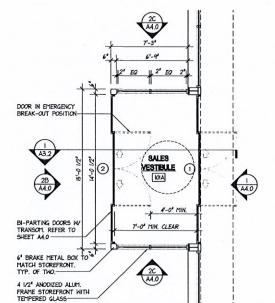

ENLARGED FLOOR PLAN O ENTRY VESTIBULE

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GUY F. FABER MA License No. 31856

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CORNER SWIFT ST. & ORCHARD BEDFORD, MASSACHUSETTS

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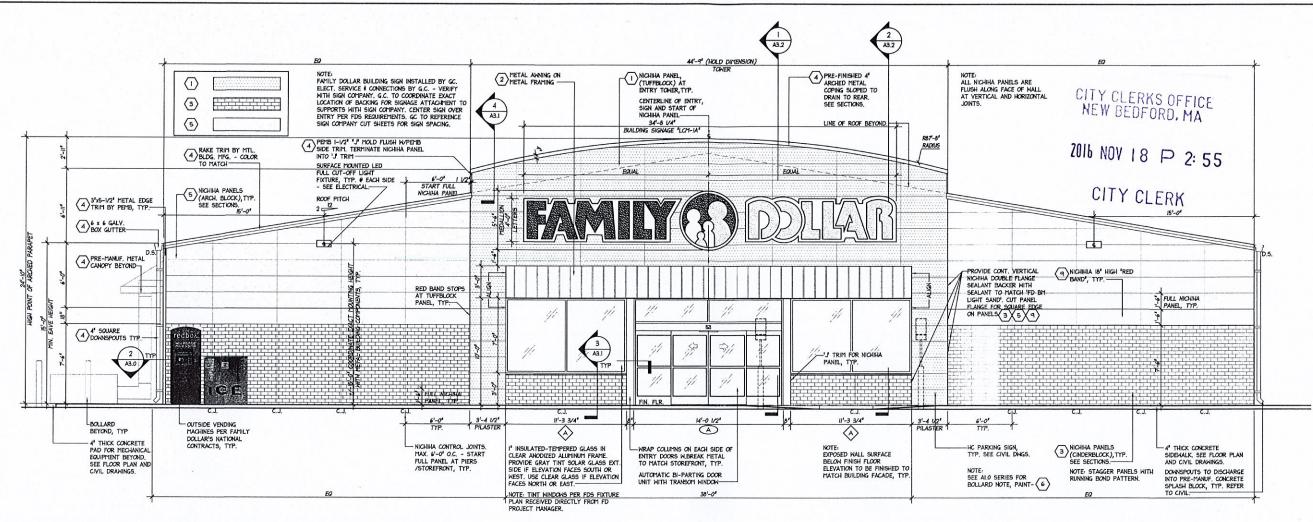
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102 X 90 FLOOR PLAN & NOTES

3-16, 39-16 & 4 11/18/2016 Case

40-16

38-16,



SOUTH ELEVATION (PARKING LOT) A20 SCALE = 1/4' = 1'-0'

APPLY MASONRY BLOCK FILLER TO CONCRETE BLOCK PRIOR TO FINISH PAINTING. (AT DUMPSTER ENCLOSURE ONLY

REFER TO PAINT ORDERING INSTRUCTIONS ON SHEET TIO

TRAFFIC PAINT-BENJAMIN MOORE LATEX TRAFFIC PAINT TD58

IF METAL BUILDING IS USED, G.C. TO SUBMIT MANUFACTURER'S STANDARD COLORS TO FAMILY DOLLAR FOR APPROVAL

EXTERIOR PAINT (OTHER THAN TRAFFIC PAINT) -BENJAMIN MOORE: ULTRA SPEC HP DTM ACRYLIC SEMI-GLOSS ENAMEL - HP29

0.	AREA	TYPE	COATS	COLOR
(-)	'NICHIHA' FIBER CEMENT WALL PANEL	TUFFBLOCK LARGE BLOCK (18"X72") PANEL W/TEXTURED FIN.	PRE-FINISHED	MATCH BENJAMIN MOORE COLOR 'FD BM LIGHT SAND'
2	METAL AWNING	VP - PANEL RIB NUCOR - CLASSIC WALL	PRE-FINISHED	MATCH VP COLOR "COOL BRIGHT RED" OR MATCH BENJAMIN MOORE COLOR "FD BM SAFETY RED"
3	'NICHIHA' FIBER CEMENT WALL PANEL	EDA621E CINDERBLOCK - BROWN (18*X72*) PANEL	PRE-FINISHED	
4	DOORS, GUTTERS, DOWNSPOUTS, MTL. TRIM, RAKE TRIM, RECEIVING CANOPY, ARCHED PARAPET CAP	METAL BUILDING MANUFACTURER	PRE-FINISHED	YP COLOR "TAN" NUCOR COLOR "SAGEBRUSH TAN" HID-WEST COLOR "SADDLE TAN" BENLIMIN MOORE COLOR "TO BY DARK SAND"
5	'NICHIHA' FIBER CEMENT WALL PANEL	ARCHITECTURAL BLOCK SERIES-COLOR TUSCAN	PRE-FINISHED	BENJAMIN MOORE COLOR 'FD BM KHAKI'
6	STEEL BOLLARDS	EXTERIOR LATEX	2	BENJAMIN MOORE COLOR 'FD BM SAFETY RED'
7	METAL ROOF	STANDING SEAM ROOF	PRE-FINISHED	COOL ARCTIC WHITE
8	METAL PANELS	MID-WEST - PBA PANEL NUCOR - ACCENT PANEL VP - VEE RIB PANEL	PRE-FINISHED	MID-MEST COLOR "SADDLE TAN" NUCOR COLOR "SAGEBRUSH TAN" VP COLOR "TAN" BENJAMIN MOORE COLOR "FD BM DARK SAND"
9	'NICHIHA' FIBER CEMENT WALL PANEL (RED BAND)	ILLUMINATIONS LARGE BLOCK (18*X72*) PANEL	PRE-FINISHED	MATCH BENJAMIN MOORE COLOR 'FD BM SAFETY RED'

- THIS SYSTEM USES STANDING SEAM ROOF SYSTEM THERMAL BLOCKS, G.C. TO PROVIDE 20 YEAR WEATHER TIGHTNESS WARRANTY.
- THE WALL PANELS ARE ATTACHED WY SELF-DRILLING CORROSION RESISTANT TYPE LONG LIFE CARBON STEEL FASTENERS WITH HEX HEAD AND SEALING WASHER (OR EQUAL) FOR ALL EXTERIOR METAL WALL PANELS, FASTENER COLOR TO MATCH PANEL BEING FASTENED
- METAL BUILDING EAVE HT. TO BE ADJUSTED AS REQUIRED TO MAINTAIN FAMILY DOLLAR STANDARD CEILING HEIGHT.

VERIFY W SPECIFIC METAL BLDG. CO.

FEE DEVELOPMENT PROJECTS

INSTALLATION OF ROAD AND BUILDING SIGN MUST BE INCLUDED IN GENERAL CONTRACTOR'S BID AND SCOPE OF WORK.

CONTRACTOR MUST PROVIDE A 20-YEAR, WEATHERTIGHT WARRANTY THAT HAS BEEN PRE-APPROVED BY FAMILY DOLLAR. NO EXCEPTIONS.

BLOCKING NOTE

GC TO PROVIDE AND INSTALL BLOCKING AT SIGNAGE, AWNING/CANOPY AND EXTERIOR LIGHT FIXTURE LOCATIONS AS NEC. TO ENSURE ADEQUATE SUPPORT IS PRESENT FOR A SECURE CONNECTION TO THE FACE OF THE BUILDING.

FOR THE EXTERIOR WALL PACKS WHEN MOUNTED TO CORRUGATED WALL PANELS FIXE TO THE WOOD PACKET OF HOOD AS A MOUNTING BLOCK, PAINTED TO MATCH PAKEL COLOR, SCREM THROUGH TO BLOCKING ON INSIDE PRIOR TO MOUNTING FIXTURE TO THE WOOD MOUNTING BLOCK.

NOTE

ALL DIMENSIONS SHOWN ARE TAKEN FROM SLAB HEIGHT, NOT SURROUNDING GRADE ELEVATION, TYPICAL.

METAL TRIM NOTE

ALL METAL TRIM TO BE FURNISHED BY BUILDING VENDOR.

'J' TRIM NOTE

PEMB SHALL FURNISH ALL "J" TRIMS OR JAMB EXTENSIONS FOR NICHIHA PANEL TERMINATION. SEE FINISH SCHEDULE FOR ADDITIONAL INFORMATION.

NOTE

ALL GLAZING TO BE TEMPERED, U.N.O.

GENERAL EXTERIOR NOTE

PROVIDE SLEEVE, BOOT, OR OTHER APPROPRIATE PENETRATION MATERIAL FOR A CLEAN TRANSITION FROM EXTERIOR TO INTERIOR FOR ALL CONDUIT WIRE, PIPE ETC. OWNER MUST APPROVE METHOD AND FINISH BEFORE BUILDING COMPLETION.

METAL FRAME BUILDINGS SHALL HAVE AN MIN. EAVE HEIGHT OF 15'-0". EAVE HEIGHT DEPENDANT ON MIN. INTERIOR REQUIREMENTS. SEE A3.0 BOXED NOTE.

DOWNSPOUTS SPACING T.B.D. BY CIVIL ENGINEER, BASED ON LOCAL TYPICAL AND MAXIMUM RAINFALL ANOUNTS, WITH DOWNSPOUTS PLACED EQUALLY APART TYP. NO DOWNSPOUT MAY BE PLACED WITHIN 12' OF A DOOR FRAME. USE A MINIMUM OF THREE STRAPS PER DOWNSPOUT, TYP.

IF SPLASH BLOCKS ARE USED, G.C. SHALL ENSURE THAT NO SAFETY HAZARDS ARE CREATED BY THE DISCHARGE OF MATER FROM THE DOWNSPOUTS OR BY ICE WHICH MAY FORM AS A RESULT OF THE WATER DISCHARGE FROM THE DOWNSPOUTS, COORDINATE ROOF STORM WATER DRAINAGE WITH PROJECT CIVIL

PROVIDE FLUSH TRENCH DRAINS ACROSS SIDEWALKS TO PARKING AREAS IF DOWNSPOUTS DO NOT TIE TO UNDERGROUND STORM SYSTEM.

CANOPY/AWNING NOTE

STOREFRONT & FREIGHT DOORS MUST BE SHIELDED OVERHEAD FROM THE MEATHER. IF THE PROTOTYPE CANOPY IS NOT USED, AN AWNING, VESTIBULE OR OTHER FORM OF PROTECTION MUST BE USED. FINAL APPROVAL FROM FAMILY DOLLAR STORES

- GENERAL CONTRACTOR SHALL INSTALL SIGNAGE.
 FAMILY DOLLAR STORE SIGNAGE VENDOR SHALL FURNISH SIGNAGE AND
 METAL SUPPORTS AS REQUIRED FOR SIGNAGE INSTALLATION, GENERAL
 CONTRACTOR SHALL COORDINATE INSTALLATION, AND EXCINIS FOR METAL
 SUPPORTS.
 GENERAL CONTRACTOR SHALL PROVIDE ELECTRICAL SERVICE AND
 CONNECTIONS FOR SIGNAGE, VERIFY ELECTRICAL DEMAND OF SIGNAGE
 HITH FAMILY DOLLAR STORE.
 COORDINATE ACCESS PANEL LOCATION FOR SIGNAGE MOUNTED ON SIDES
 OR REAR OF BUILDING FAMILY DOLLAR STORE.

SECONDARY SIGNAGE NOTE

- MALL MOUNTED LIGHT FIXTURES AT SIGNAGE LOCATIONS SHALL BE RECENTERED ABOVE SIGNAGE IF SECONDARY SIGNAGE IS PROVIDED. CONFIRM MOUNTING HEIGHT OF SECONDARY SIGNAGE WITH FAMILY

SIGNAGE WILL BE REVIEWED UNDER A SEPARATE SUBMITTAL AND PERMIT, SIGN YENDOR TO SUBMIT NECESSARY DRAWINGS AND APPLICATIONS AS NEC. TO OBTAINED ALL APPROVALS AND PERMITS ASSOCIATED WITH THE PROJECT'S SIGNAGE.

IF SITE POLE LIGHTING IS PROVIDED THAT FACES THE FRONT ELEVATION, THEN THE PROTOTYPICAL SURFACE MOUNTED LED FLOOD LIGHTS ARE NOT REQUIRED.

REFER TO SECTIONS FOR TYPICAL METAL BUILDING TRIM/PARAPET DETAILS.

PARAPET CAP NOTE

ARCHED METAL COPING SHALL HAVE A SMOOTH RADIUS AND CAN BE MADE UP OF MULTIPLE LENGTHS, MIN. IO' LONG, NO SEAM AT PEAK ϕ SPACE SEAMS EQUALLY FROM PEAK CENTER LINE.

NOTE

PROVIDE CONT. WEEP SCREED AT NICHIHA BASE.

SLOPE SIDEMALK TO PROVIDE A MINIMUM OF 2" OF CLEARANCE BETWEEN THE SIDEMALK SURFACE AND THE BOTTOM OF THE NICHIHA PANELS, SLOPE SHALL COMPLY WITH APPLICABLE HANDICAPPED ACCESSIBILITY REQUIREMENTS.

REFER TO SHEET A4.0 FOR STOREFRONT DIMENSIONS AND ADDITIONAL INFORMATION.

Case 38-16, 39-16 & 40-16 11/18/2016

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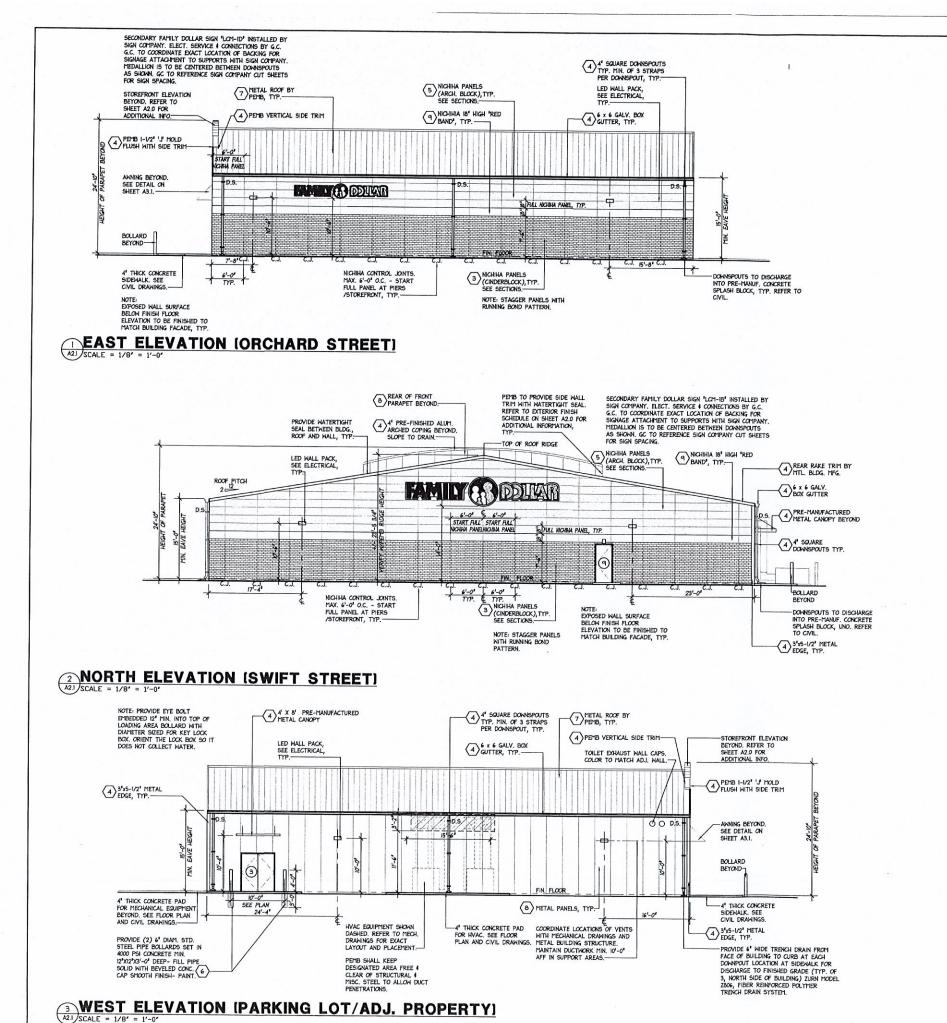
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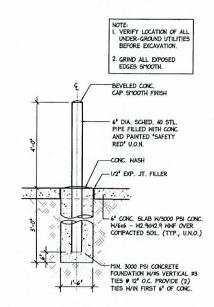
EXT. ELEVATION EXT. FINISH SCHED. AND NOTES



CITY CLERKS OFFICE NEW BEDFORD, MA

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CITY CLERK



4 BOLLARD DETAIL

A2.1 SCALE = 1/2' = 1'-0'

3336 Grand Blvd. Suite 20 Holiday Florida 34690 Ph. 727. 815. 3336 Fax 727. 815. 3337 TO THE BEST OF THE KNOWLEDGE OF THE ARCHITECTS AND ENGINEERS, PLA AND SPECIFICATIONS COPPLY WITH TH APPLICABLE MINITUM BUILDING CODE AND THE APPLICABLE MINITUM FIRE SAFETY STANDARDS GUY F. FABER MA License No. 31856 ST

POLLA CORNER SWIFT ST. & ORCHARD BEDFORD, MASSACHUSETTS

Case	38-16,	39-16	& 40-16	_

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NOTE REFER TO SHEET A2.0 FOR EXTERIOR FINISH SCHEDULE AND ADDITIONAL INFORMATION


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EXT. ELEVATIONS

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FWH Architects

Lic.# AA 0003:

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TO THE BEST OF THE KNOWLEDGE OF HE ARCHITECTS AND ENGINEERS, PLANS AND SPECIFICATIONS COMPLY WITH THE APPLICABLE MANHAM BUILDING CODES AND THE APPLICABLE MINIMAM FIRE SAFETY STANDARDS

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date revision descriptions

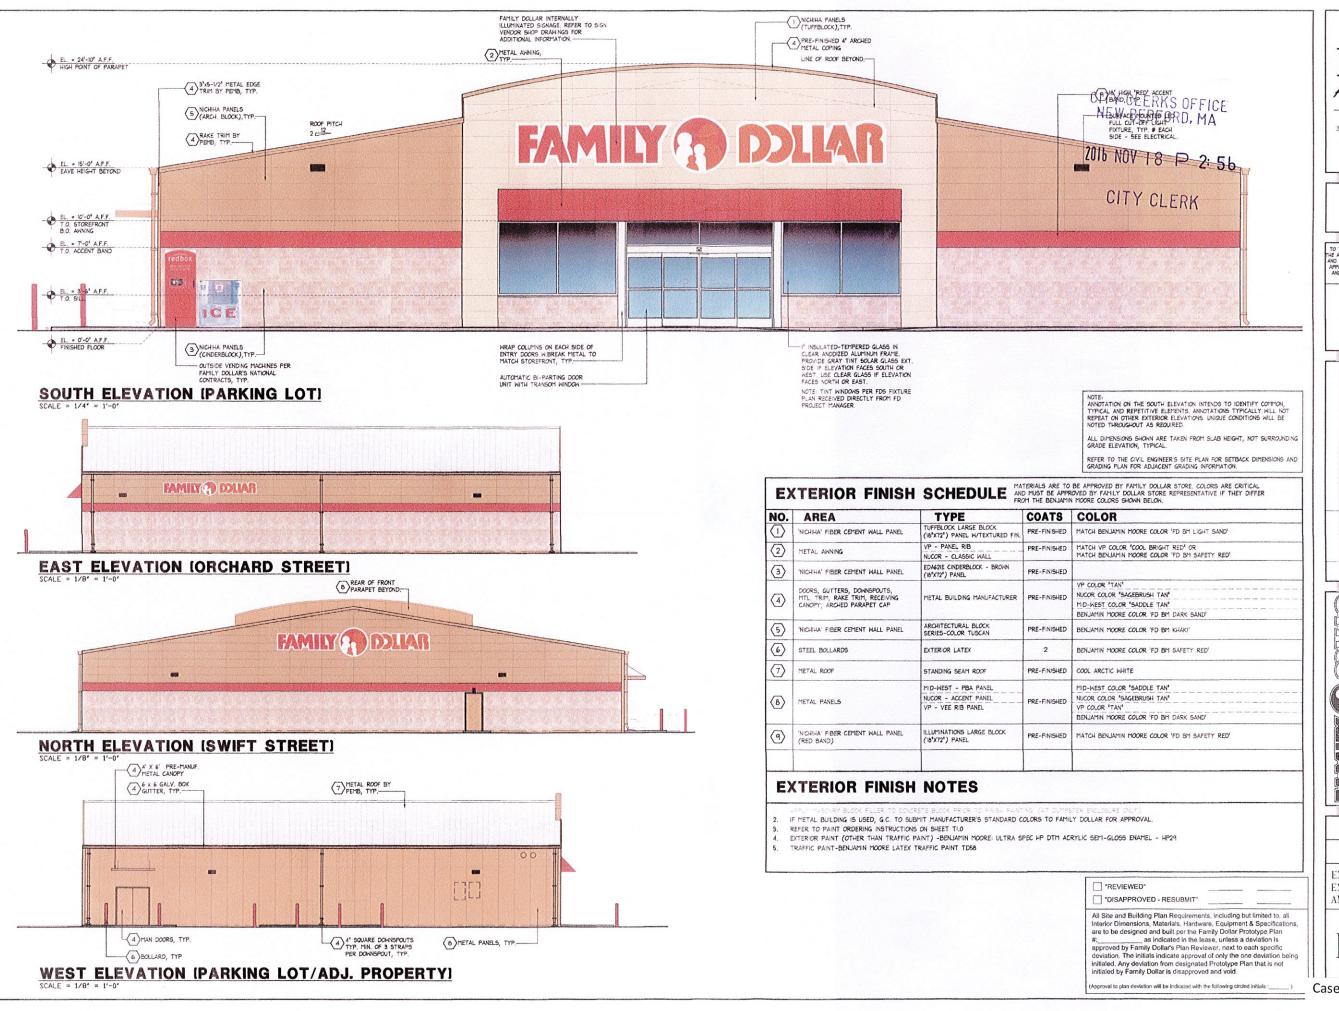SW CORNER SWIFT ST. & ORCHARD ST BEDFORD, MASSACHUSETTS

11.03.16 date

> 16085 comm. no.

EXT. ELEVATION EXT. FINISH SCHED AND NOTES

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__ Case 38-16, 39-16 & 40-16