

INDUSTRIAL SITE DEVELOPMENT PLANS

SITE PLAN APPROVAL MODIFICATION

2301 Purchase Street
New Bedford, Massachusetts

SEPTEMBER 11, 2015



11 CUSHMAN STREET
MIDDLEBORO, MA 02346
T: 508-967-0673 F: 508-967-0674
WWW.SITEDESIGNENG.COM

CITY CLERK

NO.	DATE	DESCRIPTION	APPROVED
1	2015 SEP 14 3:36	CITY CLERK'S OFFICE NEW BEDFORD, MA	

PLAN REVISIONS

DATE: SEPTEMBER 11, 2015

DRAWN BY: RLM/RT DESIGN BY: RT/DCM CHECK BY: DCM/TWH

PROJECT NO. 14101

ISSUED FOR:

REVIEW

CIVIL ENGINEER
SITE DESIGN ENGINEERING, LLC.
11 CUSHMAN STREET
MIDDLEBORO, MA 02346
(508) 967-0673

LAND SURVEYOR
SITE DESIGN ENGINEERING, LLC.
11 CUSHMAN STREET
MIDDLEBORO, MA 02346
(508) 967-0673



LOCUS MAP
SCALE: 1" = 800'

PLAN INDEX

TITLE	SHEET NO.
COVER SHEET	1
EXISTING CONDITIONS PLAN	2-3
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PLANNING
SEP 14 2015
DEPARTMENT

FILE COPY

APPROVAL OF
INDUSTRIAL LAND DEVELOPMENT
NEW BEDFORD PLANNING BOARD

DATE APPROVED: _____

DATE SIGNED: _____

FILE NO.: _____

SITE PLAN APPROVAL
MODIFICATION
2301 PURCHASE STREET
NEW BEDFORD, MASSACHUSETTS
PREPARED FOR
SID WAINER & SON, INC.

DRAWING TITLE:

COVER


SCALE: AS SHOWN

SHEET NO.

1 OF 14




CSI 23-15

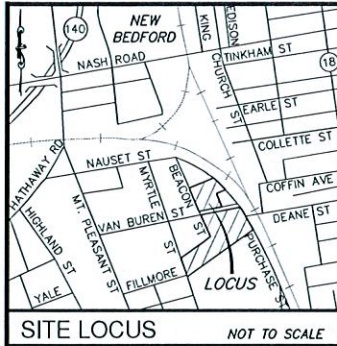

NOTES:

1. THE LOCUS PARCELS ARE SHOWN ON THE CITY OF NEW BEDFORD ASSESSORS MAP 97 AS LOTS 9, 151-153, 176 AND 180. THE CURRENT OWNER OF RECORD IS FRIENDS REALTY INC. AS DETERMINED FROM CERTIFICATES #11822 (LOTS 9 AND 180), #11824 (LOT 151), #11823 (LOT 152), #20476 (LOT 153) AND #20068 (LOT 176).
2. PROPERTY LINES ARE REFERENCED TO LAND COURT PLAN NO. 6644C, 6644F, 6644I AND PLAN RECORDED IN PLAN BOOK 156, PAGE 86 (LOT 11).
3. TOPOGRAPHIC INFORMATION HAS BEEN COMPILED FROM AN ACTUAL ON THE GROUND SURVEY PERFORMED BY CULLINAN ENGINEERING CO., INC. ON APRIL 12-14, 2005 AND SUPPLEMENTED BY SITE DESIGN ENGINEERING, LLC ON APRIL 15, 2014, MAY 12, 2014 AND JUNE 26, 2014.
4. ELEVATIONS ARE REFERENCED TO AN ASSUMED DATUM.
5. THE SITE IS NOT LOCATED WITHIN ANY SPECIAL FLOOD HAZARD AREAS AS DETERMINED FROM THE CITY OF NEW BEDFORD FLOOD INSURANCE RATE MAP, COMMUNITY PANEL NUMBER 255216 0391 F (EFFECTIVE DATE JULY 7, 2009).
6. EXISTING UTILITY LINES SHOWN ON THIS DRAWING ARE FROM AVAILABLE INFORMATION AND ARE APPROXIMATE LOCATIONS. THERE MAY BE EXISTING LINES OTHER THAN THOSE INDICATED. SITE DESIGN ENGINEERING, LLC ASSUMES NO RESPONSIBILITY FOR DAMAGES INCURRED AS A RESULT OF UTILITIES OMITTED OR INACURATELY SHOWN. BEFORE PLANNING FUTURE CONNECTIONS, THE PROPER PUBLIC UTILITY ENGINEERING DEPARTMENT SHOULD BE CONSULTED.
7. WETLAND RESOURCE AREAS SHOWN HEREON WHERE DELINEATED AND LOCATED BY SITE DESIGN ENGINEERING, LLC IN JUNE, 2014.

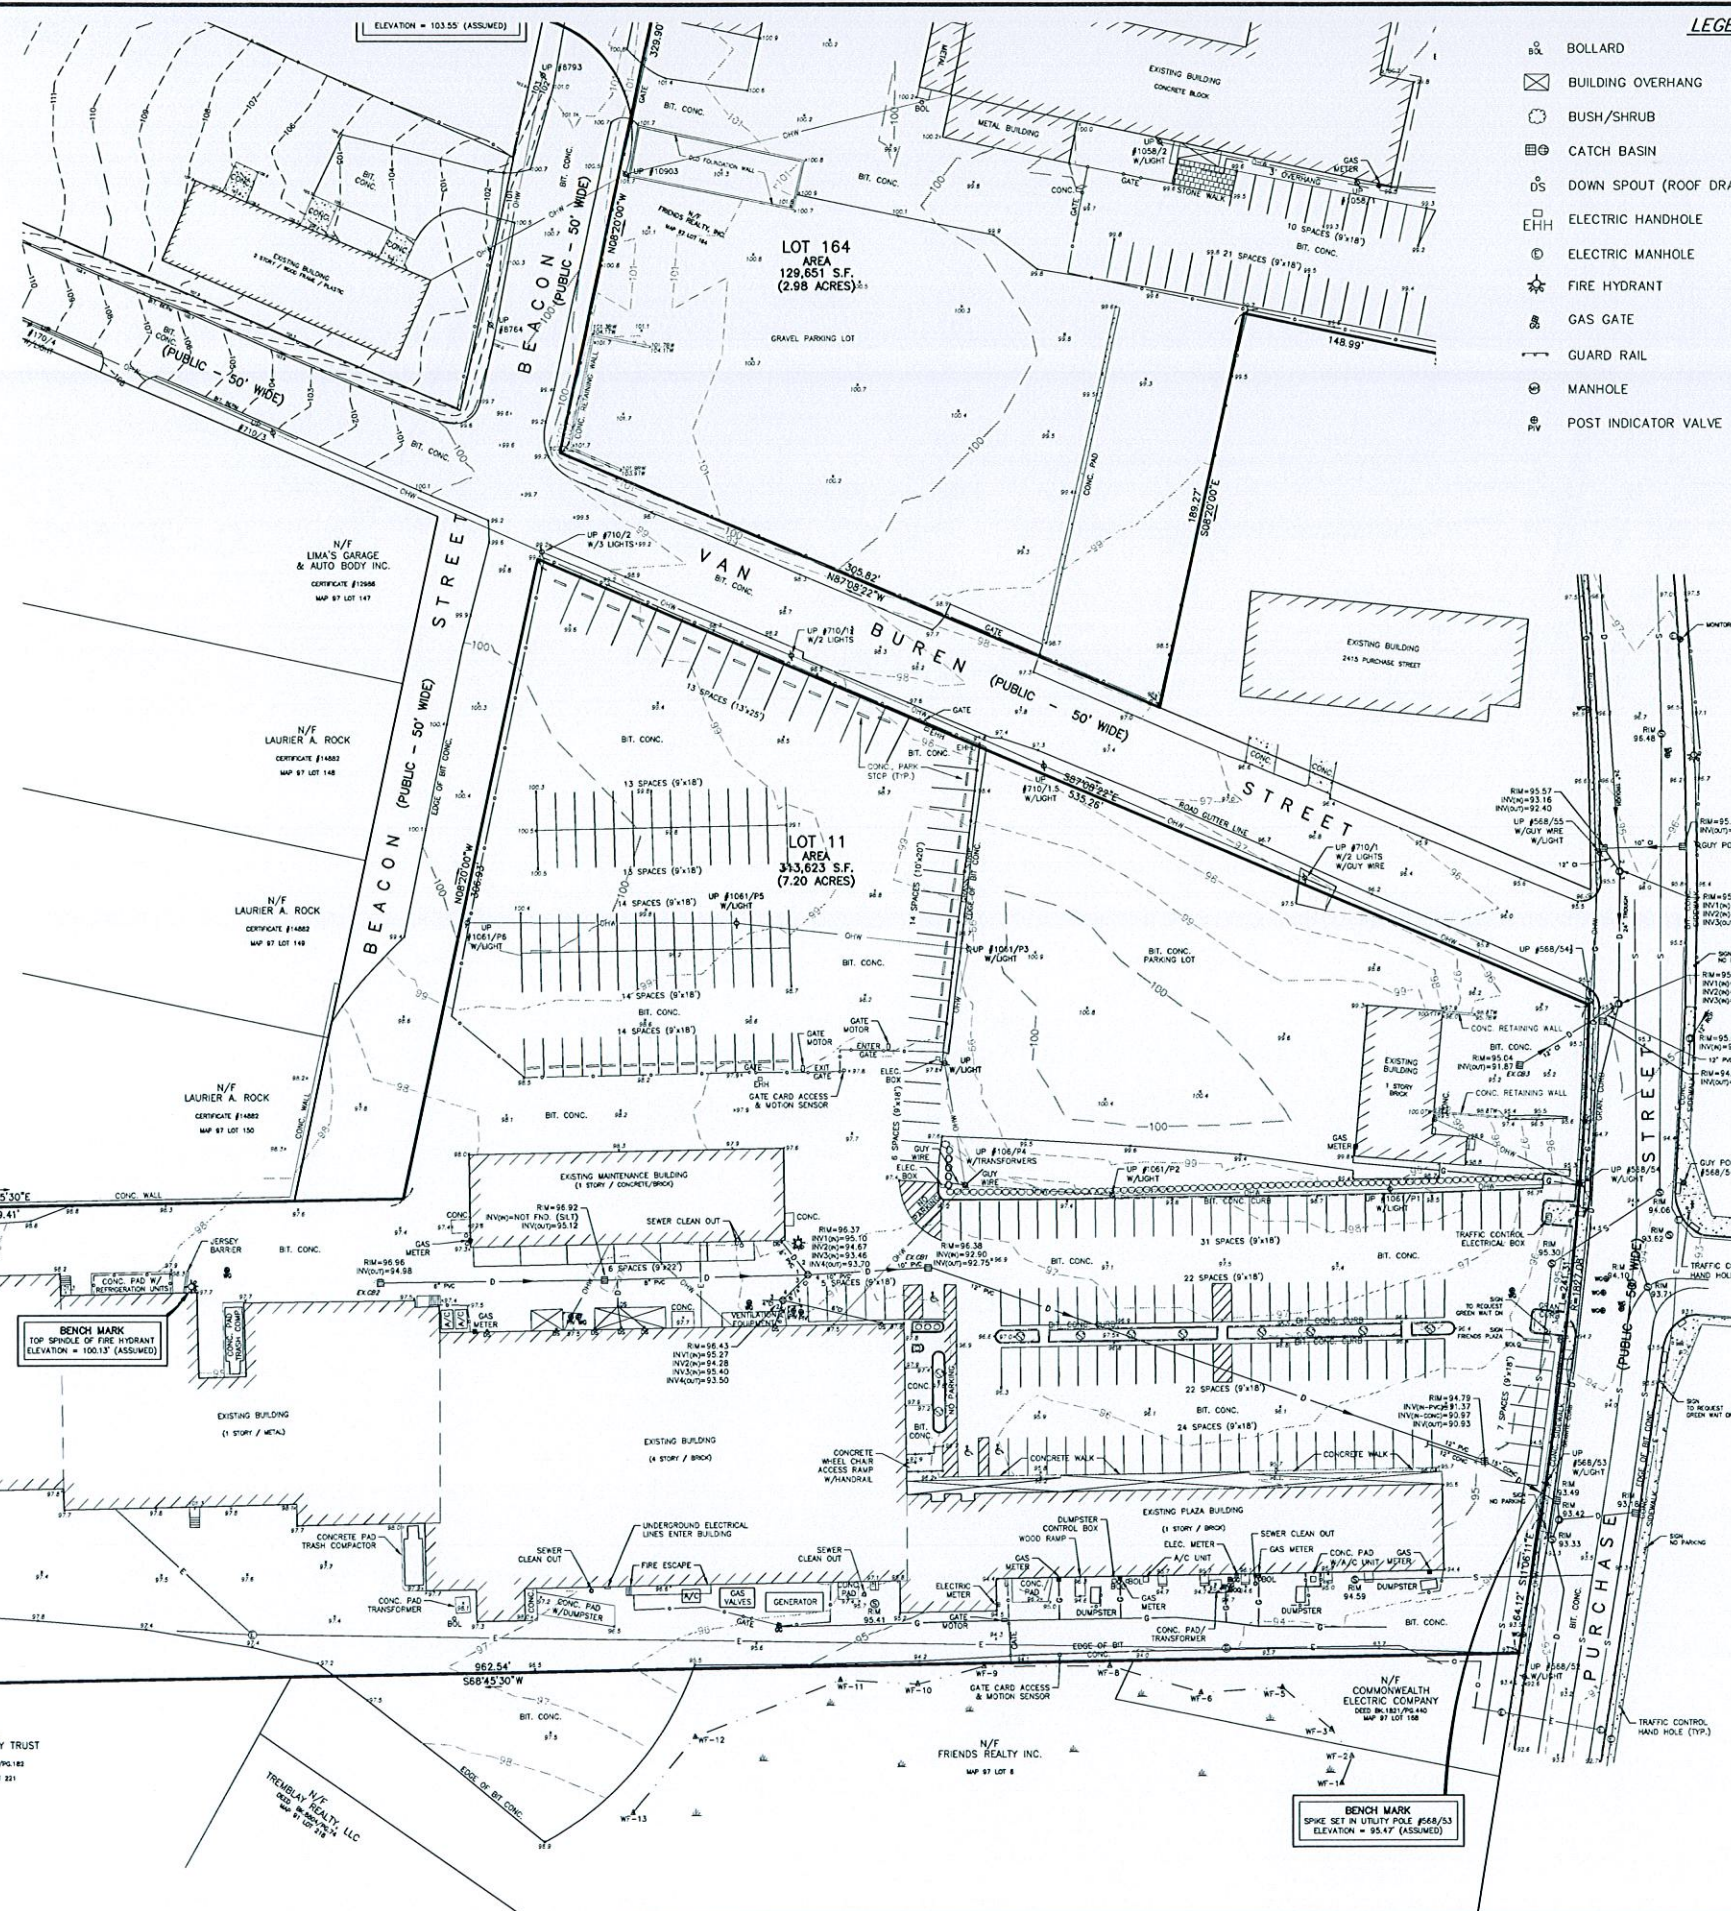

LEGEND


⊗	BOLLARD	⊙	SEWER MANHOLE
⊠	BUILDING OVERHANG	⊙	SPOT ELEVATION
⊖	BUSH/SHRUB	⊙	TRAFFIC SIGNAL
⊕	CATCH BASIN	⊙	TREE (2"/3" DIA.)
⊙	DOWN SPOUT (ROOF DRAIN)	⊙	UTILITY POLE
⊕	ELECTRIC HANDHOLE	⊙	WATER GATE
⊙	ELECTRIC MANHOLE	⊙	WATER MANHOLE
⊙	FIRE HYDRANT	⊙	WETLANDS
⊙	GAS GATE	⊙	WETLAND FLAG
⊙	GUARD RAIL	—○—○—	CHAIN LINK FENCE
⊙	MANHOLE	—○—	OVERHEAD WIRES
⊙	POST INDICATOR VALVE	—○—	UNDERGROUND DRAIN
		—○—	UNDERGROUND ELECTRIC
		—○—	UNDERGROUND GAS
		—○—	UNDERGROUND SEWER

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PLAN REVISIONS

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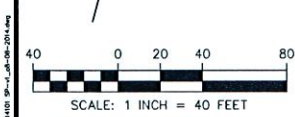
DATE: SEPTEMBER 11, 2015
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SITE PLAN APPROVAL MODIFICATION
 2301 PURCHASE STREET
 NEW BEDFORD, MASSACHUSETTS
 PREPARED FOR: SID WAINER & SON, INC.

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 PLANNING
 SEP 14 2015
 DEPARTMENT

DRAWING TITLE: EXISTING CONDITIONS PLAN
 SCALE: 1" = 40'
 SHEET NO. 2 OF 14

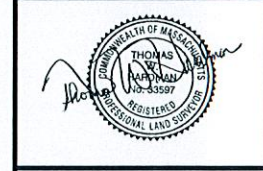


CASE 23-15

SOIL EROSION AND SEDIMENTATION CONTROL NOTES

- PRIOR TO INITIATING CONSTRUCTION, ALL SEDIMENTATION AND EROSION CONTROL MEASURES SHALL BE INSTALLED AS SHOWN ON THE PLANS, AS DIRECTED BY THE ENGINEER AND/OR AS NECESSITATED BY FIELD CONDITIONS. THE CONTRACTOR SHALL MAINTAIN THESE MEASURES UNTIL ALL WORK IS COMPLETED AND ALL AREAS HAVE BEEN STABILIZED.
- INSTALLATION SEQUENCE:
 - INSTALL SILT FENCE AND HAYBALES AS SHOWN ON PLAN.
 - CLEAR AND GRUB SITE.
 - CONSTRUCT SITE INFRASTRUCTURE AS SHOWN ON PLANS.
 - THE FOLLOWING ACTIVITIES SHALL TAKE PLACE IMMEDIATELY FOLLOWING CONSTRUCTION OF EMBANKMENTS AND FILL SLOPES: PLACEMENT OF LOAM AND GRASS SEED, INSTALLATION OF GEOWEB SLOPE STABILIZATION.
 - THE CONTRACTOR SHALL INSPECT ALL FILL SLOPES AND EMBANKMENTS ON A WEEKLY BASIS AND FOLLOWING ALL RAINFALL EVENTS UNTIL A MINIMUM 75% GRASS COVER IS ESTABLISHED SUFFICIENT TO PREVENT EROSION FROM OCCURRING.
- ACCUMULATED SEDIMENT SHALL BE REMOVED AND DISPOSED OF BY THE CONTRACTOR OR AS DIRECTED BY THE ENGINEER.
- AFTER THE INSTALLATION OF DRAINAGE STRUCTURES, HAYBALES OR OTHER APPROVED MATERIALS SHALL BE PLACED TO PROTECT THE INTEGRITY OF THE STRUCTURES.
- DISTURBED AREAS SHALL BE STABILIZED WITH THE APPLICATION OF A MINIMUM OF FOUR INCHES (4") OF LOAM AND SHALL BE SEEDING WITH AN APPROVED GRASS MIX OR SHALL BE RIPRAPPED AS SOON AS POSSIBLE AFTER THE FINISHED GRADE HAS BEEN MET. IF FINAL GRADING DOES NOT OCCUR DURING THE GROWING SEASON, THESE AREAS SHALL BE MULCHED WITH HAY AND SECURED BY JUTE NETTING WITH STAPLES. SLOPES EXCEEDING 2:1 SHALL BE LOAMED AND STABILIZED WITH PEGGED SOO OR APPROVED EROSION CONTROL BLANKETS UNLESS OTHERWISE NOTED.
- THE MOUTHS OF ALL CATCH BASINS SHALL BE FITTED WITH FILTER FABRIC DURING THE ENTIRE CONSTRUCTION PROCESS TO RETARD SILTATION.
- WHERE APPLICABLE, PROPER DUST CONTROL MEASURES SHALL APPLY TO REDUCE THE SURFACE AND AIR TRANSPORT OF DUST GENERATED DURING CONSTRUCTION. THE FOLLOWING METHODS SHALL BE USED:
 - WET SUPPRESSION WITHOUT WETTING AGENT SHALL BE APPLIED DURING LOAD IN / LOAD OUT AND EARTH MOVING CONSTRUCTION ACTIVITIES, SPECIALLY ON STOCKPILES.
 - INACTIVE STOCKPILES SHALL BE STABILIZED THROUGH APPLICATION OF SOIL STABILIZERS OR SEEDING.
 - WIND SCREENS OR BARRIERS AND PLASTIC TARP COVERS SHALL BE SECURED TO PREVENT WIND DISLODGE AND DAMAGE. ANY DAMAGES SHALL BE REPAIRED OR REPLACED IMMEDIATELY.
- CONTRACTOR SHALL CONSTRUCT A TEMPORARY CRUSHED STONE CONSTRUCTION ENTRANCE APPROXIMATELY 20' WIDE BY 50' LONG BY 6" DEEP FOR USE DURING CONSTRUCTION ACTIVITIES AS NECESSARY TO REMOVE SEDIMENT FROM VEHICLES. THE CONSTRUCTION ENTRANCE IS TO BE LOCATED AT THE ENTRANCE TO THE SITE FROM VAN BUREN STREET AND BEACON STREET.

LEGEND


	BOLLARD		SEWER MANHOLE
	BUILDING OVERHANG		SPOT ELEVATION
	BUSH/SHRUB		TRAFFIC SIGNAL
	CATCH BASIN		TREE (2"/3" DIA.)
	DOWN SPOUT (ROOF DRAIN)		UTILITY POLE
	ELECTRIC HANDHOLE		WATER GATE
	ELECTRIC MANHOLE		WATER MANHOLE
	FIRE HYDRANT		WETLANDS
	GAS GATE		WETLAND FLAG
	GUARD RAIL		CHAIN LINK FENCE
	MANHOLE		OVERHEAD WIRES
	POST INDICATOR VALVE		UNDERGROUND DRAIN
			UNDERGROUND ELECTRIC
			UNDERGROUND GAS
			UNDERGROUND SEWER

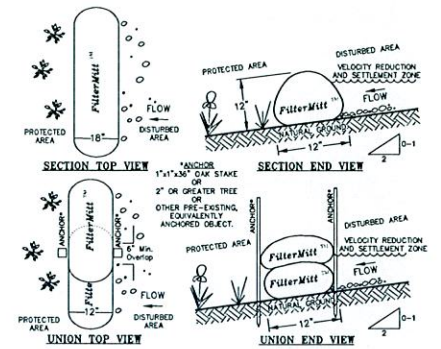


FilterMitt™ INSTALLATION:
 With the newest technology and equipment, sections can be constructed on site in lengths from 1' to 100'.
 Sections can also be delivered to the site in lengths from 1' to 6'.
 The flexibility of FilterMitt™ allows it to conform to any contour or terrain.
 Where section ends meet, there shall be an overlap of 6" or greater. Both sides shall be anchored (look stakes, trees, etc.) to stabilize the union.

FilterMitt™ COMPONENTS:
 OUTSIDE CASING: 100% organic hessian.
 FILLER INGREDIENT: FilterMitt Mulch™ - A blend of coarse and fine compost and shredded wood.
 Particle sizes: 100% passing a 3" screen; 90-100% passing a 1" screen; 70-100% passing a 0.75" screen; 30-75% passing a 0.25" screen.
 Weight: Approx. 850 lbs./cu.yd. (Ave. 25 lbs./1.1')


For more information visit:
www.groundscapecxpress.com
 or contact us at:
Groundscapes Express, Inc.
 P.O. Box 737
 Westford, MA 02093
 (508) 384-7140

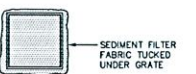

INLET SEDIMENTATION CONTROL DETAIL
 NOT TO SCALE


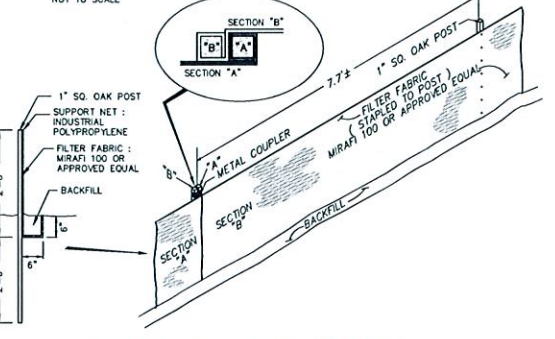


EROSION CONTROL FENCE DETAIL
 NOT TO SCALE

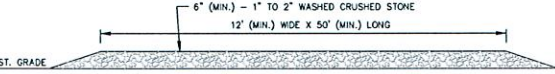

CONSTRUCTION ENTRANCE DETAIL
 NOT TO SCALE

NOTE:
 CONSTRUCTION ENTRANCE IS A TEMPORARY STONE - STABILIZED PAD LOCATED AT POINTS OF VEHICULAR INGRESS AND EGRESS ON THE CONSTRUCTION SITE TO AND FROM A PAVED PUBLIC ROAD OR OTHER PAVED AREAS.

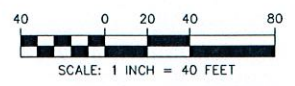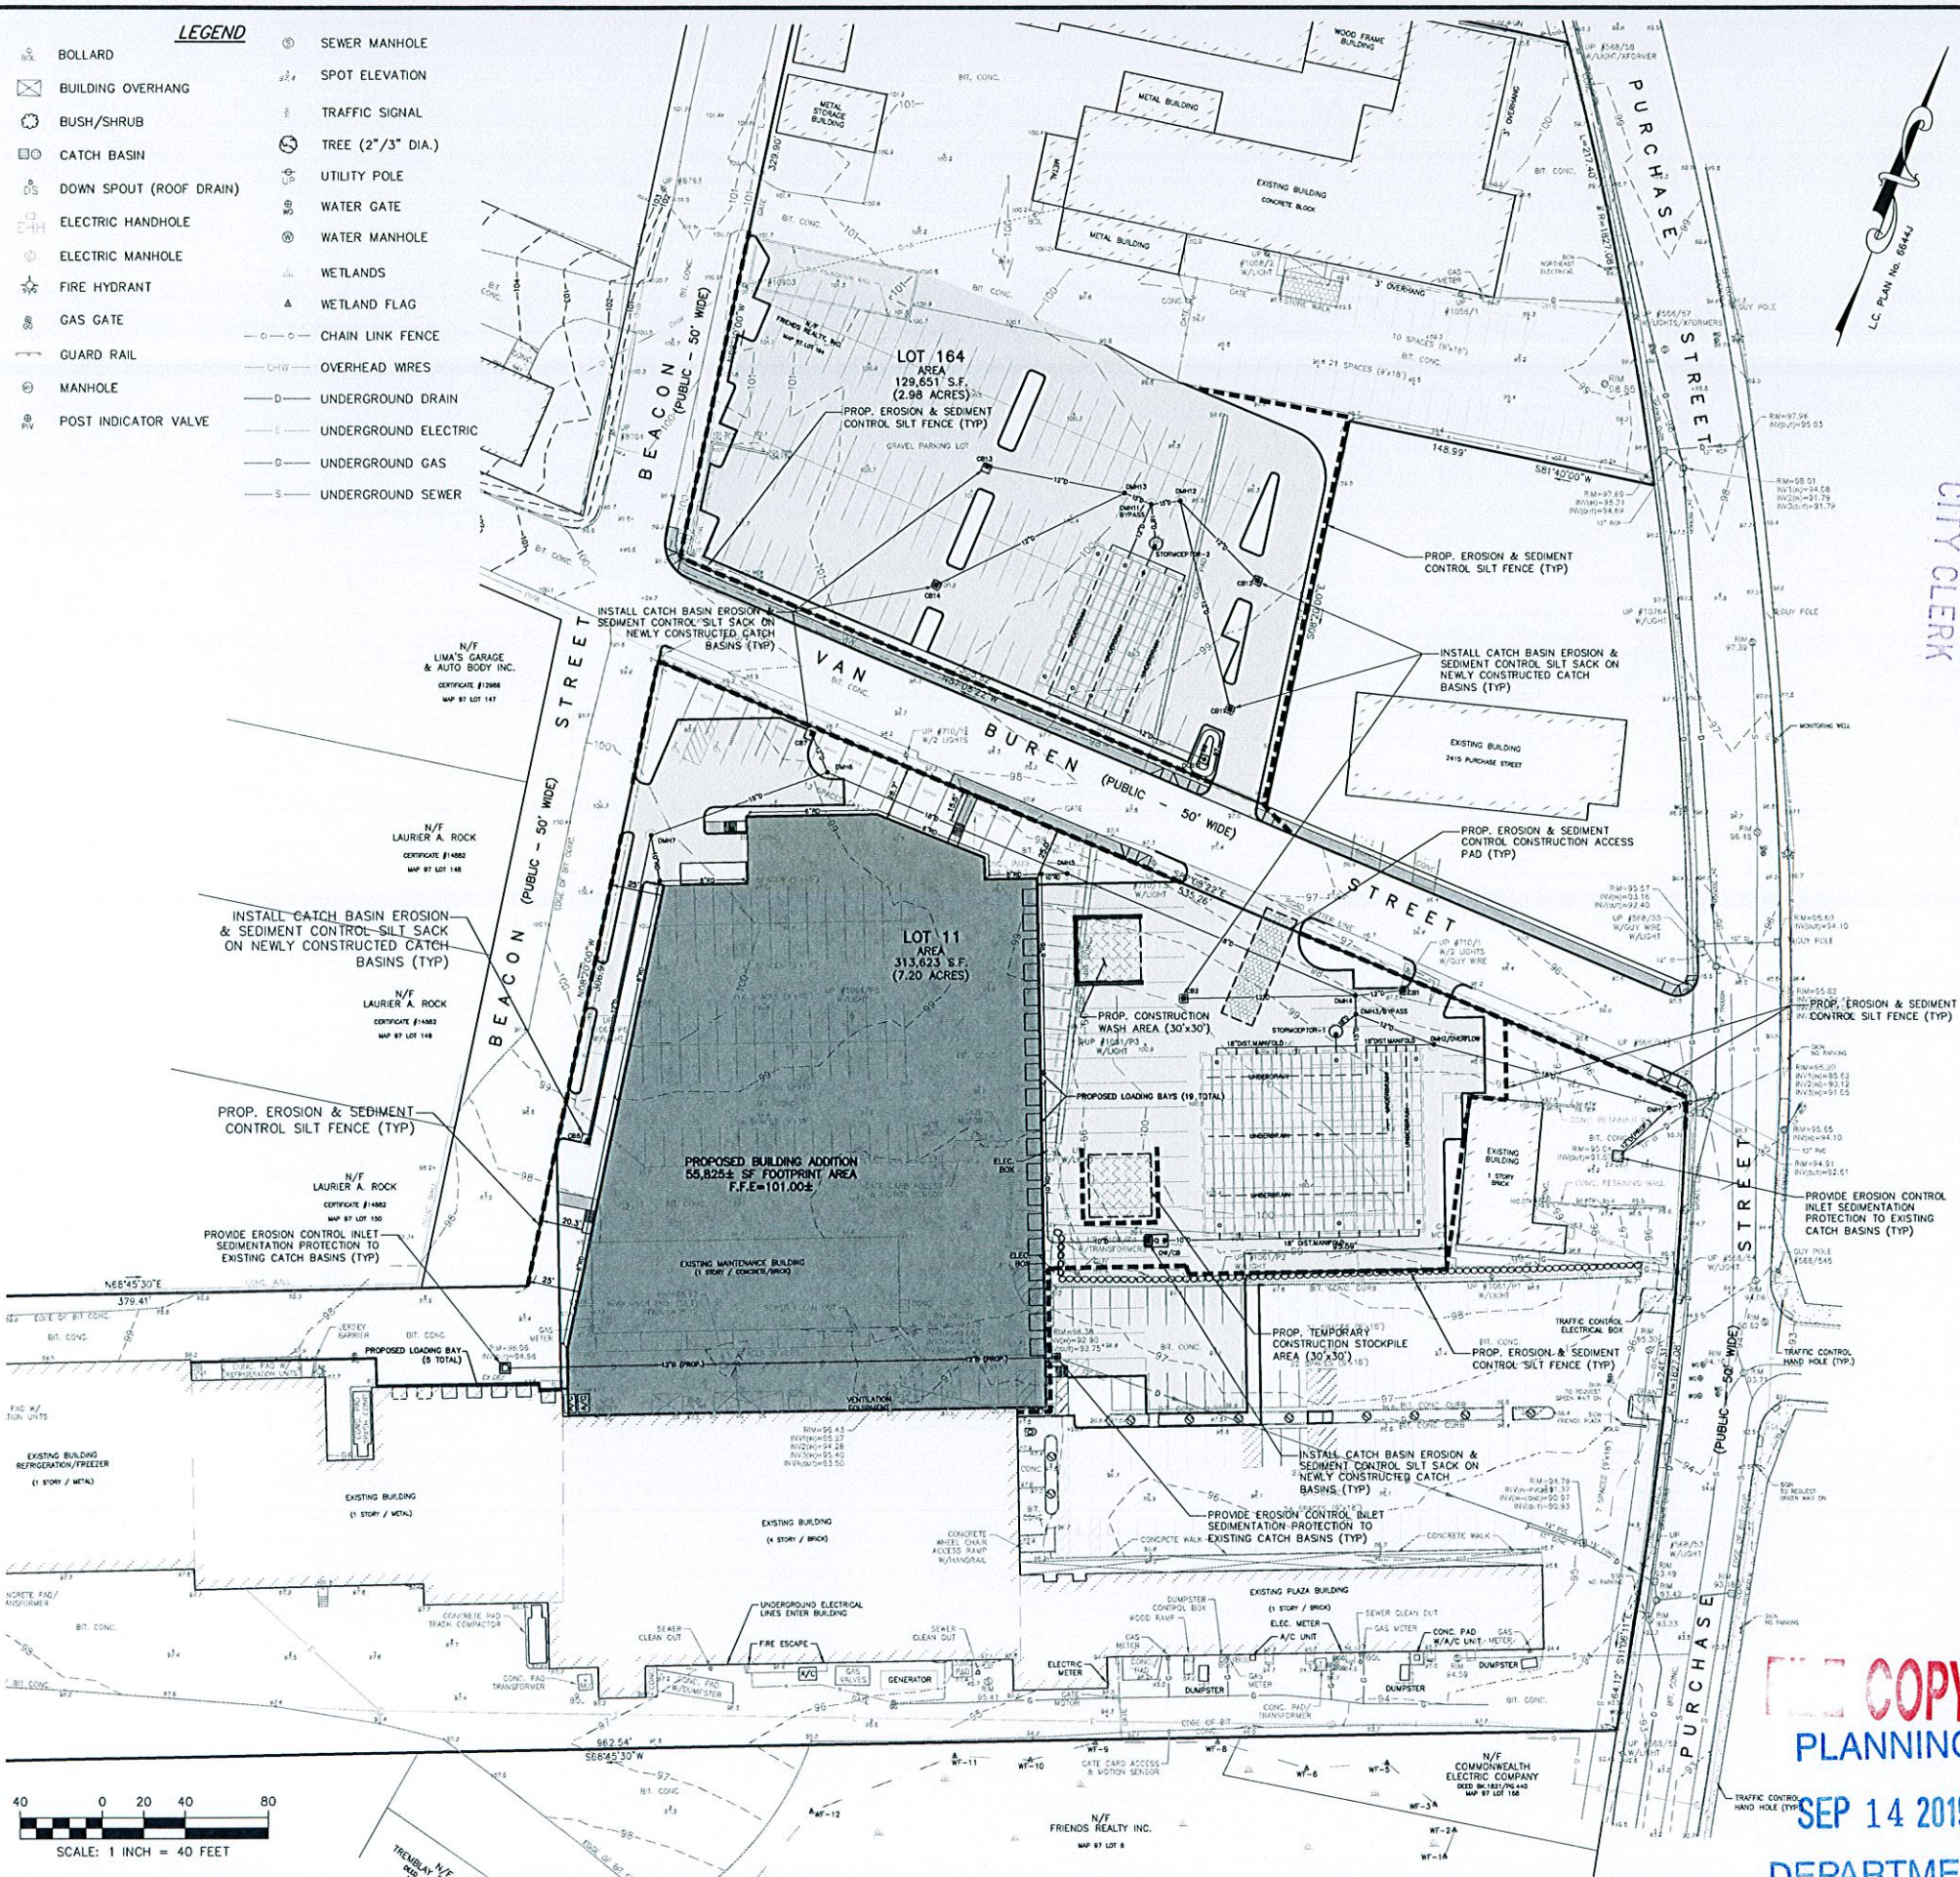

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 11 CUSHMAN STREET
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2015 SEP 14 P 3:30

CITY CLERK'S OFFICE
 NEW BEDFORD, MA

NO.	DATE	DESCRIPTION	APPROVED

PLAN REVISIONS

DATE: SEPTEMBER 11, 2015
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SITE PLAN APPROVAL
MODIFICATION
 2301 PURCHASE STREET
 NEW BEDFORD, MASSACHUSETTS

PREPARED FOR:
SID WAINER & SON, INC.

DRAWING TITLE:

EROSION CONTROL PLAN

SCALE: 1" = 40'



SHEET NO.

4 OF 14

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 SEP 14 2015
 DEPARTMENT

CASE 23-16

- LEGEND**
- BOLLARD
 - BUILDING OVERHANG
 - BUSH/SHRUB
 - CATCH BASIN
 - DOWN SPOUT (ROOF DRAIN)
 - ELECTRIC HANDHOLE
 - ELECTRIC MANHOLE
 - FIRE HYDRANT
 - GAS GATE
 - GUARD RAIL
 - MANHOLE
 - POST INDICATOR VALVE
 - SEWER MANHOLE
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**SITE PLAN APPROVAL
 MODIFICATION**
 2301 PURCHASE STREET
 NEW BEDFORD, MASSACHUSETTS

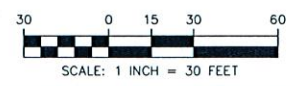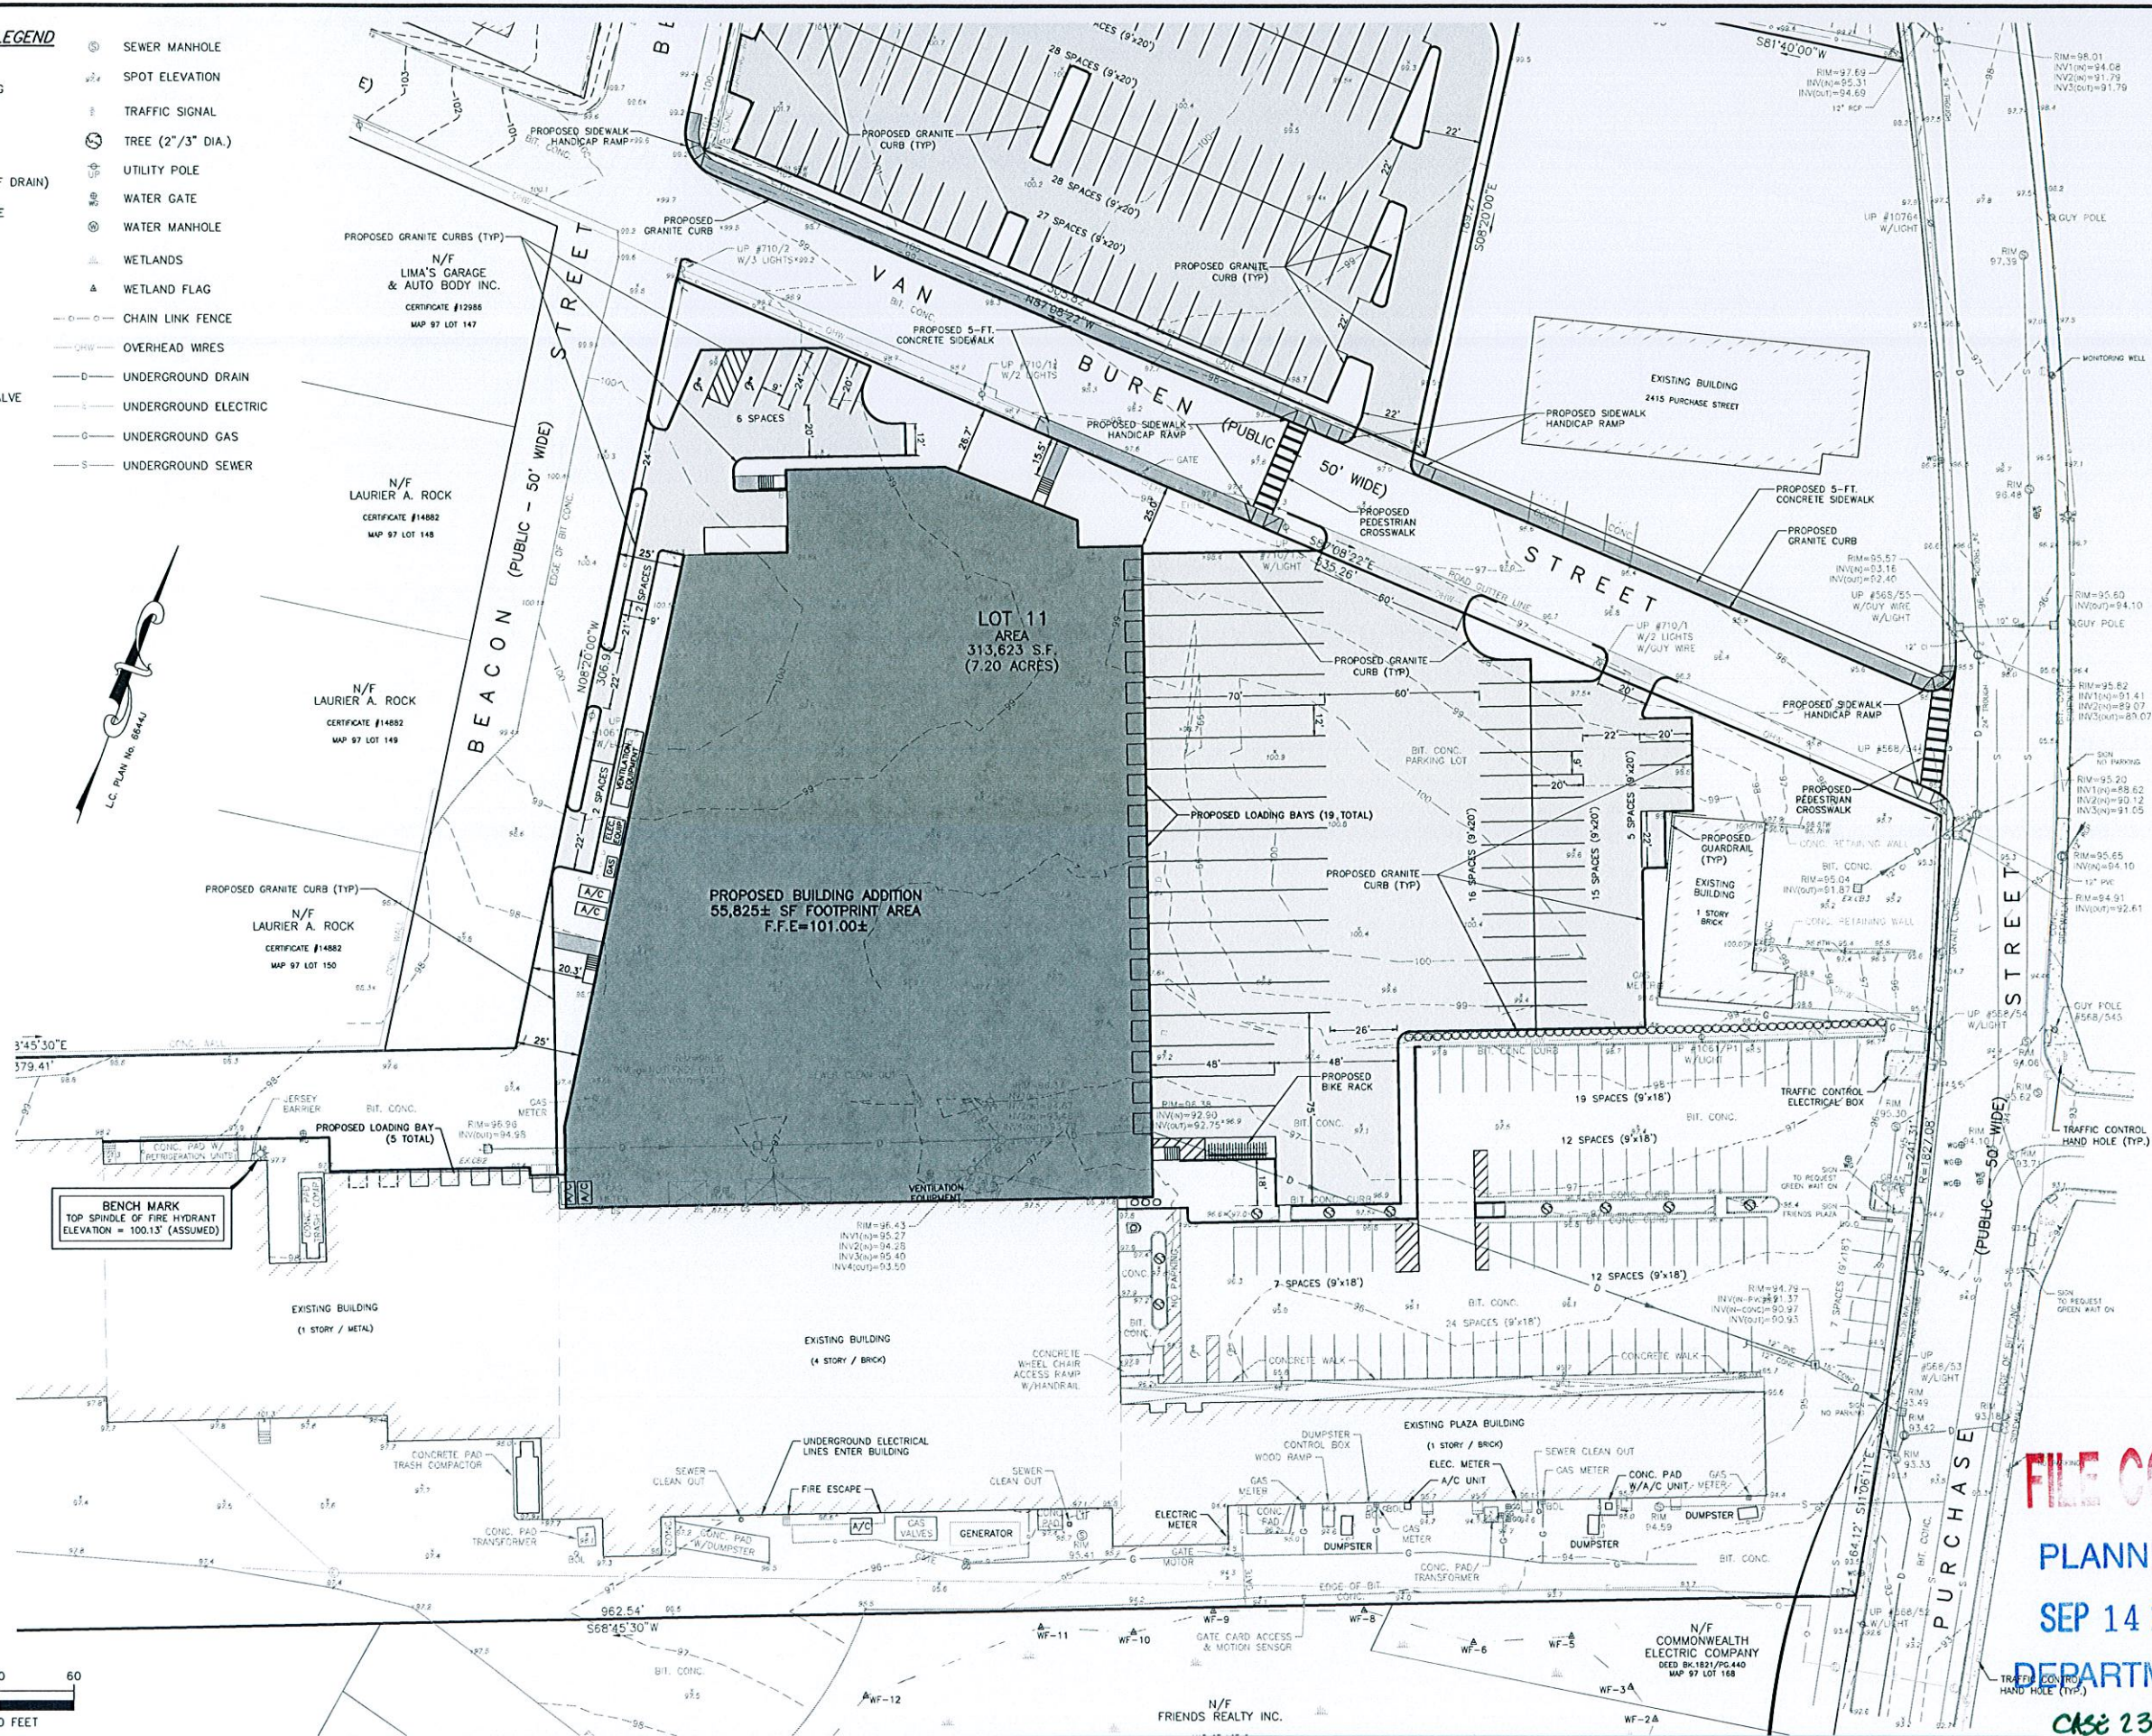DRAWING TITLE: **SITE LAYOUT PLAN**
 SCALE: 1" = 30'
 SHEET NO. **6 OF 14**

FILE COPY
PLANNING
SEP 14 2015
DEPARTMENT
CASE 23-15

PREPARED FOR
SID WAINER & SON, INC.

NO.	DATE	DESCRIPTION	APPROVED
1	2015 SEP 11 P 3:31	CITY CLERKS OFFICE NEW BEDFORD, MA	
PLAN REVISIONS			

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**SITE PLAN APPROVAL
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2301 PURCHASE STREET
NEW BEDFORD, MASSACHUSETTS



PREPARED FOR:
SID WAINER & SON, INC.

DRAWING TITLE:
**SITE LAYOUT
PLAN**

SCALE: 1" = 30'

SHEET NO.
7 OF 14

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PLANNING
SEP 14 2015
DEPARTMENT
CRS 23-15

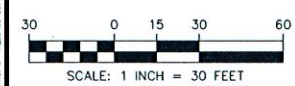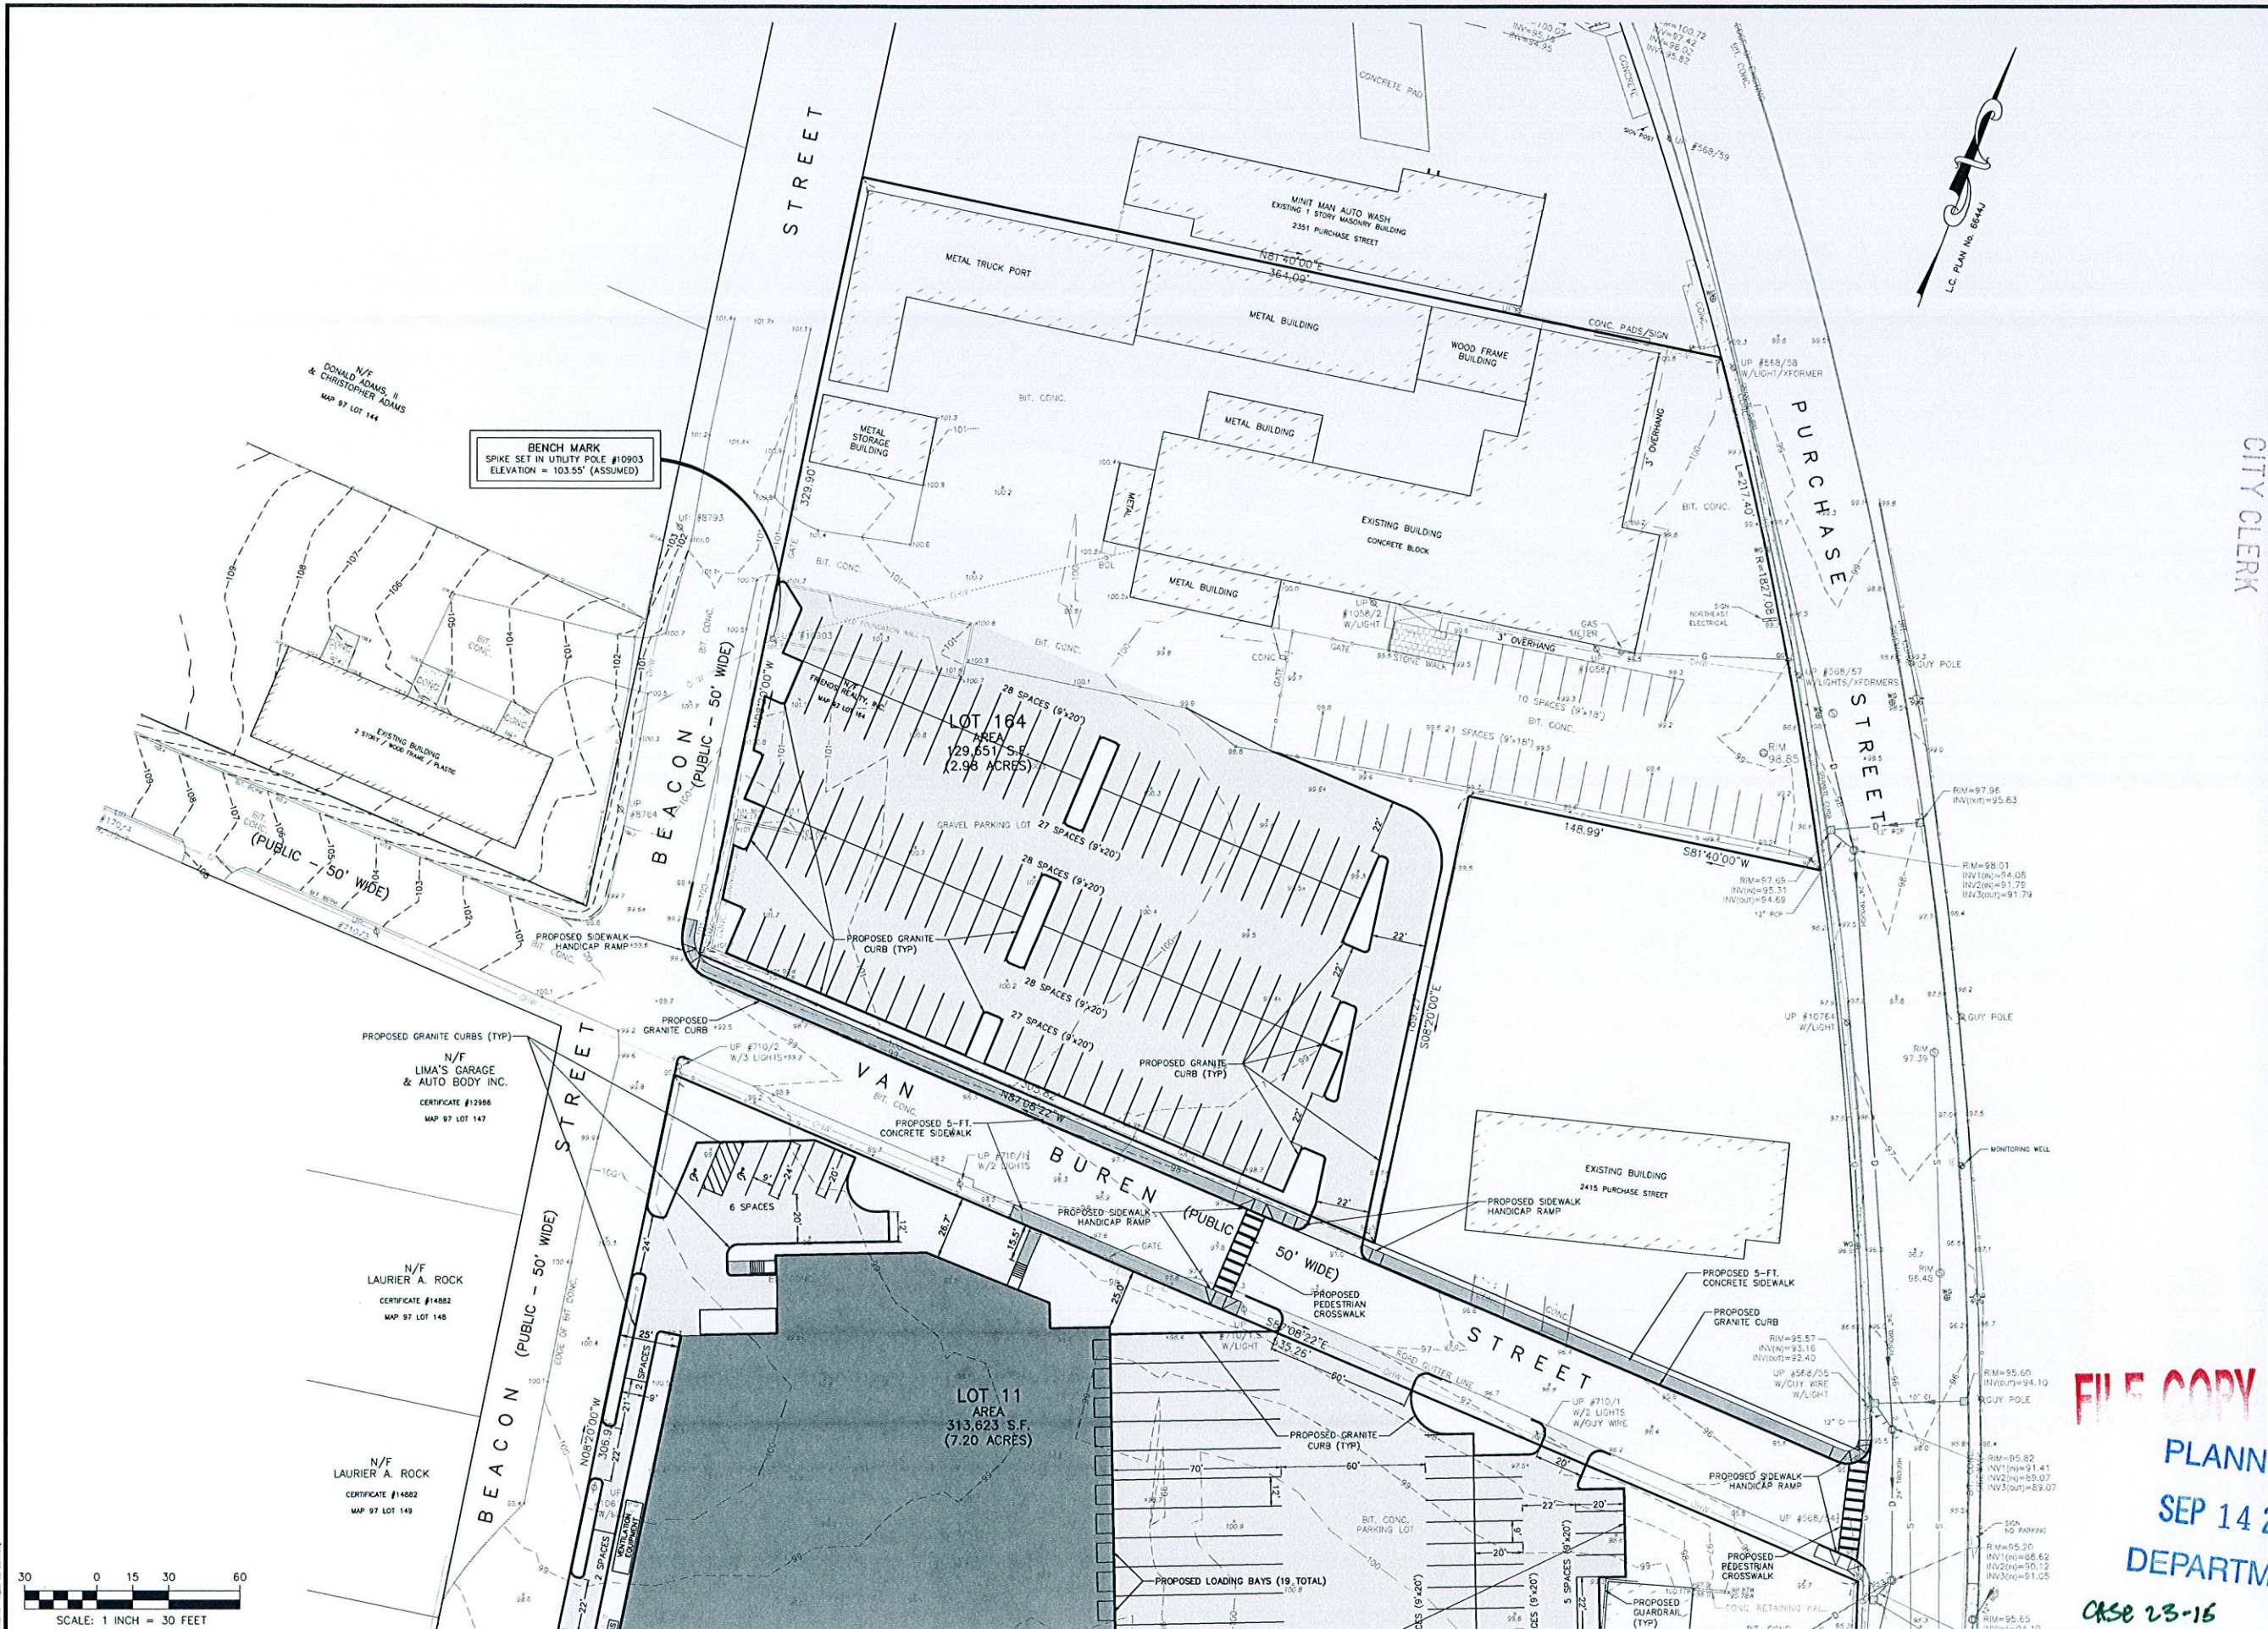


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**SITE PLAN APPROVAL
MODIFICATION**
2301 PURCHASE STREET
NEW BEDFORD, MASSACHUSETTS

PREPARED FOR
SID WAINER & SON, INC.

DRAWING TITLE: GRADING & DRAINAGE PLAN

SCALE: 1" = 30'

SHEET NO. 9 OF 14

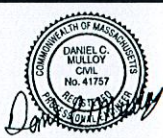FILE COPY

**PLANNING
SEP 14 2015
DEPARTMENT**

CASE 23-15



BENCH MARK
SPIKE SET IN UTILITY POLE #10933
ELEVATION = 103.55' (ASSUMED)

N/F
LIMA'S GARAGE
& AUTO BODY INC.
CERTIFICATE #12986
MAP 97 LOT 147
PROP. DMH6
RIM=100.10
12" INV. IN=94.80 (CB7)
15" INV. IN=94.30 (DMH7)
18" INV. OUT=94.05 (DMH5)

N/F
LAURIER A. ROCK
CERTIFICATE #14882
MAP 97 LOT 148
PROP. DMH7
RIM=100.25
(ROOF) 10" INV. IN=95.35
(DMH8) 15" INV. IN=95.10
(DMH6) 15" INV. OUT=95.00

N/F
LAURIER A. ROCK
CERTIFICATE #14882
MAP 97 LOT 149
PROP. DMH3/BYPASS
RIM=97.45
18" INV. IN=92.05 (DMH4)
18" INV. OUT=91.55 (STORMCEPTOR)
15" INV. OUT=92.30 (DIST. MANFOLD)
12" INV. OUT=92.30 (DMH2/OVERFLOW)

PROPOSED BUILDING ADDITION
55,825± SF FOOTPRINT AREA

