
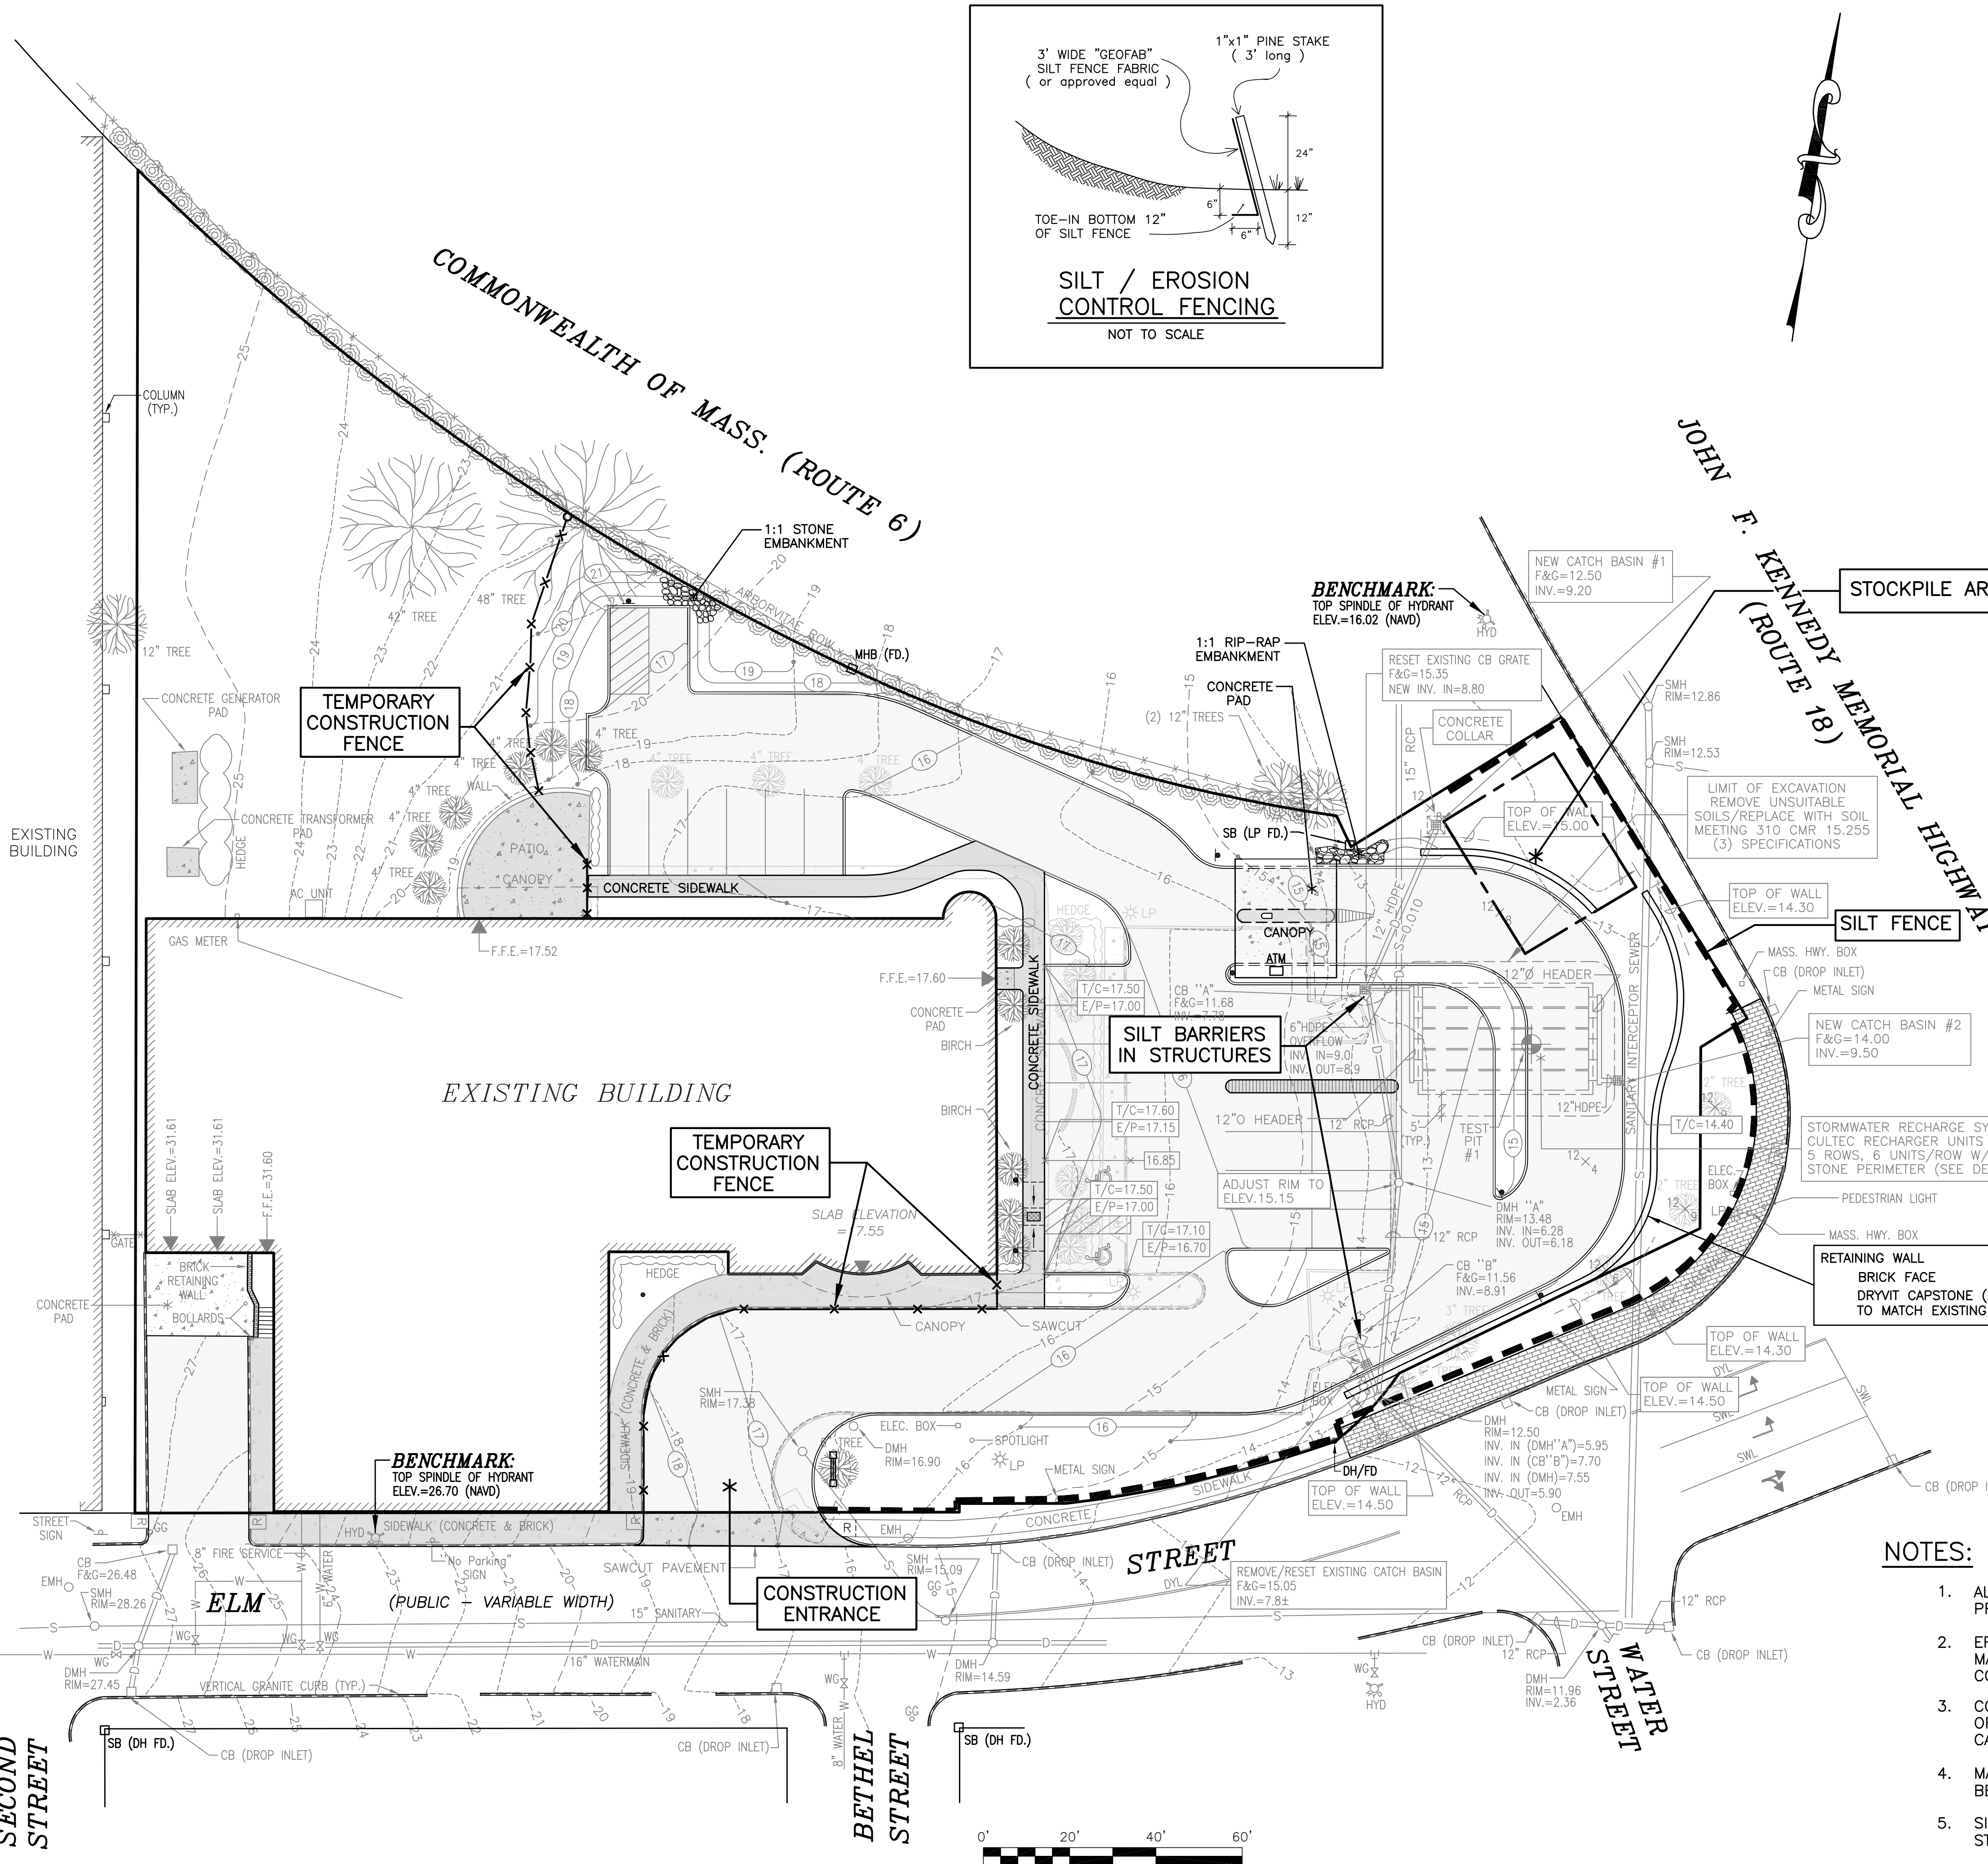


LOCUS MAP
SCALE: 1"=400'

LEGEND

	PROPERTY LINE
	EXISTING BUILDING ENTRANCE
	EXISTING DOUBLE YELLOW LINE
	EXISTING SOLID WHITE LINE
	EXISTING CONTOUR
	EXISTING CHAIN LINK FENCE
	EXISTING WATERMAIN
	EXISTING SEWER LINE
	EXISTING DRAINAGE LINE
	EXISTING CATCH BASIN
	EXISTING DRAIN MANHOLE
	EXISTING SEWER MANHOLE
	EXISTING ELECTRIC MANHOLE
	EXISTING TELEPHONE MANHOLE
	EXISTING FIRE HYDRANT
	EXISTING WATER GATE VALVE
	EXISTING GAS GATE VALVE
	EXISTING LIGHT POLE
	EXISTING UTILITY POLE
	EXISTING SPOT GRADE
	EXISTING TREE
	EXISTING SHRUB
	TEST PIT
	PROPOSED CONTOUR
	PROPOSED CATCH BASIN
	PROPOSED DRAINAGE LINE
	PROPOSED SPOT GRADE
	PROPOSED TOP OF CURB ELEVATION PROPOSED EDGE OF PAVEMENT ELEVATION

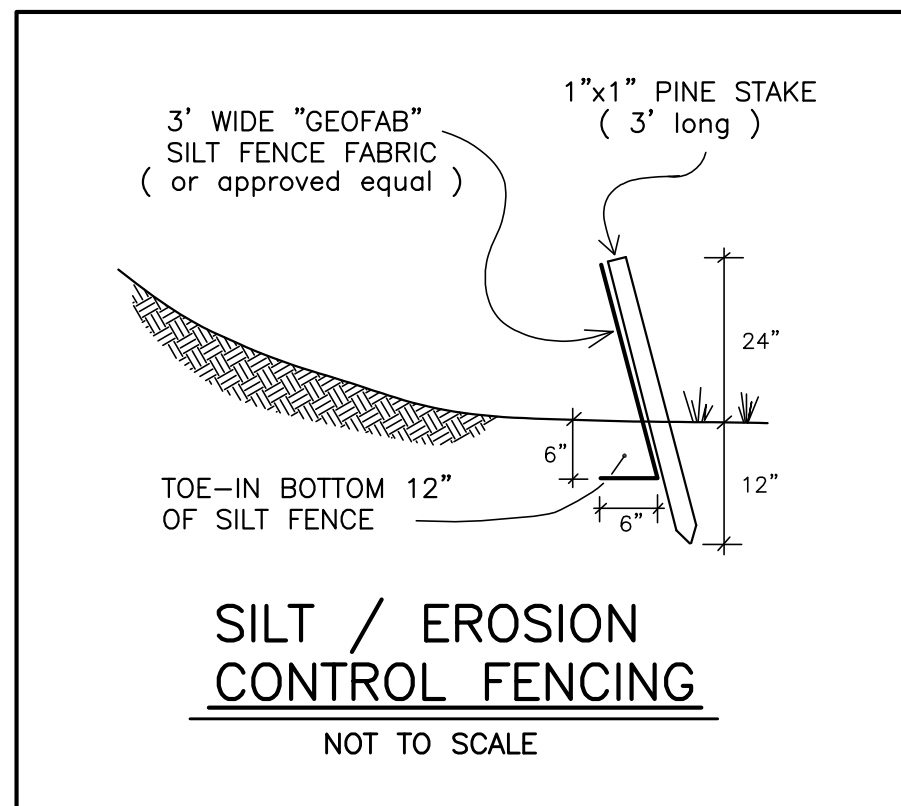

NOTES:

1. ALL BMP EROSION CONTROL MEASURES SHALL BE IN PLACE PRIOR TO DEMOLITION OR ANY SITE WORK.
2. EROSION CONTROL BMP'S SHALL CONFORM TO US EPA, NPDES, MA DEP AND MASSACHUSETTS'S EROSION AND SEDIMENTATION CONTROL GUIDELINES FOR URBAN AND SUBURBAN AREAS.
3. CONTRACTOR SHALL HAVE WATER AVAILABLE FOR DUST CONTROL OR, AS AN ALTERNATIVE, AN APPROVED DUST CONTROL AGENT CAN BE UTILIZED.
4. MATERIAL STOCKPILE SHALL BE AS NOTED. SAFETY FENCING SHALL BE USED AROUND STOCKPILES THAT EXCEED 10' IN HEIGHT.
5. SILT FENCE SHALL BE SET ON DOWNGRADIENT EDGE OF ANY STOCKPILE.

Project: 25 ELM STREET NEW BEDFORD, MASSACHUSETTS Client: BayCoast Bank Drawing Title: EROSION CONTROL PLAN	Scale: 1"=20' Date: FEBRUARY 19, 2015 Drawn: NAD Checked: SDG Approved: SDG Sheet 7 of 8 Drawing Number: ECP-1	Revision Description No. Date 	SITEC, Inc. 449 Francis Corner Road Dartmouth, MA 02747 (508) 998-2125 FAX (508) 998-7554 WWW.SITEC-ENGINEERING.COM Civil and Environmental Engineering Land Use Planning
Acad No. NB 14-5855 EROSION CONTROL.DWG File No. 14-4855			