
# TRUE STORAGE NEW BEDFORD


969 SHAWMUT AVENUE NEW BEDFORD, MA

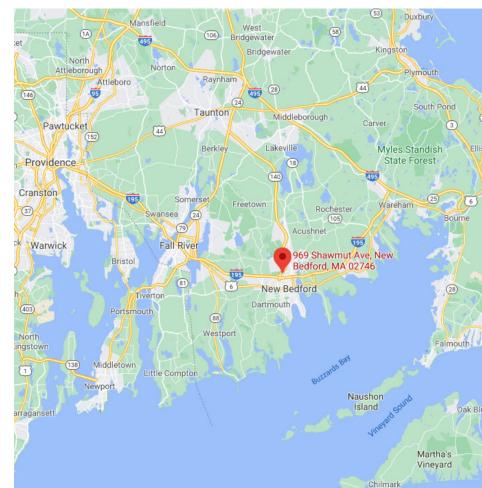

## SITE LOCUS



# **AERIAL MAP**

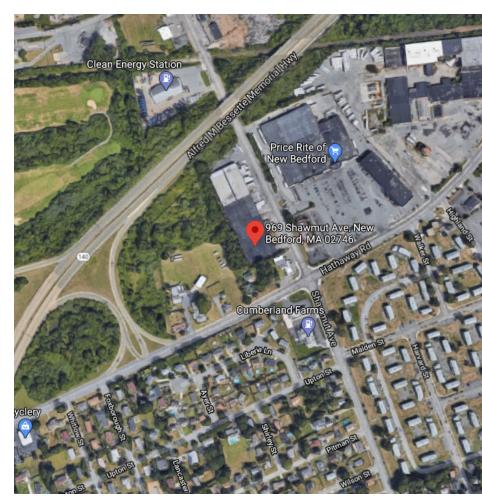

## GENERAL NOTES

- ALL CONTRACTORS AND SUBCONTRACTORS SHALL PERFOR
  THE WORK IN ACCORDANCE WITH THE DOCUMENTS OF
  SERVICE
- 2. THE CONTRACTOR OR SUBCONTRACTOR SHALL VERIFY ALL MEASUREMENTS AND CONDITIONS SHOWN ON THE DRAWINGS PRIOR TO COMMENCING WORK AND SHALL NOTIFY THE ARCHITECT OF ANY DISCREPANCIES
- 3. THE DOCUMENTS OF SERVICE CONSIST OF ALL THESE DRAWINGS ATTACHED HERE OF; WHICH ALSO INCLUDES FINISH, PLUMBING, ELECTRICAL, EQUIPMENT, CABINET, AND MECHANICAL SCHEDULES; PROJECT MANUAL, SPECIFICATIONS, INSTALLATION INSTRUCTIONS AND CUT SHEETS.
- 4. CONTRACTOR AND/OR SUBCONTRACTOR SHALL BUILD EXACTLY WHAT IS SHOWN ON DRAWINGS. ANY DEPARTURES OR SUBSTITUTIONS FROM WHAT IS INDICATED ON THE DRAWINGS SHALL BE PRESENTED TO THE ARCHITECT FOR REVIEW AND WRITTEN APPROVAL PRIOR TO CONSTRUCTION. ANY UNAUTHORIZED CHANGES TO THE APPROVED DRAWINGS SHALL BE REMOVED AND REPLACED AT THE CONTRACTOR'S EXPENSE
- THE CONTRACTOR AND SUBCONTRACTOR IS RESPONSIBLE FOR ALL MEANS AND METHODS OF TEMPORARY SHORING, BRACING, OR OTHERWISE PROTECTING ANY PORTION OF THE STRUCTURE, SITE, AND UTILITIES FROM DAMAGE DURING CONSTRUCTION.
- ALL WORK AND PROCEDURES SHALL COMPLY WITH APPLICABLE AND CURRENT CODES, REGULATIONS, ORDINANCES, AND REQUIREMENTS OF AUTHORITIES HAVING JURISDICTION, INCLUDING ACCESSIBILITY GUIDELINES WHERE APPLICABLE. CONFIRM SAME WITH LOCAL BUILDING INSPECTOR
- 7. ALL DIMENSIONS ON THE FLOOR PLANS, REFLECTED CEILING PLANS, EXTERIOR ELEVATIONS, AND INTERIOR ELEVATIONS ARE TO FINISH UNLESS NOTED OTHERWISE; DIMENSIONS ON THE SECTIONS AND DETAILS VARY AND MAY BE TO STRUCTURE, STUD, COMPONENT, OR FINISH
- 8. ALL CONTRACTORS AND SUBCONTRACTORS ARE REQUIRED TO EXAMINE THE DRAWINGS AND SPECIFICATIONS CAREFULLY, VISIT THE SITE AND FULLY INFORM THEMSELVES AS TO ALL CONDITIONS AND LIMITATIONS, PRIOR TO AGREEING TO PERFORM WORK. FAILURE TO VISIT THE SITE AND CONDITIONS AND LIMITATIONS, PRIOR TO AGREEING TO PERFORM WORK. FAILURE TO VISIT THE SITE AND AND FAMILIARIZE THEMSELVES WITH THE EXISTING CONDITIONS SHALL NOT PREVENT THE CONTRACTOR FROM FURNISHING ANY MATERIALS OR PERFORMING ANY WORK IN ACCORDANCE WITH DRAWINGS AND SPECIFICATIONS WITHOUT ADDITIONAL COST TO THE OWNER.
- DESIGN/BUILD. ALL LAYOUTS, PLANS, AND SPECIFICATIONS SHALL BE PREPARED AND STAMPED BY A LICENSED MECHANICAL ENGINEER AND PROVIDED BY DESIGN/BUILD CONTRACTOR. ALL PLANS AND SPECIFICATIONS SHALL BE SUBMITTED TO ARCHITECT FOR WRITTEN APPROVAL, PRIOR TO ANY CONSTRUCTION. THE ARCHITECT WILL REVIEW FOR CONFORMANCE WITH DESIGN AND COORDINATION OF DOCUMENTS OF SERVICE. DESIGN/BUILD CONTRACTOR AND MECHANICAL ENGINEER ARE RESPONSIBLE FOR COMPLIANCE WITH ALL APPLICABLE CODES.

10. ELECTRICAL WORK SHALL BE PERFORMED DESIGN/BUILD. ALL LAYOUTS, PLANS, AND SPECIFICATIONS SHALL BE PREPARED AND STAMPED BY A LICENSED ELECTRICAL ENGINEER AND PROVIDED BY DESIGN/BUILD CONTRACTOR. DRAWINGS/SCOPE TO INCLUDE ALL OUTLETS, CABLES, LIGHTING, FIRE ALARM SYSTEMS, AND ANY OTHER ELECTRICAL REQUIREMENTS, AS REQUIRED BY CODE. ALL PLANS AND SPECIFICATIONS SHALL BE SUBMITTED TO ARCHITECT FOR WRITTEN APPROVAL, PRIOR TO ANY CONSTRUCTION. THE ARCHITECT WILL REVIEW FOR CONFORMANCE WITH DESIGN AND COORDINATION OF DOCUMENTS OF SERVICE. DESIGN/BUILD CONTRACTOR AND ELECTRICAL ENGINEER ARE RESPONSIBLE FOR COMPLIANCE WITH ALL APPLICABLE CODES. FIRE PROTECTION/SPRINKLER WORK SHALL BE PERFORMED DESIGN/BUILD. ALL LAYOUTS, PLANS, AND SPECIFICATIONS SHALL BE PREPARED AND STAMPED BY A LICENSED FIRE PROTECTION ENGINEER AND PROVIDED BY DESIGN/BUILD CONTRACTOR. ALL PLANS AND SPECIFICATIONS SHALL BE SUBMITTED TO ARCHITECT FOR WRITTEN APPROVAL, PRIOR TO ANY CONSTRUCTION. THE ARCHITECT WILL REVIEW FOR CONFORMANCE WITH DESIGN AND COORDINATION OF DOCUMENTS OF SERVICE. DESIGN/BUILD CONTRACTOR AND FIRE PROTECTION ENGINEER ARE RESPONSIBLE FOR COMPLIANCE WITH ALL APPLICABLE CODES. . SPRINKLER SYSTEM TO BE DESIGN BUILD BY LICENSED

## OWNER/DEVELOPER

TRUE STORAGE NEW BEDFORD

670 N. COMMERCIAL ST. MANCHESTER, NH 03101

603.622.6223 **ARCHITECT** 

## TRUE STORAGE NEW BEDFORD

670 N. COMMERCIAL ST.

MANCHESTER, NH 03101 603.622.6223

## STRUCTURAL ENGINEER

**DM BERG CONSULTANTS, P.C.**THOMAS G HEGER, PE, LEED AP, PRESIDENT

100 CRESCENT ROAD, SUITE 1A NEEDHAM, MA 02494-1457

## CONSTRUCTION

## <u>MANAGER</u>

781.444.5156

603.622.6223

CONTRACTOR CONSTRUCTION. LLC. 670 N. COMMERCIAL ST. MANCHESTER, NH 03101

	DRAWING LIST			
Sheet Number	Sheet Name	Sheet Issue Date	Drawing Revision Number	Revision Issue Date
- Turriber	Sheet Name	Dute	- Trainibei	13546 546
GENERAL				
A0-0A	COVER SHEET	12/20/20		
A0-0B	ABBREVIATIONS & SYMBOLS	12/20/20		
A0-0C	CODE PLAN	12/20/20		
A0-0D	ACCESSIBILITY STANDARDS	12/20/20		
ARCHITE	CTURAL			
A0-01	LEVEL 01 ARCHITECTURAL DEMOLITION FLOOR PLAN	12/20/20		
A0-02	OVERALL EXTERIOR DEMOLITION ELEVATIONS	12/20/20		
A1-1	LEVEL 01 OVERALL FLOOR PLAN & LEVEL 02 OVERALL ROOF PLAN	12/20/20		
A1-1A	LEVEL 01A CONSTRUCTION PLAN - QUADRANT A	12/20/20		
A1-1B	LEVEL 01 CONSTRUCTION PLAN - QUADRANT B	12/20/20		
A1-1C	LEVEL 01C CONSTRUCTION PLAN - QUADRANT C	12/20/20		
A1-2	ENLARGED ADDITION FOUNDATION PLANS	12/20/20		
A2-1	LEVEL 01 OVERALL REFLECTED CEILING PLAN	02/12/21		
A2-11	STANDARD LIGHTING CUT SHEETS FOR DESIGN-BUILD	02/12/21		
A3-1	OVERALL EXTERIOR ELEVATIONS	12/20/20		
A4-2	WALL SECTIONS	12/20/20		
A4-3	WALL SECTIONS	12/20/20		
A4-5	SHELL & CORE SECTIONS & DETAILS	12/20/20		
A4-6	SHELL & CORE SECTIONS & DETAILS	12/20/20		
A4-7	SHELL & CORE SECTIONS & DETAILS	12/20/20		



670 N. COMMERCIAL ST. MANCHESTER, NH 03101
P: 603.622.6223
F: 603.622.7342
WWW.TRUESTORAGE.COM



369 SHAWMUT AN NEW BEDFORD, N

THESE DRAWINGS ARE IN DESIGN
DEVELOPMENT. THEY ARE
PROGRESS DRAWINGS. THEY ARE
NOT INTENDED TO BE
CONSTRUCTION DOCUMENTS AND
SHOULD NOT BE USED FOR

CONSTRUCTION.

	DAT					
	Z CIFOLOGO CONTRACTOR					
	o Z					

OVER SHEET

SHEET ISSUE DATE:

1 2/20/20

PROJECT NO.:


XX.XXXXXXX


APPROVED BY:

CL



Scale:

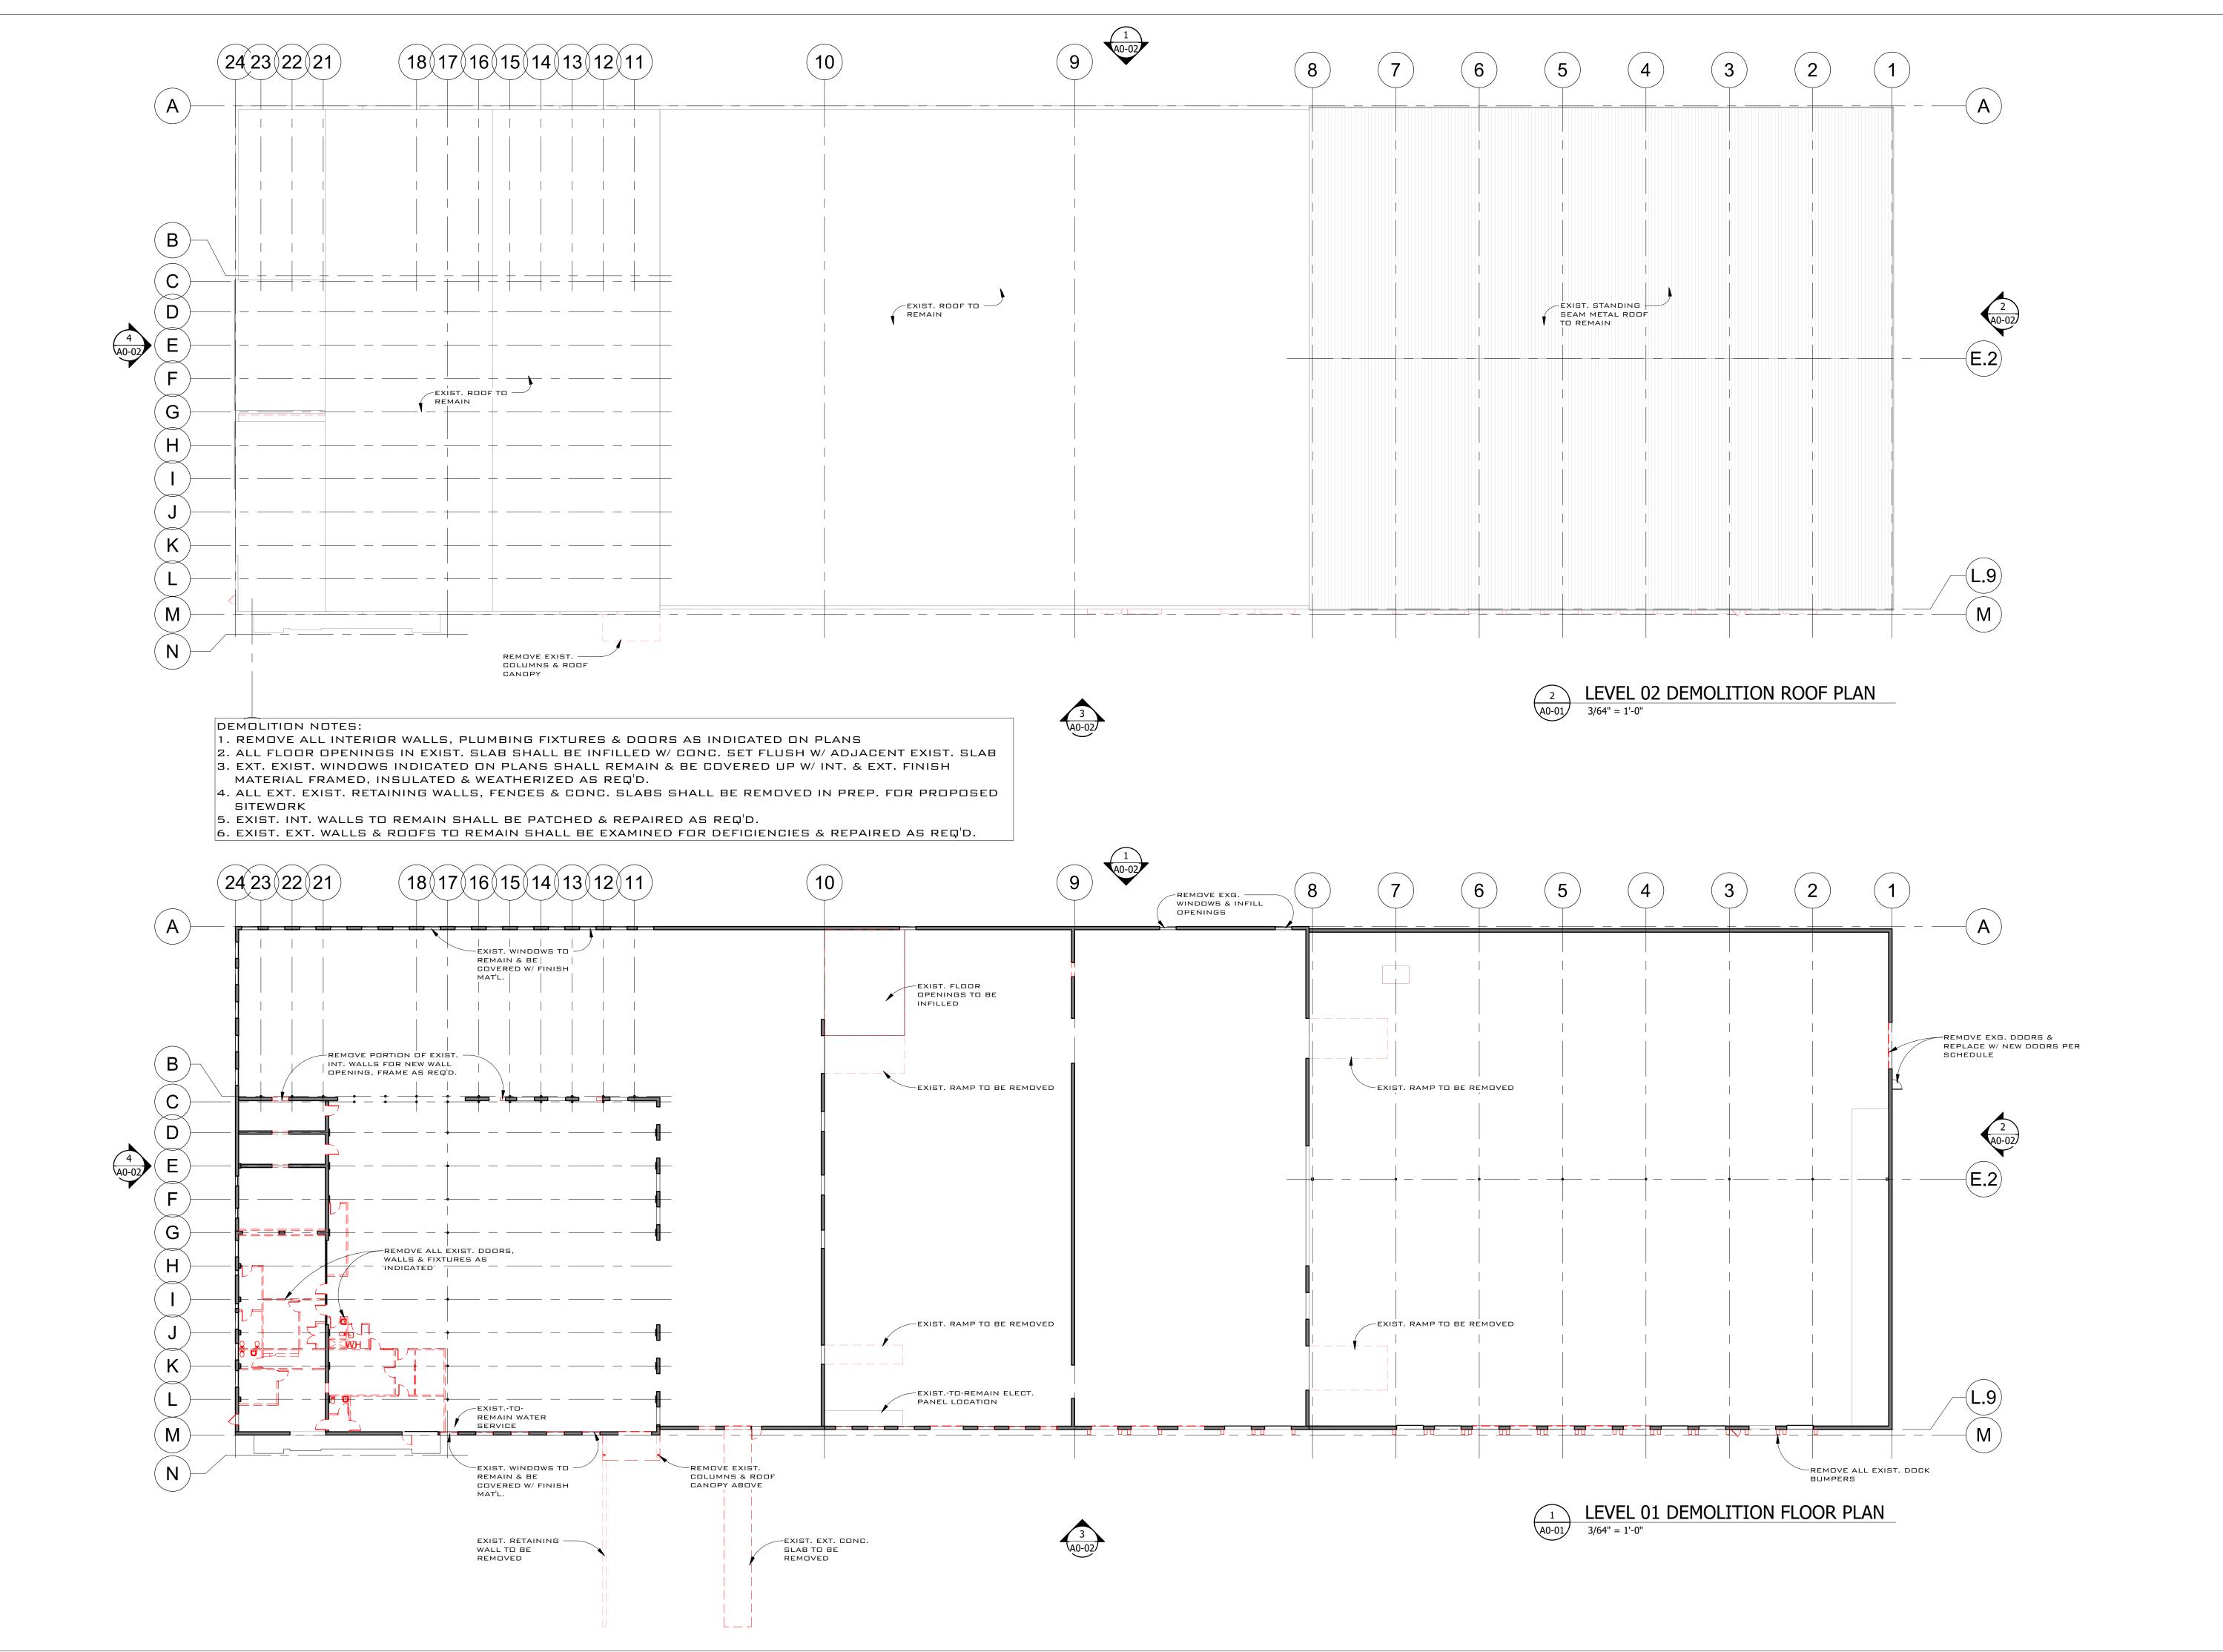

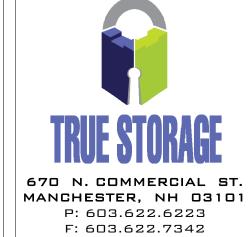



WWW.TRUESTORAGE.COM

ш > X

TRUE STORAGE 969 SHAWMUT AV NEW BEDFORD, M

NO. DESCRIPTION DATE

LEVEL 01 ARCHITECTURAL DEMOLITION FLOOR PLAN

SHEET ISSUE DATE:

1 2/20/20

PROJECT NO.:

XX.XXXXXXX

APPROVED BY:


CL

DRAWN BY:

DC

AO-01

3/64" = 1'-0"

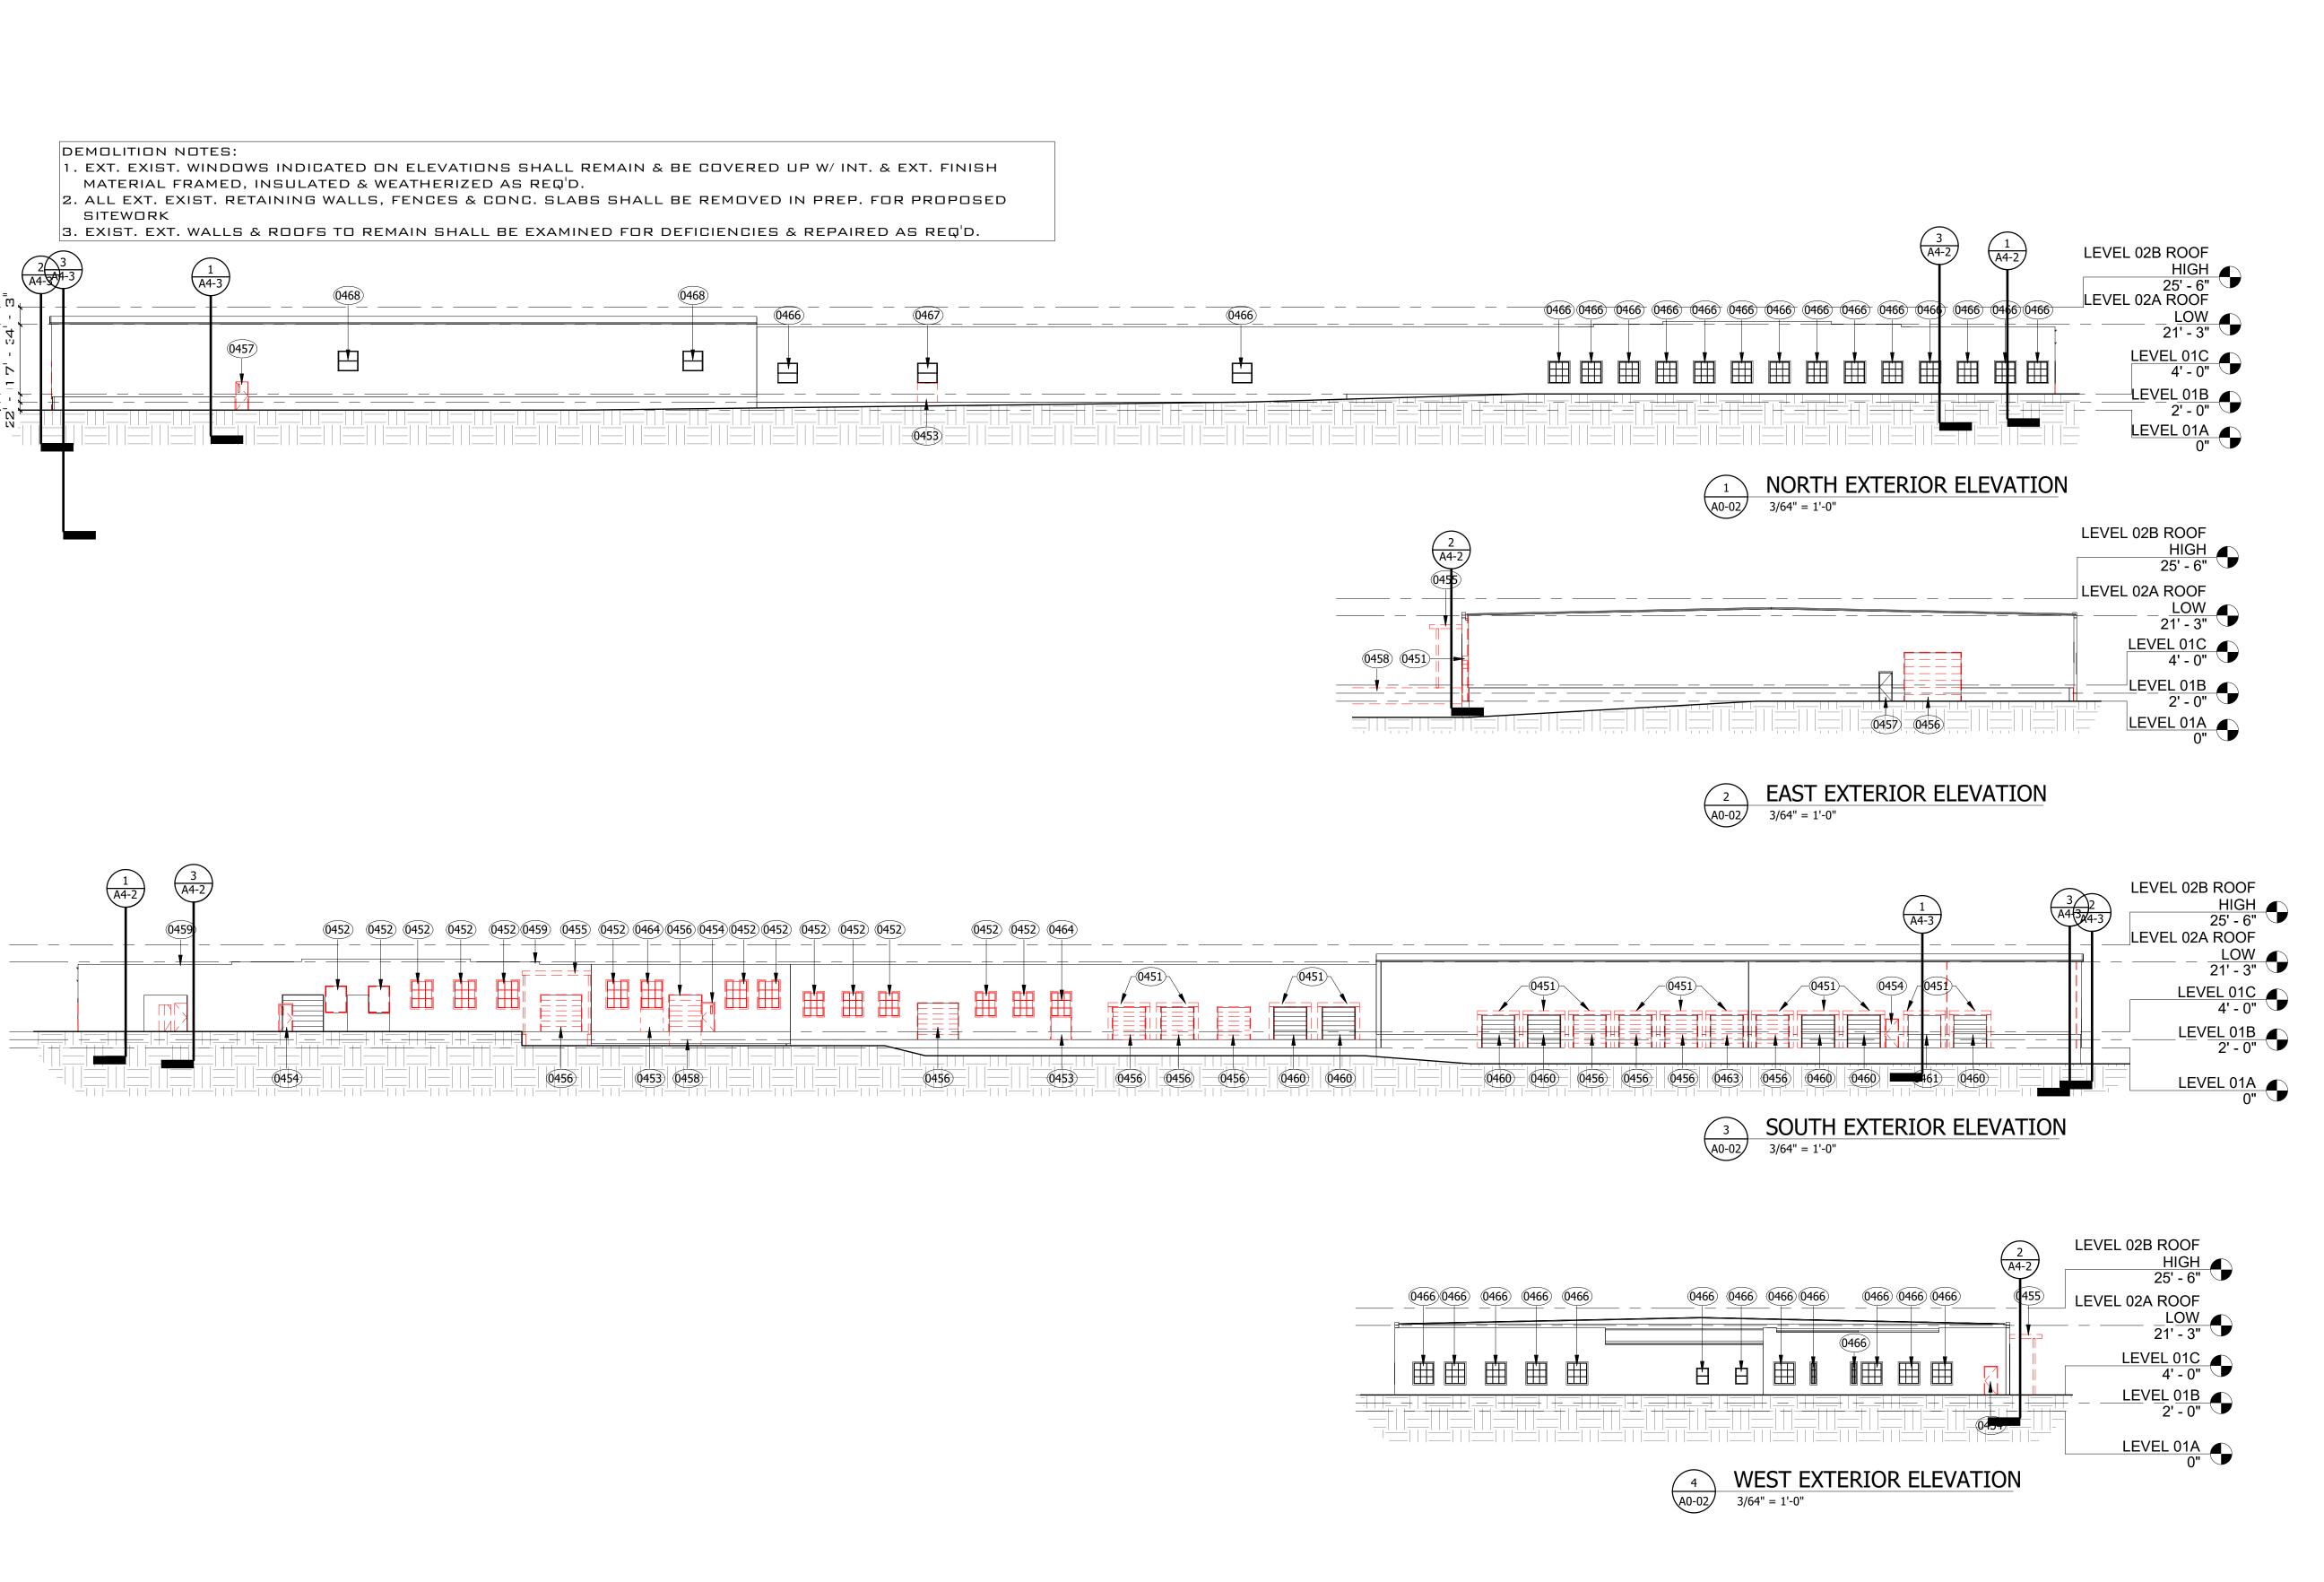

## DEMOLITION EXTERIOR ELEVATION

## <u>KEYNOTES</u>

04 NEW OVERHEAD DOOR IN EXG. OPENING

0451 REMOVE OVERHEAD DOOR BUMBER0452 REMOVE EXTER. WINDOWS& INFILL W/ NEW EIFS OVERLAY

0453 REMOVE PORTION OF BRICK & CMU MASONRY WALL BELOW WINDOW TO ALLOW FOR CONST. OF NEW EXTER. ALUM. FRAME/DOOR

PANEL/HDWR UNIT

0454 REMOVE EXTER. FRAME/DOOR PANEL/HDWR UNIT & PREP. FOR WEATHER-RESIST. INFILL CONST.

FOOTINGS TO PREVENT INTERFERENCE WITH NEW CONST.

56 REMOVE OVERHEAD DOOR & PREP FOR CONST. OF NEW AUTOMAT.

REMOVE OVERHEAD CANOPY & SUPPORTING STRUCT., REMOVE PIERS &

0456 REMOVE OVERHEAD DOOR & PREP FOR CONST. OF NEW AUTOMATIC
OVERHEAD DOOR

OVERHEAD DOOR
REMOVE EXTER. FRAME/DOOR PANEL/HDWR UNIT; PREP FOR CONST. OF

NEW FRAME/DOOR PANEL/HDWR UNIT REMOVE EXIST. EXTER. CONC. LOADING DOCK PAD

REMOVE EXIST. EXTER. CONC. LOADING DOCK PAD

PREP EXIST. STEPPED WALL FOR EIFS INFILL TO LEVEL OFF PARAPET

0460 EXG. OVERHEAD DOOR TO REMAIN, PREP OPENING FOR EIFS OVERLAY
0461 REMOVE EXG. OVERHEAD DOOR & RAILS & ASSOCIATED OPERATOR

0463 REMOVE OVERHEAD DOOR RAILS & OPERATOR, PREP TO RECEIVE NEW ALUM. FULL-GLASS SLIDING DOOR UNIT

REMOVE EXT. WINDOW & PREP TOP PORTION TO RECEIVE NEW WEATHER RESISTANT INFILL CONST. & EIFS OVERLAY

REMOVE EXT. WINDOW & PREP EXG. MASONRY OPENING TO RECEIVE NEW MASONRY INFILL

0467 REMOVE EXT. WINDOW & PREP TO RECEIVE NEW DOOR
0468 REMOVE EXT. WINDOW & PREP OPENING TO BE INFILLED W/ MTL.

SIDING OVER THERMAL INSULATION SUBSTRATE



670 N. COMMERCIAL ST.

MANCHESTER, NH 03101


P: 603.622.6223

F: 603.622.7342

WWW.TRUESTORAGE.COM



969 SHAWMUT AVE. NEW BEDFORD, MA

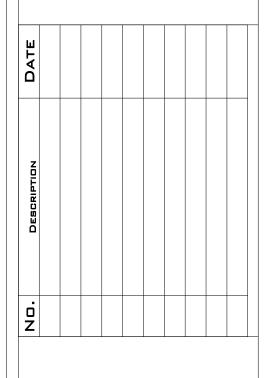

OVERALL EXTERIOR DEMOLITION ELEVATIONS

SHEET ISSUE DATE:

1 2/20/20
PROJECT NO.:

XX.XXXXX.XX


APPROVED BY:

CL

DRAWN BY:



ALE: AS INDICATED

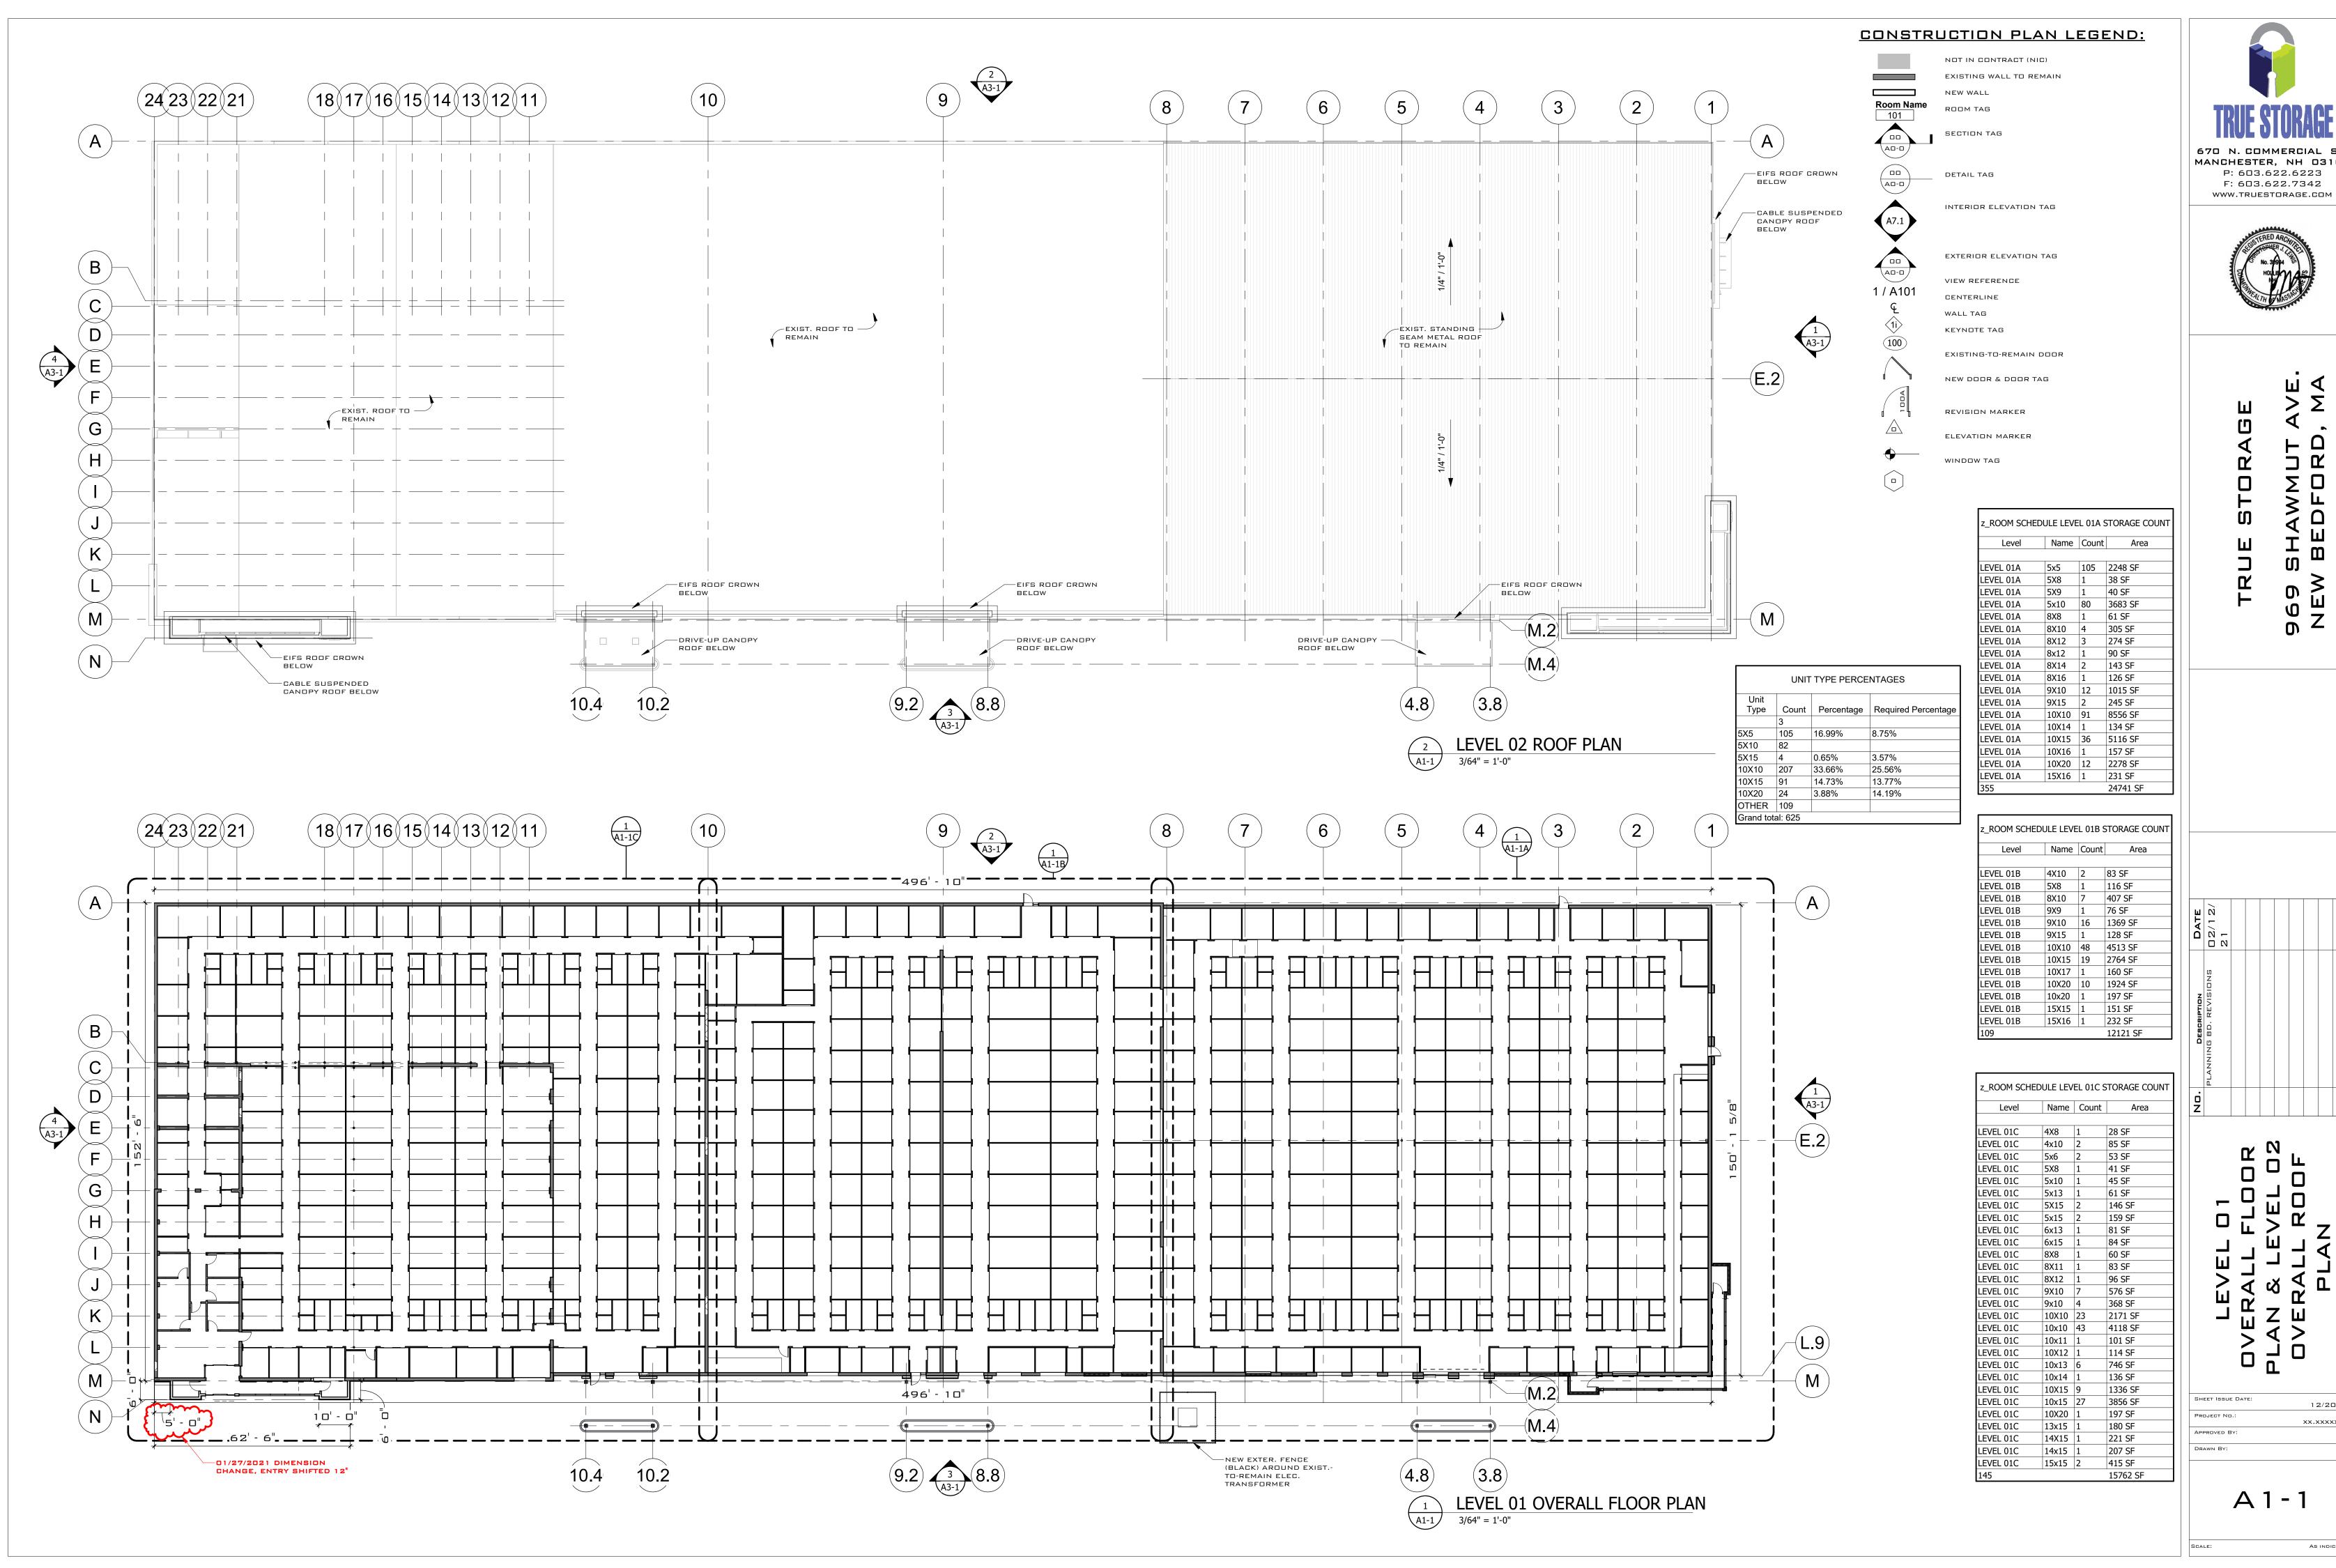






			I     n									
Name	Count	Area										
												-
X8	1	28 SF										
x10	2	85 SF			_		1	3				
x6	2	53 SF			L	Ľ	_	•	L			
X8	1	41 SF			ſ	7	L	J				
x10	1	45 SF			L				$\cup$			
x13	1	61 SF			ſ	7		J				
X15	2	146 SF			_	_	П	ı	U			
x15	2	159 SF			-	_	-					
x13	1	81 SF			L	L		>			7	
x15	1	84 SF		ı		_	Ь	1	ı		7	
X8	1	60 SF		$\neg$	_			ı	$\neg$	<	1	
X11	1	83 SF		LEVEI		ı		-		_	╝	
X12	1	96 SF		>	-		دء	2	1	_	1	
X10	7	576 SF		í. i	<	J	Ч	J	$\sim$	L	_	
x10	4	368 SF		щ	ſ	γ		_	Щ			
0X10	23	2171 SF			ī		Z	<b>Z</b>	Ш			
0x10	43	4118 SF			L	Ц		7	VERA			
0x11	1	101 SF				<b>4 4 7 7 7</b>		Ļ				
0X12	1	114 SF			_	_	_					
0x13	6	746 SF			L	J	Π					
0x14	1	136 SF						_				
0X15	9	1336 SF										
0x15	27	3856 SF	SHI	EET ISSUI	E DAT	E:				12	/20	/
0X20	1	197 SF	PRO	DJECT NO	o.:							
3x15	1	180 SF			75.44				×	X.X	(XXX	(
4X15	1	221 SF	APF	PROVED E	3Y:							
4x15	1	207 SF	DRA	AWN BY:								
	1		<b>1</b> ( )									

A1-1

AS INDICATED

12/20/20

xx.xxxxx.xx

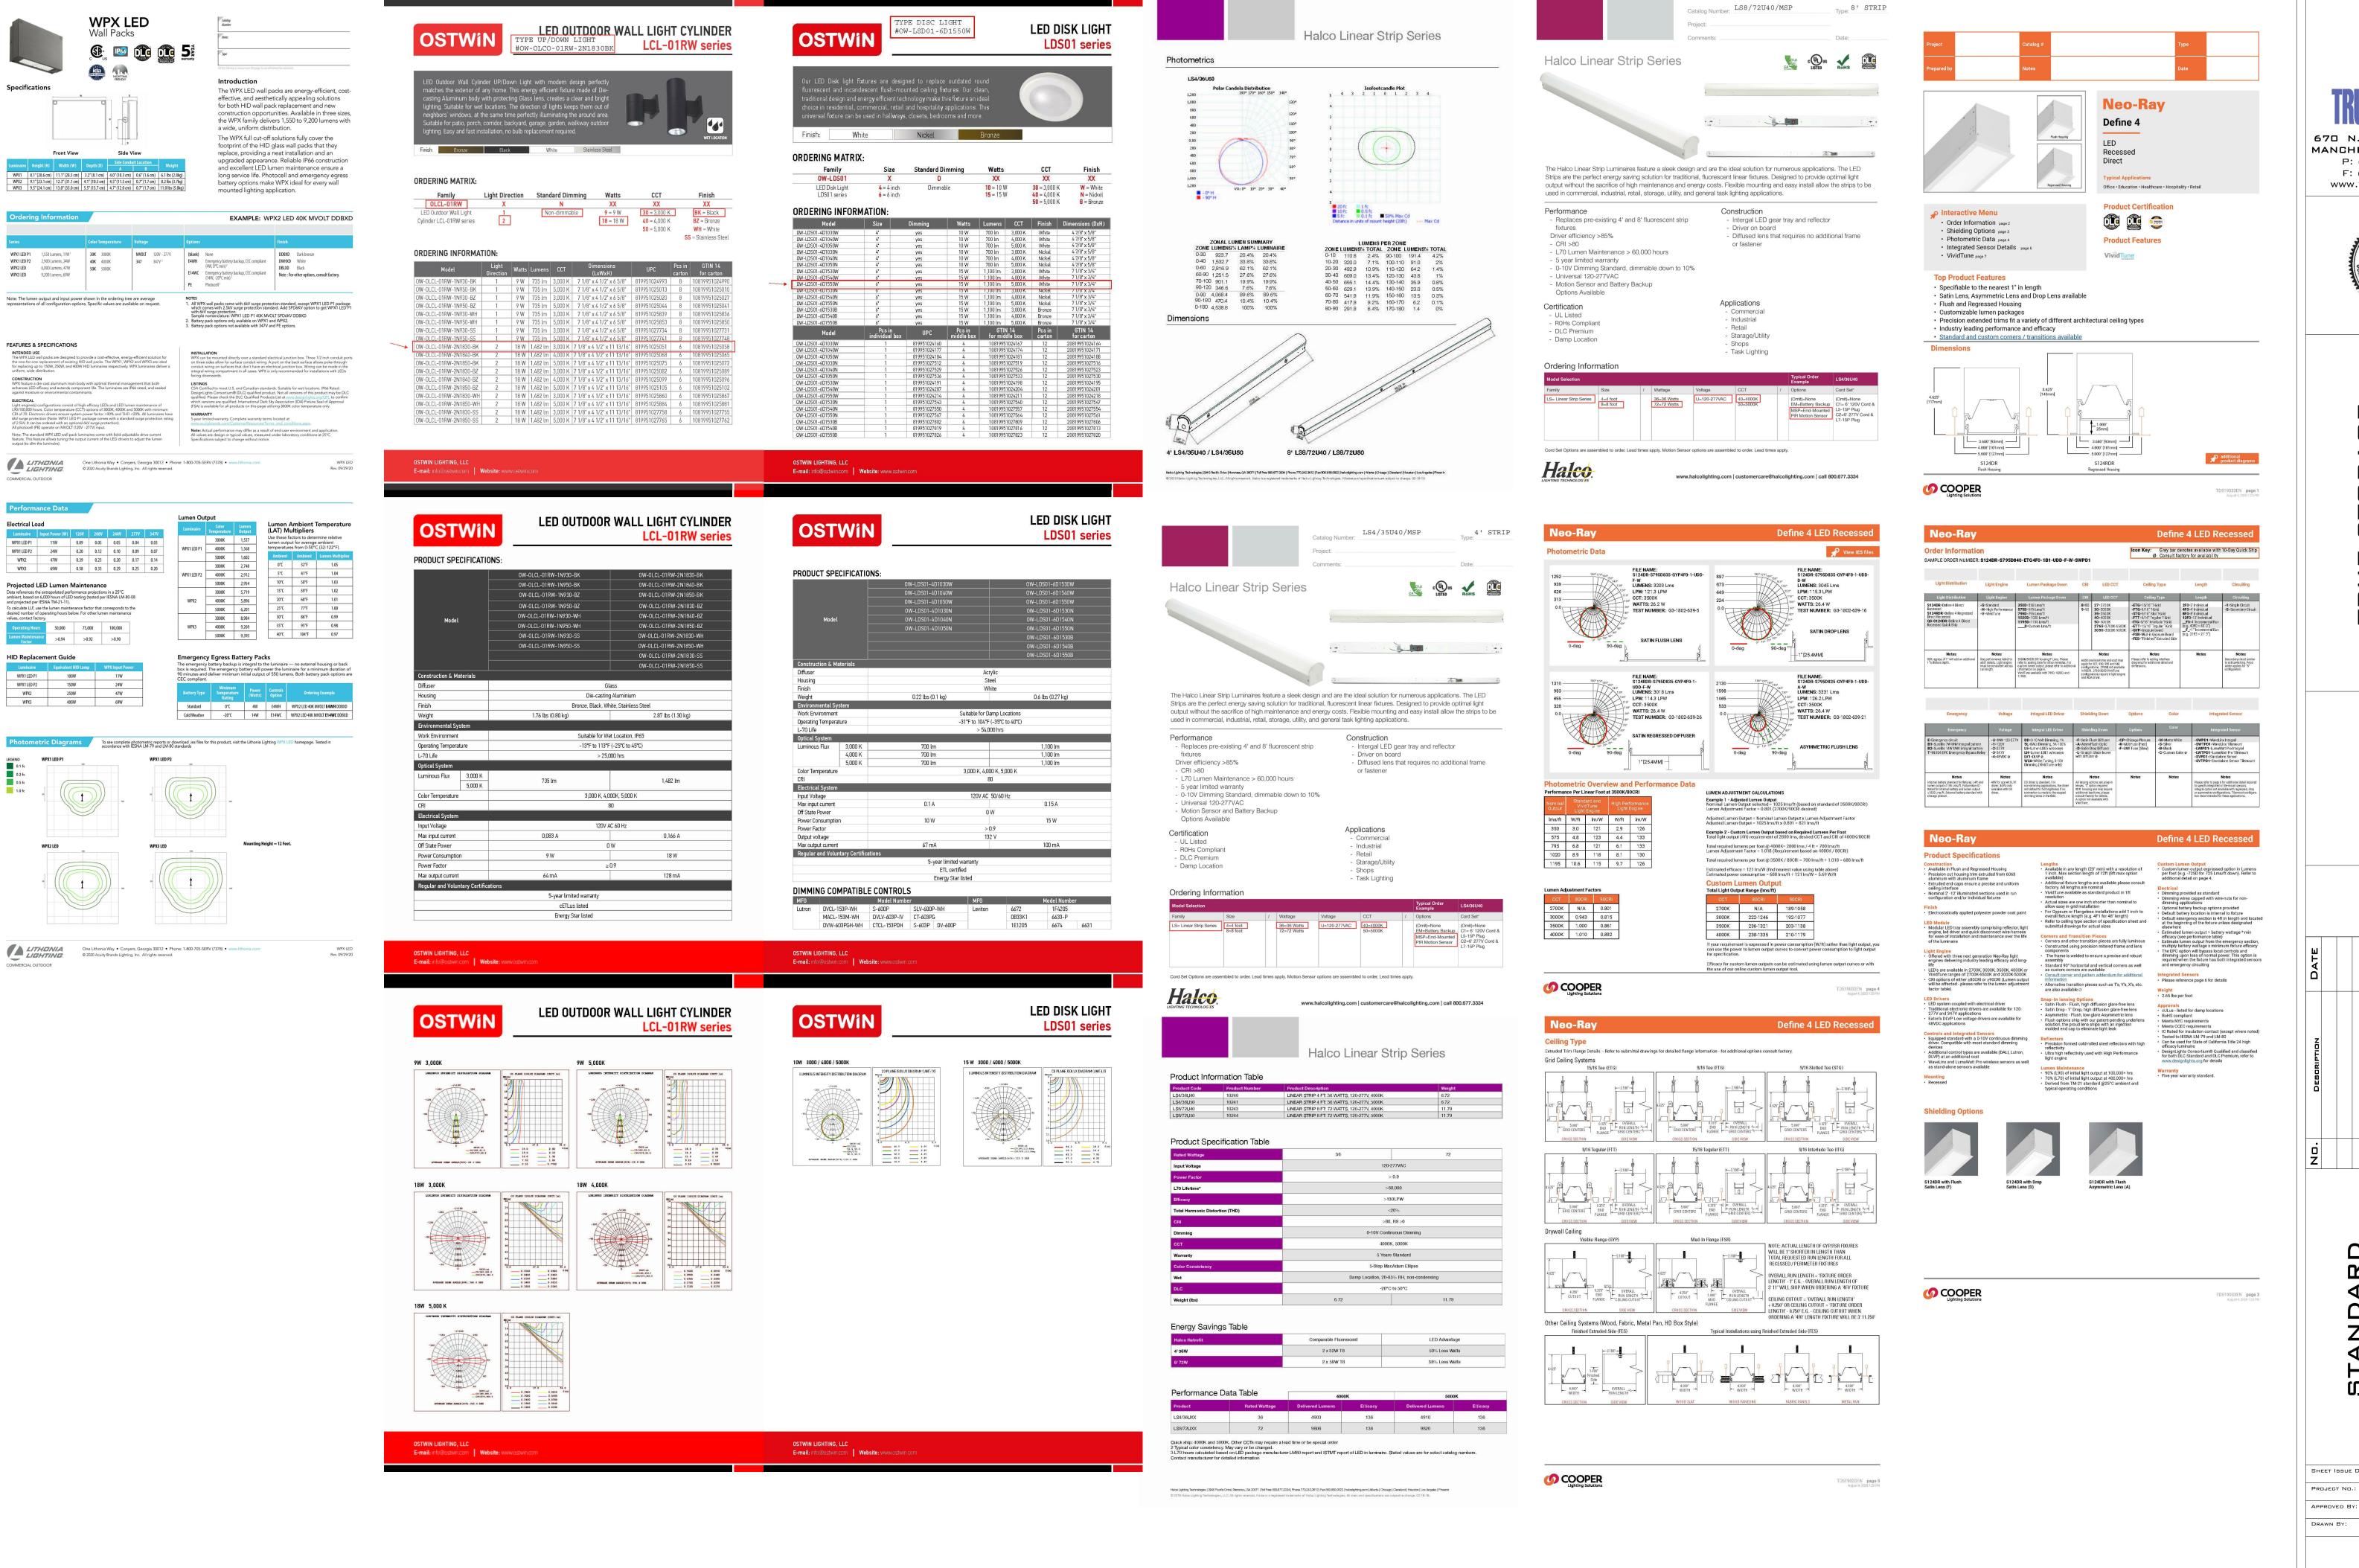

TRUE STORAGE
670 N. COMMERCIAL ST.

670 N. COMMERCIAL ST.
MANCHESTER, NH 03101
P: 603.622.6223
F: 603.622.7342
WWW.TRUESTORAGE.COM



E STORAGE HAWMUT AVE.

6 Z

ANDARD ITING CUT EETS FOR IGN-BUILD

LIGH SHE DESI

SHEET ISSUE DATE:

D2/12/21

PROJECT NO.:

XX.XXXXX.XX


APPROVED BY:

APPROVER

A2-11

e, = 1,-0, ½

AUTHOR

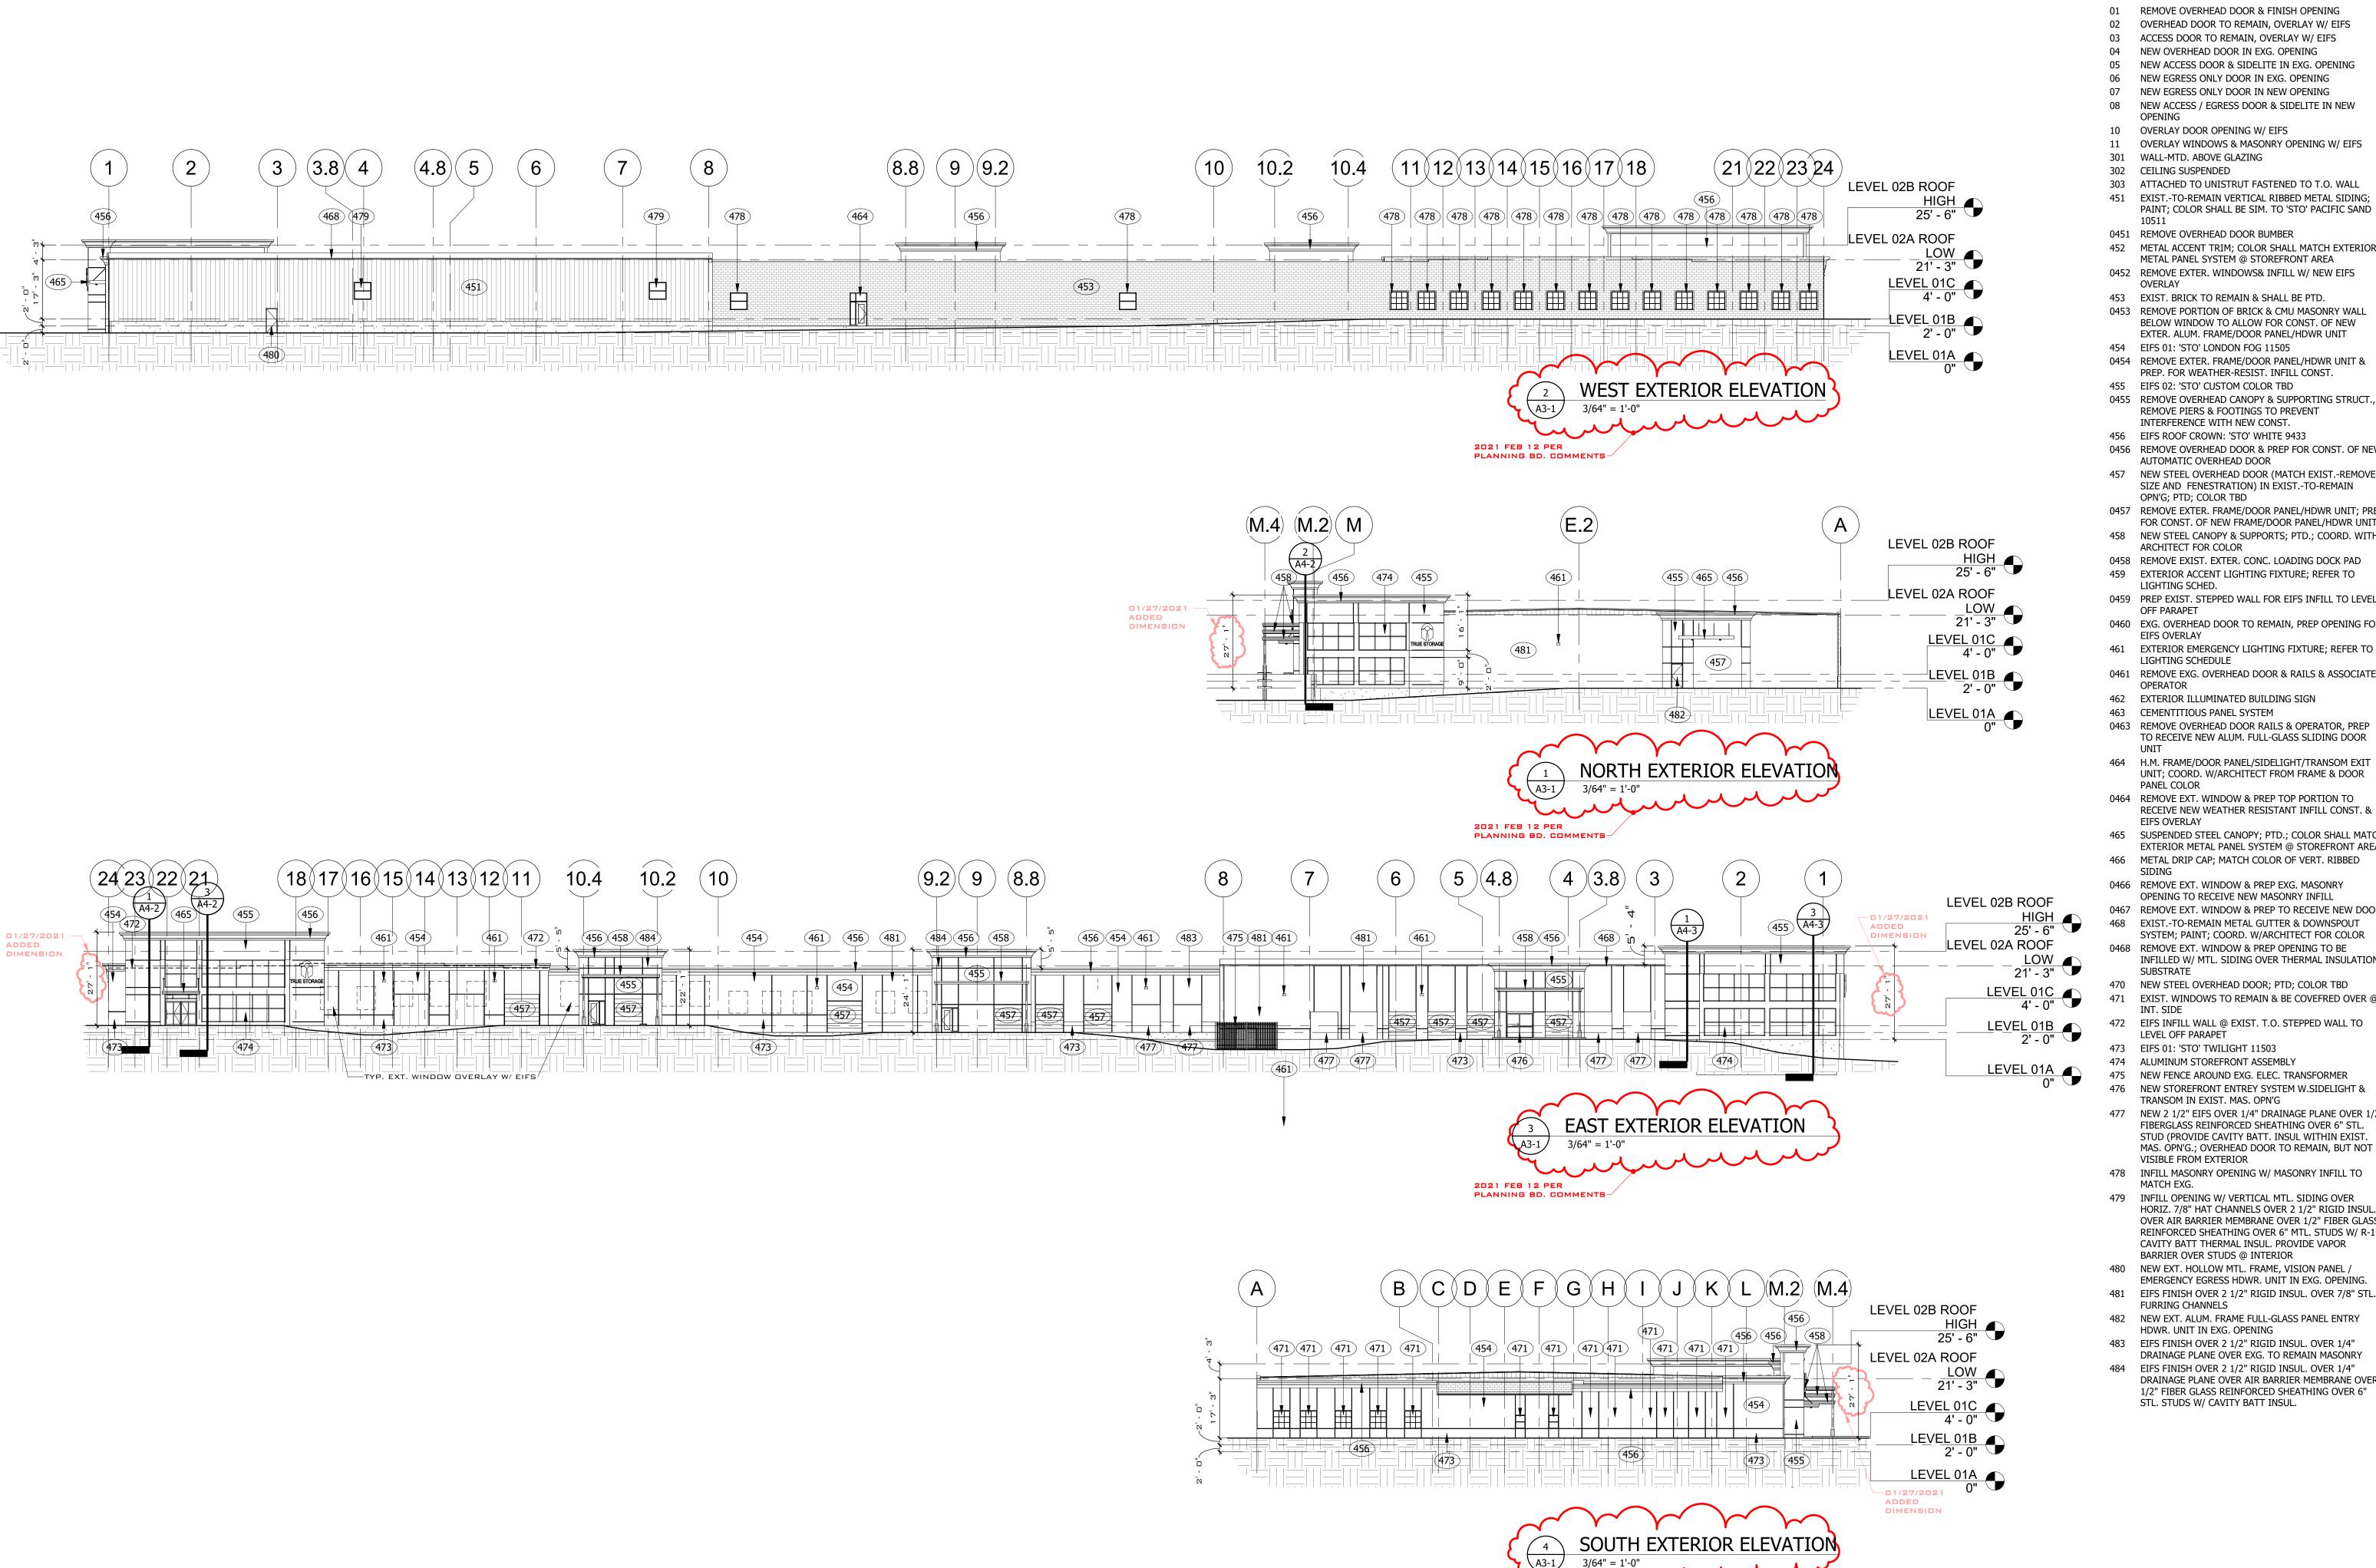

2021 FEB 12 PER

PLANNING BD. COMMENTS-

- 01 REMOVE OVERHEAD DOOR & FINISH OPENING 02 OVERHEAD DOOR TO REMAIN, OVERLAY W/ EIFS
- ACCESS DOOR TO REMAIN, OVERLAY W/ EIFS
- 04 NEW OVERHEAD DOOR IN EXG. OPENING
- 05 NEW ACCESS DOOR & SIDELITE IN EXG. OPENING 06 NEW EGRESS ONLY DOOR IN EXG. OPENING
- 07 NEW EGRESS ONLY DOOR IN NEW OPENING
- 08 NEW ACCESS / EGRESS DOOR & SIDELITE IN NEW

670 N. COMMERCIAL ST.

MANCHESTER, NH 03101

P: 603.622.6223

F: 603.622.7342

WWW.TRUESTORAGE.COM

THESE DRAWINGS ARE IN DESIGN

PROGRESS DRAWINGS. THEY ARE

CONSTRUCTION DOCUMENTS AND

DEVELOPMENT. THEY ARE

SHOULD NOT BE USED FOR

NOT INTENDED TO BE

CONSTRUCTION.

- 10 OVERLAY DOOR OPENING W/ EIFS
- 11 OVERLAY WINDOWS & MASONRY OPENING W/ EIFS
- 301 WALL-MTD. ABOVE GLAZING 302 CEILING SUSPENDED
- 303 ATTACHED TO UNISTRUT FASTENED TO T.O. WALL 451 EXIST.-TO-REMAIN VERTICAL RIBBED METAL SIDING; PAINT; COLOR SHALL BE SIM. TO 'STO' PACIFIC SAND
- 0451 REMOVE OVERHEAD DOOR BUMBER
- 452 METAL ACCENT TRIM; COLOR SHALL MATCH EXTERIOR METAL PANEL SYSTEM @ STOREFRONT AREA
- 0452 REMOVE EXTER. WINDOWS& INFILL W/ NEW EIFS
- 453 EXIST. BRICK TO REMAIN & SHALL BE PTD. 0453 REMOVE PORTION OF BRICK & CMU MASONRY WALL
- BELOW WINDOW TO ALLOW FOR CONST. OF NEW EXTER. ALUM. FRAME/DOOR PANEL/HDWR UNIT
- 454 EIFS 01: 'STO' LONDON FOG 11505
- 0454 REMOVE EXTER. FRAME/DOOR PANEL/HDWR UNIT & PREP. FOR WEATHER-RESIST. INFILL CONST.
- 0455 REMOVE OVERHEAD CANOPY & SUPPORTING STRUCT., REMOVE PIERS & FOOTINGS TO PREVENT
- 456 EIFS ROOF CROWN: 'STO' WHITE 9433 0456 REMOVE OVERHEAD DOOR & PREP FOR CONST. OF NEW
- AUTOMATIC OVERHEAD DOOR 457 NEW STEEL OVERHEAD DOOR (MATCH EXIST.-REMOVED
- SIZE AND FENESTRATION) IN EXIST.-TO-REMAIN OPN'G; PTD; COLOR TBD
- 0457 REMOVE EXTER. FRAME/DOOR PANEL/HDWR UNIT; PREP FOR CONST. OF NEW FRAME/DOOR PANEL/HDWR UNIT
- 458 NEW STEEL CANOPY & SUPPORTS; PTD.; COORD. WITH ARCHITECT FOR COLOR
- 0458 REMOVE EXIST. EXTER. CONC. LOADING DOCK PAD
- 459 EXTERIOR ACCENT LIGHTING FIXTURE; REFER TO LIGHTING SCHED.
- 0459 PREP EXIST. STEPPED WALL FOR EIFS INFILL TO LEVEL OFF PARAPET
- 0460 EXG. OVERHEAD DOOR TO REMAIN, PREP OPENING FOR EIFS OVERLAY
- 461 EXTERIOR EMERGENCY LIGHTING FIXTURE; REFER TO LIGHTING SCHEDULE
- 0461 REMOVE EXG. OVERHEAD DOOR & RAILS & ASSOCIATED
- OPERATOR
- 462 EXTERIOR ILLUMINATED BUILDING SIGN
- 463 CEMENTITIOUS PANEL SYSTEM
- 0463 REMOVE OVERHEAD DOOR RAILS & OPERATOR, PREP TO RECEIVE NEW ALUM. FULL-GLASS SLIDING DOOR
- 464 H.M. FRAME/DOOR PANEL/SIDELIGHT/TRANSOM EXIT UNIT; COORD. W/ARCHITECT FROM FRAME & DOOR
- 0464 REMOVE EXT. WINDOW & PREP TOP PORTION TO RECEIVE NEW WEATHER RESISTANT INFILL CONST. &
- EIFS OVERLAY 465 SUSPENDED STEEL CANOPY; PTD.; COLOR SHALL MATCH
- EXTERIOR METAL PANEL SYSTEM @ STOREFRONT AREA 466 METAL DRIP CAP; MATCH COLOR OF VERT. RIBBED
- SIDING
- OPENING TO RECEIVE NEW MASONRY INFILL
- 0467 REMOVE EXT. WINDOW & PREP TO RECEIVE NEW DOOR 468 EXIST.-TO-REMAIN METAL GUTTER & DOWNSPOUT
- SYSTEM; PAINT; COORD. W/ARCHITECT FOR COLOR 0468 REMOVE EXT. WINDOW & PREP OPENING TO BE INFILLED W/ MTL. SIDING OVER THERMAL INSULATION
- SUBSTRATE 470 NEW STEEL OVERHEAD DOOR; PTD; COLOR TBD
- 471 EXIST. WINDOWS TO REMAIN & BE COVEFRED OVER @
- 472 EIFS INFILL WALL @ EXIST. T.O. STEPPED WALL TO
- LEVEL OFF PARAPET 473 EIFS 01: 'STO' TWILIGHT 11503
- 474 ALUMINUM STOREFRONT ASSEMBLY
- 475 NEW FENCE AROUND EXG. ELEC. TRANSFORMER 476 NEW STOREFRONT ENTREY SYSTEM W.SIDELIGHT &
- TRANSOM IN EXIST. MAS. OPN'G 477 NEW 2 1/2" EIFS OVER 1/4" DRAINAGE PLANE OVER 1/2" FIBERGLASS REINFORCED SHEATHING OVER 6" STL. STUD (PROVIDE CAVITY BATT. INSUL WITHIN EXIST.
- VISIBLE FROM EXTERIOR 478 INFILL MASONRY OPENING W/ MASONRY INFILL TO
- MATCH EXG. 479 INFILL OPENING W/ VERTICAL MTL. SIDING OVER HORIZ. 7/8" HAT CHANNELS OVER 2 1/2" RIGID INSUL. OVER AIR BARRIER MEMBRANE OVER 1/2" FIBER GLASS REINFORCED SHEATHING OVER 6" MTL. STUDS W/ R-13 CAVITY BATT THERMAL INSUL. PROVIDE VAPOR
- 480 NEW EXT. HOLLOW MTL. FRAME, VISION PANEL / EMERGENCY EGRESS HDWR. UNIT IN EXG. OPENING.
- 481 EIFS FINISH OVER 2 1/2" RIGID INSUL. OVER 7/8" STL. FURRING CHANNELS
- 482 NEW EXT. ALUM. FRAME FULL-GLASS PANEL ENTRY HDWR. UNIT IN EXG. OPENING
- 483 EIFS FINISH OVER 2 1/2" RIGID INSUL. OVER 1/4"
- 484 EIFS FINISH OVER 2 1/2" RIGID INSUL. OVER 1/4" DRAINAGE PLANE OVER AIR BARRIER MEMBRANE OVER 1/2" FIBER GLASS REINFORCED SHEATHING OVER 6"

DRAINAGE PLANE OVER EXG. TO REMAIN MASONRY STL. STUDS W/ CAVITY BATT INSUL.

> SHEET ISSUE DATE: 12/20/20 PROJECT No.: xx.xxxxx.xx APPROVED BY:

\_ o o

A3-1

AS INDICATED