### TRUE STORAGE NEW BEDFORD, LLC

# COMMERCIAL BUILDING CONVERSION

## 969 SHAWMUT AVENUE NEW BEDFORD, MASSACHUSETTS

### **APPLICANT**:

TRUE STORAGE NEW BEDFORD, LLC 670 N. COMMERCIAL STREET, SUITE 303 MANCHESTER, NH 03101 603-622-1002

LAND SURVEYOR & CIVIL ENGINEER:
ALLEN & MAJOR ASSOCIATES, INC.
100 COMMERCE WAY
WOBURN, MA 01888-0118
(781) 935-6889

### **ARCHITECT**

TRUE STORAGE NEW BEDFORD
- ARCHITECTURE DEPARTMENT
670 N. COMMERCIAL ST.
MANCHESTER, NH 03101
603-622-6223



LIST OF DRAWINGS			
DRAWING TITLE	SHEET	ISSUED	REVISED
COVER	С	02-09-21	02-12-21
EXISTING CONDITIONS	V-101	02-09-21	-
SITE PREPARATION PLAN	C-101	02-09-21	02-12-21
LAYOUT & MATERIALS PLAN	C-102	02-09-21	02-12-21
GRADING & DRAINAGE PLAN	C-103	02-09-21	02-12-21
LANDSCAPE PLAN	C-104	02-09-21	02-12-21
DETAILS	C-500	02-09-21	02-12-21
DETAILS	C-501	02-09-21	02-12-21
COVER SHEET	A0-0A	12-20-20	02-12-21
LEVEL 01 ARCHITECTURAL DEMOLITION FLOOR PLAN	A0-01	12-20-20	02-12-21
OVERALL EXTERIOR DEMOLITION ELEVATIONS	A0-02	12-20-20	02-12-21
LEVEL 01 OVERALL FLOOR PLAN & LEVEL 02 OVERALL ROOF PLAN	A1-1	12-20-20	02-12-21
STANDARD LIGHTING CUT SHEETS FOR DESIGN-BUILD	A2-11	12-20-20	02-12-21
OVERALL EXTERIOR ELEVATIONS	A3-1	12-20-20	02-12-21

#### **PLAN NOTES:**

- 1. THE SITE IS LISTED ON CITY OF NEW BEDFORD ASSESSOR PROPERTY RECORD CARD AS TAX MAP 121, LOT 63
- 2. EXISTING CONDITIONS WERE COMPILED FROM AN ON THE GROUND SURVEY PERFORMED BY ALLEN & MAJOR ASSOCIATES AS WELL AS AVAILABLE RECORD PLANS OBTAINED FROM THE CITY ENGINEERING DEPARTMENT AND OTHER SOURCES.
- 3. BRISTOL COUNTY SOUTH REGISTRY OF DEEDS:
  DEED REFERENCE: BK 00136 PG 87
  PLAN REFERENCE: LCC 25130 A THRU E
- 4. THE SUBJECT PROPERTY IS LOCATED IN ZONE Z, AS SHOWN ON THE FLOOD INSURANCE RATE MAP OF BRISTOL COUNTY, MASSACHUSETTS, MAP NUMBER 25005C0379F, MAP REVISED JULY 7, 2009.
- 5. THE SITE IS NOT LOCATED WITHIN AN AREA OF CRITICAL ENVIRONMENTAL CONCERN (ACEC)
- 6. THE SITE <u>IS NOT</u> IN A ZONE A SURFACE WATER SUPPLY AREA
- 7. THE SITE <u>IS NOT</u> LOCATE IN AN OUTSTANDING RESOURCE WATER AREA (ORW)
- 8. THE CONTRACTOR IS SPECIFICALLY CAUTIONED THAT THE LOCATION AND/OR ELEVATION OF EXISTING UTILITIES AND STRUCTURES AS SHOWN ON THESE PLANS IS BASED ON RECORDS OF VARIOUS UTILITY COMPANIES AND WHERE POSSIBLE, MEASUREMENTS TAKEN IN THE FIELD. THIS INFORMATION IS NOT TO BE RELIED ON AS BEING EXACT OR COMPLETE. THE LOCATION OF ALL UNDERGROUND UTILITIES AND STRUCTURES SHALL BE VERIFIED IN THE FIELD BY THE CONTRACTOR PRIOR TO THE START OF CONSTRUCTION
- 9. THE CONTRACTOR MUST CONTACT THE APPROPRIATE UTILITY COMPANY, ANY GOVERNING PERMITTING AUTHORITY, AND "DIGSAFE" AT LEAST 72 HOURS PRIOR TO ANY EXCAVATION WORK. THE CONTRACTOR SHALL ALSO CONTACT THE CITY DEPARTMENT OF PUBLIC WORKS AT LEAST 72 HOURS PRIOR TO ANY EXCAVATION WORK TO REQUEST EXACT FIELD LOCATION OF LOCAL UTILITIES.



ALLEN & MAJOR

ASSOCIATES, INC.

civil engineering • land surveying
environmental consulting • landscape architecture

w w w . a l l e n m a j o r . c o m

100 COMMERCE WAY, SUITE 5

FAX: (781) 935-2896

WOBURN, MA ◆ LAKEVILLE, MA ◆ MANCHESTER, NH


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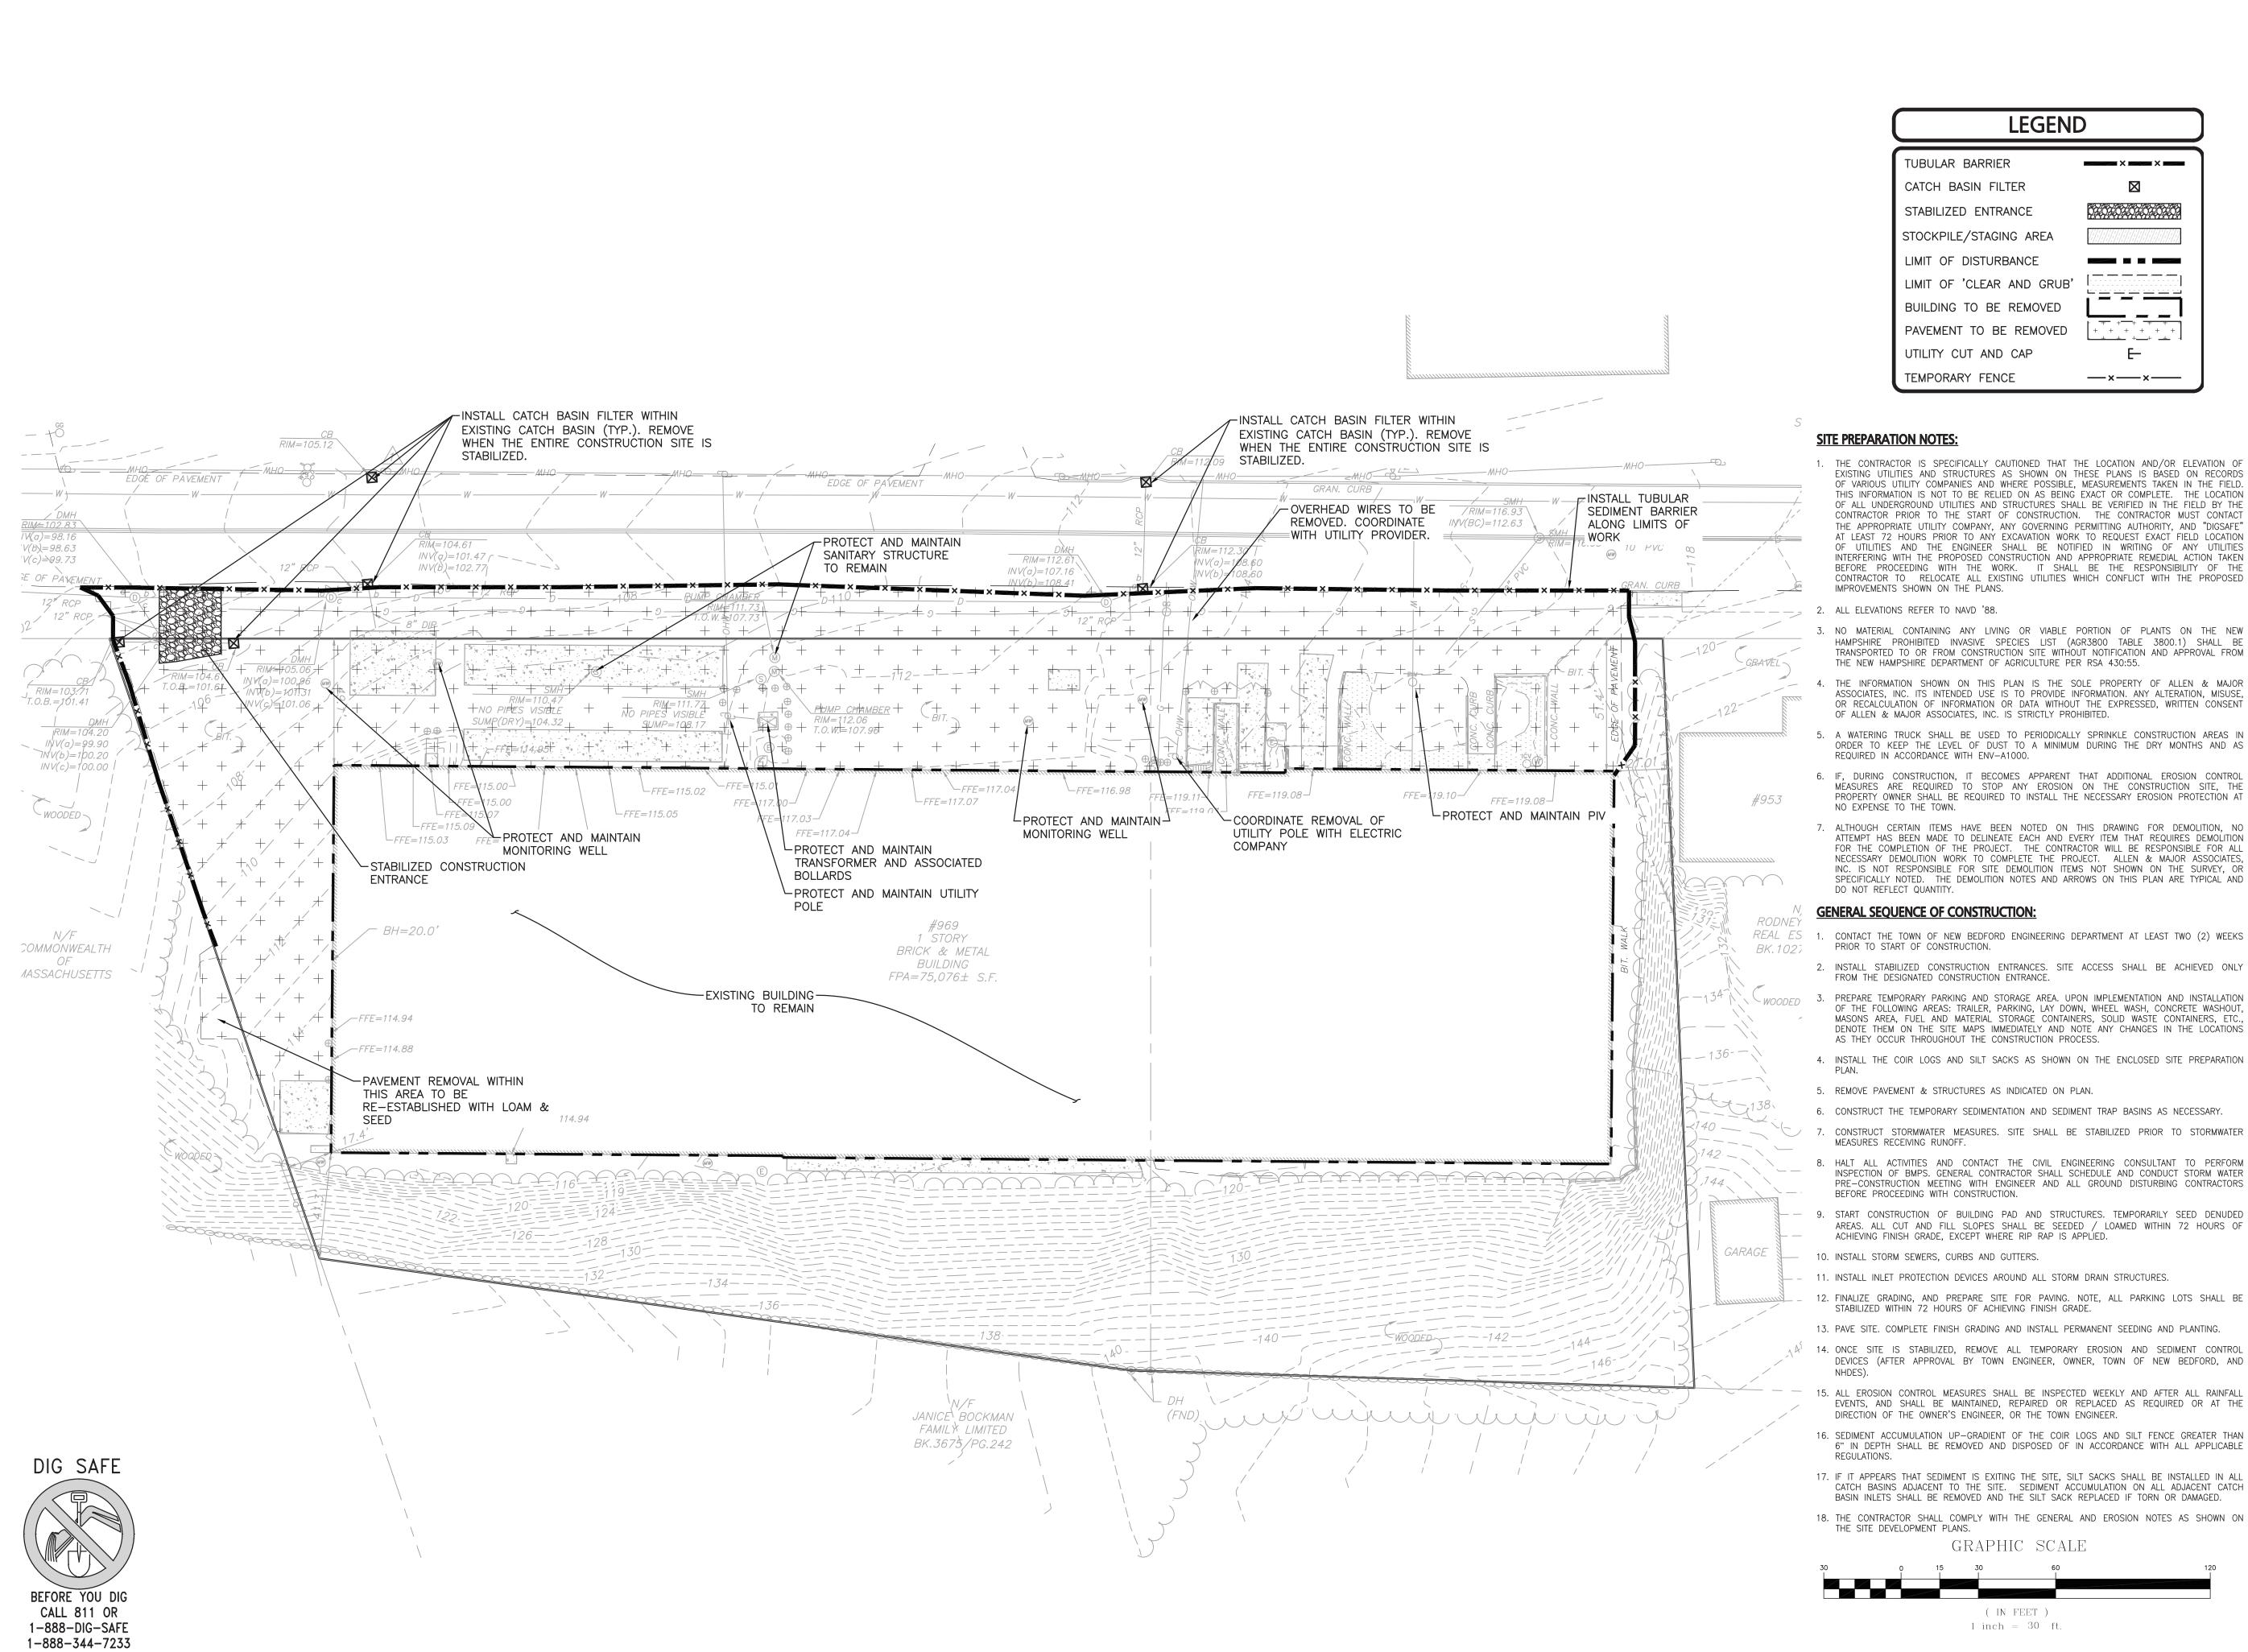
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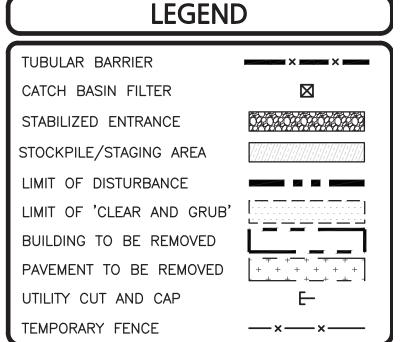
WOBURN MA 01801

TEL: (781) 935-6889

ISSUED FOR SITE PLAN APPROVAL: FEBRUARY 09, 2021





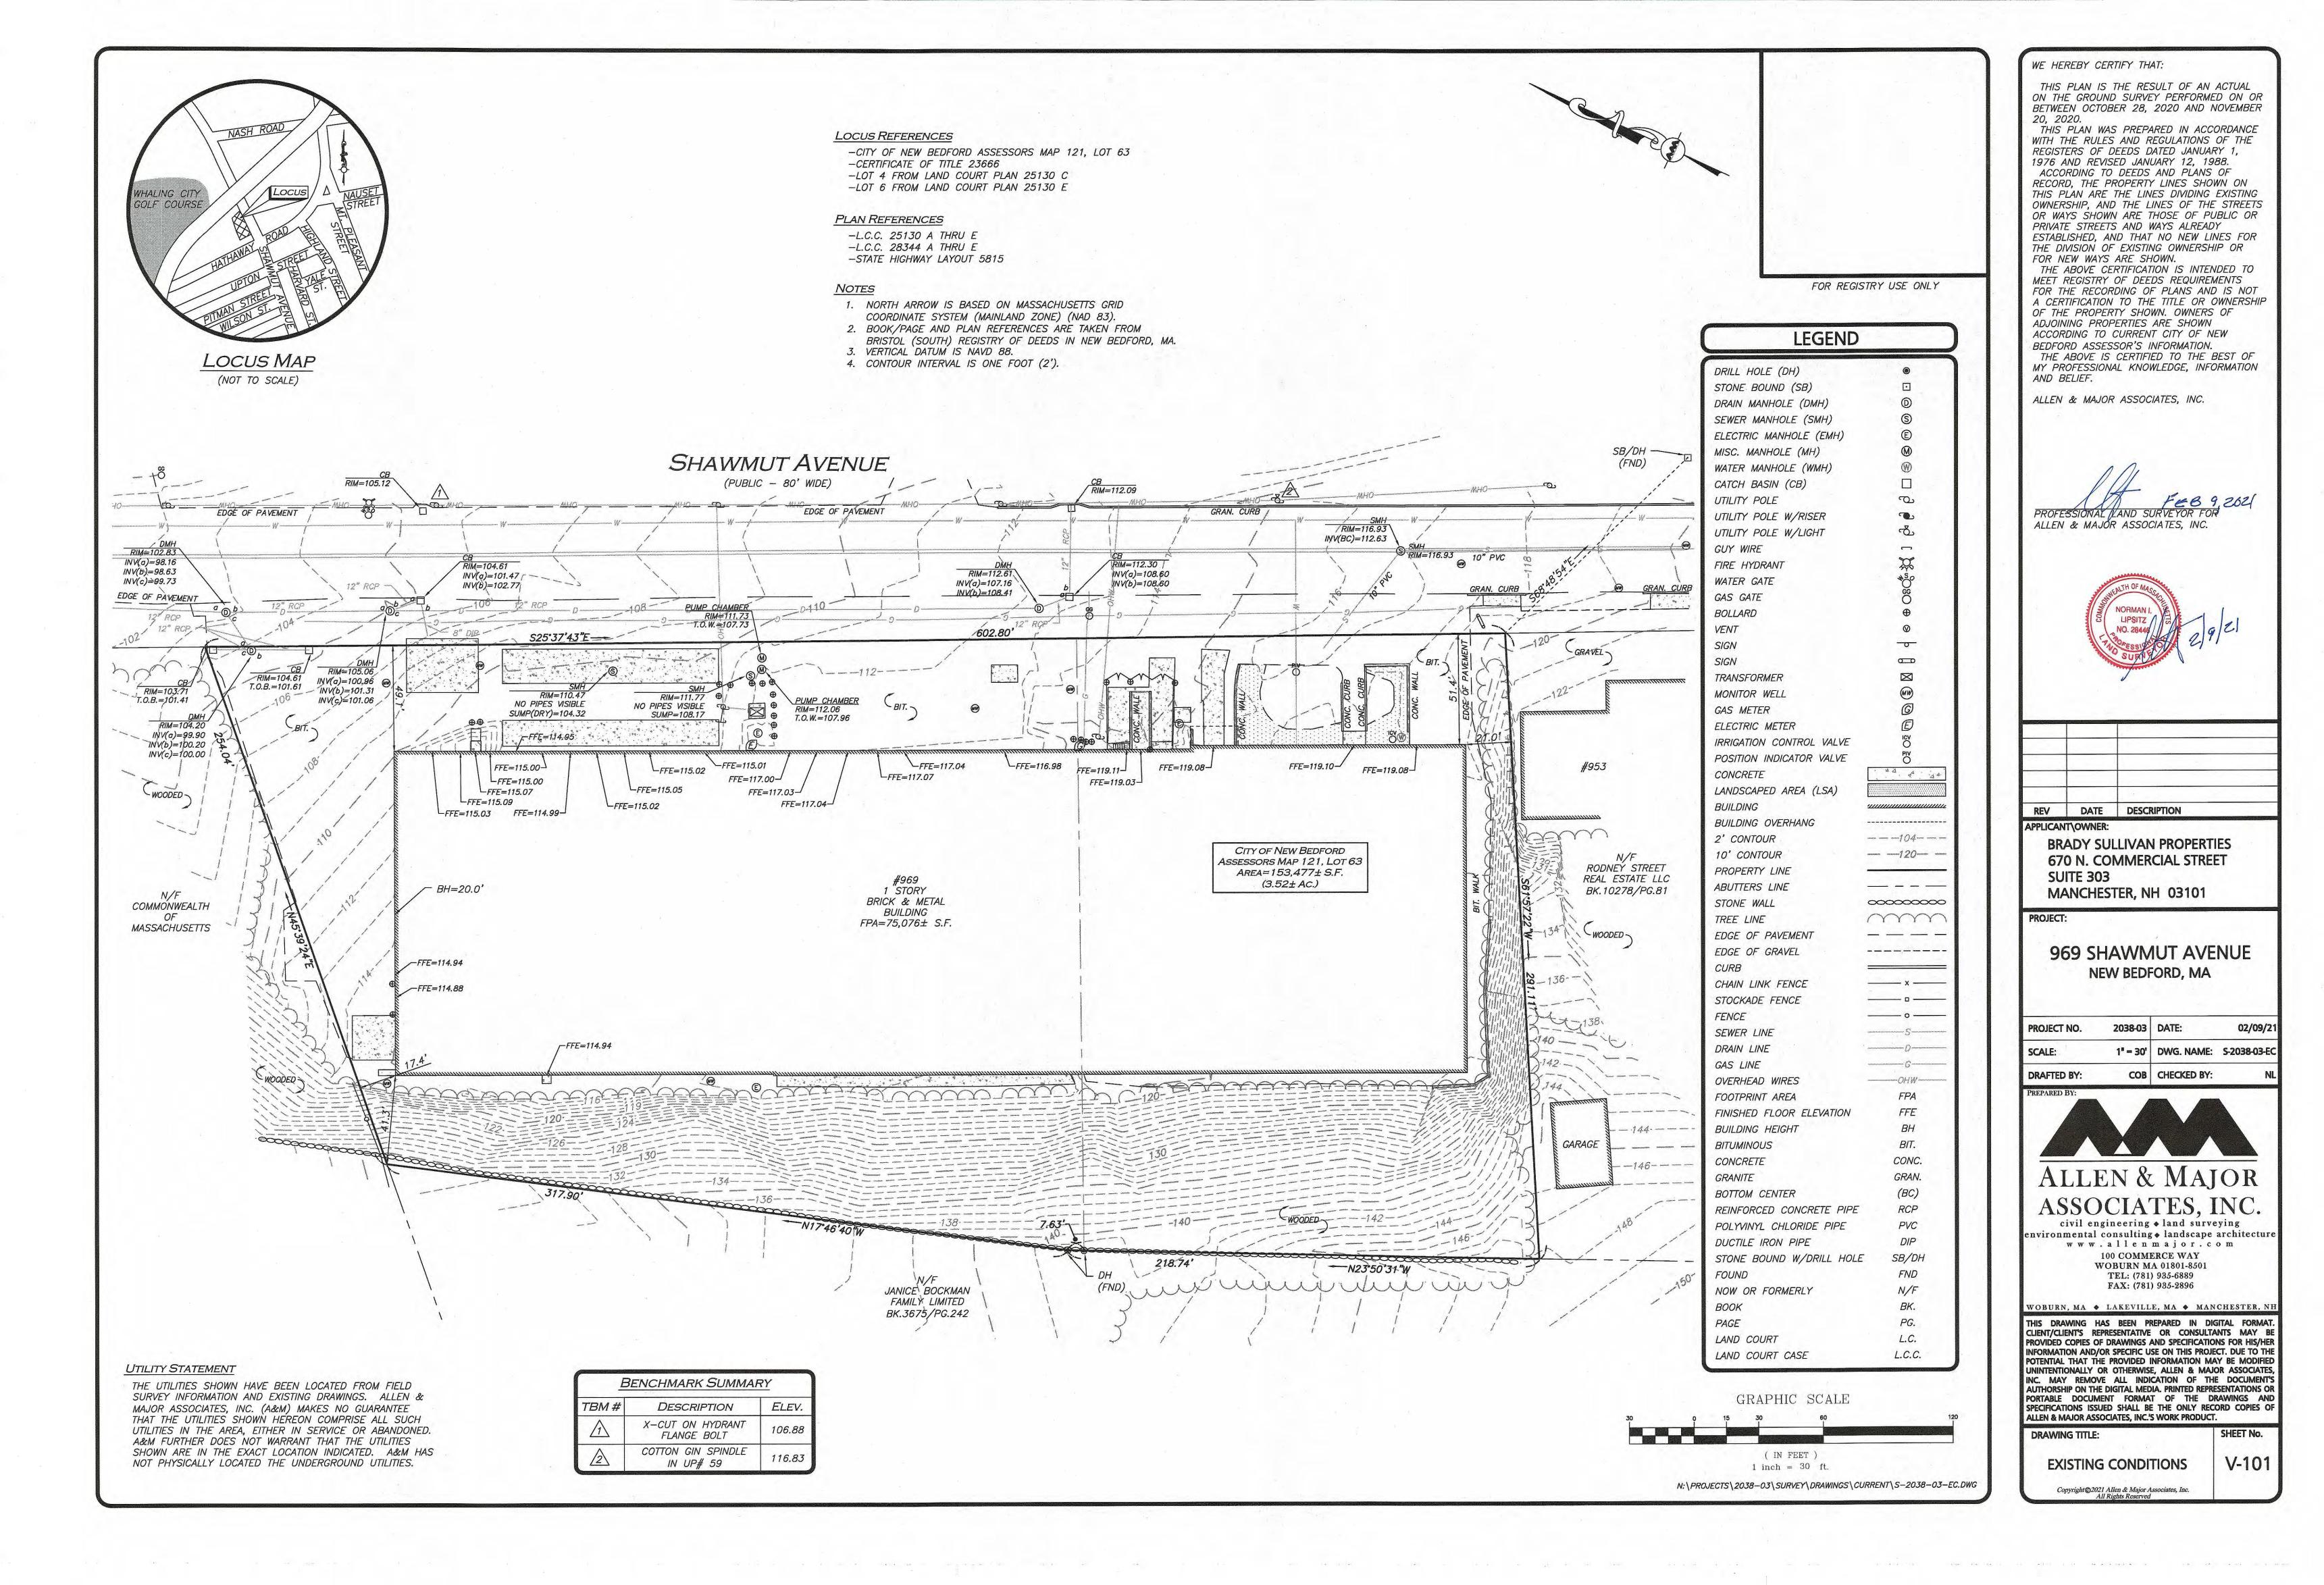

- 1. THE CONTRACTOR IS SPECIFICALLY CAUTIONED THAT THE LOCATION AND/OR ELEVATION OF EXISTING UTILITIES AND STRUCTURES AS SHOWN ON THESE PLANS IS BASED ON RECORDS OF VARIOUS UTILITY COMPANIES AND WHERE POSSIBLE, MEASUREMENTS TAKEN IN THE FIELD. THIS INFORMATION IS NOT TO BE RELIED ON AS BEING EXACT OR COMPLETE. THE LOCATION OF ALL UNDERGROUND UTILITIES AND STRUCTURES SHALL BE VERIFIED IN THE FIELD BY THE CONTRACTOR PRIOR TO THE START OF CONSTRUCTION. THE CONTRACTOR MUST CONTACT THE APPROPRIATE UTILITY COMPANY, ANY GOVERNING PERMITTING AUTHORITY, AND "DIGSAFE" AT LEAST 72 HOURS PRIOR TO ANY EXCAVATION WORK TO REQUEST EXACT FIELD LOCATION OF UTILITIES AND THE ENGINEER SHALL BE NOTIFIED IN WRITING OF ANY UTILITIES INTERFERING WITH THE PROPOSED CONSTRUCTION AND APPROPRIATE REMEDIAL ACTION TAKEN BEFORE PROCEEDING WITH THE WORK. IT SHALL BE THE RESPONSIBILITY OF THE CONTRACTOR TO RELOCATE ALL EXISTING UTILITIES WHICH CONFLICT WITH THE PROPOSED
- 3. NO MATERIAL CONTAINING ANY LIVING OR VIABLE PORTION OF PLANTS ON THE NEW HAMPSHIRE PROHIBITED INVASIVE SPECIES LIST (AGR3800 TABLE 3800.1) SHALL BE TRANSPORTED TO OR FROM CONSTRUCTION SITE WITHOUT NOTIFICATION AND APPROVAL FROM THE NEW HAMPSHIRE DEPARTMENT OF AGRICULTURE PER RSA 430:55.
- THE INFORMATION SHOWN ON THIS PLAN IS THE SOLE PROPERTY OF ALLEN & MAJOR ASSOCIATES, INC. ITS INTENDED USE IS TO PROVIDE INFORMATION. ANY ALTERATION, MISUSE, OR RECALCULATION OF INFORMATION OR DATA WITHOUT THE EXPRESSED, WRITTEN CONSENT
- 5. A WATERING TRUCK SHALL BE USED TO PERIODICALLY SPRINKLE CONSTRUCTION AREAS IN ORDER TO KEEP THE LEVEL OF DUST TO A MINIMUM DURING THE DRY MONTHS AND AS REQUIRED IN ACCORDANCE WITH ENV-A1000.
- 6. IF, DURING CONSTRUCTION, IT BECOMES APPARENT THAT ADDITIONAL EROSION CONTROL MEASURES ARE REQUIRED TO STOP ANY EROSION ON THE CONSTRUCTION SITE, THE PROPERTY OWNER SHALL BE REQUIRED TO INSTALL THE NECESSARY EROSION PROTECTION AT
- 7. ALTHOUGH CERTAIN ITEMS HAVE BEEN NOTED ON THIS DRAWING FOR DEMOLITION, NO ATTEMPT HAS BEEN MADE TO DELINEATE EACH AND EVERY ITEM THAT REQUIRES DEMOLITION FOR THE COMPLETION OF THE PROJECT. THE CONTRACTOR WILL BE RESPONSIBLE FOR ALL NECESSARY DEMOLITION WORK TO COMPLETE THE PROJECT. ALLEN & MAJOR ASSOCIATES, INC. IS NOT RESPONSIBLE FOR SITE DEMOLITION ITEMS NOT SHOWN ON THE SURVEY. OR SPECIFICALLY NOTED. THE DEMOLITION NOTES AND ARROWS ON THIS PLAN ARE TYPICAL AND

#### **GENERAL SEQUENCE OF CONSTRUCTION:**

- REAL ES 1. CONTACT THE TOWN OF NEW BEDFORD ENGINEERING DEPARTMENT AT LEAST TWO (2) WEEKS
  - 2. INSTALL STABILIZED CONSTRUCTION ENTRANCES. SITE ACCESS SHALL BE ACHIEVED ONLY FROM THE DESIGNATED CONSTRUCTION ENTRANCE.
- WOODED 3. PREPARE TEMPORARY PARKING AND STORAGE AREA. UPON IMPLEMENTATION AND INSTALLATION OF THE FOLLOWING AREAS: TRAILER, PARKING, LAY DOWN, WHEEL WASH, CONCRETE WASHOUT, MASONS AREA, FUEL AND MATERIAL STORAGE CONTAINERS, SOLID WASTE CONTAINERS, ETC., DENOTE THEM ON THE SITE MAPS IMMEDIATELY AND NOTE ANY CHANGES IN THE LOCATIONS AS THEY OCCUR THROUGHOUT THE CONSTRUCTION PROCESS.
  - 4. INSTALL THE COIR LOGS AND SILT SACKS AS SHOWN ON THE ENCLOSED SITE PREPARATION
  - 5. REMOVE PAVEMENT & STRUCTURES AS INDICATED ON PLAN.
  - 6. CONSTRUCT THE TEMPORARY SEDIMENTATION AND SEDIMENT TRAP BASINS AS NECESSARY.
  - 7. CONSTRUCT STORMWATER MEASURES. SITE SHALL BE STABILIZED PRIOR TO STORMWATER
  - 8. HALT ALL ACTIVITIES AND CONTACT THE CIVIL ENGINEERING CONSULTANT TO PERFORM INSPECTION OF BMPS. GENERAL CONTRACTOR SHALL SCHEDULE AND CONDUCT STORM WATER PRE-CONSTRUCTION MEETING WITH ENGINEER AND ALL GROUND DISTURBING CONTRACTORS
  - 9. START CONSTRUCTION OF BUILDING PAD AND STRUCTURES. TEMPORARILY SEED DENUDED AREAS. ALL CUT AND FILL SLOPES SHALL BE SEEDED / LOAMED WITHIN 72 HOURS OF
  - 10. INSTALL STORM SEWERS, CURBS AND GUTTERS.
  - 11. INSTALL INLET PROTECTION DEVICES AROUND ALL STORM DRAIN STRUCTURES.
  - 12. FINALIZE GRADING, AND PREPARE SITE FOR PAVING. NOTE, ALL PARKING LOTS SHALL BE STABILIZED WITHIN 72 HOURS OF ACHIEVING FINISH GRADE.
  - 13. PAVE SITE. COMPLETE FINISH GRADING AND INSTALL PERMANENT SEEDING AND PLANTING.
  - DEVICES (AFTER APPROVAL BY TOWN ENGINEER, OWNER, TOWN OF NEW BEDFORD, AND
  - 15. ALL EROSION CONTROL MEASURES SHALL BE INSPECTED WEEKLY AND AFTER ALL RAINFALL EVENTS, AND SHALL BE MAINTAINED, REPAIRED OR REPLACED AS REQUIRED OR AT THE DIRECTION OF THE OWNER'S ENGINEER, OR THE TOWN ENGINEER.
  - 16. SEDIMENT ACCUMULATION UP-GRADIENT OF THE COIR LOGS AND SILT FENCE GREATER THAN 6" IN DEPTH SHALL BE REMOVED AND DISPOSED OF IN ACCORDANCE WITH ALL APPLICABLE
  - 17. IF IT APPEARS THAT SEDIMENT IS EXITING THE SITE, SILT SACKS SHALL BE INSTALLED IN ALL CATCH BASINS ADJACENT TO THE SITE. SEDIMENT ACCUMULATION ON ALL ADJACENT CATCH BASIN INLETS SHALL BE REMOVED AND THE SILT SACK REPLACED IF TORN OR DAMAGED.
  - 18. THE CONTRACTOR SHALL COMPLY WITH THE GENERAL AND EROSION NOTES AS SHOWN ON

( IN FEET ) 1 inch = 30 ft.



Digitally signed by Michael Malynowsk Date: 2021.02.15 13:16:01 -05'00'

ALLEN & MAJOR ASSOCIATES, INC.

<u> </u>	02-12-21	MISC. UPDATES PER TOWN COMMEN
REV	DATE	DESCRIPTION

APPLICANT\OWNER:

TRUE STORAGE NEW BEDFORD, LLC 670 N. COMMERCIAL STREET, SUITE 303 MANCHESTER, NH 03101

COMMERCIAL BUILDING

**CONVERSION** 969 SHAWMUT AVENUE NEW BEDFORD, MA

2038-03 | DATE: FEBRUARY 9, 2021 PROJECT NO. SCALE: 1"=30' DWG. : C-2038-03\_SITE-PREP

DRAFTED BY: MM | CHECKED BY:



ASSOCIATES, INC. civil engineering ♦ land surveying nvironmental consulting ♦ landscape architecture

www.allenmajor.com 100 COMMERCE WAY, SUITE 5 WOBURN MA 01801

FAX: (781) 935-2896 WOBURN, MA ♦ LAKEVILLE, MA ♦ MANCHESTER, NH

TEL: (781) 935-6889

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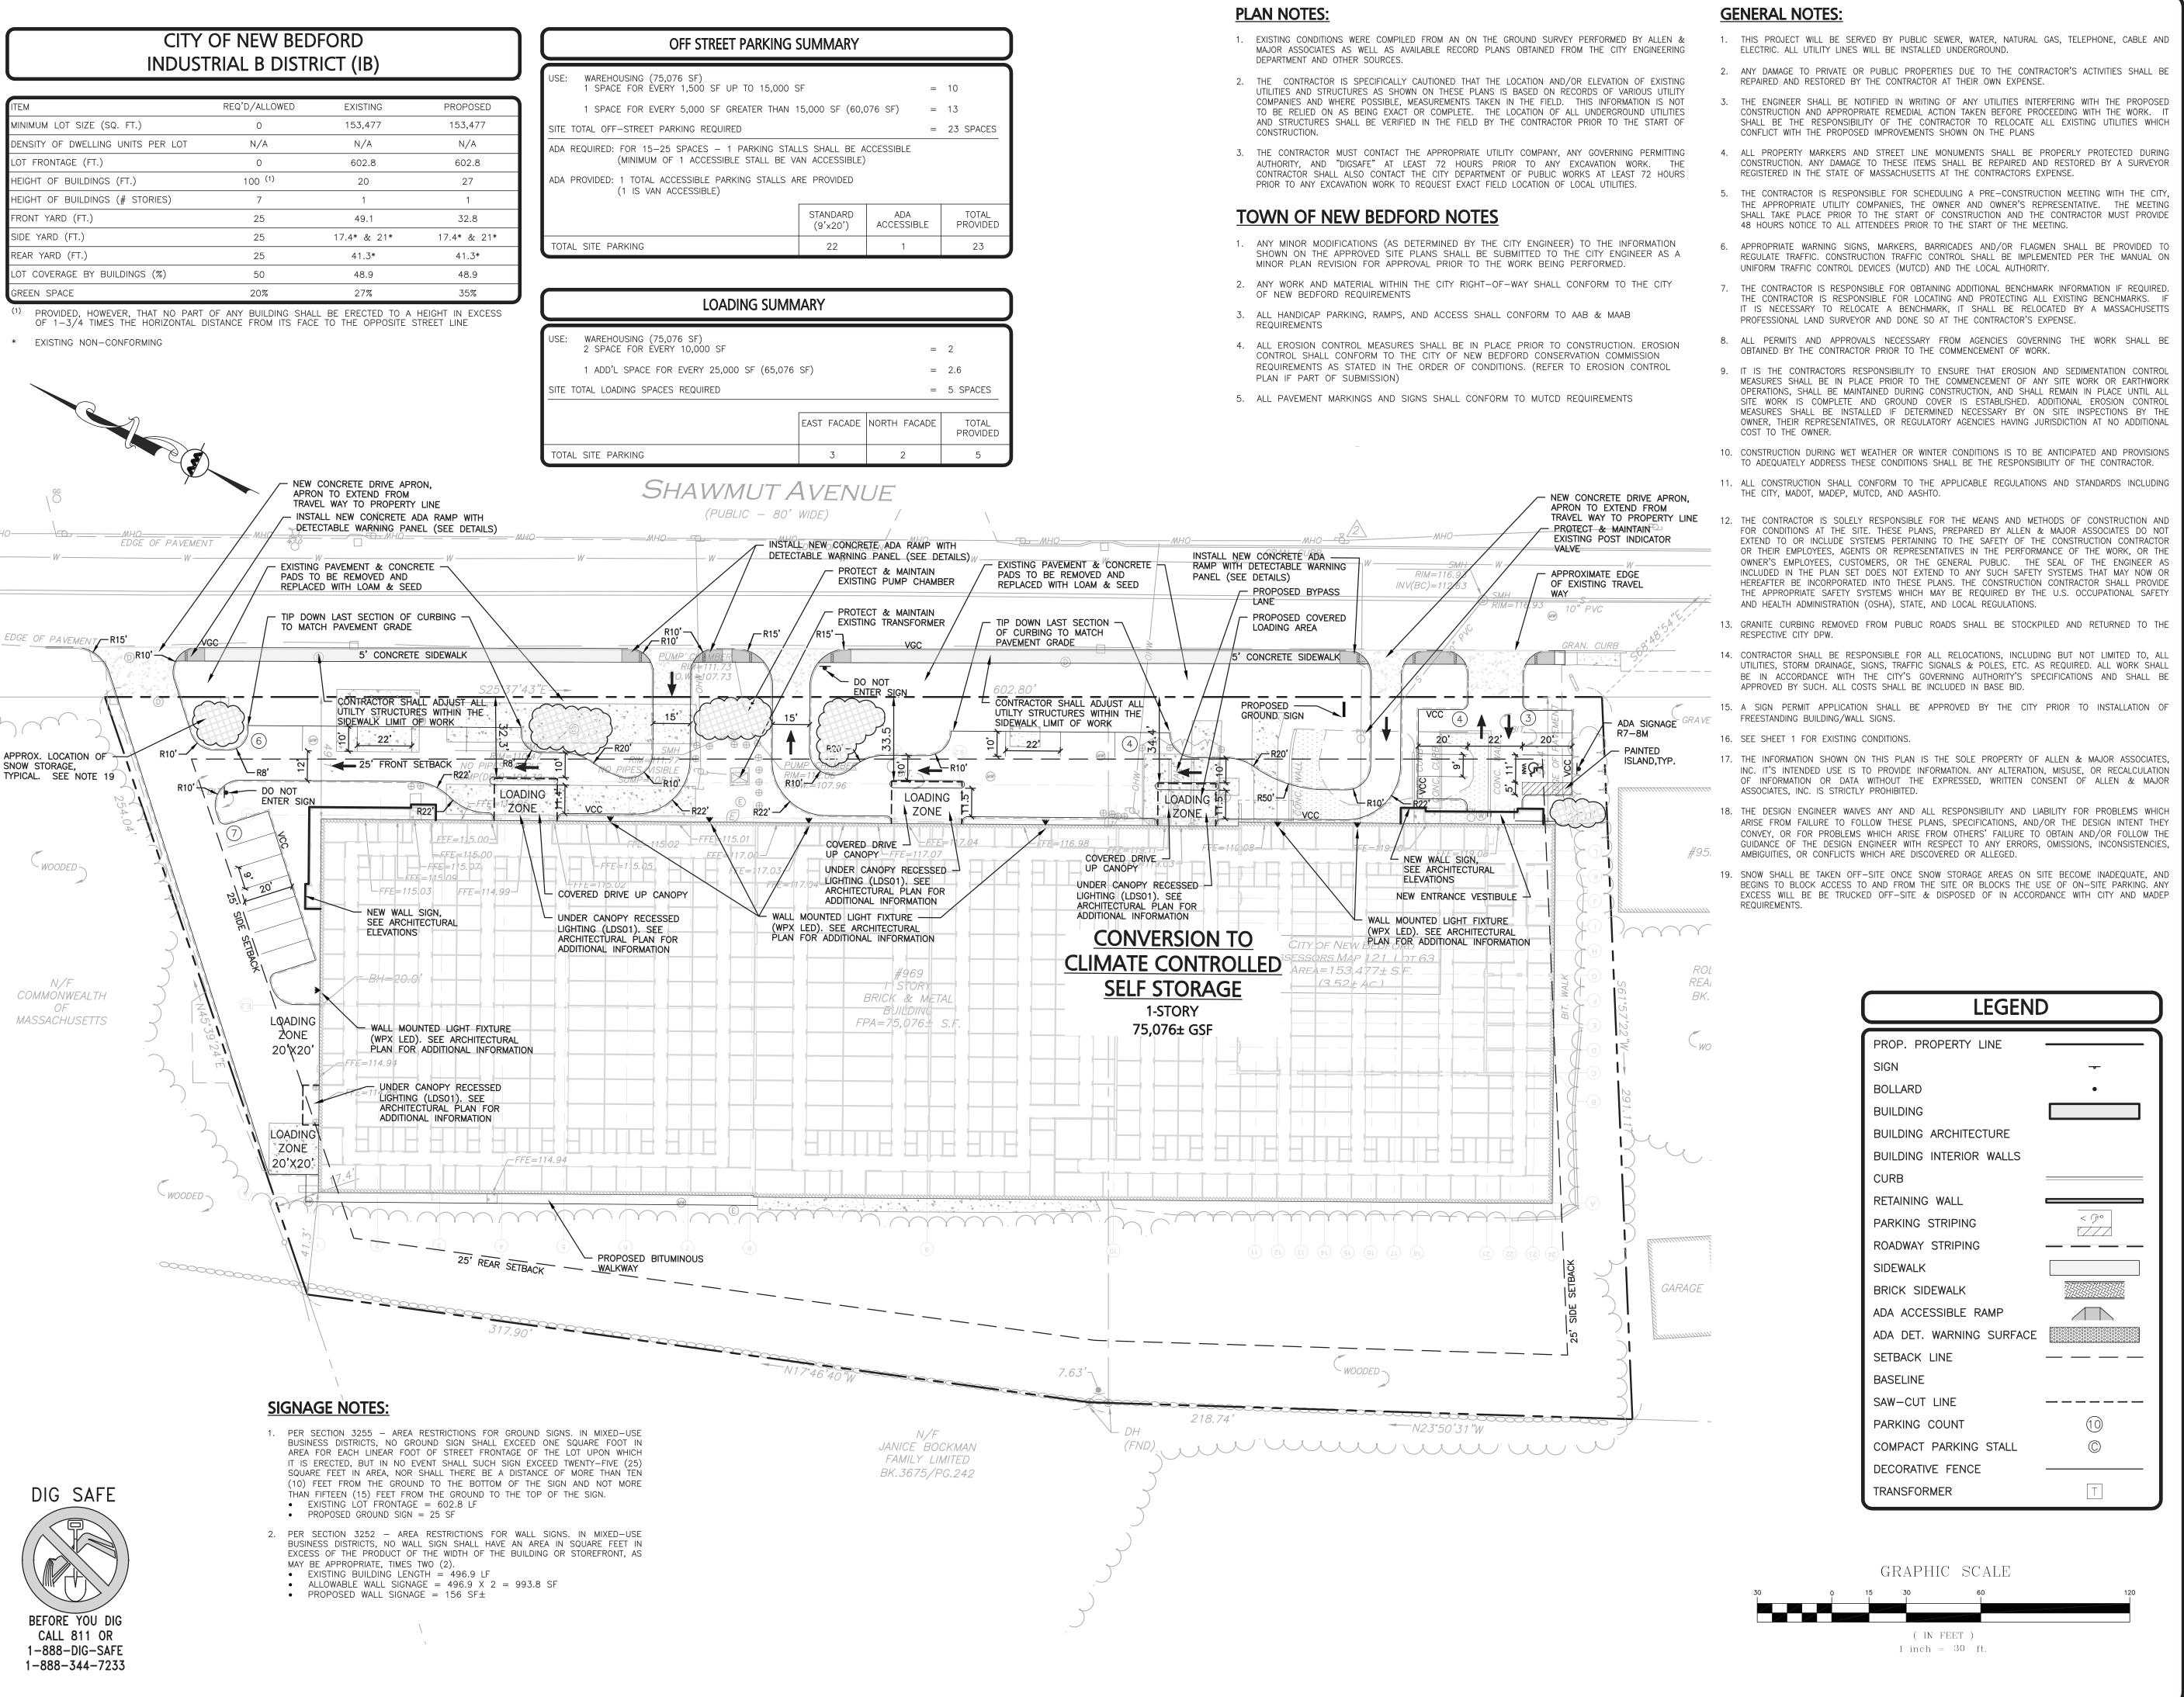
DRAWING TITLE:

SITE PREPARATION PLAN

C-101

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MICHAEL A. MALYNOWSKI CIVIL No. 47269 Digitally signed by Michael Malynows Date: 2021.02.15 13:10:23 -05'00' ENGINEER FOR ALLEN & MAJOR ASSOCIATES, INC.

1 02-12-21 MISC. UPDATES	
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APPLICANT\OWNER:

TRUE STORAGE NEW BEDFORD, LLC 670 N. COMMERCIAL STREET, SUITE 303 MANCHESTER, NH 03101

PROJECT:

COMMERCIAL BUILDING CONVERSION 969 SHAWMUT AVENUE NEW BEDFORD, MA

PROJECT NO. 2038-03 DATE: FEBRUARY 9, 202 SCALE: DWG.: C-2038-03\_LAYOUT & MATERIAL **DRAFTED BY:** MM | CHECKED BY:



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SHEET No. **DRAWING TITLE:** LAYOUT & MATERIALS PLAN | C-102

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#### **GRADING & DRAINAGE NOTES: GENERAL NOTES:** TOPOGRAPHIC INFORMATION AND EXISTING SITE FEATURES WERE OBTAINED FROM AN ACTUAL FIELD SURVEY 1. THE CONTRACTOR SHALL OBTAIN A STREET DISTURBANCE & OBSTRUCTION PERMIT PRIOR TO ANY CONSTRUCTION WITHIN THE PERFORMED BY ALLEN & MAJOR ASSOCIATES, INC, 100 COMMERCE WAY, WOBURN, MASSACHUSETTS. — EXISTING BUILDING THE CONTRACTOR IS SPECIFICALLY CAUTIONED THAT THE LOCATION AND/OR ELEVATION OF EXISTING 2. EXISTING PAVEMENT SHALL BE SAW-CUT AND PAVEMENT JOINT SHALL BE INSTALLED WHERE NECESSARY TO ENSURE A SMOOTH UTILITIES AND STRUCTURES AS SHOWN ON THESE PLANS IS BASED ON RECORDS OF VARIOUS UTILITY CONTINUOUS GRADE. COMPANIES AND WHERE POSSIBLE, MEASUREMENTS TAKEN IN THE FIELD. THIS INFORMATION IS NOT TO BE EXISTING ROOF RELIED ON AS BEING EXACT OR COMPLETE. THE LOCATION OF ALL UNDERGROUND UTILITIES AND LEADER TO REMAIN 4. ALL GRADING OPERATIONS SHALL BE COORDINATED WITH THE APPROPRIATE UTILITY COMPANIES. STRUCTURES SHALL BE VERIFIED IN THE FIELD BY THE CONTRACTOR PRIOR TO THE START OF CONSTRUCTION. THE CONTRACTOR MUST CONTACT THE APPROPRIATE UTILITY COMPANY, ANY GOVERNING 5. IN LANDSCAPED AREAS THE TOP ELEVATION OF MANHOLES SHALL MATCH THE FINISH GRADE OF THE TOPSOIL. IN PAVED AREAS THE PERMITTING AUTHORITY, AND "DIGSAFE" AT LEAST 72 HOURS PRIOR TO ANY EXCAVATION WORK TO CUT IN NEW WYE TOP ELEVATIONS OF MANHOLES SHALL MATCH FINISH GRADE. REQUEST EXACT FIELD LOCATION OF UTILITIES AND THE ENGINEER SHALL BE NOTIFIED IN WRITING OF ANY CONNECTION WITH UTILITIES INTERFERING WITH THE PROPOSED CONSTRUCTION AND APPROPRIATE REMEDIAL ACTION TAKEN OVERFLOW PIPE 6. ALL AREAS DISTURBED DURING CONSTRUCTION SHALL BE STABILIZED AS SOON AS POSSIBLE UPON COMPLETION OF CONSTRUCTION BEFORE PROCEEDING WITH THE WORK. IT SHALL BE THE RESPONSIBILITY OF THE CONTRACTOR TO WORK IN THE AREA. - INSTALL INSECT **LEGEND** RELOCATE ALL EXISTING UTILITIES WHICH CONFLICT WITH THE PROPOSED IMPROVEMENTS SHOWN ON THE SCREEN PLANS AT NO ADDITIONAL COST. 7. TEMPORARY TUBULAR BARRIER PROTECTION AND/OR SILT SACKS SHALL BE INSTALLED AND MAINTAINED AT EXISTING DRAINAGE STRUCTURES DURING CONSTRUCTION, TO PREVENT SEDIMENT LADEN RUNOFF FROM ENTERING THE DRAINAGE SYSTEM. 3. THE CONTRACTOR IS RESPONSIBLE FOR OBTAINING ADDITIONAL BENCHMARK INFORMATION IF REQUIRED. THE DRAIN MANHOLE CONTRACTOR IS RESPONSIBLE FOR LOCATING AND PROTECTING ALL EXISTING BENCHMARKS. IF IT IS 8. ALL CATCH BASINS, MANHOLES, INFILTRATION SYSTEMS, AND WATER QUALITY STRUCTURES ARE TO BE CLEANED TO REMOVE ALL the desirability of the de NECESSARY TO RELOCATE A BENCHMARK, IT SHALL BE RELOCATED BY A MASSACHUSETTS PROFESSIONAL CONSTRUCTION SILT AND DEBRIS PRIOR TO FINAL APPROVAL. CATCH BASIN LAND SURVEYOR AND DONE SO AT THE CONTRACTOR'S EXPENSE. 9. IF ANY EXISTING UTILITY STRUCTURES TO REMAIN ARE DAMAGED DURING CONSTRUCTION, IT SHALL BE THE CONTRACTOR'S 4. CONTRACTOR SHALL BE RESPONSIBLE FOR ALL RELOCATIONS, INCLUDING BUT NOT LIMITED TO, ALL CATCH BASIN - DOUBLE GRATE RESPONSIBILITY TO REPAIR AND/OR REPLACE THE EXISTING STRUCTURE AS NECESSARY TO RETURN IT TO EXISTING CONDITIONS OR UTILITIES, STORM DRAINAGE, SIGNS, & POLES, ETC. AS REQUIRED. ALL WORK SHALL BE IN ACCORDANCE BETTER AT NO ADDITIONAL COST. WITH THE LOCAL MUNICIPALITY'S GOVERNING AUTHORITY'S SPECIFICATIONS AND SHALL BE APPROVED BY OUTLET CONTROL 10. CONTRACTOR SHALL ENSURE POSITIVE DRAINAGE AWAY FROM BUILDINGS FOR ALL NATURAL AND PAVED AREAS. DIVERSION WEIR 5. THE CONTRACTOR SHALL COORDINATE WITH ALL UTILITY COMPANIES TO DETERMINE EXACT POINT OF 11. CONTRACTOR SHALL APPLY STABILIZATION FABRIC TO ALL SLOPES STEEPER THAN 3H:1V. 4" SOLID WALL PVC PIPE, SERVICE CONNECTION AND DISCONNECTION AT EXISTING UTILITY. WATER QUALITY UNIT CONNECT TO PROPOSED 12. ALL DRAINAGE SYSTEM COMPONENTS SHALL CONFORM TO LOCAL REQUIREMENTS. ROOF DRAIN MANIFOLD AREA DRAIN 13. WHERE AN EXISTING UTILITY IS FOUND TO CONFLICT WITH THE PROPOSED WORK, THE LOCATION, ELEVATION AND SIZE OF THE UTILITY SHALL BE ACCURATELY DETERMINED WITHOUT DELAY BY THE CONTRACTOR, AND THE INFORMATION FURNISHED TO THE ENGINEER FOR FLARED END SECTION 16. IT IS THE RESPONSIBILITY OF THE CONTRACTOR TO REVIEW ALL DRAWINGS AND SPECIFICATIONS ASSOCIATED WITH THE PROJECT WORK DRAIN LINE SCOPE PRIOR TO THE START OF CONSTRUCTION. SHOULD THE CONTRACTOR FIND A CONFLICT WITH THE DRAWINGS, SPECIFICATIONS, OR **ROOF LEADER OVERFLOW CONNECTION DETAIL** RELATIVE CODES, IT IS THE RESPONSIBILITY OF THE CONTRACTOR TO NOTIFY THE ENGINEER AND/OR ARCHITECT PRIOR TO START OF RIPRAP OUTFALL 5050505 CONSTRUCTION. FAILURE BY THE CONTRACTOR TO NOTIFY THE ENGINEER AND/OR ARCHITECT SHALL CONSTITUTE ACCEPTANCE OF FULL NOT TO SCALE RESPONSIBILITY BY THE CONTRACTOR TO COMPLETE THE SCOPE OF WORK AND/OR DESIGN INTENT OF THE DRAWINGS AND IN FULL HEADWALL COMPLIANCE WITH LOCAL REGULATIONS AND CODES. 5' CONTOUR 17. THE DESIGN ENGINEER WAIVES ANY AND ALL RESPONSIBILITY AND LIABILITY FOR PROBLEMS WHICH ARISE FROM FAILURE TO FOLLOW THESE PLANS, SPECIFICATIONS, AND/OR THE DESIGN INTENT THEY CONVEY, OR FOR PROBLEMS WHICH ARISE FROM OTHERS' FAILURE TO 1' CONTOUR OBTAIN AND/OR FOLLOW THE GUIDANCE OF THE DESIGN ENGINEER WITH RESPECT TO ANY ERRORS, OMISSIONS, INCONSISTENCIES, AMBIGUITIES, OR CONFLICTS WHICH ARE DISCOVERED OR ALLEGED. SPOT GRADE ×119.10 INFILTRATION SYSTEM INFILTRATION PIPE SHAWMUT AVENUE -INSTALL IMPERMEABLE MEMBRANE DETENTION PIPE -INSTALL IMPERMEABLE MEMBRANE ALONG LIMITS OF EXCAVATION ALONG LIMITS OF EXCAVATION (PUBLIC - 80' WIDE) ADJACENT TO DOWNWARD SLOPE UNDERDRAIN ADJACENT TO DOWNWARD SLOPE - tNV.=104.0-FLOW DIRECTION $\Longrightarrow$ ADJUST CB-EDGE OF PAVEMENT -PROPOSED INFILTRATION -PROPOSED INFILTRATION RIM=105.5 TRENCH #2, SEE DETAIL TRENCH #2, SEE DETAIL /RIM=116.93 CORE DRILL FOR NEW INLET TOP STONE=VARIES TOP STONE=VARIES INV.=102.5 INV(BC) = 112.63/\_/INV.=111.0 BOT STONE=VARIES BOT STONE=VARIES STONE DEPTH=4FT MIN. STONE DEPTH=4FT MIN. INV(a) = 98.16ÀDJUST DMH⊸ -OBSERVATION PORT, $^{ar{2}}$ ADJUST SMH OBSERVATION PORT, INV(b) = 98.63RIM=112 RIM = 105.2TYPICAL, RIM = 113.0TYPICAL. INV(c)≥99.73 INV(a) = 107.EDGE OF PAKEMEN $\leftarrow \rightarrow - \rightarrow$ **√** FFE=17.04 FFE 1 19.08 LFFE-1 ADJUST /STRUCTURE - INSTALL IMPERVIOUS CHECK #953 TO GRADE DAM AFTER EACH OBSERVATION PORT & DOWNSTREAM END. INSTALL IMPERVIOUS CHECK CHECK DAM TO BE 6" WIDE DAM AFTER EACH OBSERVATION -CONNECT EXISTING BUILDING BY 18" TALL PORTFE& 1 DOWNSTREAM = END 99 GUTTER DOWN SPOUTS TO ROOF DRAIN MANIFOLD CHECK DAM TO BE 6" WIDE BY 18" TALL **CONVERSION TO** CLIMATE CONTROLLED RODNEY STREET #969 REAL ESTATE LLC **SELF STORAGE** BK.10278/PG.81 N/F BRICK & META COMMONWEALTH 1-STORY FPA=75.076± S. 75,076± GSF *MASSACHUSETTS* DIG SAFE JANICE BOCKMAN FAMILY LIMITED BK.3675/PG.242 GRAPHIC SCALE BEFORE YOU DIG CALL 811 OR ( IN FEET ) 1-888-DIG-SAFE 1 inch = 30 ft.1-888-344-7233

MICHAEL A MALYNOWSKI CIVIL No. 47269

Digitally signed by Michael Date: 2021.02.15 13:09:29 -05'00

PROFESSIONAL ENGINEER FOR ALLEN & MAJOR ASSOCIATES, INC.

02-12-21 MISC. UPDATES PER TOWN COMMENTS

APPLICANT\OWNER:

REV DATE DESCRIPTION

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2038-03 DATE: FEBRUARY 9, 2021 PROJECT NO. SCALE:

1" = 30' DWG. : C-2038-03\_GRADING & DRAINAG

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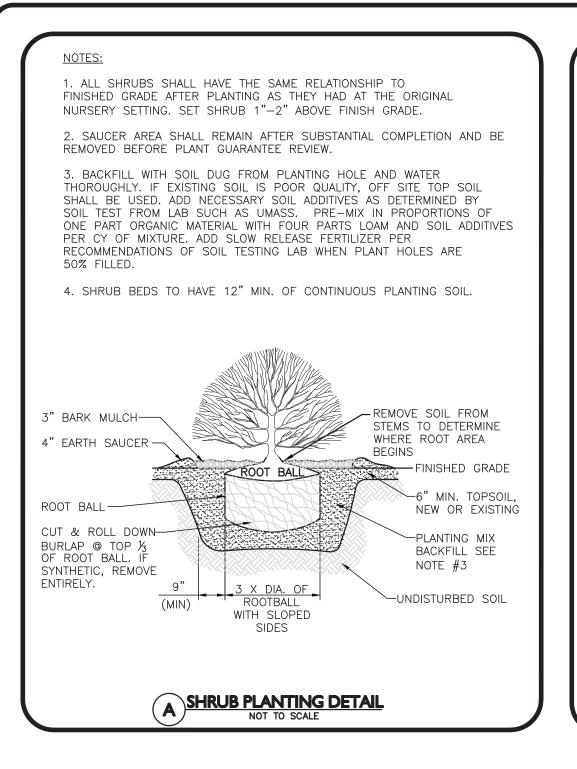
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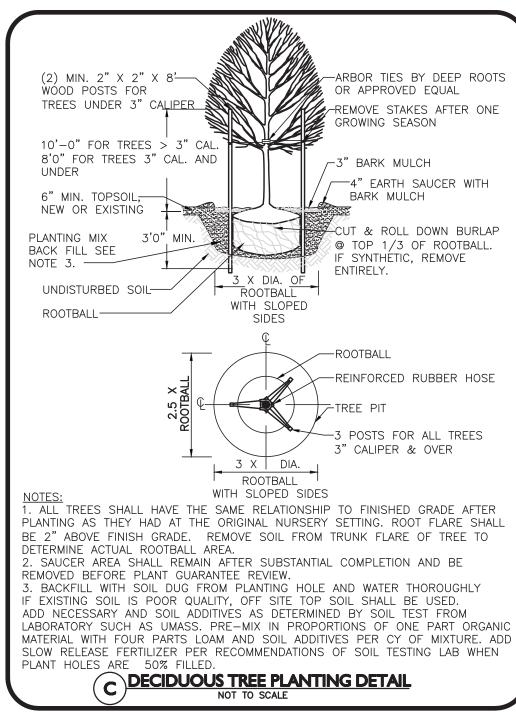
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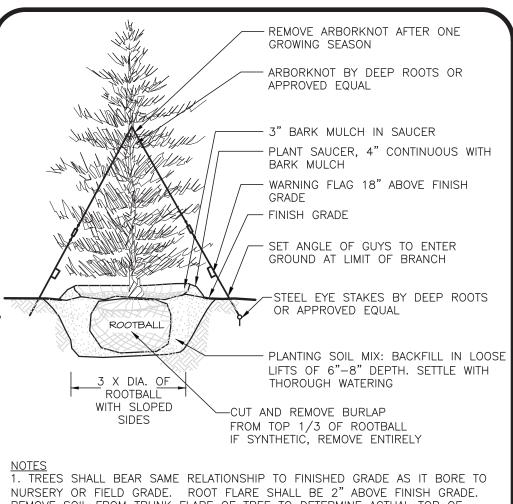
**DRAWING TITLE:** 

GRADING & DRAINAGE PLAN | C-103


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REMOVE SOIL FROM TRUNK FLARE OF TREE TO DETERMINE ACTUAL TOP OF ROOTBALL AREA. 2. INSTALL THREE GUYS PER TREE: EQUALLY SPACED AROUND BALL 3. ATTACH GUYS AT 2/3 HEIGHT OF TREE. 4. SAUCER AREA SHALL REMAIN AFTER SUBSTANTIAL COMPLETION AND BE REMOVED BEFORE PLANT GUARANTEE REVIEW. . BACKFILL WITH SOIL DUG FROM PLANTING HOLE AND WATER THOROUGHLY IF EXISTING SOIL IS POOR QUALITY, OFF SITE TOP SOIL SHALL BE USED. ADD NECESSARY AND SOIL ADDITIVES AS DETERMINED BY SOIL TEST AND PRE-MIX IN PROPORTIONS OF ONE PART ORGANIC MATERIAL WITH FOUR PARTS LOAM AND SOIL ADDITIVES PER CY OF MIXTURE. ADD SLOW RELEASE FERTILIZER PER SOIL TESTING LAB RECOMMENDATIONS WHEN PLANT HOLES ARE 50% FILLED. **D**EVERGREEN TREE DETAIL



DEBRIS NOR CONTAIN TOXIC SUBSTANCES. 3. THE CONTRACTOR SHALL PROVIDE THE OWNER / LANDSCAPE ARCHITECT WITH PLANTING SOIL TEST RESULTS FOR APPROVAL PRIOR TO OBTAINING AND PLACING THE SOIL. IF THE PLANTING SOIL DOES NOT FALL WITHIN THE REQUIRED SIEVE ANALYSIS, ORGANIC CONTENT, OR PH RANGE, IT SHALL BE ADJUSTED TO MEET THE SPECIFICATIONS THROUGH THE


4. PLANTING SOIL SHALL HAVE A PH VALUE BETWEEN 5.5 AND 6.5. TOPSOIL SHALL CONTAIN BETWEEN 5% AND 12% ORGANIC MATTER OF TOTAL DRY WEIGHT AND SHALL CONFORM TO THE FOLLOWING GRADATION ABOVE.

ADDITION OF SAND, COMPOST, LIMESTONE, OR ALUMINUM

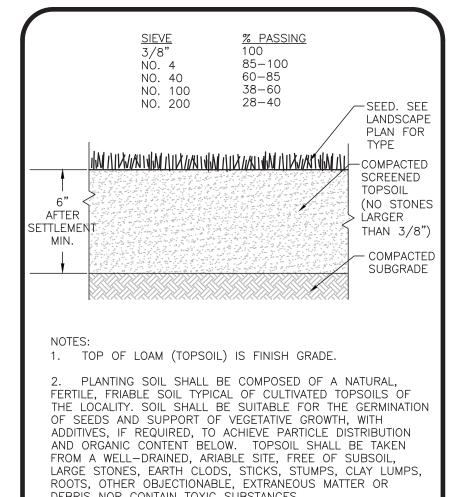SULFATE TO BRING IT WITHIN THE SPECIFIED LIMITS AT NO

**E LOAM & SEED LAWN DETAIL** 

ADDITIONAL COST TO THE OWNER.

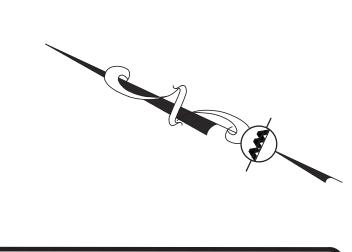

### **LEGEND**

DECIDUOUS TREE A July Mark **EVERGREEN TREE** 

FLOWERING TREE

SHRUBS 

MULCH BED

PERENNIALS/GROUNDCOVER WILDFLOWER SEED MIX

EROSION CONTROL SEED MIX

MICHAEL A. MALYNOWSKI CIVIL No. 47269 Digitally signed by Michael Malynowsk Date: 2021.02.15 13:08:23 -05'00' PROFESSIONAL ENGINEER FOR ALLEN & MAJOR ASSOCIATES, INC.

02-12-21 MISC. UPDATES PER TOWN COMMENTS

DATE DESCRIPTION APPLICANT\OWNER:

> TRUE STORAGE NEW BEDFORD, LLC 670 N. COMMERCIAL STREET, SUITE 303 MANCHESTER, NH 03101

**COMMERCIAL BUILDING CONVERSION** 969 SHAWMUT AVENUE

NEW BEDFORD, MA

ALLEN & MAJOR

ASSOCIATES, INC.

civil engineering ♦ land surveying

www.allenmajor.com 100 COMMERCE WAY, SUITE 5 WOBURN MA 01801 TEL: (781) 935-6889 FAX: (781) 935-2896

VOBURN, MA ♦ LAKEVILLE, MA ♦ MANCHESTER, NE

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nvironmental consulting ♦ landscape architecture

2038-03 DATE: FEBRUARY 9, 2021 PROJECT NO.

SCALE: 1" = 30' DWG. : C-2038-03\_LANDSCAPI **DRAFTED BY:** MM | CHECKED BY:


10. ANY FALL TRANSPLANTING HAZARD PLANTS SHALL BE DUG IN THE SPRING AND STORED FOR FALL PLANTING.

MULCH. GROUND COVER AREAS SHALL RECEIVE 1" OF PINE BARK MULCH

HAVE A BRANCHING PATTERN TO ALLOW FOR A MINIMUM OF 7' OF CLEARANCE BETWEEN THE GROUND AND THE LOWEST BRANCH.



1 inch = 30 ft.

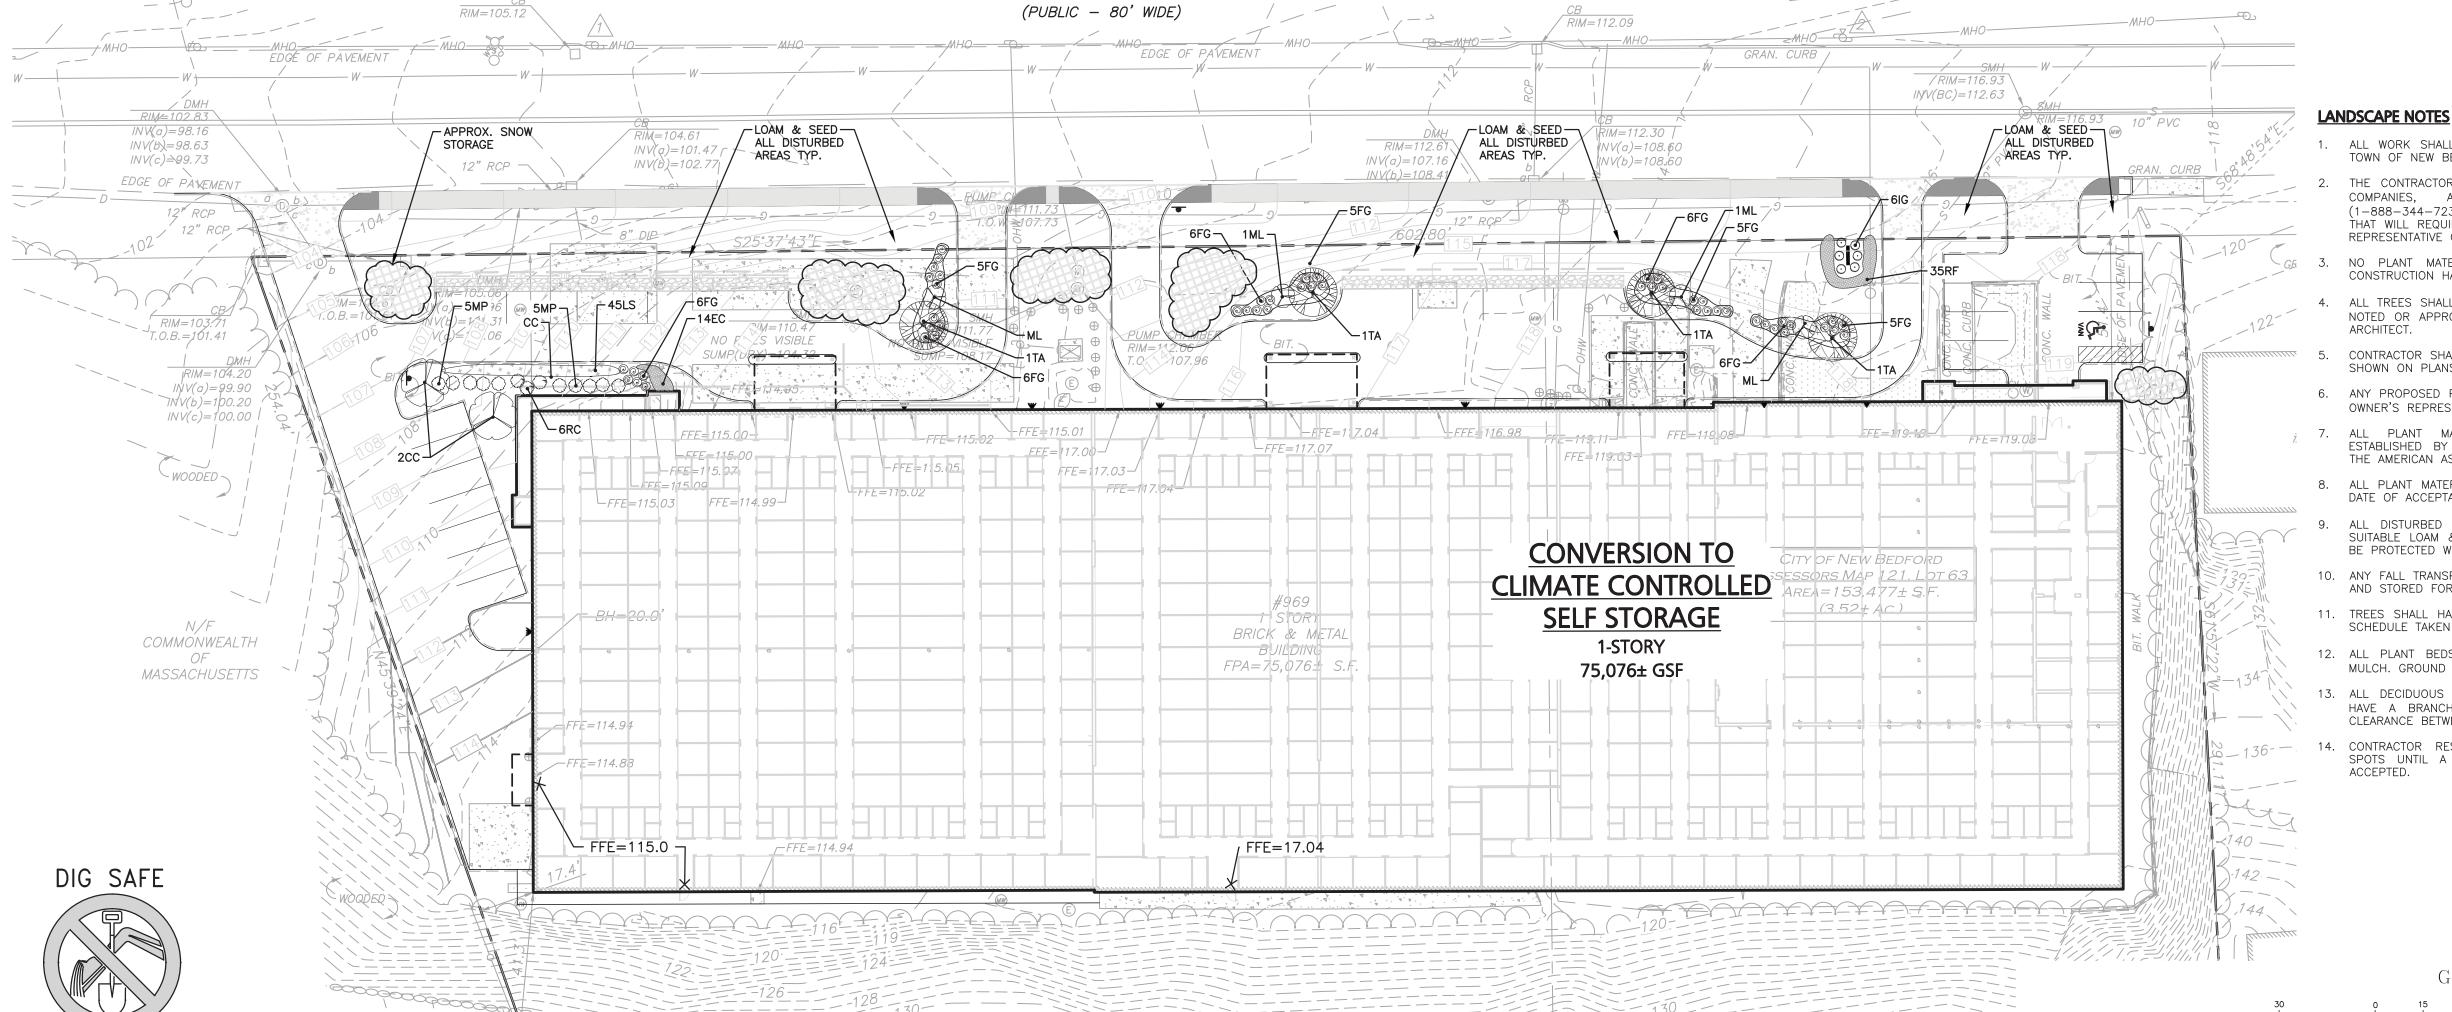

SHAWMUT AVENUE

ALL WORK SHALL BE IN ACCORDANCE WITH THE REQUIREMENTS OF THE

TOWN OF NEW BEDFORD. THE CONTRACTOR SHALL BE RESPONSIBLE FOR CONTACTING ALL UTILITY COMPANIES, ANY PERMITTING AGENCIES, AND "DIG-SAFE" (1-888-344-7233) AT LEAST 72 HOURS IN ADVANCE OF ANY WORK THAT WILL REQUIRE EXCAVATION. CONTRACTOR SHALL NOTIFY THE OWNERS REPRESENTATIVE OF NAY CONFLICTS IN WRITING.

NO PLANT MATERIAL SHALL BE INSTALLED UNTIL ALL GRADING AND CONSTRUCTION HAS BEEN COMPLETED IN THE IMMEDIATE AREA

ALL TREES SHALL BE BALLED AND BURLAPPED (B&B) UNLESS OTHERWISE NOTED OR APPROVED BY THE OWNER'S REPRESENTATIVE AND LANDSCAPE

CONTRACTOR SHALL VERIFY QUANTITIES SHOWN ON PLANT LIST. QUANTITIES SHOWN ON PLANS SHALL GOVERN OVER PLANT LIST.

6. ANY PROPOSED PLANT SUBSTITUTIONS MUST BE APPROVED IN WRITING BY OWNER'S REPRESENTATIVE AND LANDSCAPE ARCHITECT. 7. ALL PLANT MATERIALS INSTALLED SHALL MEET THE GUIDELINES ESTABLISHED BY THE STANDARDS FOR NURSERY STOCK PUBLISHED BY

THE AMERICAN ASSOCIATION OF NURSERYMEN. 8. ALL PLANT MATERIALS SHALL BE GUARANTEED FOR ONE YEAR FOLLOWING DATE OF ACCEPTANCE.

ALL DISTURBED AREAS NOT OTHERWISE NOTED SHALL RECEIVE 6" OF SUITABLE LOAM & SEED LAWNS WITH 3:1 OR GREATER SLOPES SHALL BE PROTECTED WITH AN EROSION CONTROL BLANKET.

11. TREES SHALL HAVE A MINIMUM CALIPER AS INDICATED ON THE PLANTING SCHEDULE TAKEN ONE FOOT ABOVE THE ROOT CROWN.

12. ALL PLANT BEDS AND TREE SAUCERS TO RECEIVE 3" OF PINE BARK 13. ALL DECIDUOUS TREES ADJACENT TO WALKWAYS AND ROADWAYS SHALL

CONTRACTOR RESPONSIBLE FOR WATERING, AND RESEEDING OF BARE SPOTS UNTIL A UNIFORM STAND OF VEGETATION IS ESTABLISHED AND


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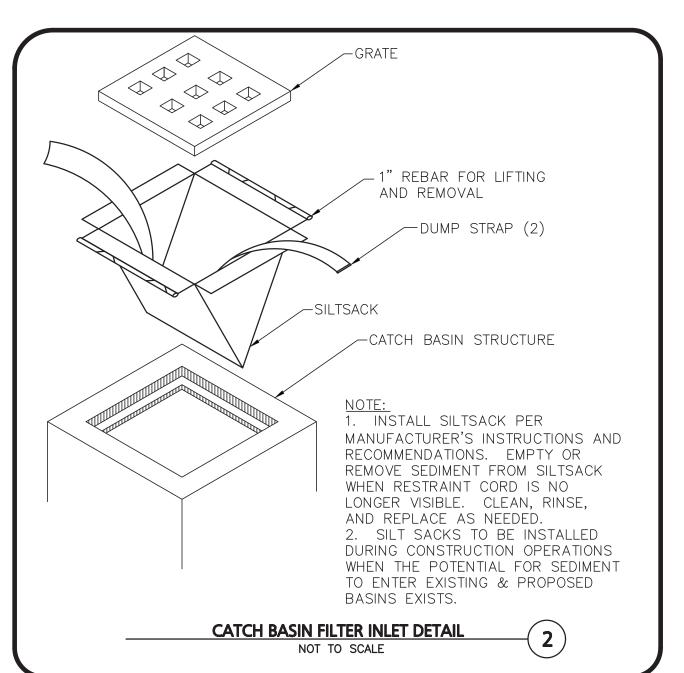
LANDSCAPE PLAN


BEFORE YOU DIG CALL 811 OR 1-888-DIG-SAFE 1-888-344-7233



- 1. ALL MATERIALS TO MEET MANUFACTURERS SPECIFICATIONS.
- 2. INSTALL WOODEN STAKES IN A CRISS-CROSS PATTERN EVERY 8' ON CENTER.
- 2. OVERLAP TUBULAR BARRIER SEGMENTS A MINIMUM OF 12".
- 3. THE CONTRACTOR SHALL MAINTAIN THE TUBULAR BARRIERS IN A FUNCTIONAL CONDITION AT ALL TIMES. THE CONTROLS SHALL BE ROUTINELY INSPECTED BY THE CONTRACTOR.
- 4. WHERE THE TUBULAR BARRIERS REQUIRE REPAIR OR SEDIMENT REMOVAL, IT WILL BE COMPLETED BY THE CONTRACTOR AT NO ADDITIONAL COST.
- 5. AT A MINIMUM, THE CONTRACTOR SHALL REMOVE SEDIMENTS COLLECTED AT THE BASE WHEN THEY REACH 1/3 THE EXPOSED HEIGHT OF THE BARRIER.




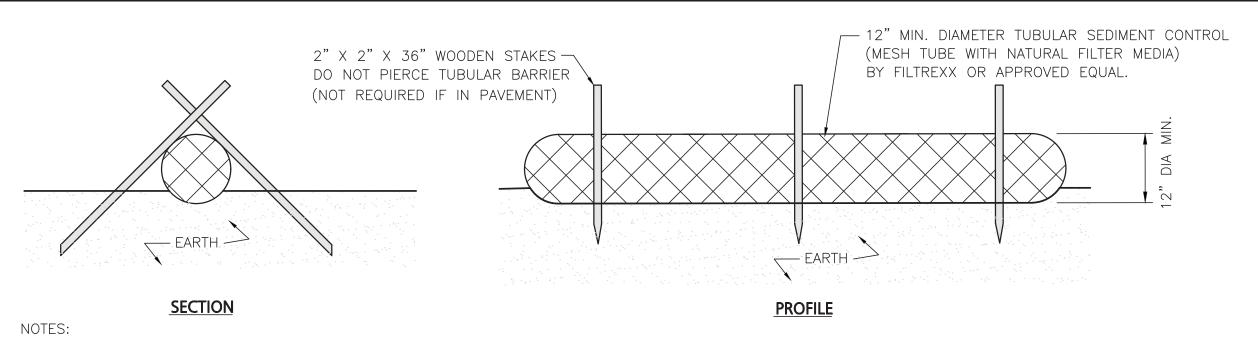

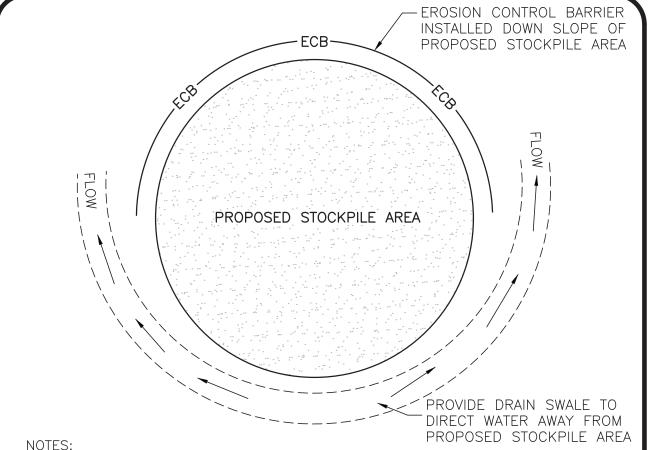


1. SOIL AND FILL STOCKPILES EXPECTED TO REMAIN IN PLACE FOR LESS THAN 90 DAYS SHALL BE COVERED WITH STRAW AND MULCH (AT 100LBS/1,000 SF), OR WITH AN ANCHORED TARP WITHIN 7 DAYS OR PRIOR TO ANY RAINFALL. 2. SOIL AND FILL STOCKPILES EXPECTED TO REMAIN IN PLACE FOR 90 DAYS OR MORE SHALL BE SEEDED WITH WINTER RYE (FOR FALL SEEDING AT 1LB/1,000 SF) OR OATS (FOR SUMMER SEEDING AT 2LB/1,000 SF) AND THEN COVERED WITH STRAW MULCH (AT 100LB/1,000 SF) OR AN ANCHORED TARP WITHIN 7 DAYS OR PRIOR TO ANY RAINFALL.

> STOCKPILE PROTECTION DETAIL NOT TO SCALE

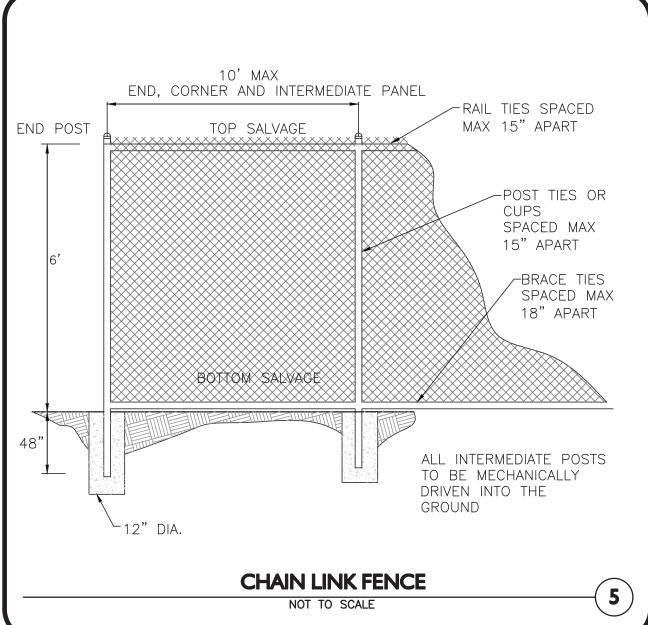

- MINIMUM BURIAL DEPTH (FINISH GRADE TO TOP OF PIPE) GRAVITY PIPE (SEWER & DRAIN) - SEE PLAN OR PROFILE PRESSURE PIPÈ UNDER PAVING - 4' PRESSURE PIPE BENEATH UNPAVED - 3' WATER PIPE - 5'
- WHERE BACKFILL IS DESIGNATED AS COMPACTED, THIS MEANS 90 TO 95% STANDARD PROCTOR. AASHTO T-99. ALL FILL PLACED BELOW PIPES AND STRUCTURES MUST MEET THIS REQUIREMENT.
- TRENCHES WITHIN PUBLIC RIGHT OF WAY MAY REQUIRE FLOWABLE FILL. VERIFY WITH MUNICIPAL ENGINEER.
- WHERE WASTE FILLS ARE ENCOUNTERED AT SUBGRADE LEVEL FOR NEW UTILITIES, THE FILL SHOULD BE OVER-EXCAVATED, THE SUBGRADE SHOULD BE RE-COMPACTED, AND BACKFILL CONSISTING OF PIPE BEDDING MATERIAL, CRUSHED STONE OR OTHER SUITABLE GRANULAR FILL SHOULD BE PLACED TO A SUFFICIENT DEPTH TO CREATE A FIRM AND STABLE SUBGRADE (TYPICALLY 12 TO 18 INCHES OVER-EXCAVATION).
- 5. REFER TO PAVING, CURBS, WALKS AND DRIVEWAY DETAILS.
- 6. REFER TO LANDSCAPING DETAILS.

	FILTER FA	BRIC USE
	SOIL	TYPE
	SILT OR CLAY	GRANULAR SOIL
ABOVE GROUND WATER	FILTER FABRIC NOT REQUIRED	FILTER FABRIC NOT REQUIRED
BELOW GROUND WATER	FILTER FABRIC REQUIRED	FILTER FABRIC NOT REQUIRED
•		

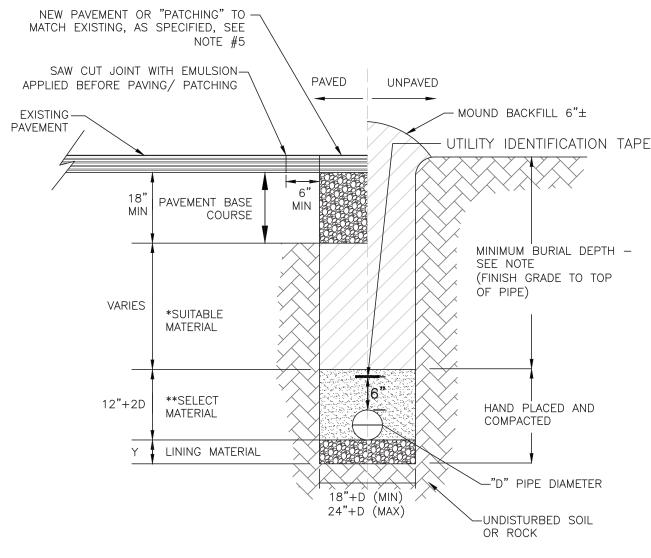

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DUCTILE IRON "ORDINARY SOIL"	TYPE I, II, OR III	SAND OR TYPE III	3"
RCP "ORDINARY SOIL"	TYPE II OR III	SAND OR TYPE III	3"
ALL PIPE OVER BEDROCK OR LEDGE	TYPE II OR III	SAND OR TYPE III	12"
DUCTILE IRON IN CLAY OR MUCK	TYPE II OR III	SAND	4"
RCP IN CLAY	TYPE II OR III	SAND	8"
ALL PLASTICS	TYPE III	SAND OR TYPE III	6"

CONDITION & PIPE | \*\*SELECT MATERIAL | LINING MATERIAL | Y-DIMENSION


SUITABLE MATERIAL SHALL CONTAIN NO STONE GREATER THAN 4" IN DIAMETER, NO FROZEN LUMPS, AND ONLY MINOR AMOUNTS OF CLAY OR ORGANIC MATERIAL. ALL MATERIAL TO BE


\*\*TYPE I MATERIAL SHALL BE EITHER GRAVEL OR EXCAVATED MATERIAL CONTAINING NO STONES GREATER THAN 1.5" DIAMETER, NO FROZEN LUMPS, CLAY OR ORGANIC MATERIAL. \*\*TYPE II MATERIAL SHALL BE CLEAN, HARD, CRUSHED OR NATURAL STONE WITH A GRADATION BY WEIGHT OF 100% PASSING A 1.5" SQUARE OPENING, NOT MORE THAN 25% PASSING A 3"


OPENING, AND NOT MORE THAN 5% PASSING A  $\frac{1}{2}$ " SQUARE OPENING. \*\*TYPE III MATERIAL SHALL BE CLEAN, HARD, CRUSHED STONE FREE FROM COATINGS AND THOROUGHLY WASHED WITH A GRADATION BY WEIGHT OF 100% PASSING A 1" SQUARE OPENING, AND 0 TO 5% PASSING A 4" SQUARE OPENING.


_( <b>5</b> )	WAIER	REQUIRED	NOT REQUIRED	TRENCH DETAIL	
				NOT TO SCALE	<u> </u>




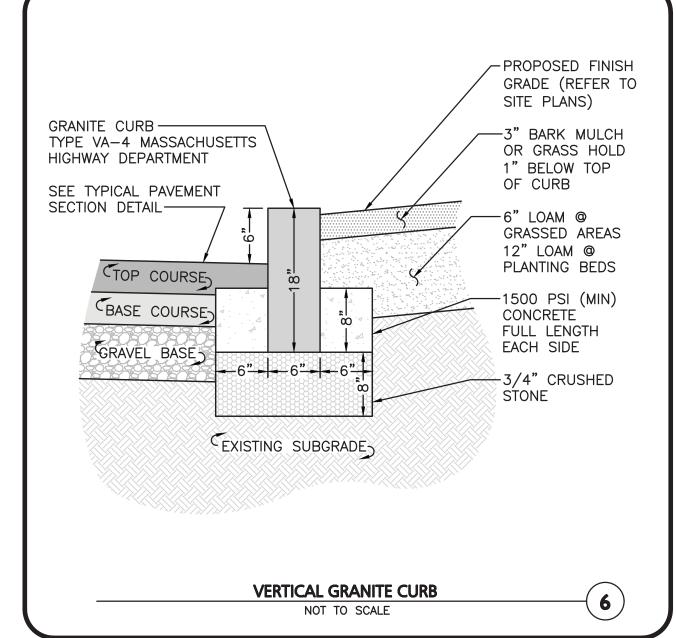

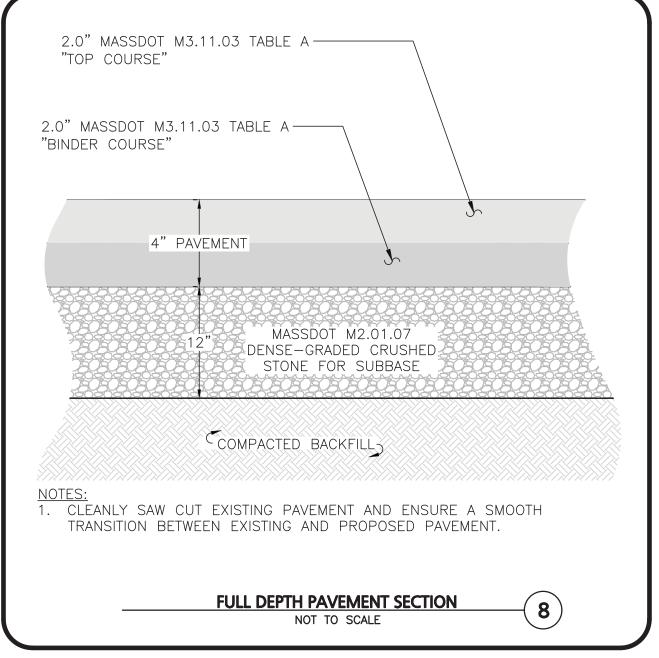

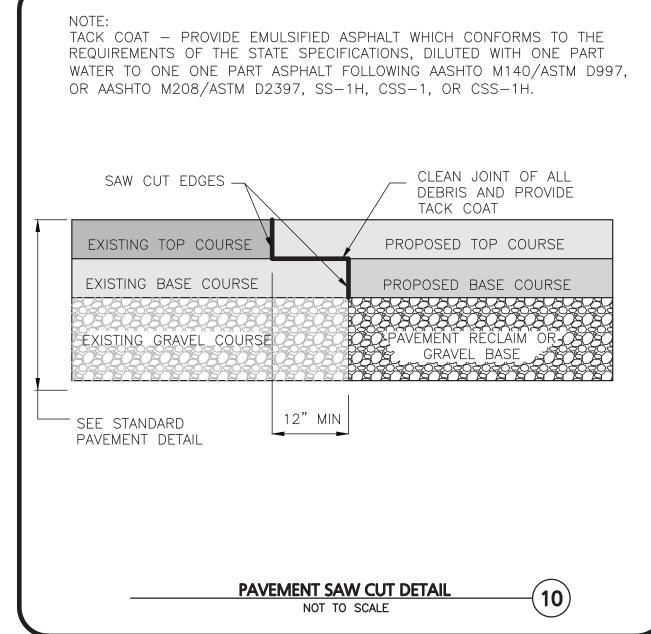

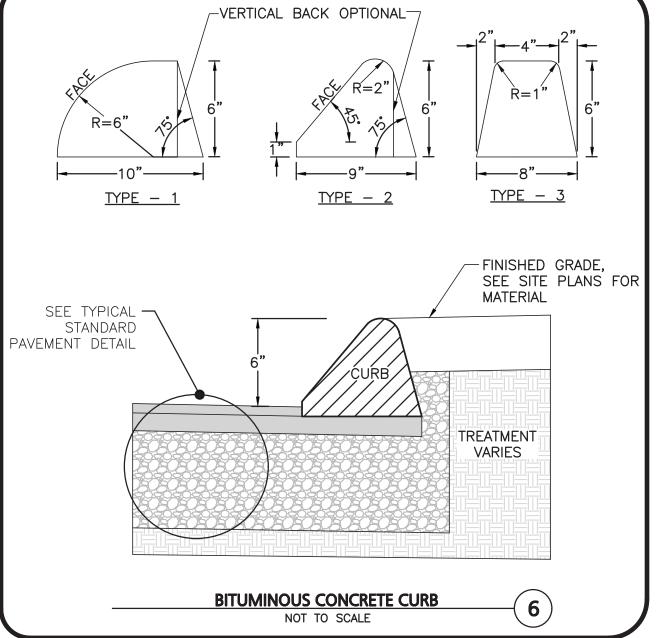

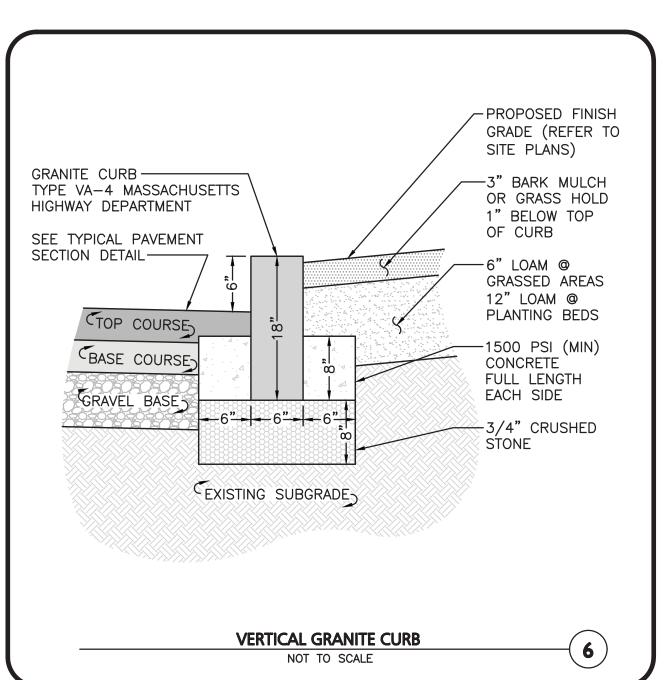

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**DRAWING TITLE:** 

MALYNOWSKI

CIVIL No. 47269

PROFESSIONAL ENGINEER FOR

REV DATE DESCRIPTION

MANCHESTER, NH 03101

APPLICANT\OWNER:

PROJECT:

PROJECT NO.

DRAFTED BY:

SCALE:

ALLEN & MAJOR ASSOCIATES, INC.

Digitally signed by Michael Malynowsk

Date: 2021.02.15 13:12:37 -05'00'

02-12-21 MISC. UPDATES PER TOWN COMMENTS

TRUE STORAGE NEW BEDFORD, LLC

COMMERCIAL BUILDING

CONVERSION

969 SHAWMUT AVENUE

NEW BEDFORD, MA

ALLEN & MAJOR

ASSOCIATES, INC.

civil engineering • land surveying

environmental consulting • landscape architecture

www.allenmajor.com 100 COMMERCE WAY, SUITE 5

WOBURN MA 01801

TEL: (781) 935-6889

FAX: (781) 935-2896

WOBURN, MA ♦ LAKEVILLE, MA ♦ MANCHESTER, N

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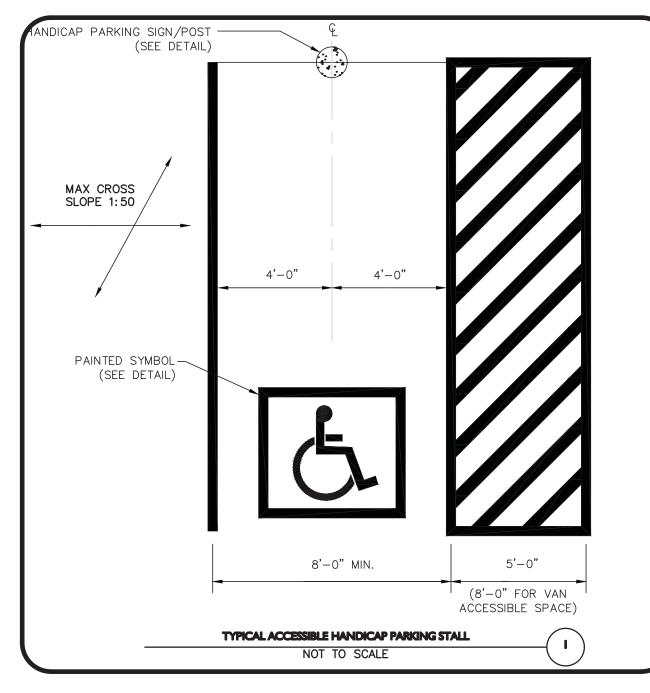
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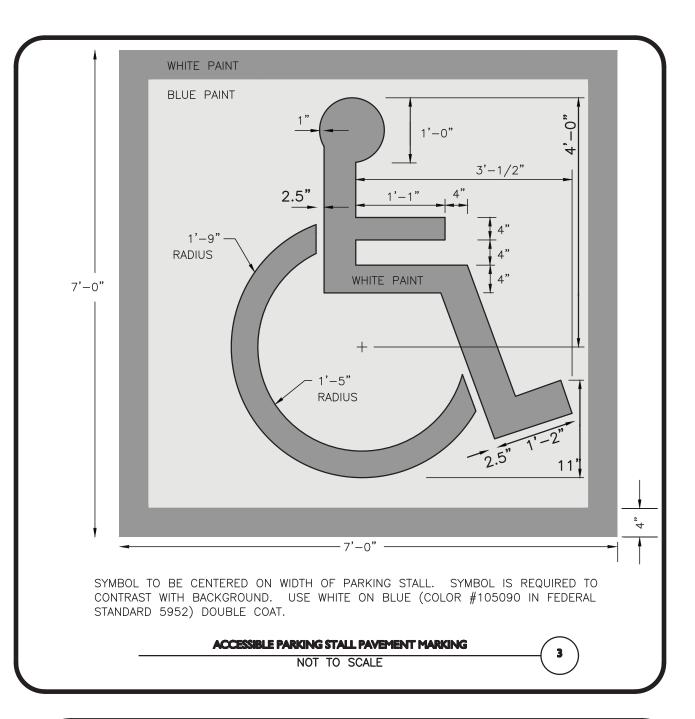
2038-03 DATE: FEBRUARY 9, 202


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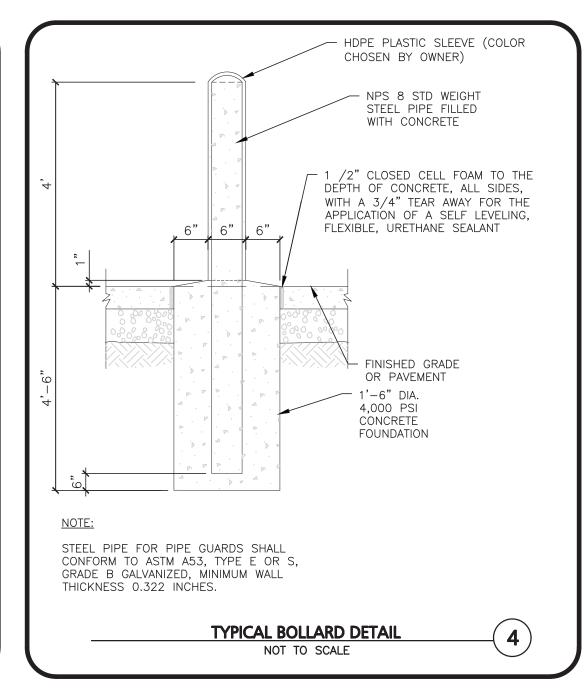
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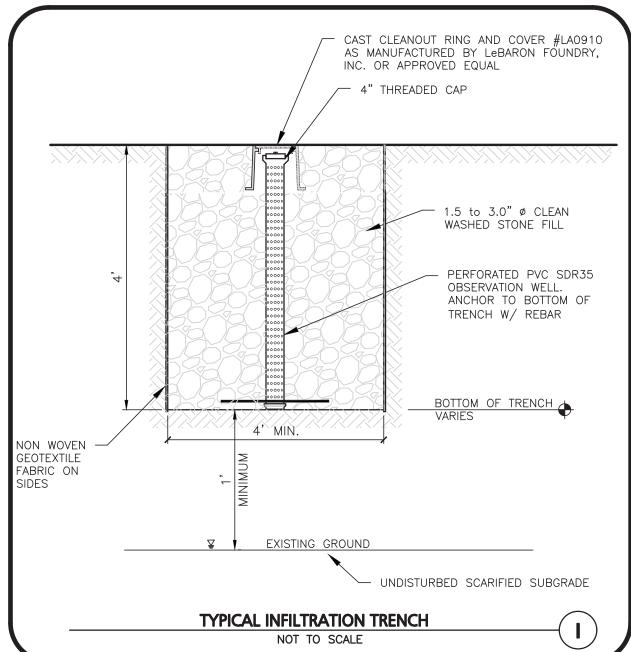
670 N. COMMERCIAL STREET, SUITE 303













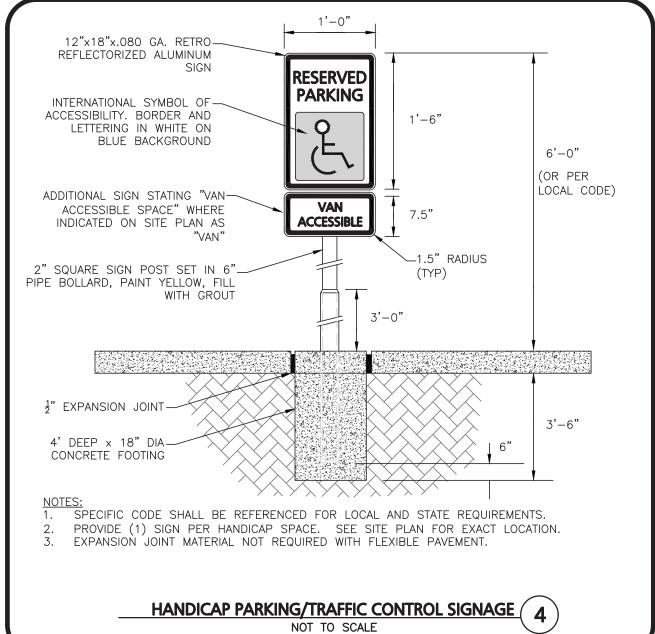

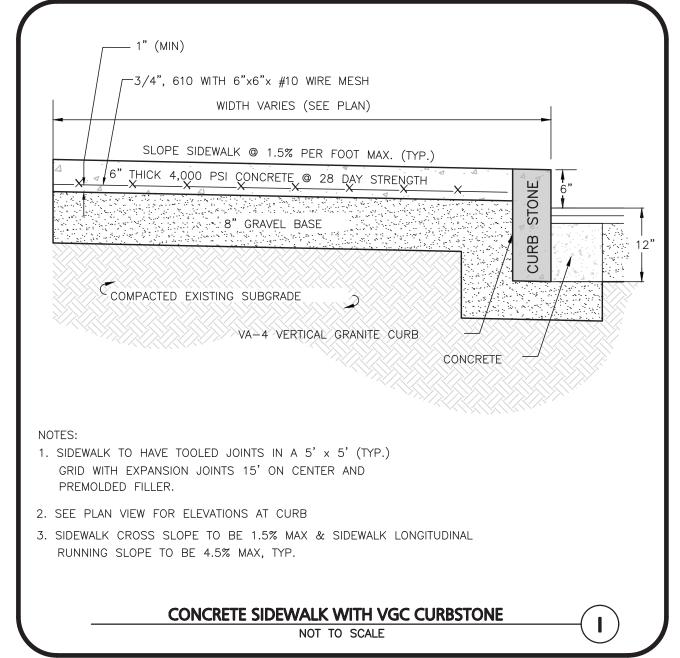

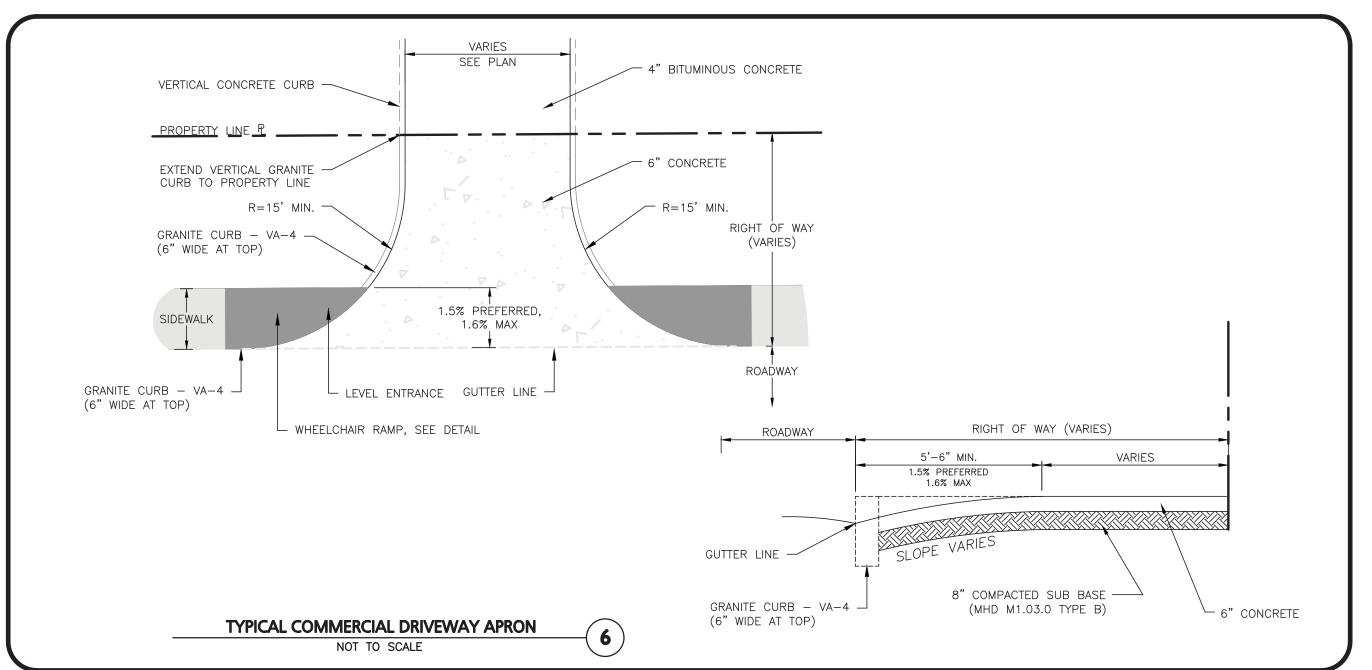

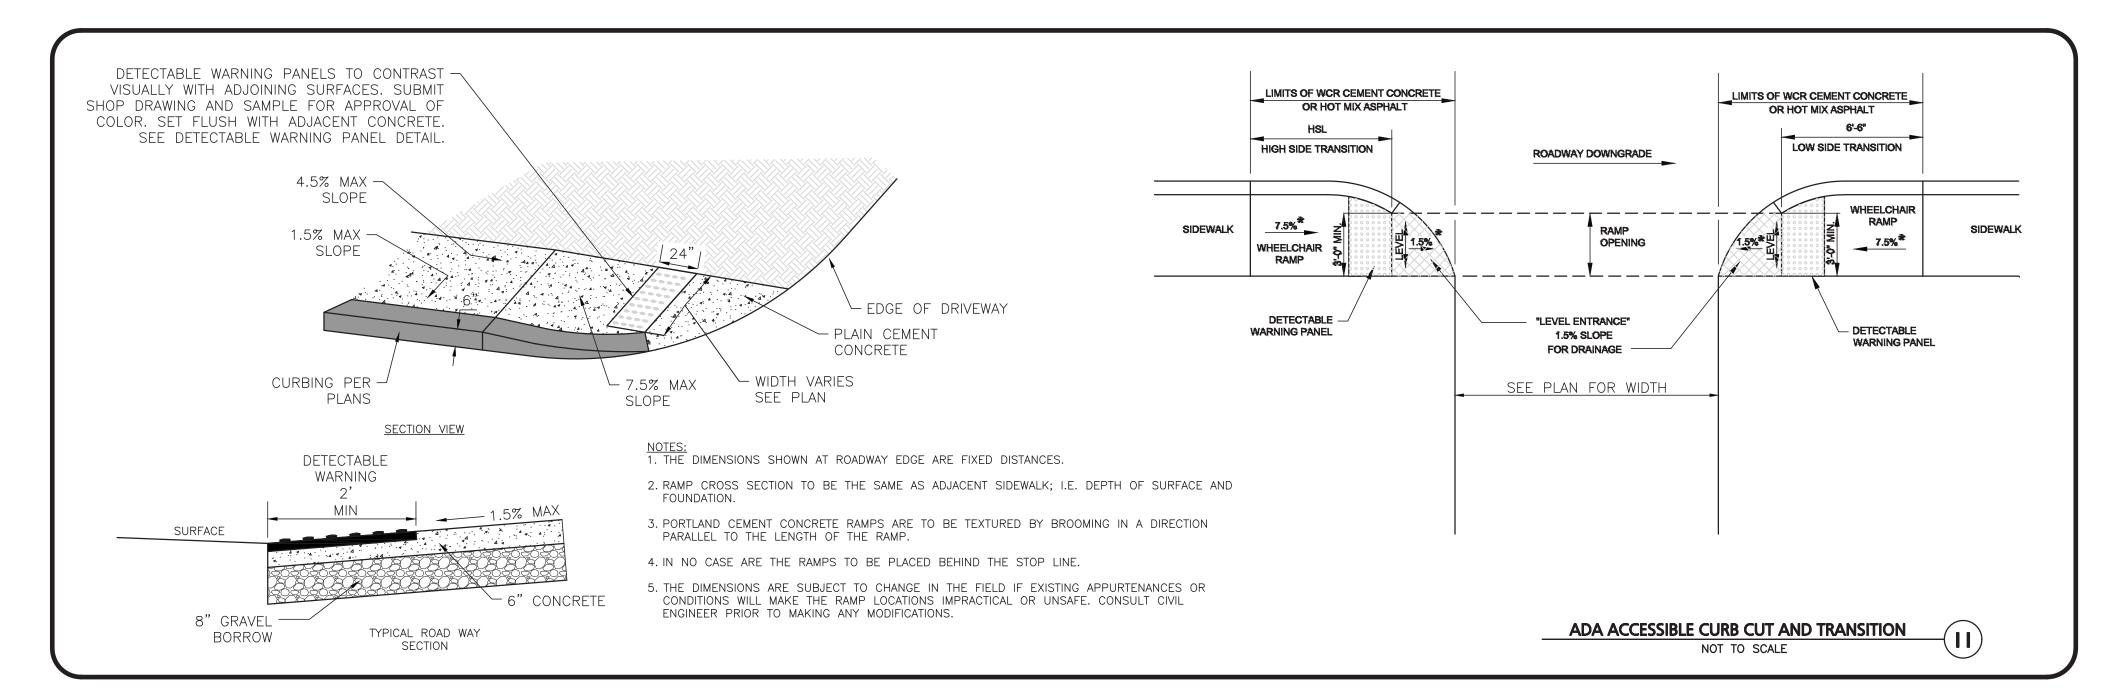

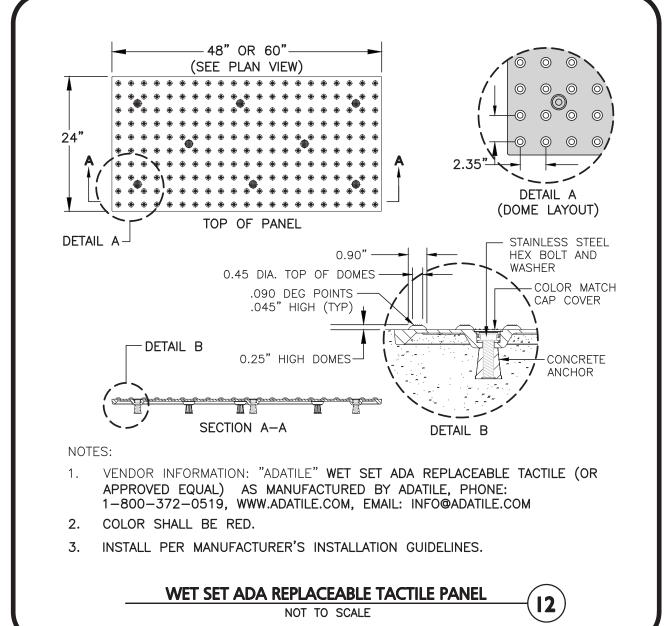



PROFESSIONAL ENGINEER FOR ALLEN & MAJOR ASSOCIATES, INC.

<u> </u>	02-12-21	MISC. UPDATES PER TOWN COMMEN
REV	DATE	DESCRIPTION

APPLICANT\OWNER:

TRUE STORAGE NEW BEDFORD, LLC 670 N. COMMERCIAL STREET, SUITE 303 MANCHESTER, NH 03101

PROJECT:

COMMERCIAL BUILDING
CONVERSION
969 SHAWMUT AVENUE
NEW BEDFORD, MA

PROJECT NO. 2038-03 DATE: FEBRUARY 9, 2021

SCALE: AS SHOWN DWG.: C-2038-03\_DETAILS

DRAFTED BY: MM CHECKED BY: MAM



ASSOCIATES, INC.

civil engineering • land surveying
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100 COMMERCE WAY, SUITE 5

WOBURN MA 01801

TEL: (781) 935-6889

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