


1250 SHAWMUT AVE 2.522 MWDC / 999.0 KWAC PV TOTAL SYSTEM 1.0MW / 6.0 MWH ENERGY STORAGE TOTAL RATING

PROPOSED COMMERCIAL SOLAR CARPORT SYSTEM									
SYSTEM SIZE				2.5 MW DC SYSTEM					
				2.66 MW AC SYSTEM					
TOTAL QTY. OF SOLAR MODULES			;	5,864 QTY. HANWHA SOLAR MODULES (430W)					
TOTAL QTY. OF INVERTERS				1 QTY. SMA CENTRAL INVERTER (SMA_SC 2660 UP-US)					
TOTAL AREA. OF PV ARRAY				143,557 SQ. FT.±					
ARRAY	MODULE QTY.	DC SIZE	AZIMUTH	TILT	AREA	SOLAR MODULES	SOLAR INVERTER		
							QTY.	DESCRIPTION	
Α	4,933	2,121.200 KW	142	3°	120,277 SQ.FT.±	HANWHA SOLAR 430W	1	CENTRAL INVERTER	
В	931	400.300 KW	142	3°	23,280 SQ.FT.±	HANWHA SOLAR 430W			



LOCATION MAP

SCALE: NTS

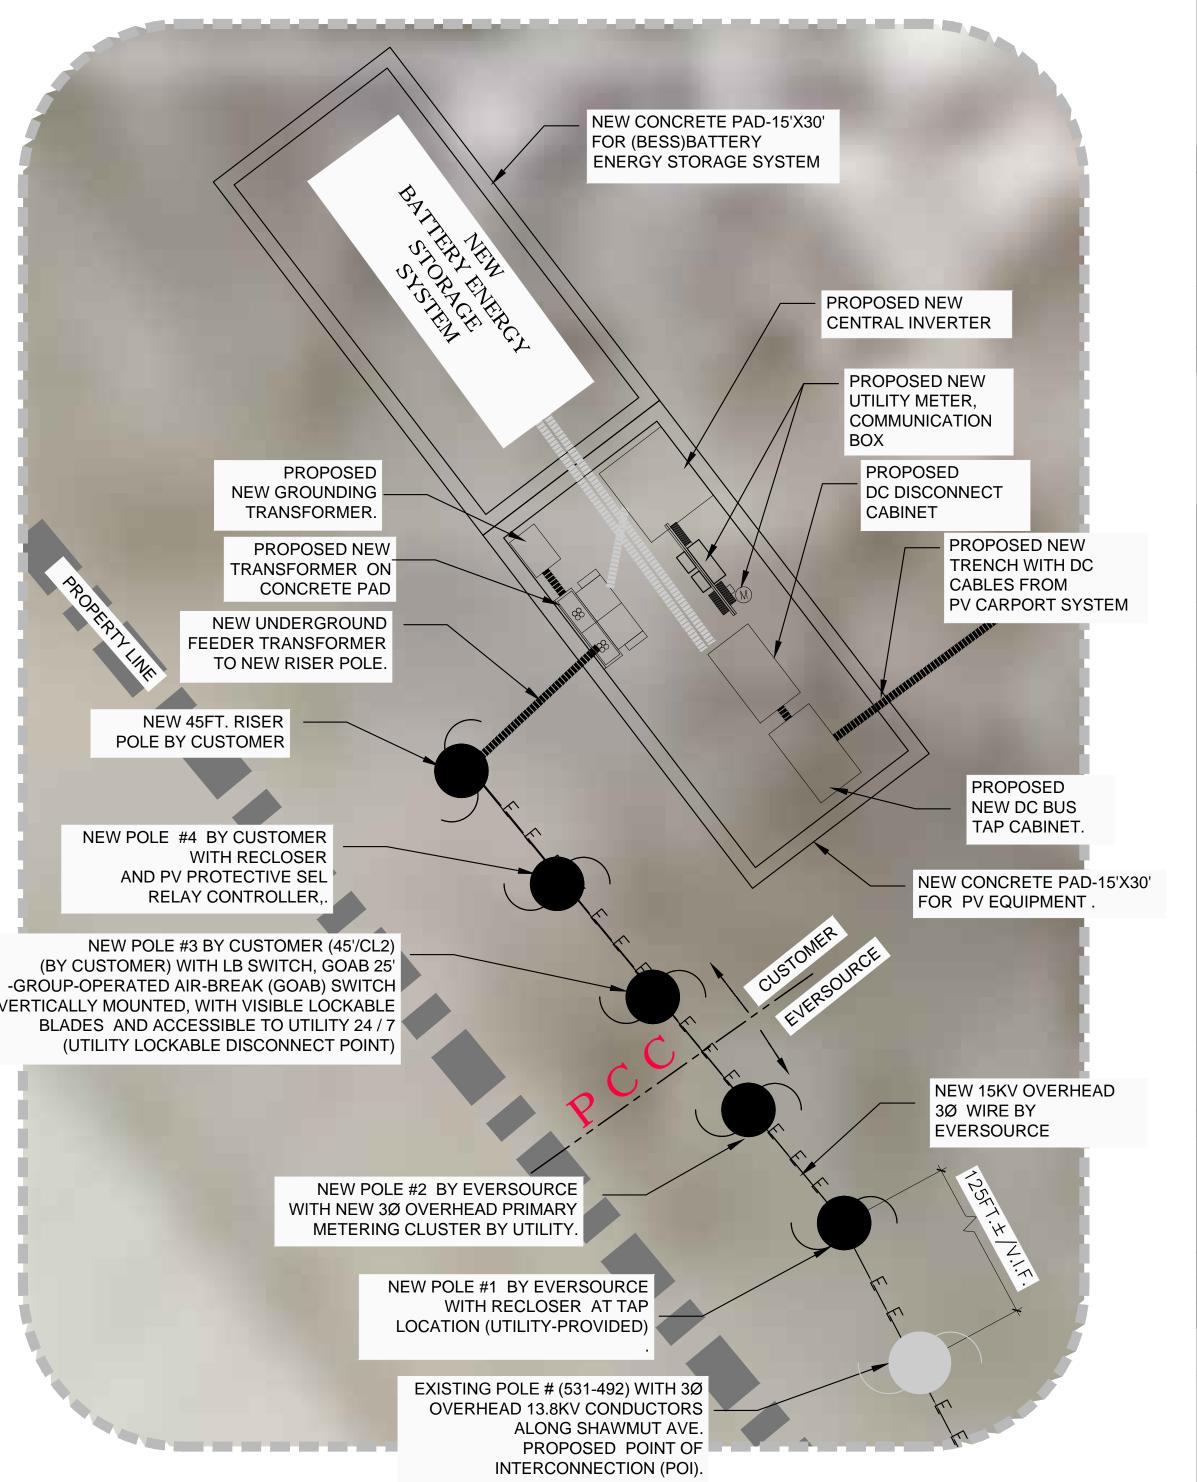

ENLARGED EQUIPMENT PAD AND PCC LOCATION

CLIENT:

PARALLEL PRODUCTS SOLAR ENERGY ,LLC

100 DUCHAINE BLVD. NEW BEDFORD, MA 02745

ENGINEER:

PROJECT NAME: JOB #:


1260 SHAWMUT AVE. SOLAR CARPORT

AGGREGATE AC KW NAMEPLATE RATING 2.66 MWAC

SITE OWNER:

SHAWMUT REALTY,LLC

1250 SHAWMUT AVE. NEW BEDFORD, MA 02746

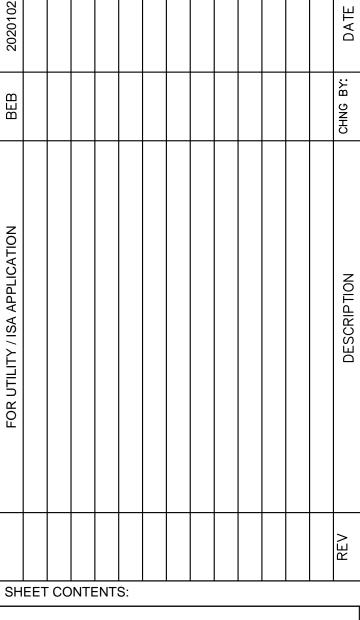

OVER-ALL SITE PLAN

NOT FOR CON	STRUCTION	PV1					
SCALE:	AS SHOWN	SHEET NO.					
CHECKED:	N/A	DATE:					
DRAWN:	BEB	DATE: 10-16-2020					

PARALLEL PRODUCTS SOLAR ENERGY,LLC

THIS DESIGN IS THE PROPERTY OF PARALLEL PRODUCTS SOLAR ENERGY,LLC

ALL PRODUCTION AND DUPLICATION RIGHTS ARE RESERVED BY PARALLEL PRODUCTS SOLAR ENERGY,LLC.THIS PRINT IS DESIGNED FOR YOUR PERSONAL USE AND IS NOT TO BE USED OUTSIDE YOUR ORGANIZATION OR EXHIBITED IN ANY FASHION.

OCTOBER 21, 2020