

SOLAR CANOPY
FOR
PARALLEL PRODUCTS
AT
GOYETTE'S AUTO PARTS
1260 SHAWMUT AVE
NEW BEDFORD, MA 02746

RBI SOLAR

Total Solar Service: Design * Fabrication
Installation * Parts * Repair Service

5513 VINE STREET
CINCINNATI, OH 45217
513.242.2051
FAX: 513.242.0816

PROFESSIONAL SEAL

ENGINEER'S SEAL APPLIES TO DESIGN
OF STRUCTURAL COMPONENTS ONLY



RBI SOLAR IS NOT
RESPONSIBLE FOR
CONSTRUCTION THAT IS
BUILT FROM SET LABELED
"NOT FOR CONSTRUCTION"

SOLAR CANOPY
FOR
PARALLEL PRODUCTS

RELEASE RECORD

7	12/06/21	INTERNAL REVIEW
6	08/13/21	50% REVIEW (R1)
5	07/22/21	30% REVIEW (R3)
4	07/22/21	30% REVIEW (R2)
3	07/15/21	30% REVIEW (R1)
2	07/08/21	30% REVIEW
1	06/30/21	50% REVIEW
MARK	DATE	DESCRIPTION

PROJECT INFORMATION

TITLE & ADDRESS:
GOYETTE'S AUTO PARTS

1260 SHAWMUT AVE
NEW BEDFORD, MA 02746

RBI SOLAR PROJECT No.:
2170063


DRAWN BY: WCC
REVIEWED BY: -

SHEET TITLE:

COVER SHEET

SHEET No.:
SC001

SYMBOLS LEGEND

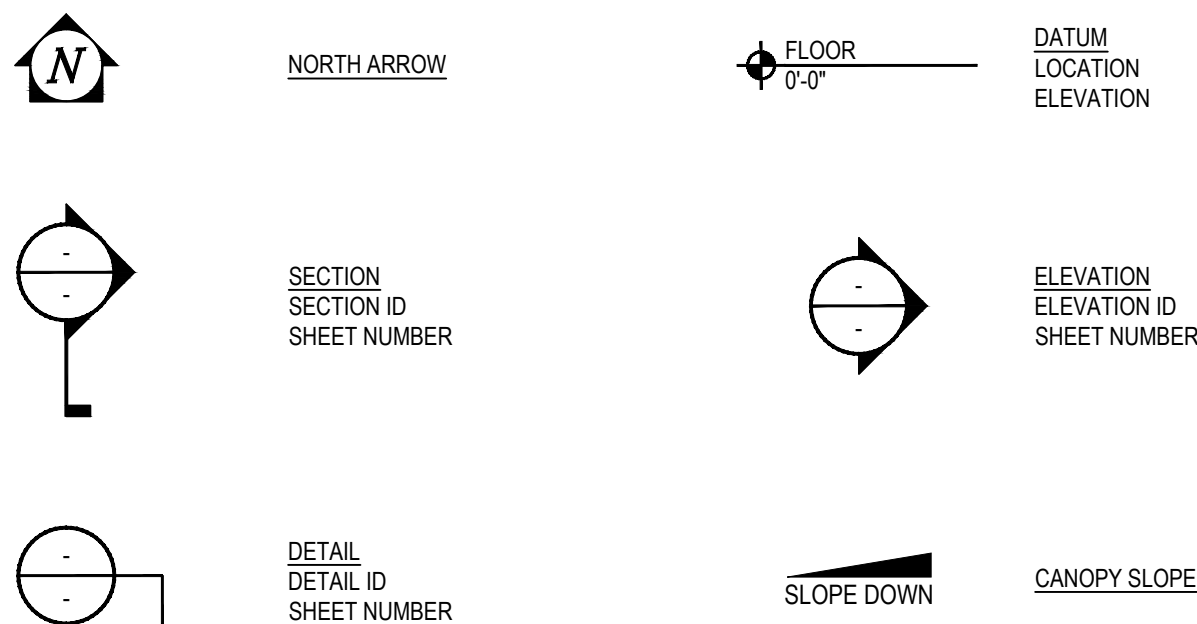


GOVERNING CODE

- MA STATE BUILDING CODE, 9TH EDITION
- CONSTRUCTION TYPE:** IIB
- RISK CATEGORY:** II
- DESIGN LOADS:**
- DEAD LOADS:
 - STRUCTURE: 5.0 PSF
 - GLAZING: 3.0 PSF
 - Σ = 8.0 PSF
 - ROOF LIVE LOAD = 12 PSF
 - SNOW LOAD:
 - P_g = 30 PSF (GROUND SNOW)
 - P_f = XX.X PSF (ROOF SNOW)
 - C_d = 0.9
 - C_e = 1.2
 - I_s = 1.00
 - WIND LOAD: (MAIN WIND FORCE RESISTING SYSTEM)
 - V_{ult} = 129 MPH
 - V_{bst} = 100 MPH
 - I_w = 1.00
 - EXPOSURE: B
 - SEISMIC: (LOADS PARALLEL AND PERPENDICULAR TO CANOPY FRAMES)
 - S_s = 0.192
 - S_1 = 0.053
 - S_{ds} = 0.205
 - S_{d1} = 0.085
 - I_e = 1.00
 - SITE CLASS: D
 - SEISMIC DESIGN CATEGORY: B
 - SEISMIC FORCE RESISTING SYSTEM =
CANTILEVERED COLUMN SYSTEM
 - DESIGN BASE SHEAR: V = 1.312 PSF
 C_u = 0.164
 R = 1.25
 - EQUIVALENT LATERAL FORCE ANALYSIS

SOLAR CANOPY SYSTEM SPECIFICATIONS

PV MODULE TYPE	: TRINA SOLAR	ACTIVE PV MODULES	: 4666
MODULE MODEL #	: VERTEX 550W	SPARE PV MODULES	: -
ARRAY TYPE	: FIXED TILT	TOTAL PV MODULES	: 4666
ARRAY TILT	: 5 DEGREES	TOTAL WATTS	: 2,566.3 kW DC

VICINITY MAP

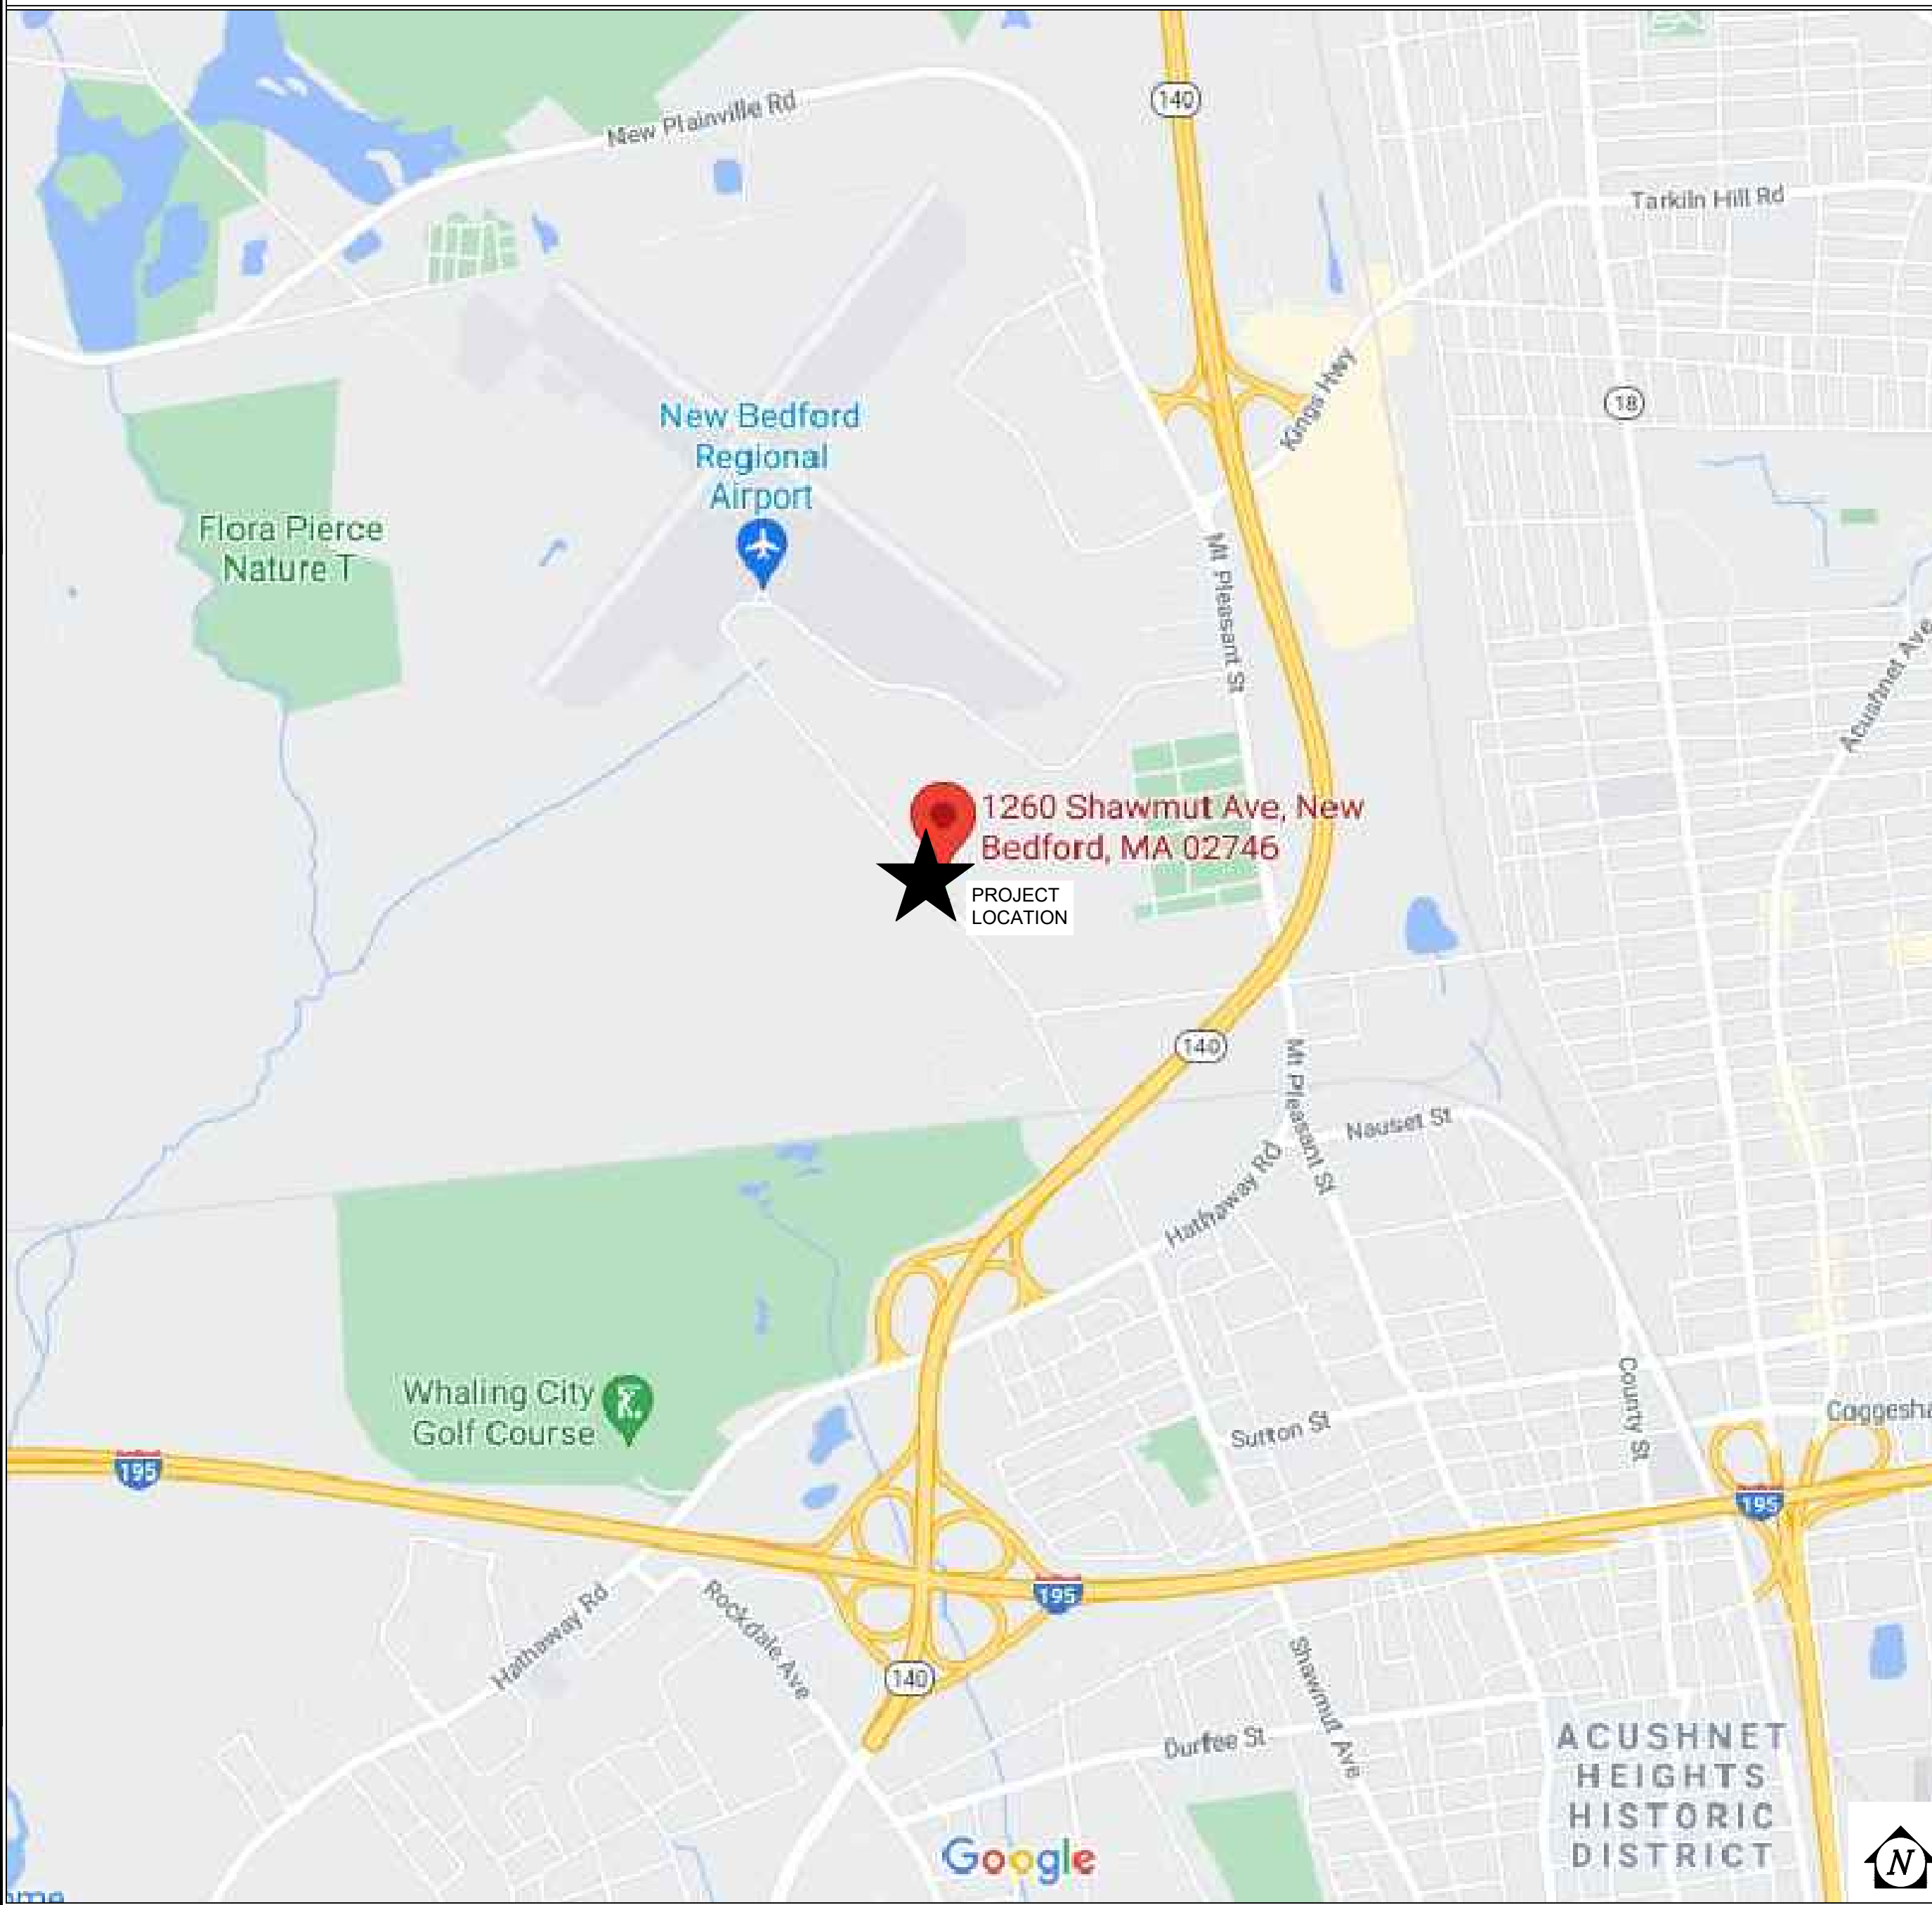

DRAWING INDEX

SHT. No.	SHEET DESCRIPTION	REL. No.	SHT. No.	SHEET DESCRIPTION	REL. No.
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RESPONSIBILITY SCHEDULE

ITEM DESCRIPTION	N/A	RBI SOLAR		CUSTOMER		REMARKS
		FURN.	INST.	FURN.	INST.	
GEOTECHNICAL REPORT						
SITE SURVEY						EXISTING CONDITIONS - TOPO & LOCATE COLUMNS
CONSTRUCTION SURVEY						VERIFY COLUMN LOCATIONS
CORROSION ANALYSIS						
LOCATE SUBSURFACE UTILITIES/STRUCTURES						PRIVATE UTILITY LOCATE
SITE GRADING						
SPOILS REMOVAL						
FENCING						
TEMPORARY ELECTRIC						
PORTABLE TOILET						
MATERIAL UNLOADING						
MATERIAL STAGING						
DUMPSTER/REFUSE REMOVAL						
FOUNDATIONS						
ANCHOR BOLTS						
PV MODULES						
PV MODULE MOUNTING HDW						
PV MODULE GROUNDING HDW						
WIRE MANAGEMENT						
CANOPY GROUNDING						
SITE CLEAN-UP						
SPECIAL INSPECTIONS						
FOUNDATION GROUNDING						
OPTIONAL ADD-ONS						
RAISED PIERS						
DECKING						
GUTTERS & DOWNSPOUTS						
SNOW GUARDS						
FASCIA/PURLIN ENCLOSURE						



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PROJECT INFORMATION

TITLE & ADDRESS:
GOYETTE'S AUTO PARTS

1260 SHAWMUT AVE
NEW BEDFORD, MA 02746

RBI SOLAR PROJECT No.:
2170063

DRAWN BY: WCC	REVIEWED BY: —
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SHEET TITLE:

SITE PLAN


SHEET No.:
SC003

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A1
SCALE:
1" = 30'-0"

Site Plan



COLUMN SCHEDULE					
	MARK	FNDN. TYPE	DESCRIPTION	LENGTH	LEVELING NUT
CANOPY	1	A	W24 x 84 COLUMN	T.B.D.	T.B.D.
	2	A	W24 x 84 COLUMN	T.B.D.	T.B.D.
	3	A	W24 x 84 COLUMN	T.B.D.	T.B.D.
	4	A	W24 x 84 COLUMN	T.B.D.	T.B.D.
	5	A	W24 x 84 COLUMN	T.B.D.	T.B.D.
	6	A	W24 x 84 COLUMN	T.B.D.	T.B.D.
	7	A	W24 x 84 COLUMN	T.B.D.	T.B.D.
	8	A	W24 x 84 COLUMN	T.B.D.	T.B.D.
	9	A	W21x73 Column	T.B.D.	T.B.D.
	10	A	W24 x 84 COLUMN	T.B.D.	T.B.D.
	11	A	W24 x 84 COLUMN	T.B.D.	T.B.D.
	12	A	W24 x 84 COLUMN	T.B.D.	T.B.D.
	13	A	W24 x 84 COLUMN	T.B.D.	T.B.D.
	14	A	W24 x 84 COLUMN	T.B.D.	T.B.D.
	15	A	W24 x 84 COLUMN	T.B.D.	T.B.D.
	16	A	W24 x 84 COLUMN	T.B.D.	T.B.D.
	17	A	W24 x 84 COLUMN	T.B.D.	T.B.D.

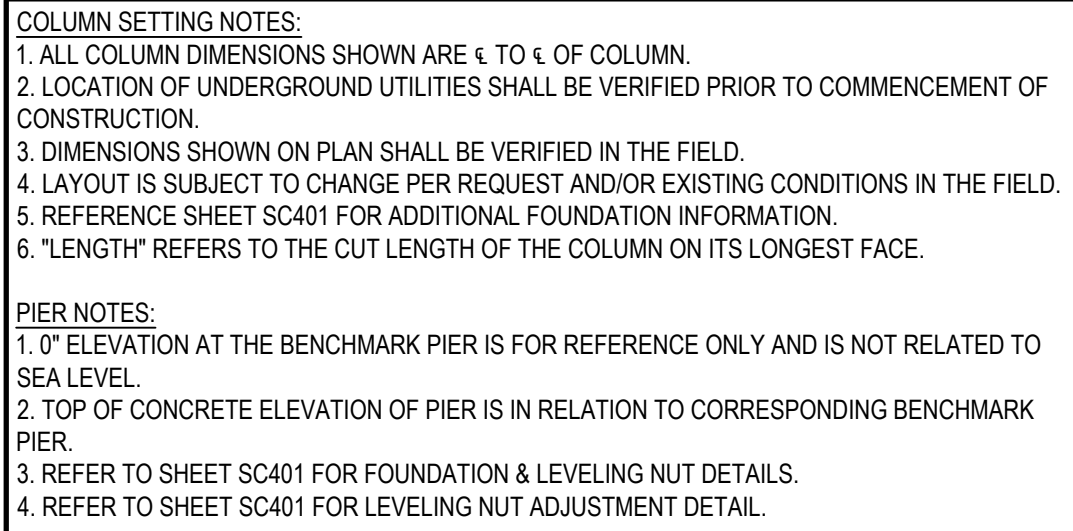


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F1	Canopy 1 Foundation & Column Plan
SCALE: 1" = 20'-0"	



COLUMN SETTING NOTES:

1. ALL COLUMN DIMENSIONS SHOWN ARE ϵ TO ϵ OF COLUMN.
2. LOCATION OF UNDERGROUND UTILITIES SHALL BE VERIFIED PRIOR TO COMMENCEMENT OF CONSTRUCTION.
3. DIMENSIONS SHOWN ON PLAN SHALL BE VERIFIED IN THE FIELD.
4. LAYOUT IS SUBJECT TO CHANGE PER REQUEST AND/OR EXISTING CONDITIONS IN THE FIELD.
5. REFERENCE SHEET SC401 FOR ADDITIONAL FOUNDATION INFORMATION.
6. "LENGTH" REFERS TO THE CUT LENGTH OF THE COLUMN ON ITS LONGEST FACE.

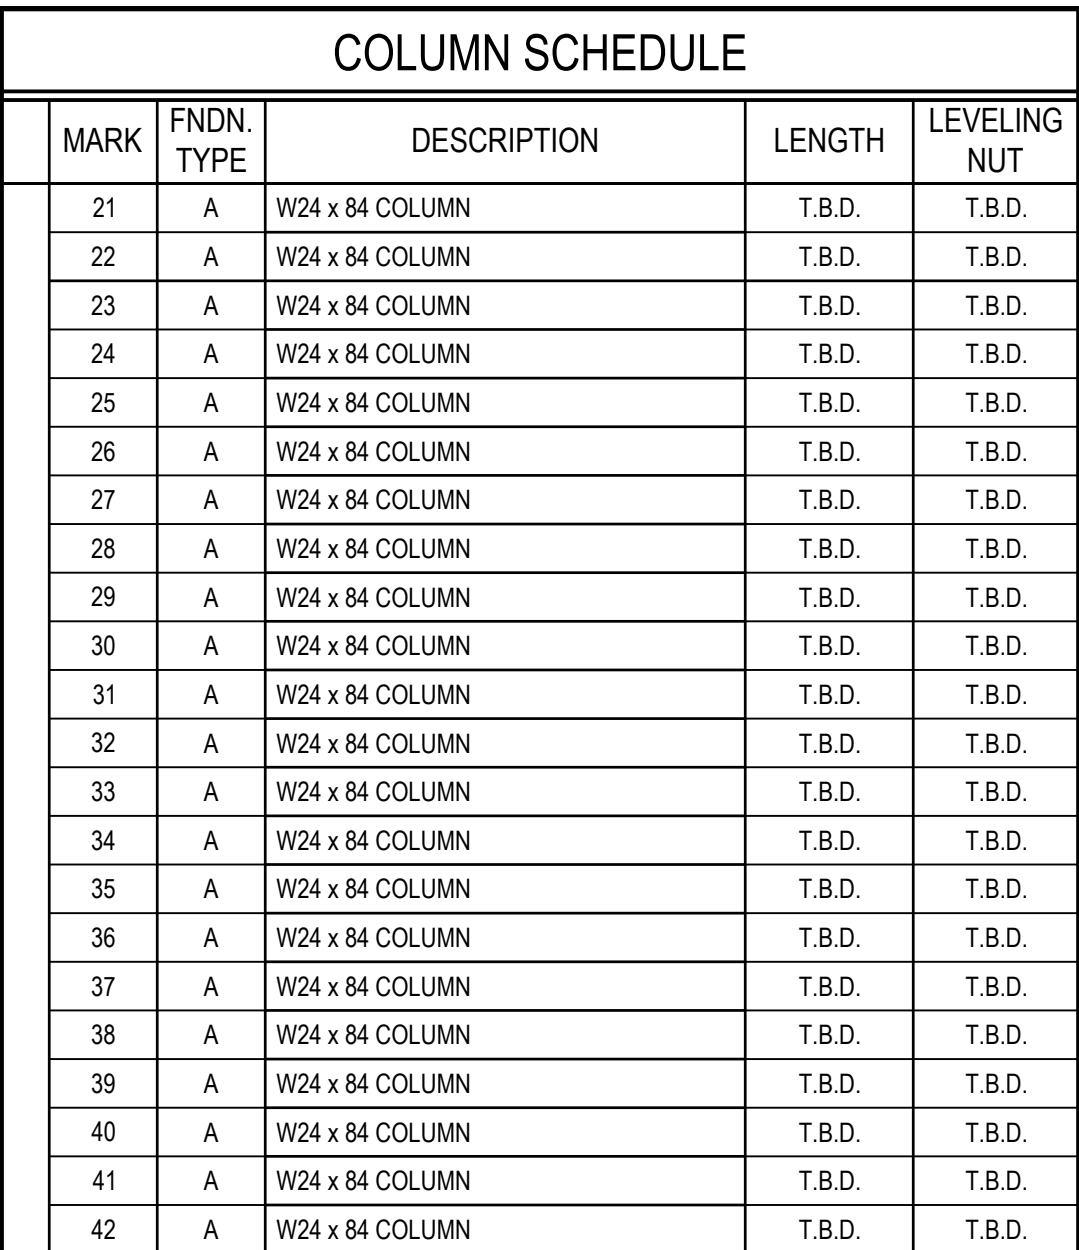PIER NOTES:

1. 0" ELEVATION AT THE BENCHMARK PIER IS FOR REFERENCE ONLY AND IS NOT RELATED TO SEA LEVEL.
2. TOP OF CONCRETE ELEVATION OF PIER IS IN RELATION TO CORRESPONDING BENCHMARK PIER.
3. REFER TO SHEET SC401 FOR FOUNDATION & LEVELING NUT DETAILS.
4. REFER TO SHEET SC401 FOR LEVELING NUT ADJUSTMENT DETAIL.

□ RELEASE RECORD

7	12/06/21	INTERNAL REVIEW
6	08/13/21	50% REVIEW (R1)
5	07/22/21	30% REVIEW (R3)
4	07/22/21	30% REVIEW (R2)
1	06/30/21	50% REVIEW
MARK	DATE	DESCRIPTION

PROJECT INFORMATION

TITLE & ADDRESS:
GOYETTE'S AUTO PARTS

1260 SHAWMUT AVE
NEW BEDFORD, MA 02746

RBI SOLAR PROJECT No.
2170063

DRAWN BY: WCC	REVIEWED BY: —
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SHEET TITLE:

FOUNDATION AND
COLUMN PLAN

SHEET No.:

SC101

COLUMN SCHEDULE				
MARK	FNDN. TYPE	DESCRIPTION	LENGTH	LEVELING NUT
43	A	W24 x 84 COLUMN	T.B.D.	T.B.D.
44	A	W24 x 84 COLUMN	T.B.D.	T.B.D.
45	A	W24 x 84 COLUMN	T.B.D.	T.B.D.
46	A	W24 x 84 COLUMN	T.B.D.	T.B.D.
47	A	W24 x 84 COLUMN	T.B.D.	T.B.D.
48	A	W24 x 84 COLUMN	T.B.D.	T.B.D.
49	A	W24 x 84 COLUMN	T.B.D.	T.B.D.
50	A	W24 x 84 COLUMN	T.B.D.	T.B.D.
51	A	W24 x 84 COLUMN	T.B.D.	T.B.D.
52	A	W24 x 84 COLUMN	T.B.D.	T.B.D.
53	A	W24 x 84 COLUMN	T.B.D.	T.B.D.
54	A	W24 x 84 COLUMN	T.B.D.	T.B.D.
55	A	W21 x 73 COLUMN	T.B.D.	T.B.D.
56	A	W21x 73 COLUMN	T.B.D.	T.B.D.
57	A	W24 x 84 COLUMN	T.B.D.	T.B.D.
58	A	W24 x 84 COLUMN	T.B.D.	T.B.D.
59	A	W24 x 84 COLUMN	T.B.D.	T.B.D.
60	A	W24 x 84 COLUMN	T.B.D.	T.B.D.
61	A	W24 x 84 COLUMN	T.B.D.	T.B.D.
62	A	W24 x 84 COLUMN	T.B.D.	T.B.D.
63	A	W24 x 84 COLUMN	T.B.D.	T.B.D.
64	A	W24 x 84 COLUMN	T.B.D.	T.B.D.
65	A	W24 x 84 COLUMN	T.B.D.	T.B.D.
66	A	W24 x 84 COLUMN	T.B.D.	T.B.D.
67	A	W24 x 84 COLUMN	T.B.D.	T.B.D.
68	A	W24 x 84 COLUMN	T.B.D.	T.B.D.

COLUMN SETTING NOTES:
1. ALL COLUMN DIMENSIONS SHOWN ARE 1/4" TO 1/8" OF COLUMN.
2. LOCATION OF UNDERGROUND UTILITIES SHALL BE VERIFIED PRIOR TO COMMENCEMENT OF CONSTRUCTION.
3. DIMENSIONS SHOWN ON PLAN SHALL BE VERIFIED IN THE FIELD.
4. LAYOUT IS SUBJECT TO CHANGE PER REQUEST AND/OR EXISTING CONDITIONS IN THE FIELD.
5. REFERENCE SHEET SC401 FOR ADDITIONAL FOUNDATION INFORMATION.
6. "LENGTH" REFERS TO THE CUT LENGTH OF THE COLUMN ON ITS LONGEST FACE.

PIER NOTES:
1. 0' ELEVATION AT THE BENCHMARK PIER IS FOR REFERENCE ONLY AND IS NOT RELATED TO SEA LEVEL.
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SOLAR CANOPY
FOR
PARALLEL PRODUCTS

RELEASE RECORD		
1	06/30/21	50% REVIEW
4	07/22/21	30% REVIEW (R2)
5	07/22/21	30% REVIEW (R3)
6	08/13/21	50% REVIEW (R1)
7	12/06/21	INTERNAL REVIEW

PROJECT INFORMATION

TITLE & ADDRESS:
GOYETTE'S AUTO PARTS


1260 SHAWMUT AVE
NEW BEDFORD, MA 02746

RBI SOLAR PROJECT No.:
2170063

DRAWN BY: WCC REVIEWED BY: _

SHEET TITLE:
FOUNDATION AND COLUMN PLAN

SHEET No.:
SC102

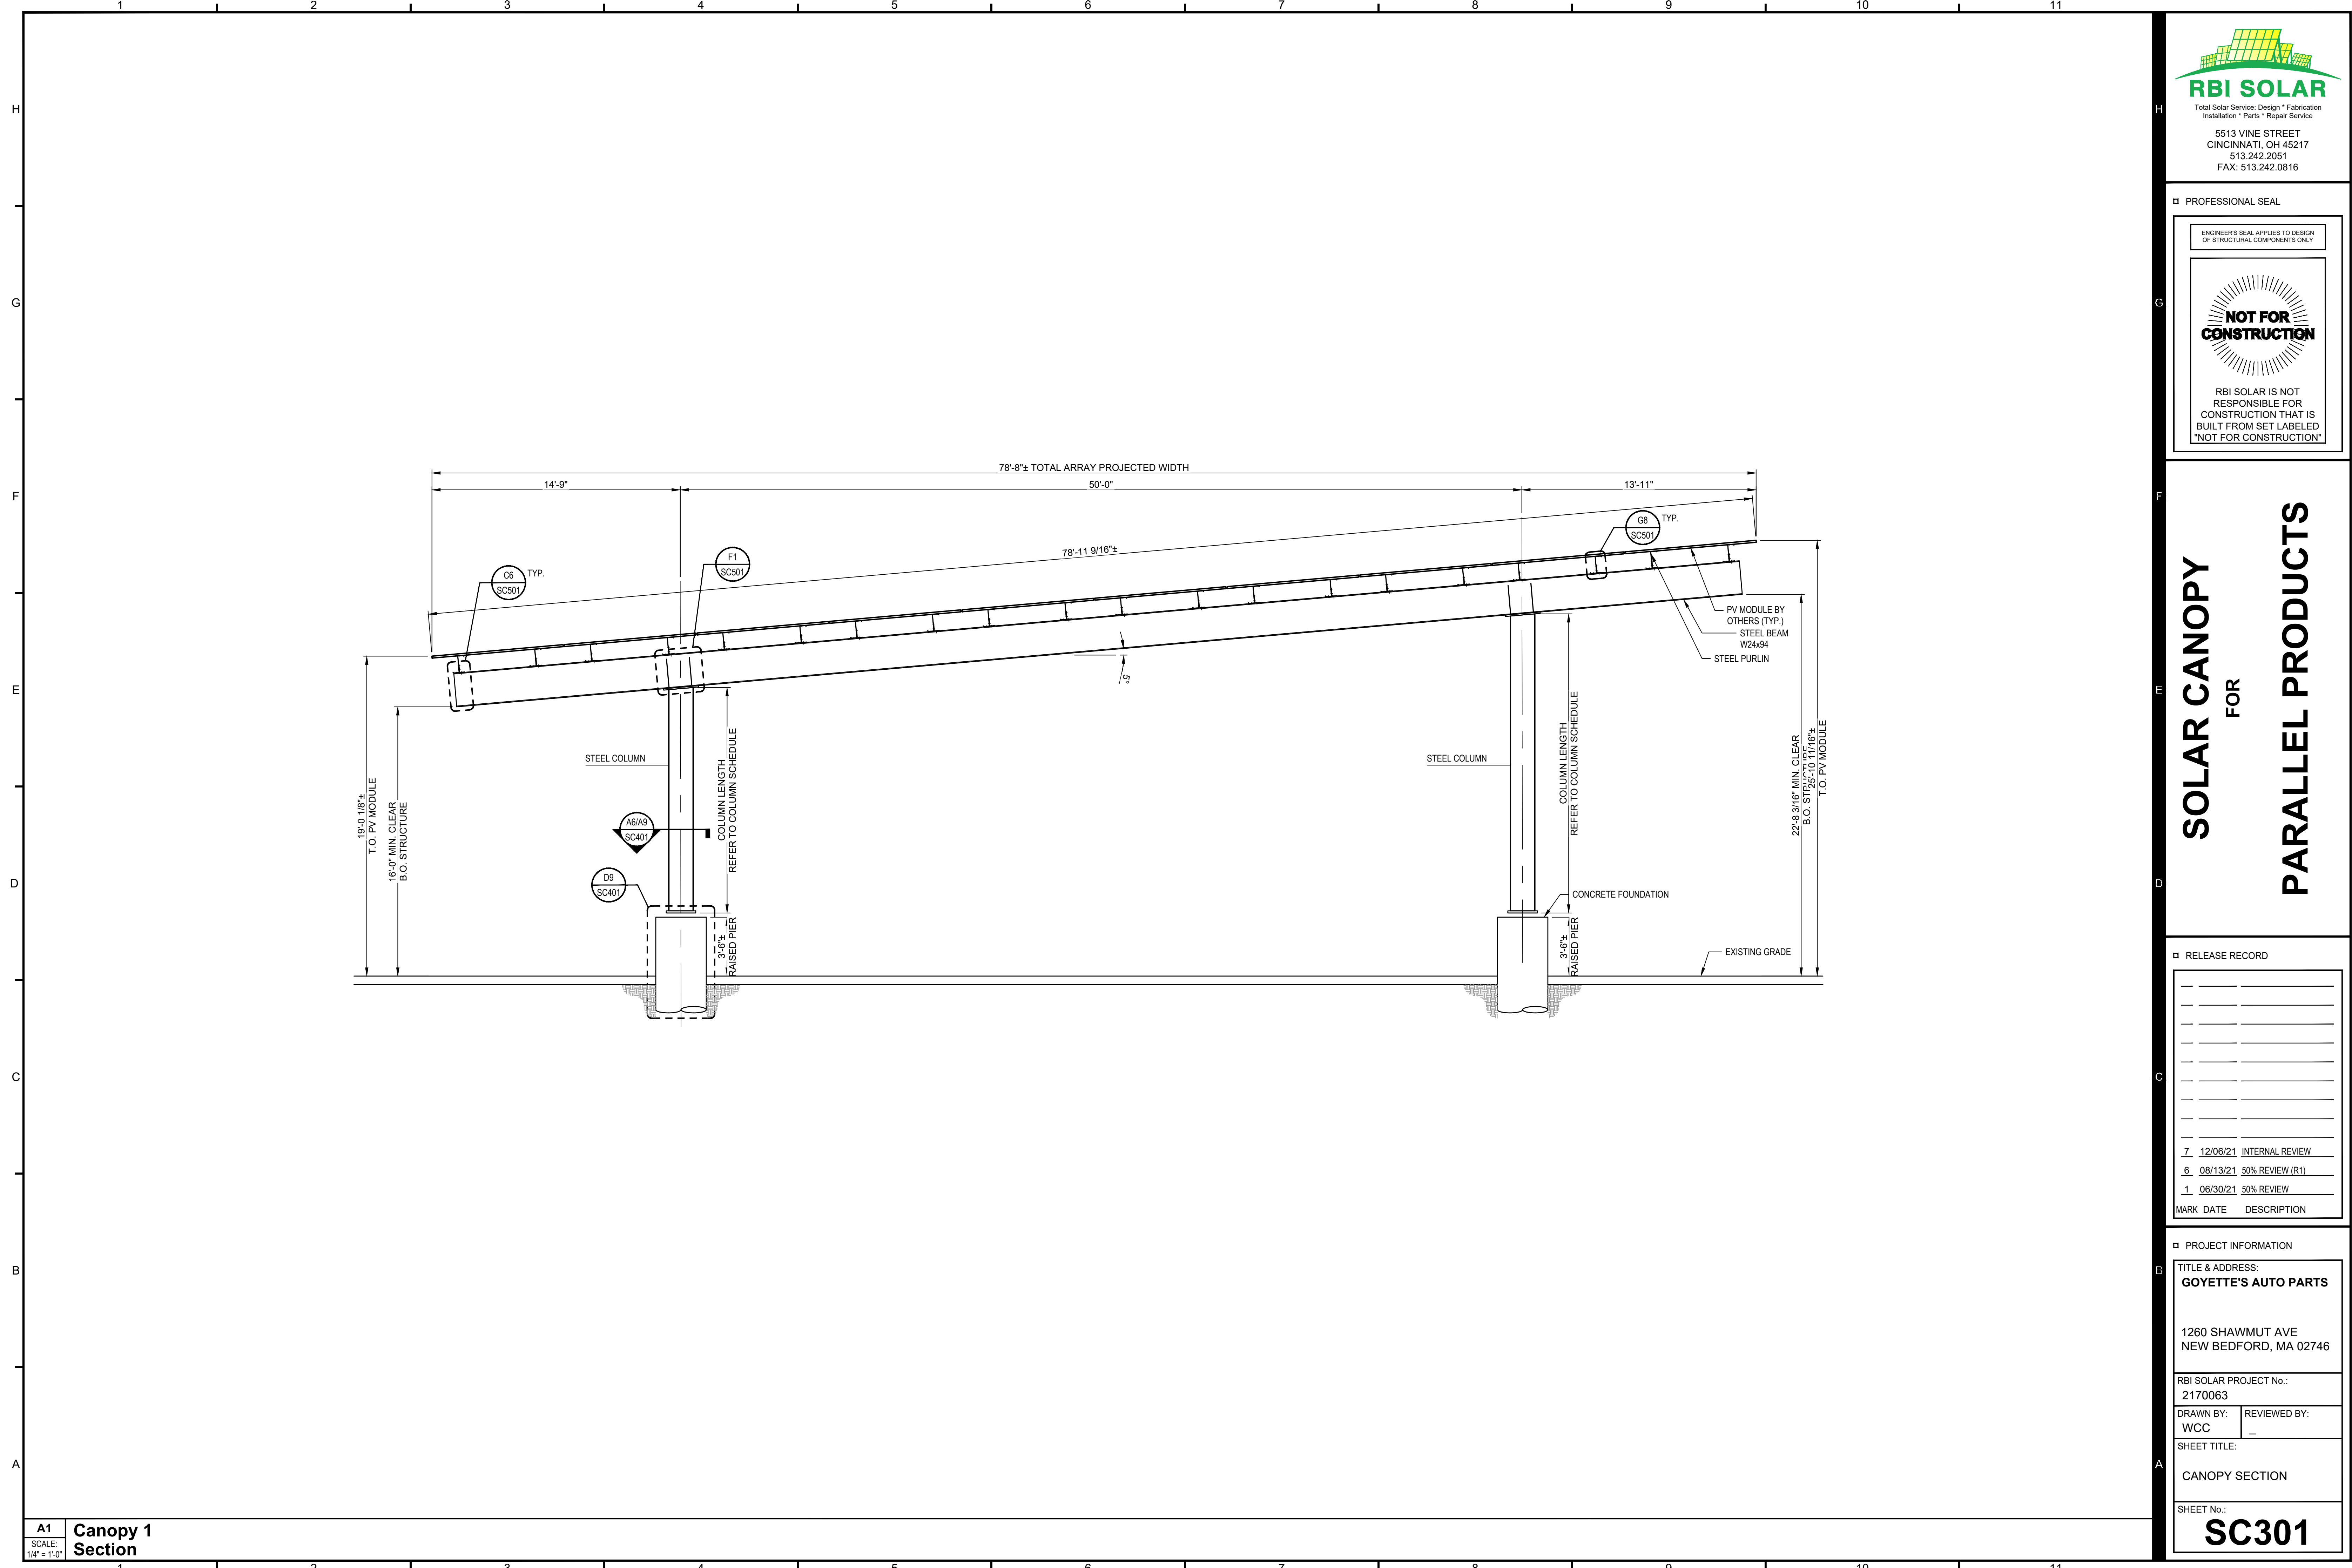



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Total Solar Service: Design * Fabrication
Installation * Parts * Repair Service

5513 VINE STREET
CINCINNATI, OH 45217
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PROFESSIONAL SEAL

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SOLAR CANOPY FOR PARALLEL PRODUCTS

RELEASE RECORD


7	12/06/21	INTERNAL REVIEW
6	08/13/21	50% REVIEW (R1)
1	06/30/21	50% REVIEW
MARK	DATE	DESCRIPTION

PROJECT INFORMATION

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1260 SHAWMUT AVE
NEW BEDFORD, MA 02746

RBI SOLAR PROJECT No.:
2170063

DRAWN BY: WCC
REVIEWED BY: 

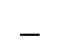SHEET TITLE:
CANOPY SECTION


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A1
SCALE:
1/4" = 1'-0"

Canopy 1
Section



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Installation * Parts * Repair Service
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SOLAR CANOPY FOR PARALLEL PRODUCTS

RELEASE RECORD

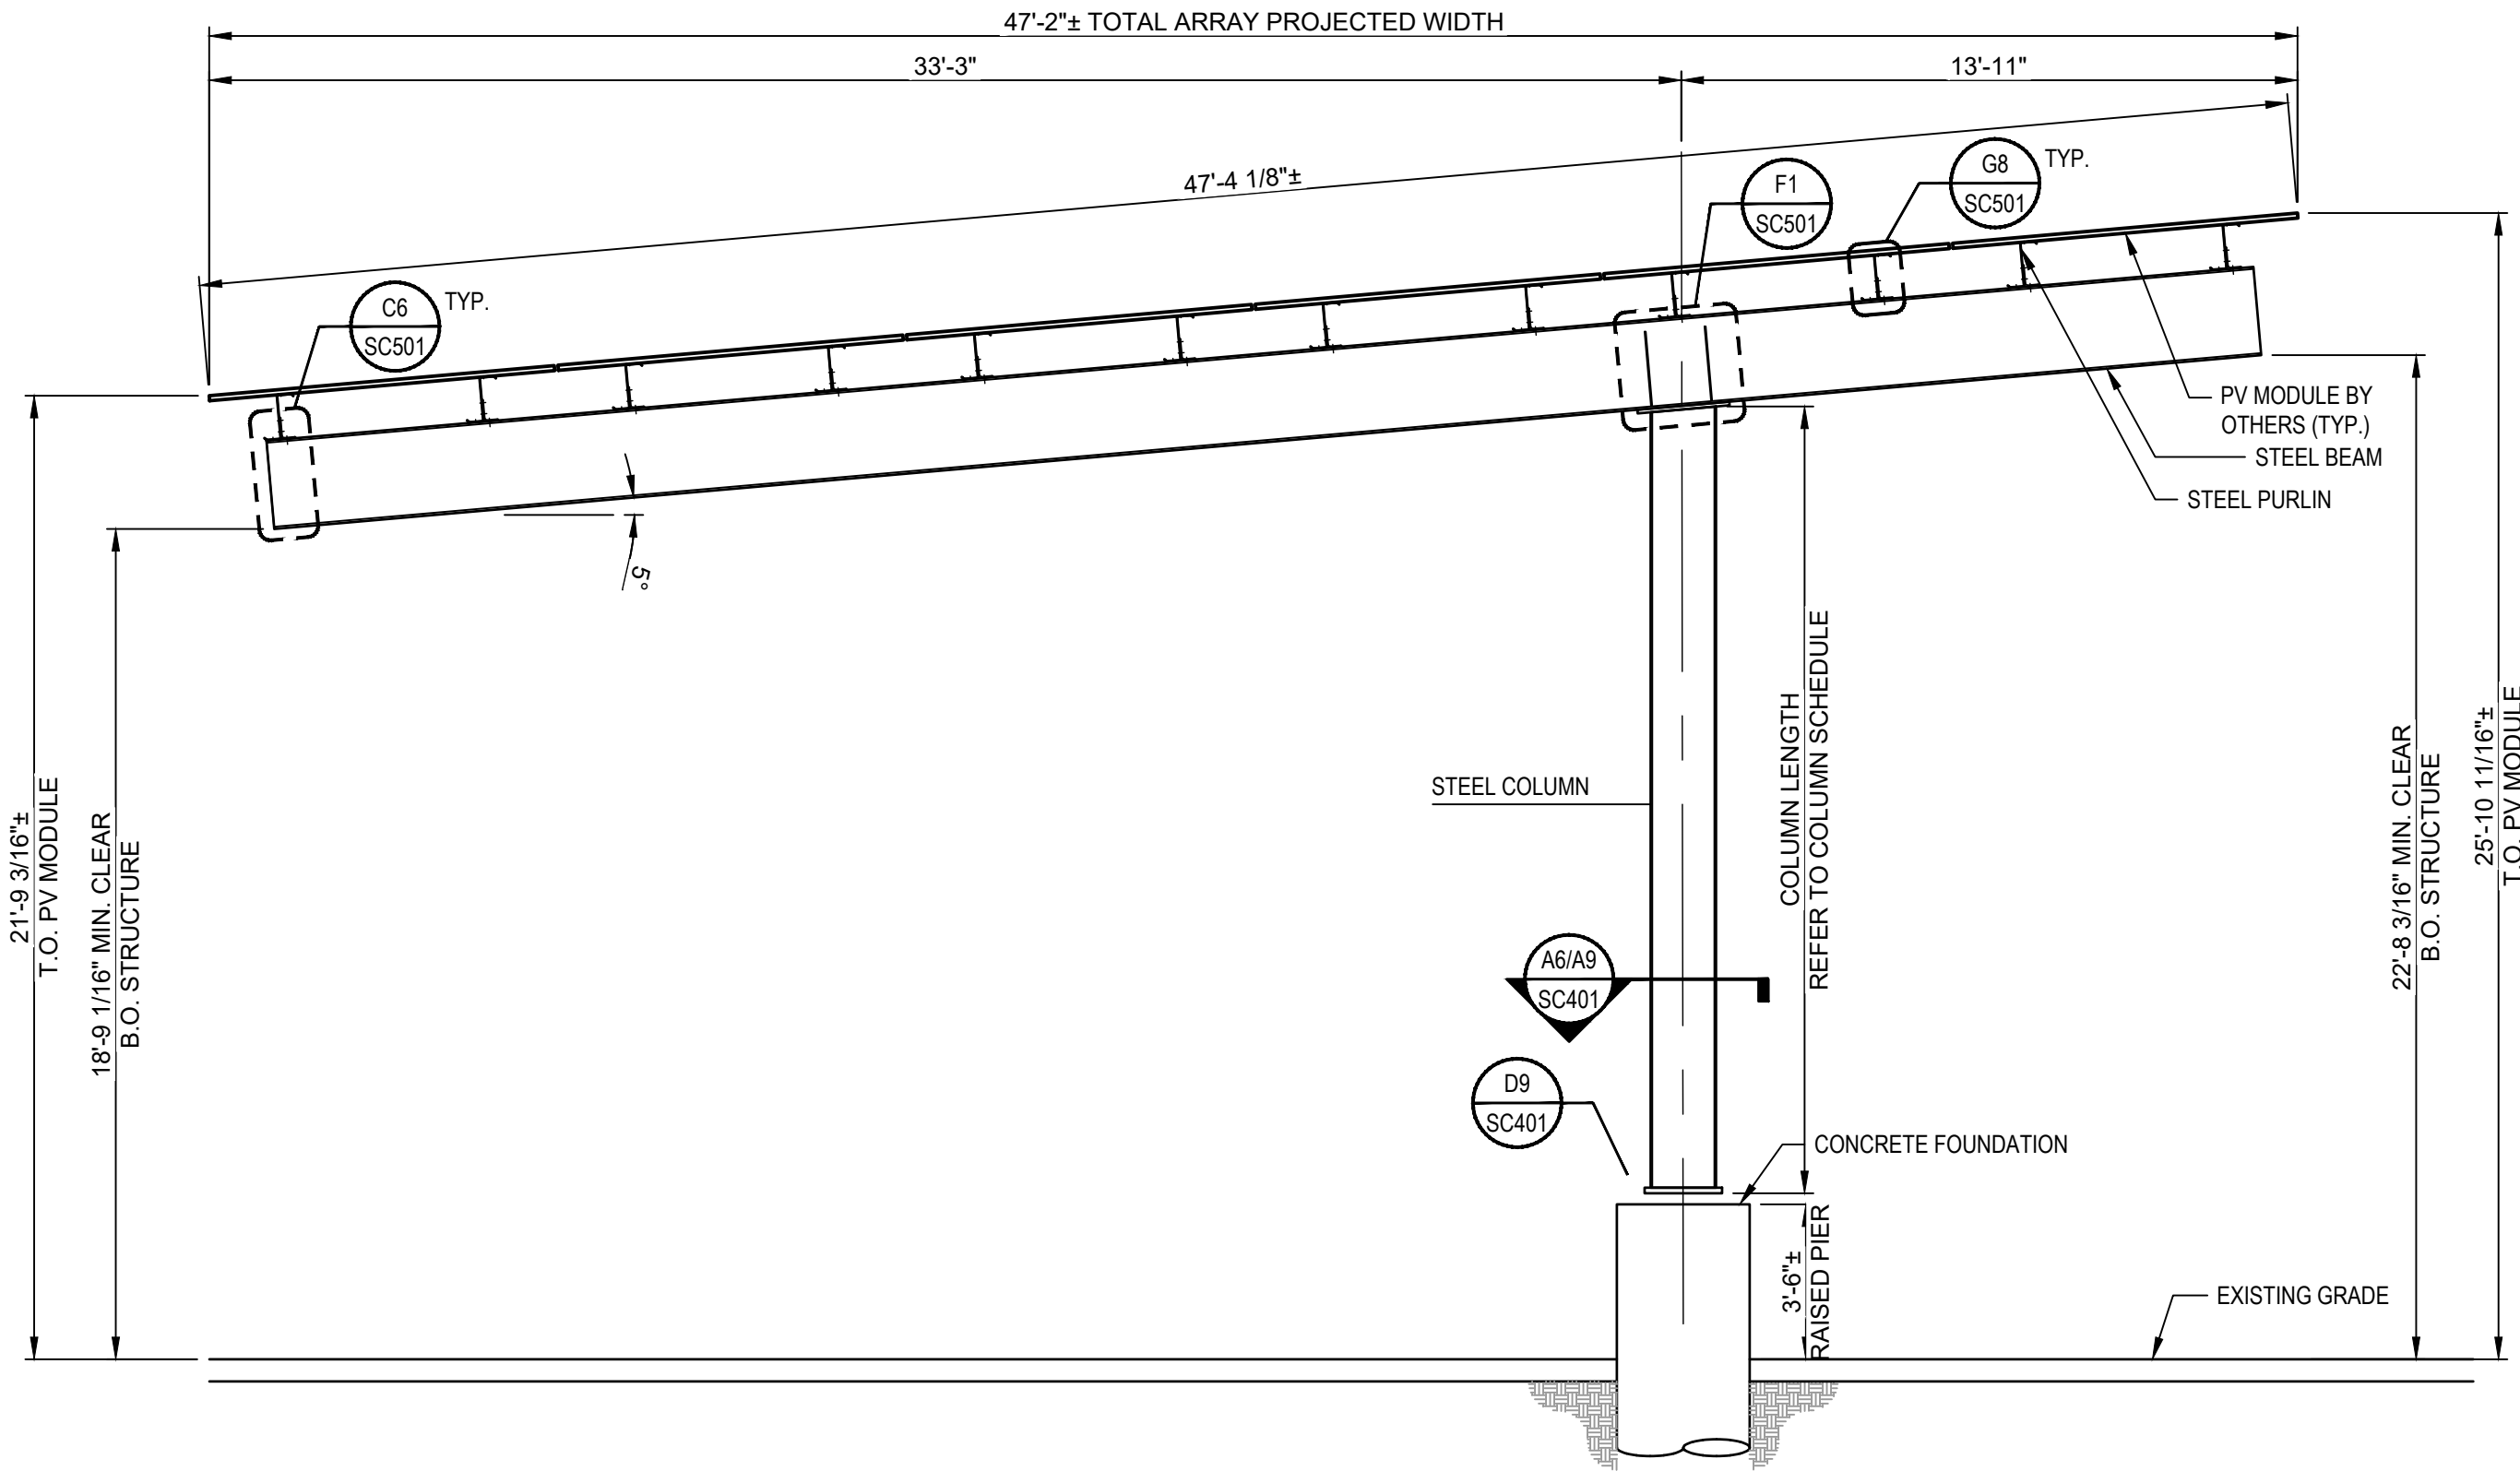1	06/30/21	50% REVIEW
6	08/13/21	50% REVIEW (R1)
7	12/06/21	INTERNAL REVIEW

PROJECT INFORMATION

TITLE & ADDRESS:

GOYETTE'S AUTO PARTS

1260 SHAWMUT AVE
NEW BEDFORD, MA 02746

RBI SOLAR PROJECT No.:
2170063

DRAWN BY: WCC
REVIEWED BY: _

SHEET TITLE:

CANOPY SECTION



SHEET No.:

SC302

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A1
SCALE:
1/8" = 1'-0"

Canopy 2
Section



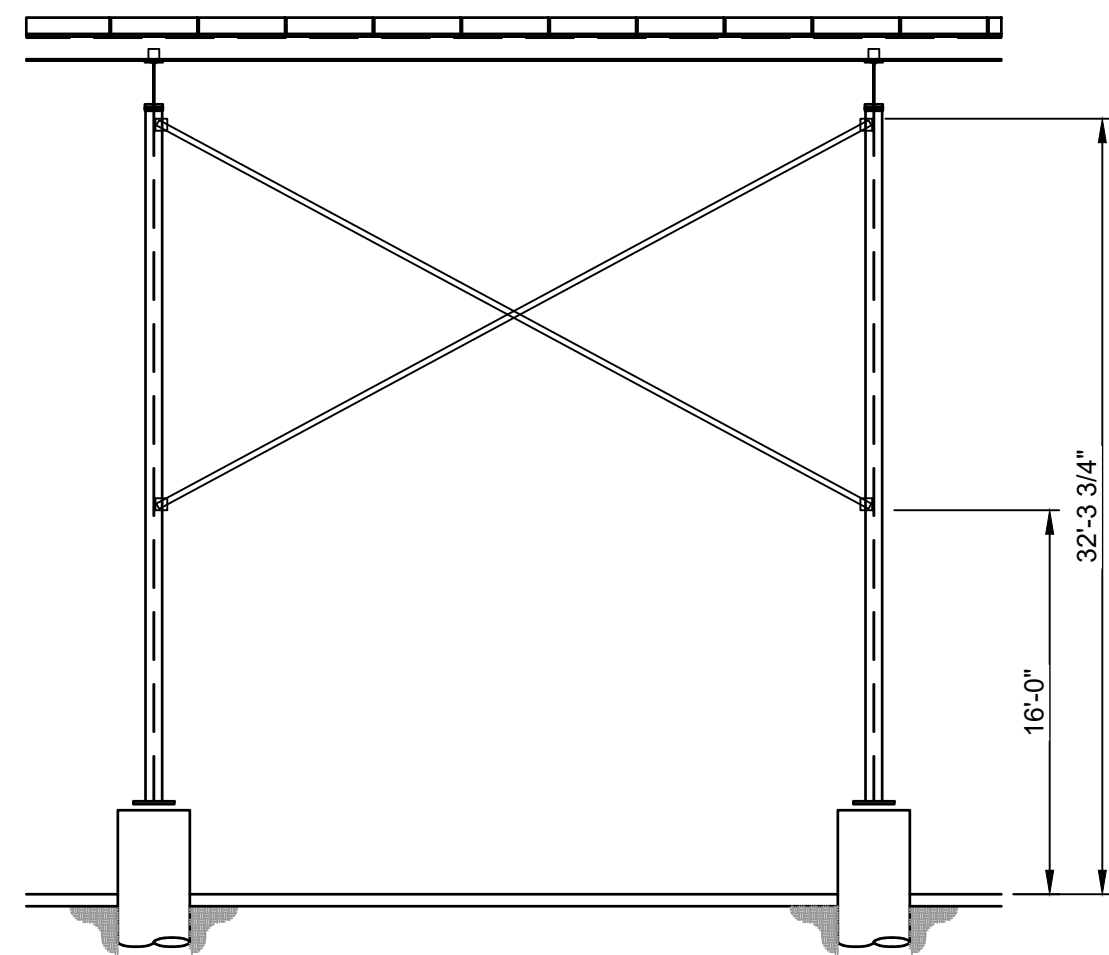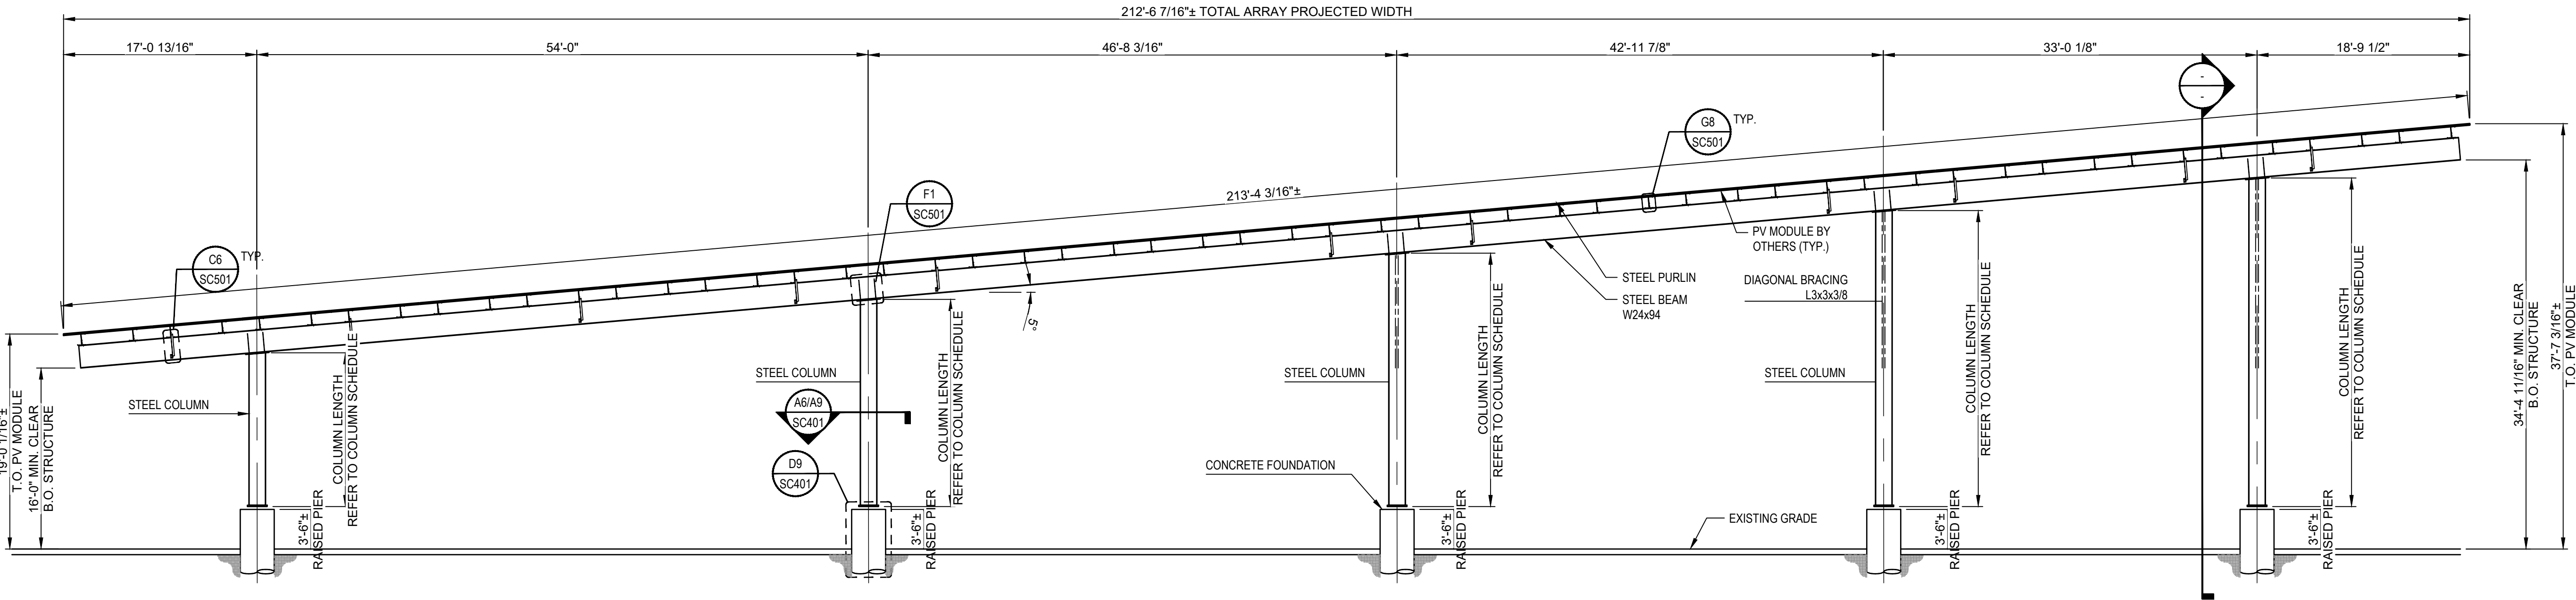


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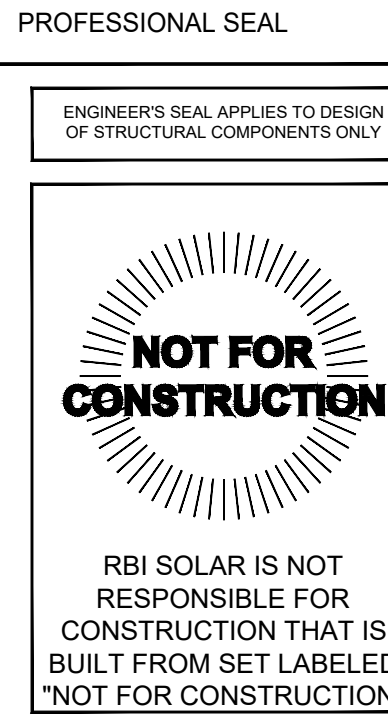
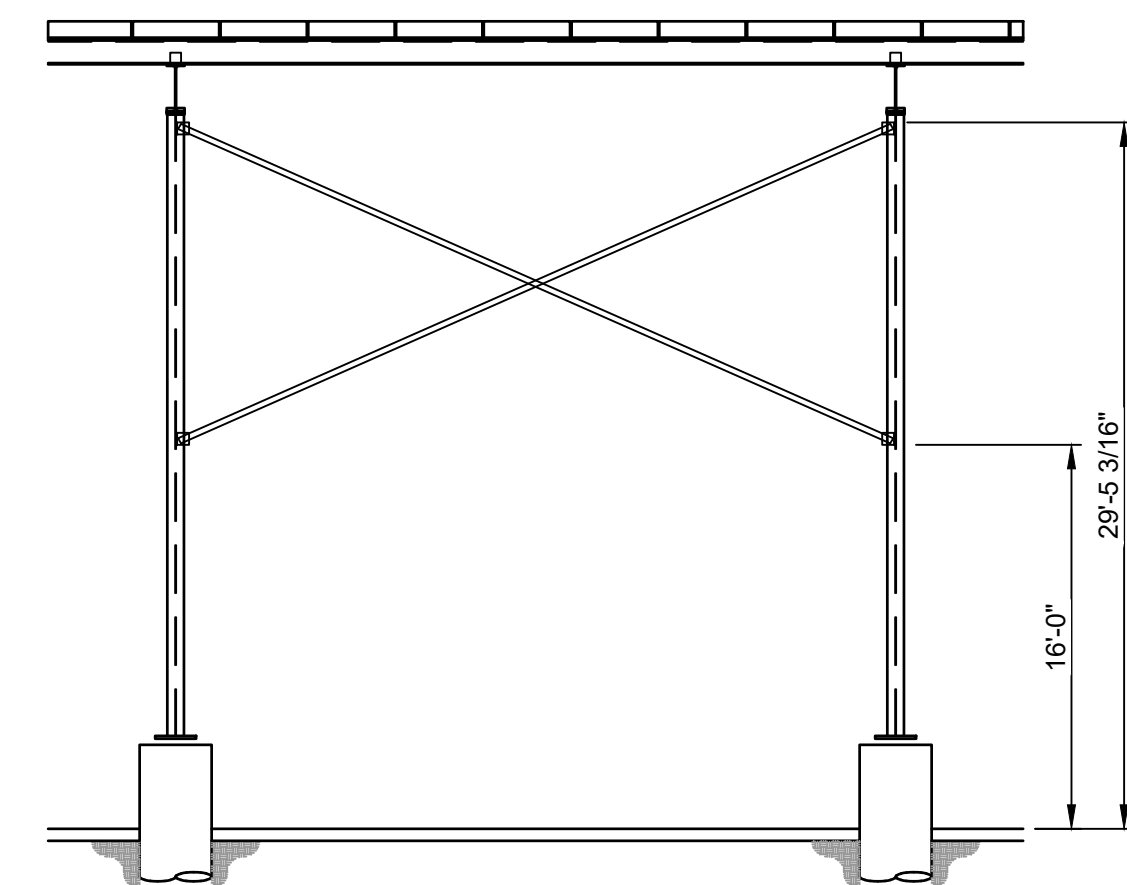
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2170063

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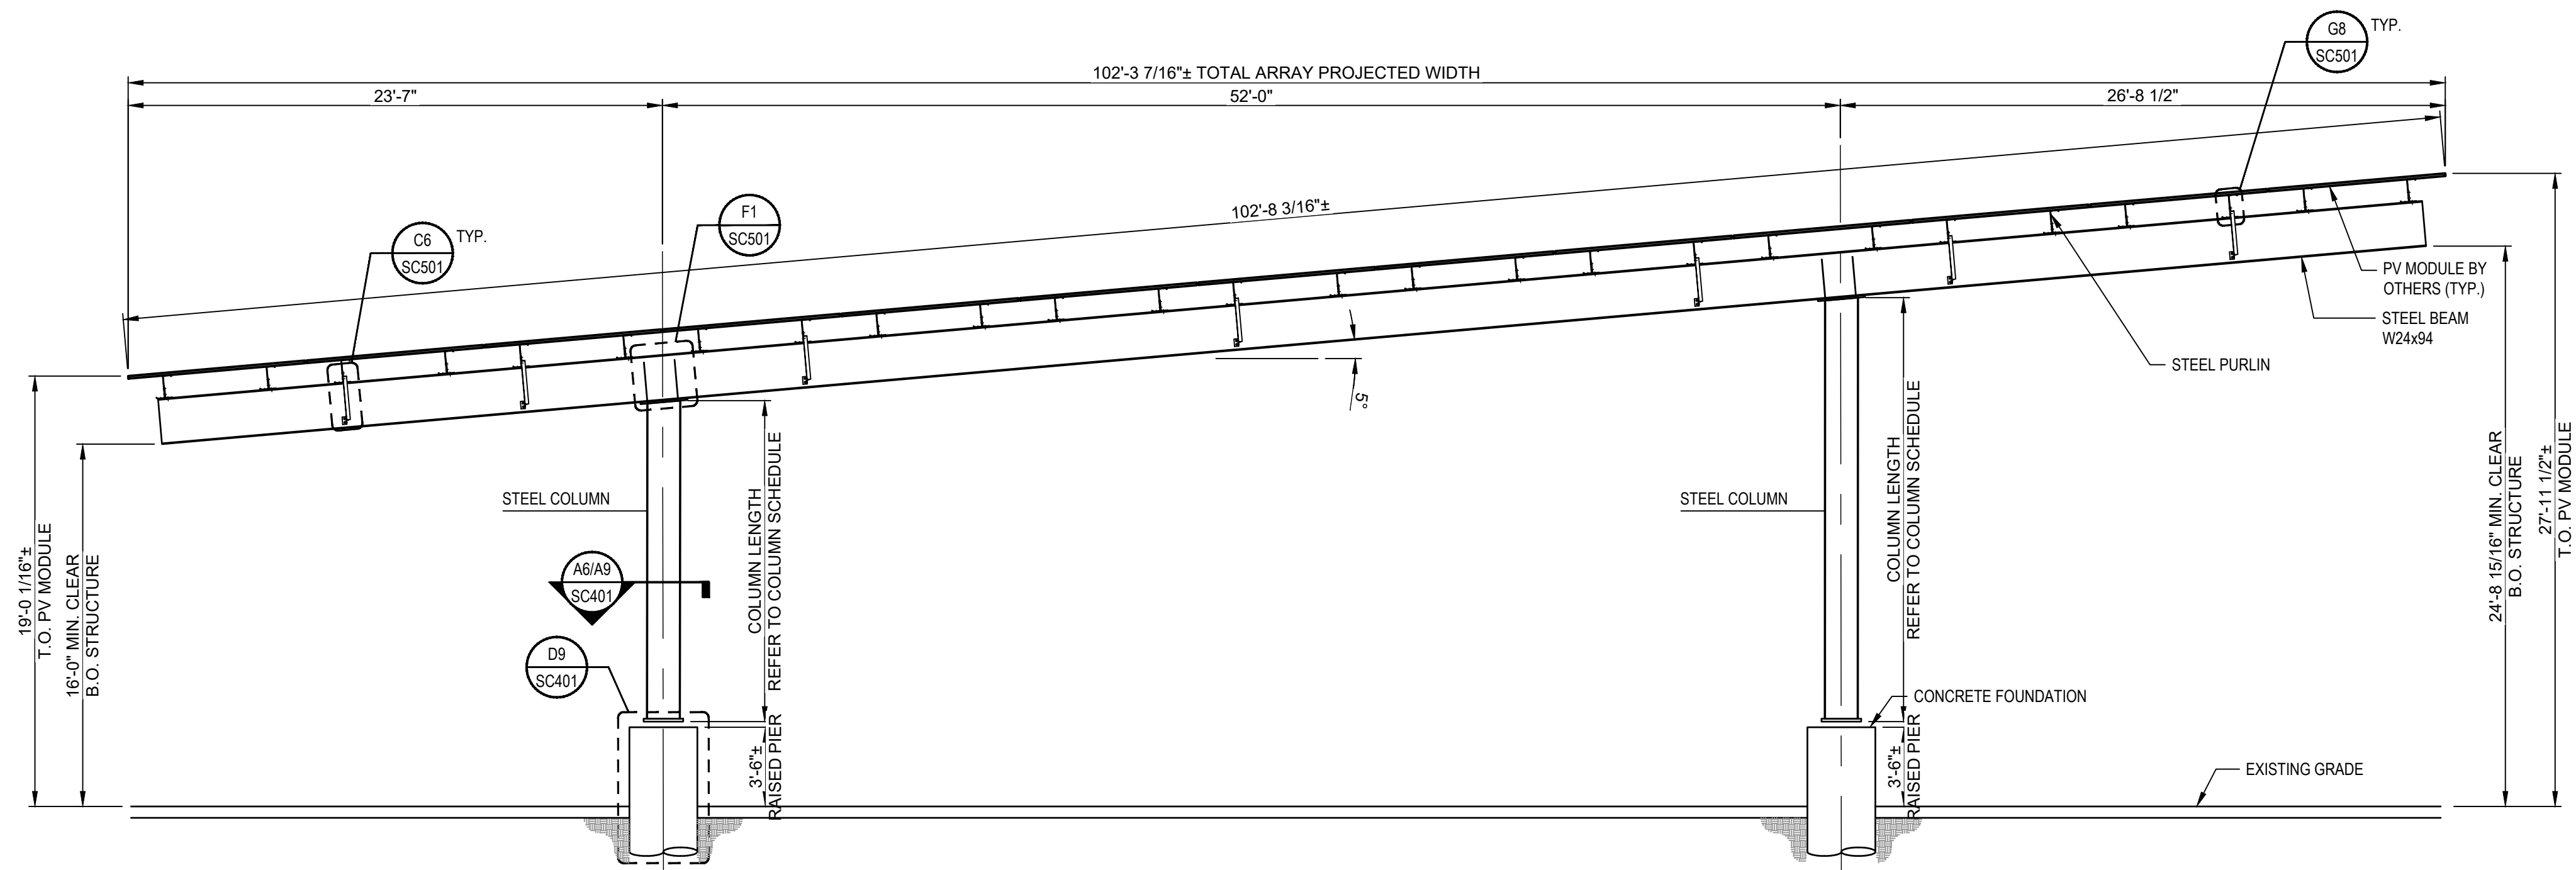
REVIEWED BY:
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SHEET TITLE:
CANOPY SECTION

SHEET No.:
SC303

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PROJECT INFORMATION	
TITLE & ADDRESS: GOYETTE'S AUTO PAR	
1260 SHAWMUT AVE NEW BEDFORD, MA 027	
RBI SOLAR PROJECT No.: 2170063	
DRAWN BY: WCC	REVIEWED BY: —
SHEET TITLE: CANOPY SECTION	
SHEET No.: SC304	

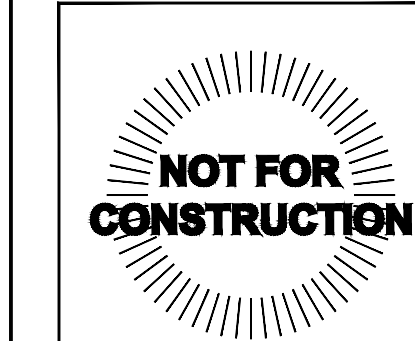

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SOLAR CANOPY FOR PARALLEL PRODUCTS

RELEASE RECORD

[illegible]

7 12/06/21 INTERNAL REVIEW

[illegible]

PROJECT INFORMATION

TITLE & ADDRESS:
GOYETTE'S AUTO PARTS

1260 SHAWMUT AVE
NEW BEDFORD, MA 02746

IRBI SOLAR PROJECT No.
2170063

DRAWN BY: WCC	REVIEWED BY:
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SHEET TITLE:

CANOPY SECTION

SHEET No.:

SC305

A1	Canopy 3 Section
SCALE: 3/16" = 1'-0"	



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[illegible]

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RBI SOLAR PROJECT No.:	2170063
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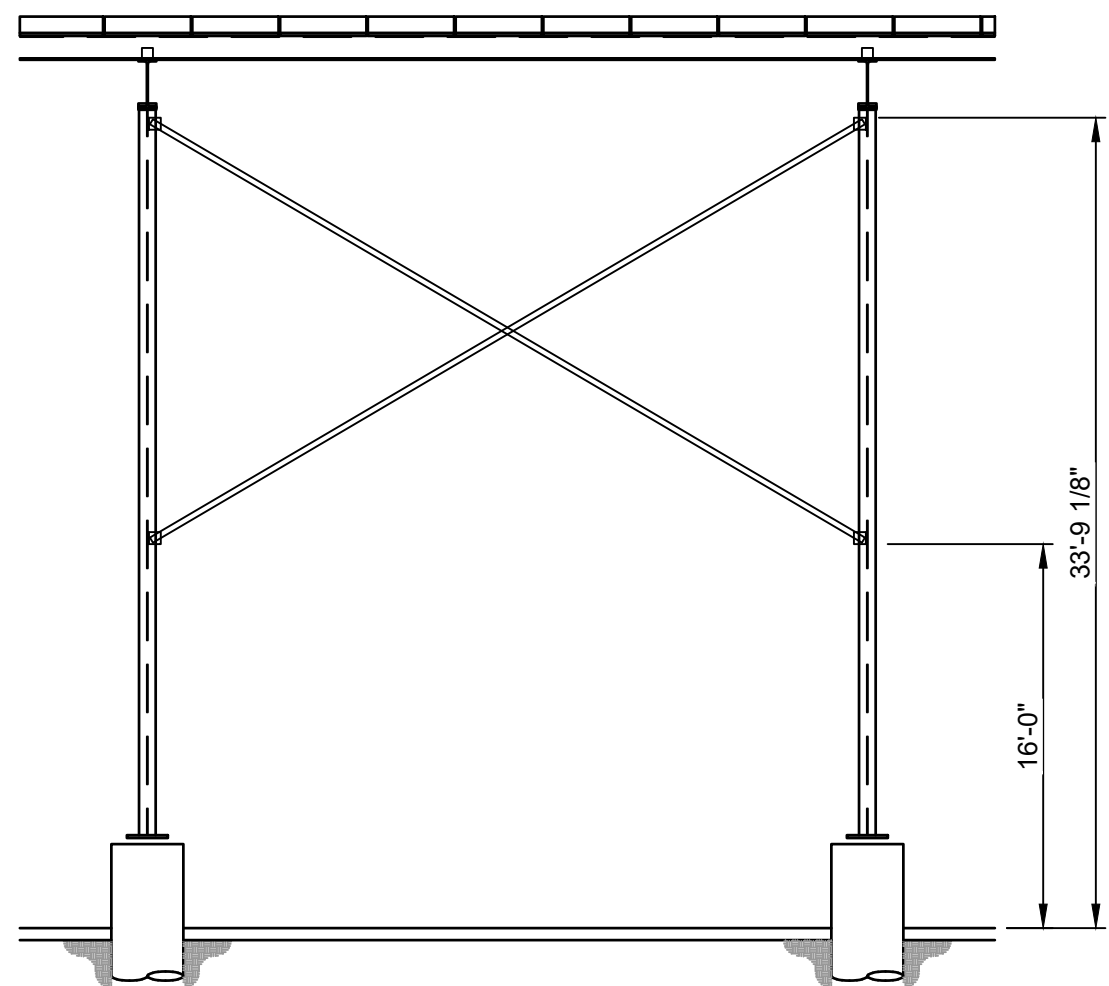
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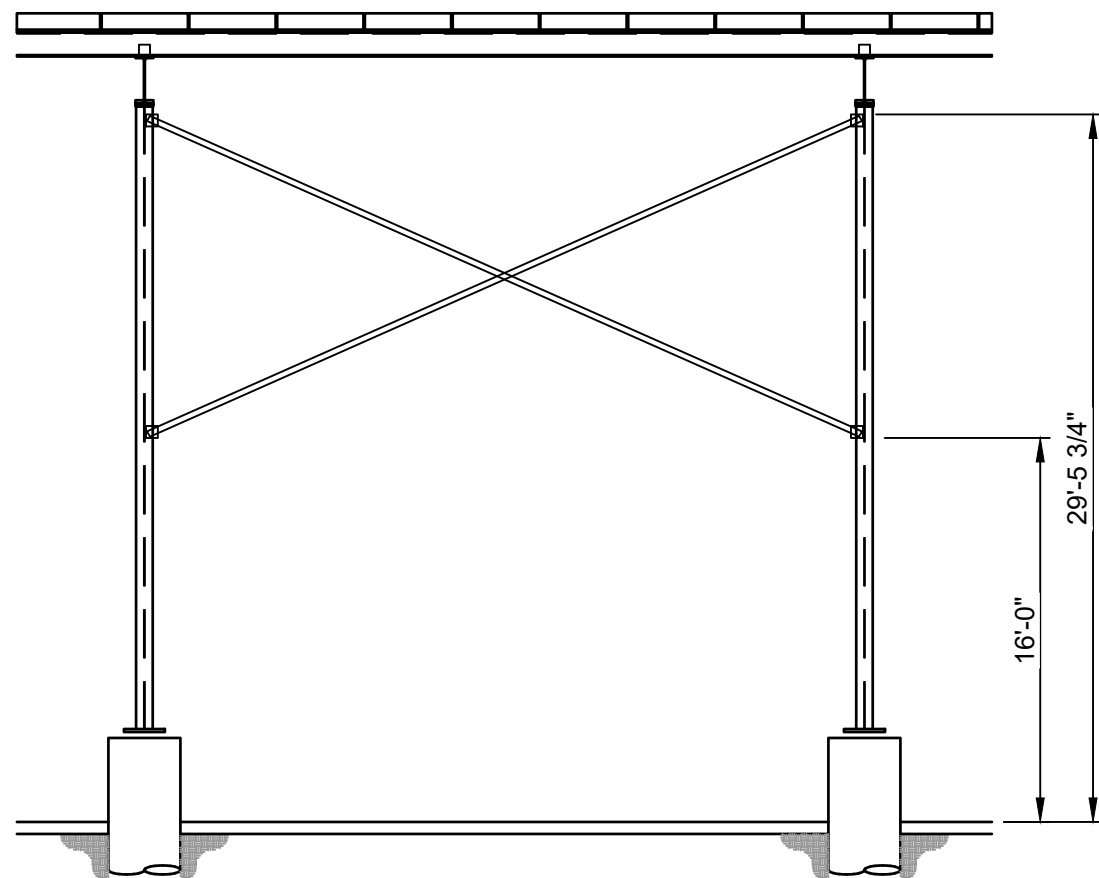
CANOPY SECTION

SHEET No.:

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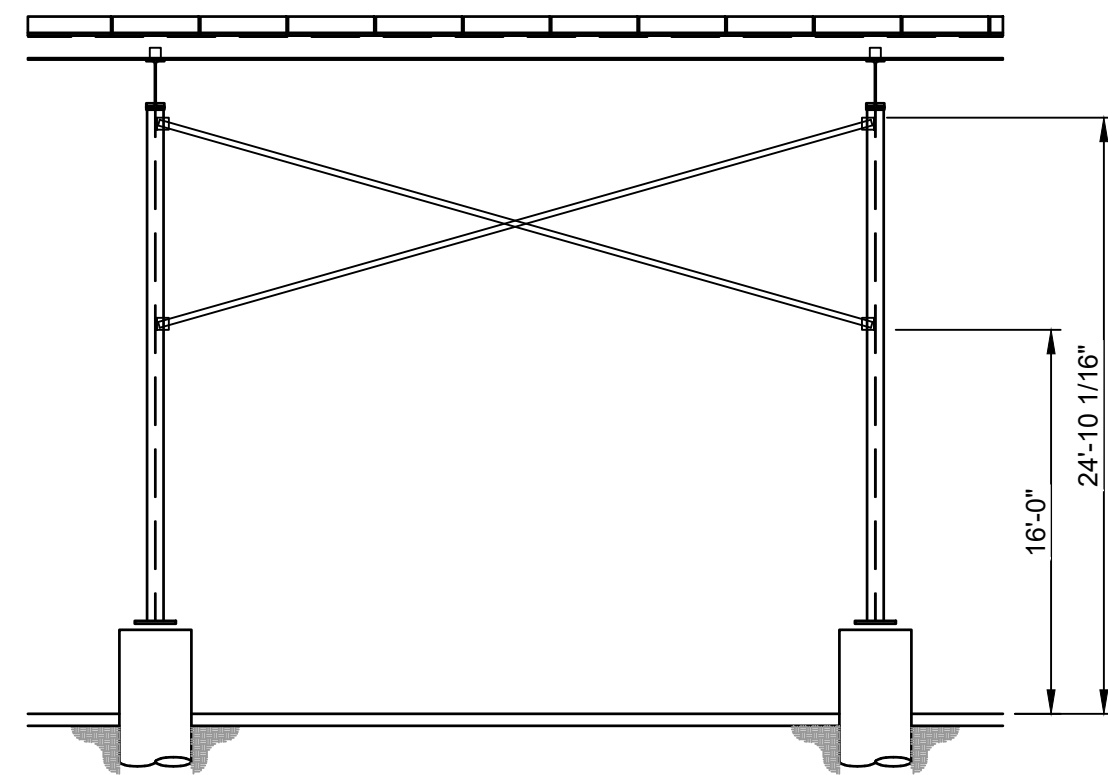
A1	Canopy 3 Section
SCALE: 3/16" = 1'-0"	








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SC309





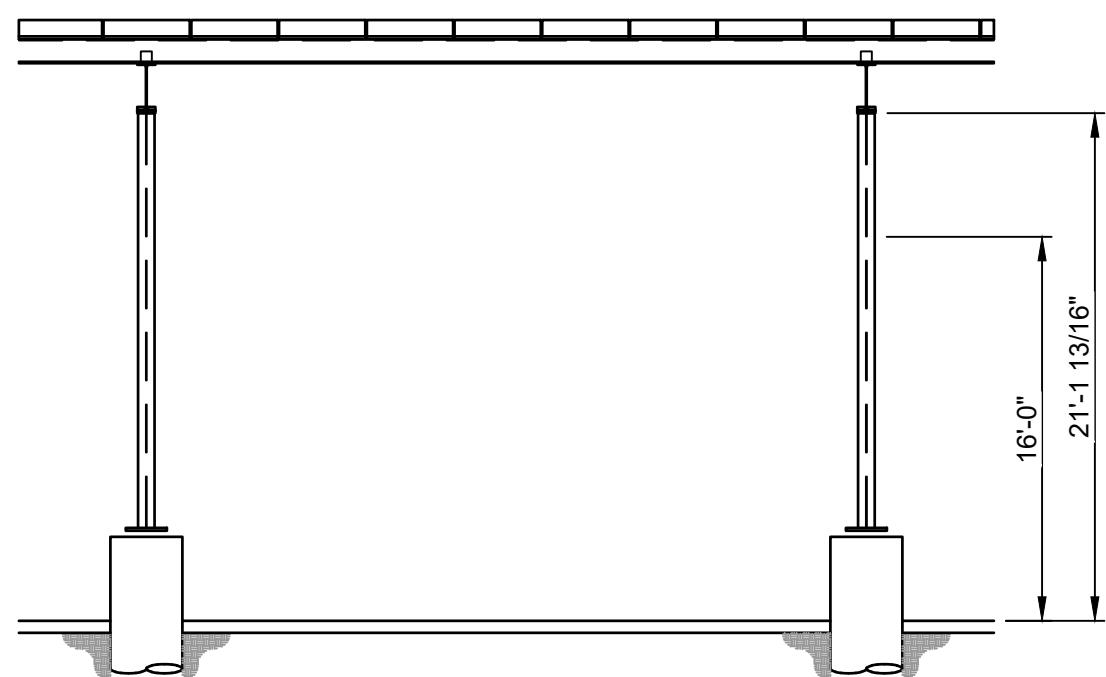


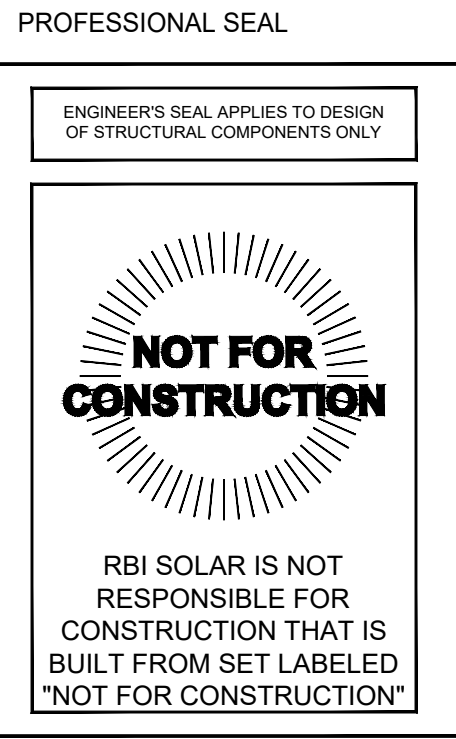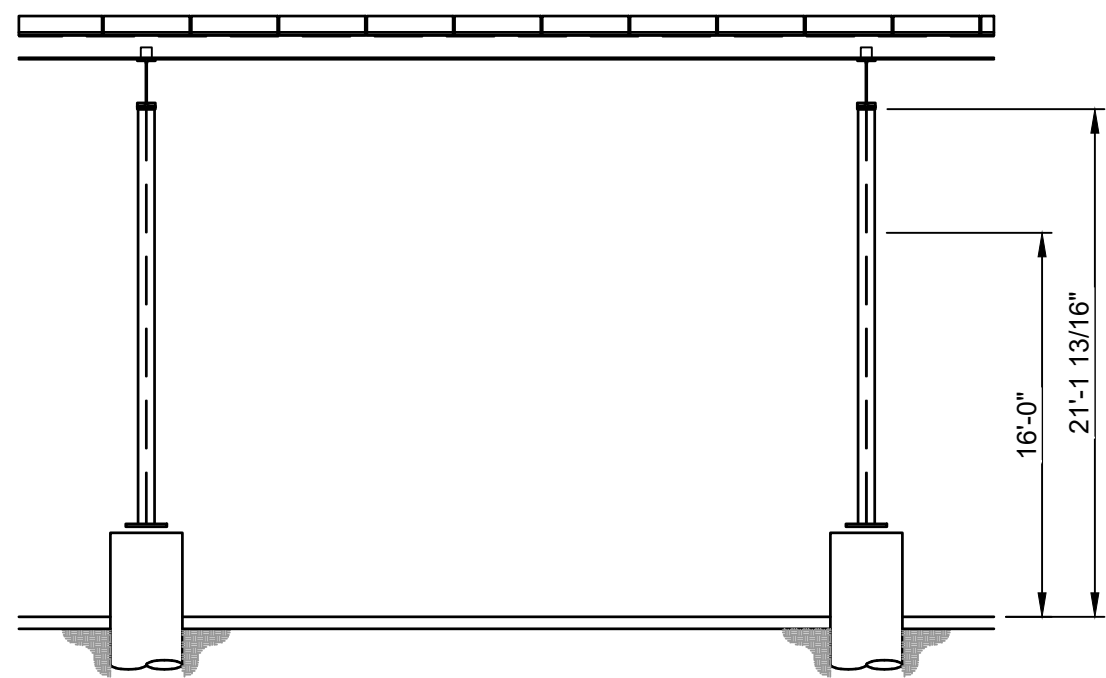SOLAR CANOPY FOR PARALLEL PRODUCTS


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PROJECT INFORMATION	
TITLE & ADDRESS: YETTE'S AUTO PARTS	
1260 SHAWMUT AVE NEW BEDFORD, MA 02746	
RBI SOLAR PROJECT No.: 2170063	
DRAWN BY: WCC	REVIEWED BY: _
SHEET TITLE: CANOPY SECTION	
SHEET No.: SC311	


TOP BEAM CONNECTION SCHEDULE									
COLUMN/PIER	CAP PLATE				STIFFENER PLATE SIZE	WELD SIZE			BOLT SIZE
	PLATE SIZE	X1	X2	Y1		W1	W2	W3	
A	1" x 9" x 28"	4 1/4"	16"	5 1/2"	3/8" x 3 1/2" x 20"	1/4"	CJP	5/16"	1"x3 1/4" A325
B	1" x 9 1/4" x 32"	5"	18 1/2"	5 1/2"	3/8" x 3 1/2" x 20"	1/4"	3/8"	5/16"	1"x3 1/4" A325
NOTE: DRAWING IS A TYPICAL DEPICTION AND MAY NOT REPRESENT ACTUAL DIMENSIONS OF PARTS.									

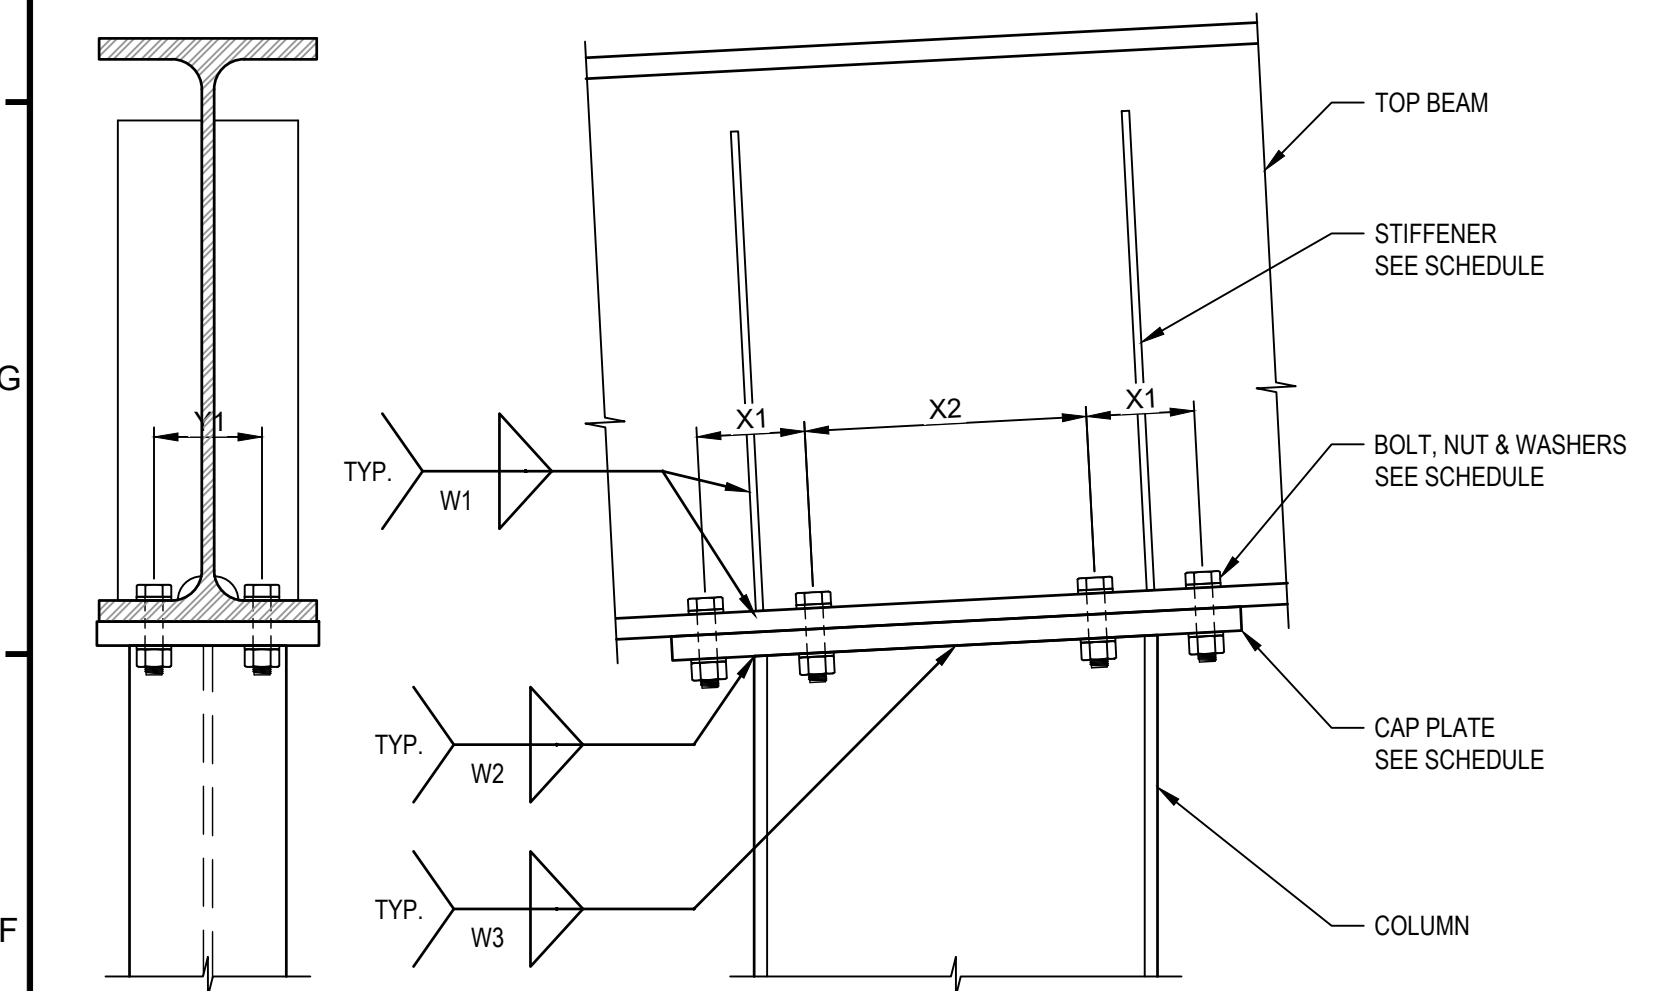



F1	Top Beam To Column Connection Detail
SCALE: 1-1/2" = 1'-0"	

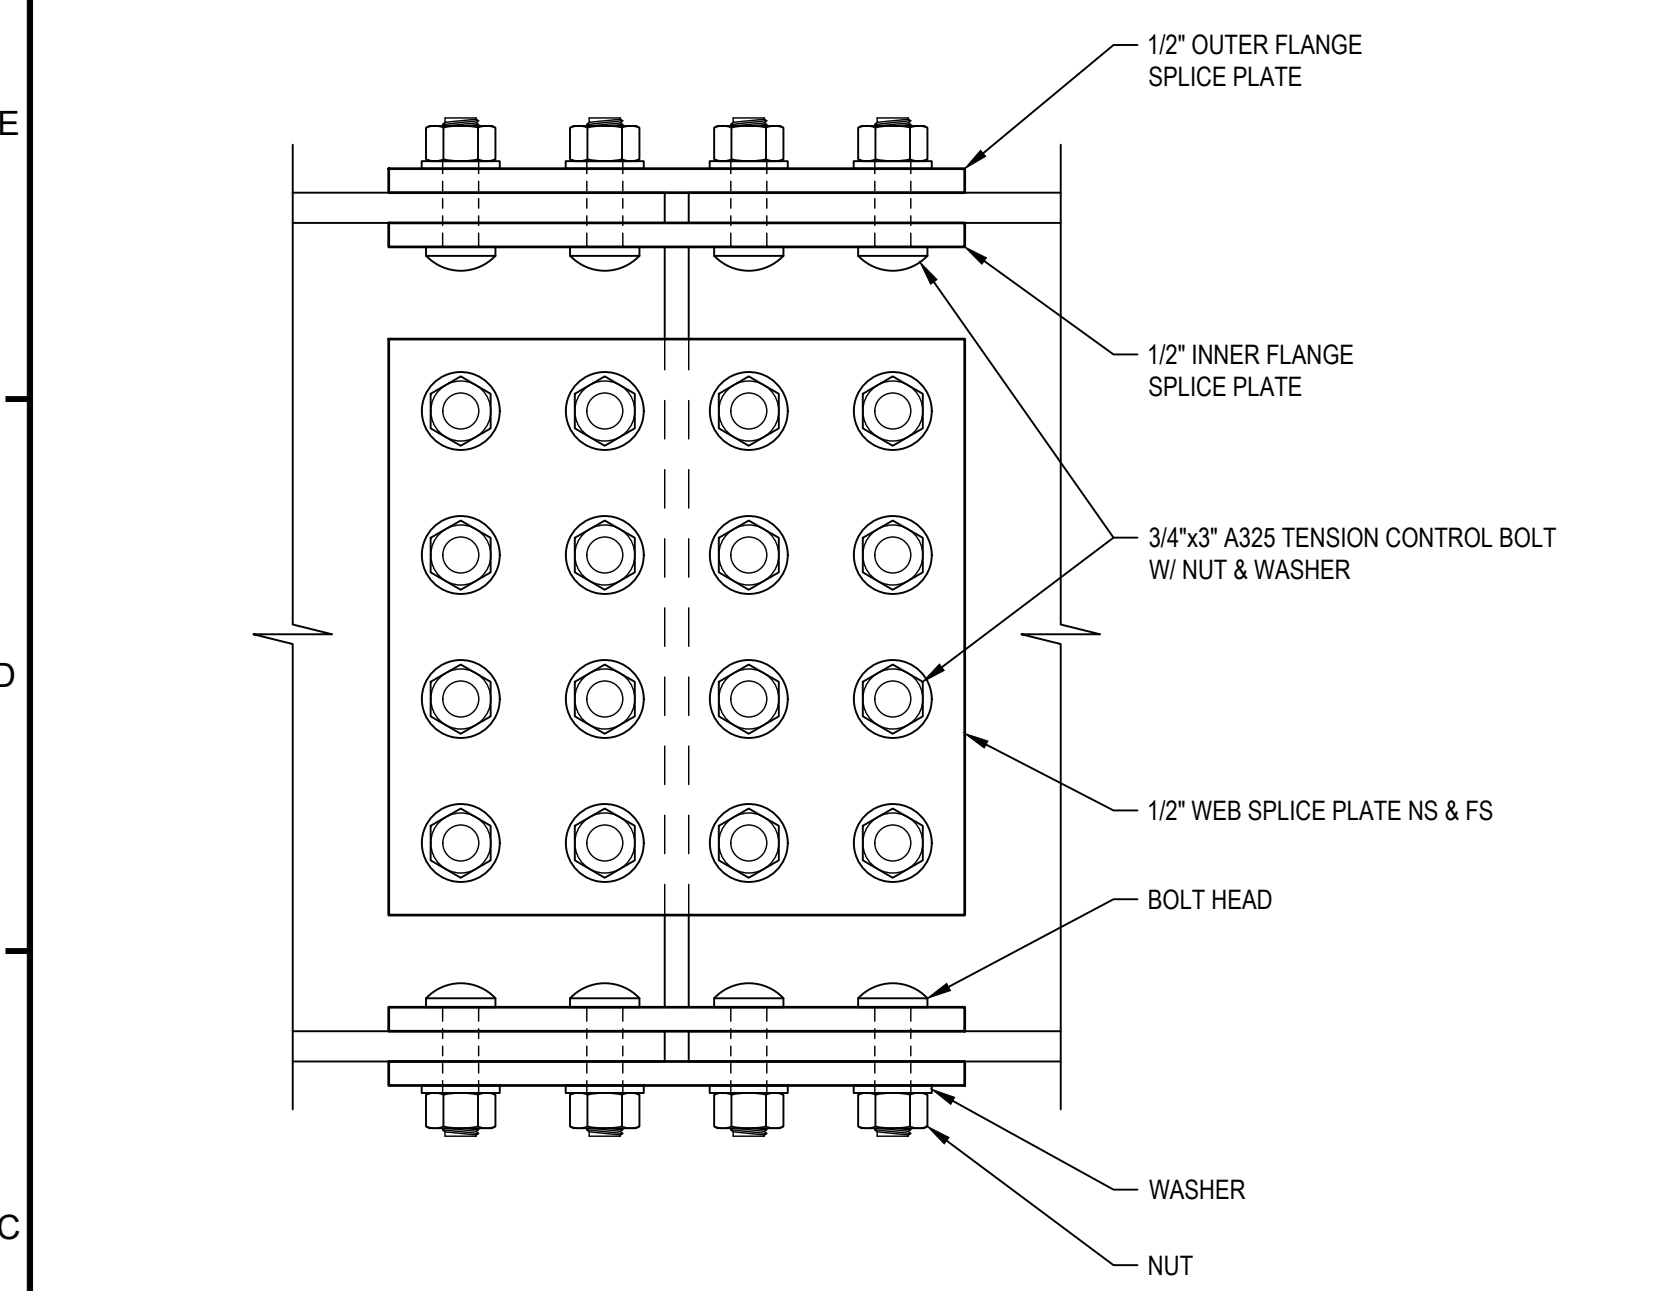



C1	Top Beam Splice Connection
SCALE: 3" = 1'-0"	

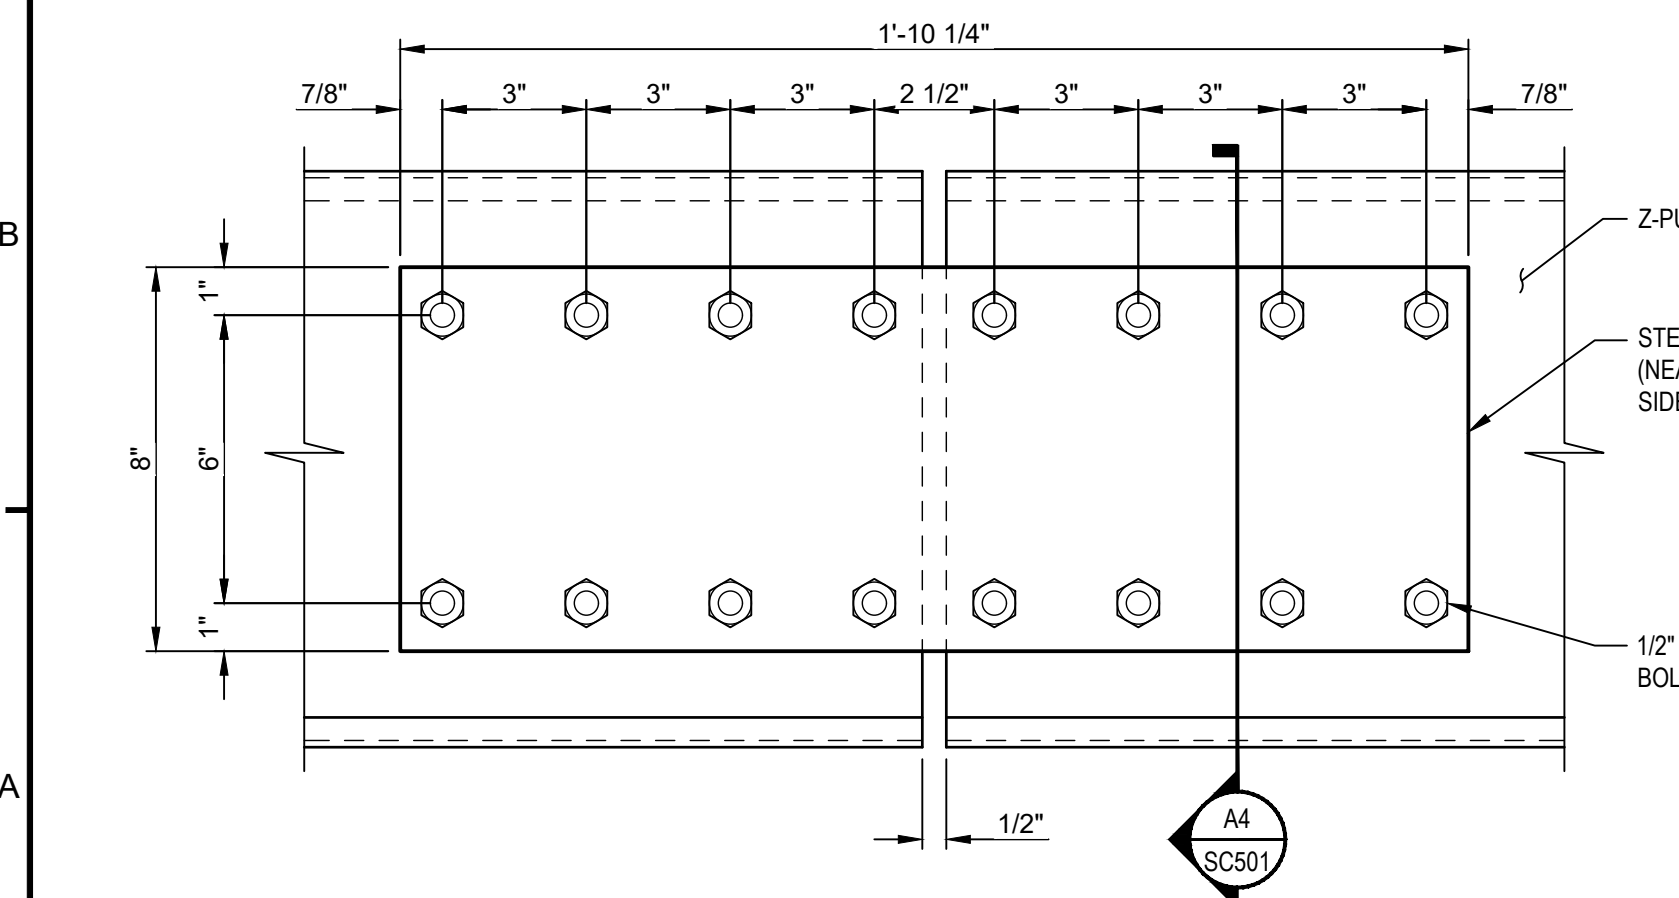


A1	Purlin Splice Connection
SCALE: 3" = 1'-0"	

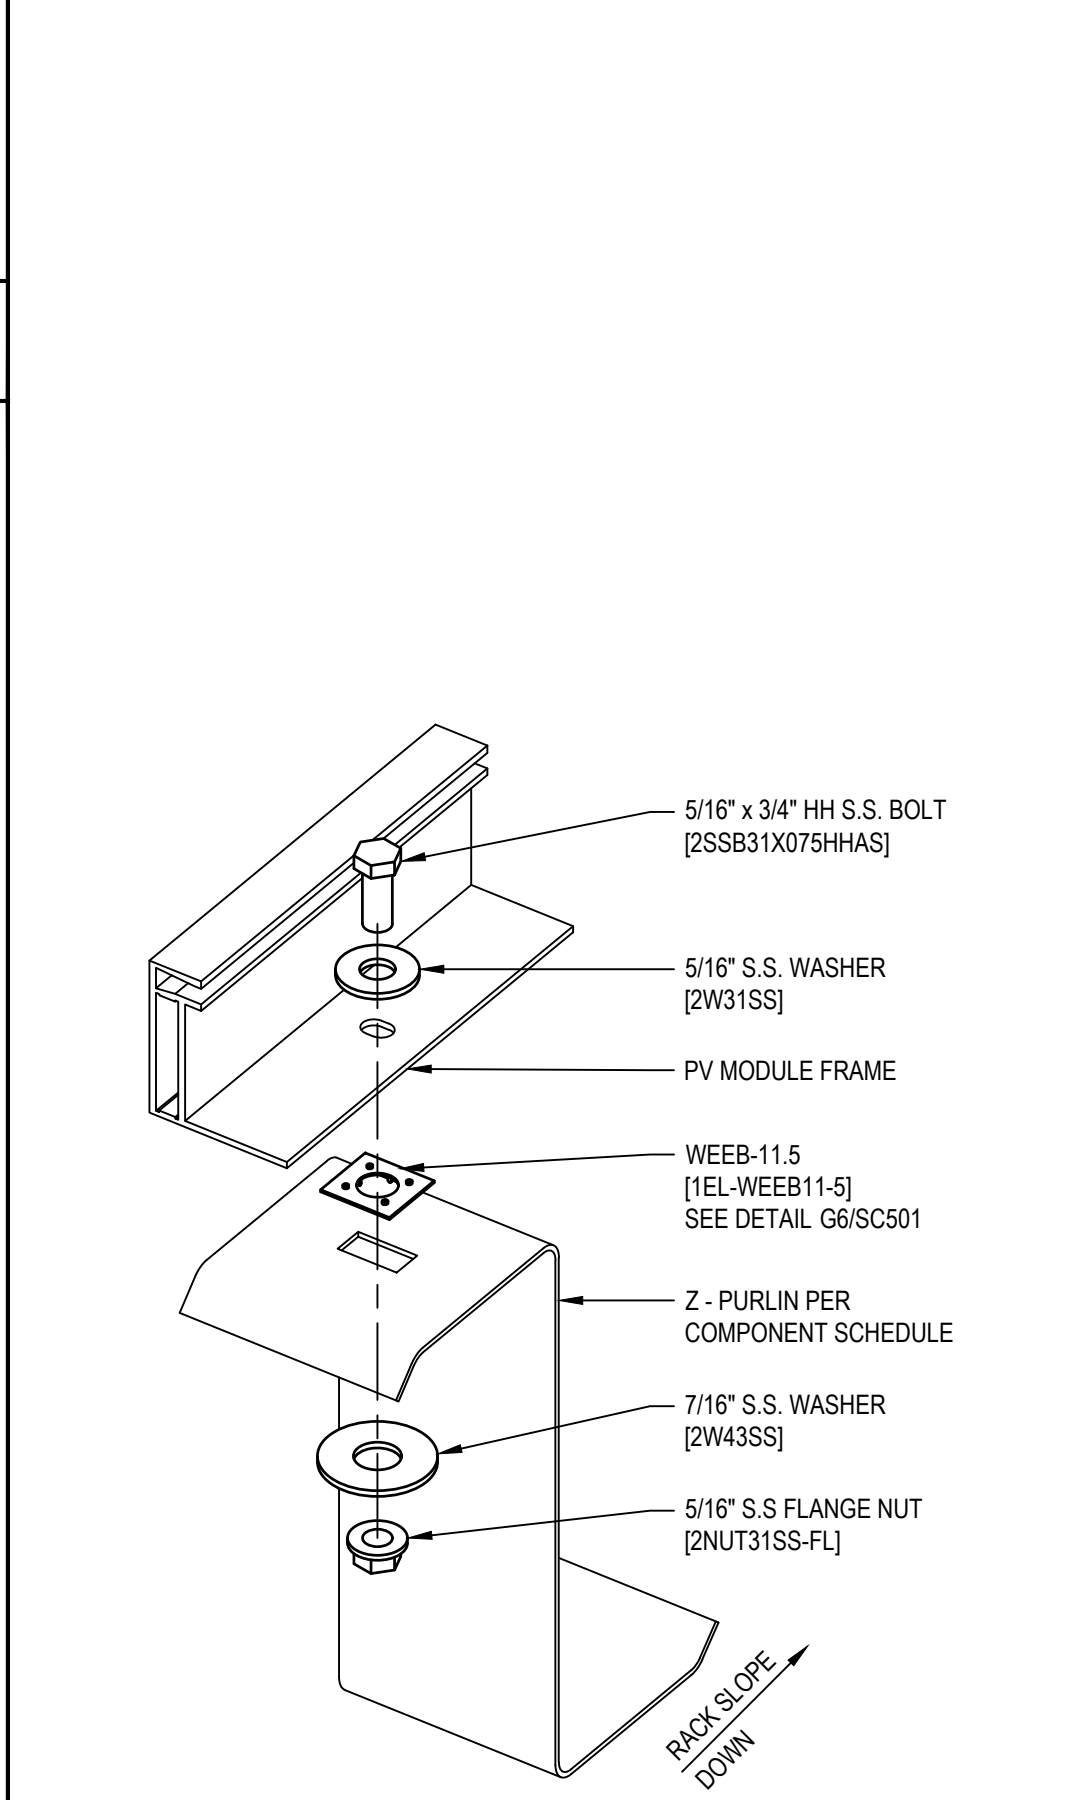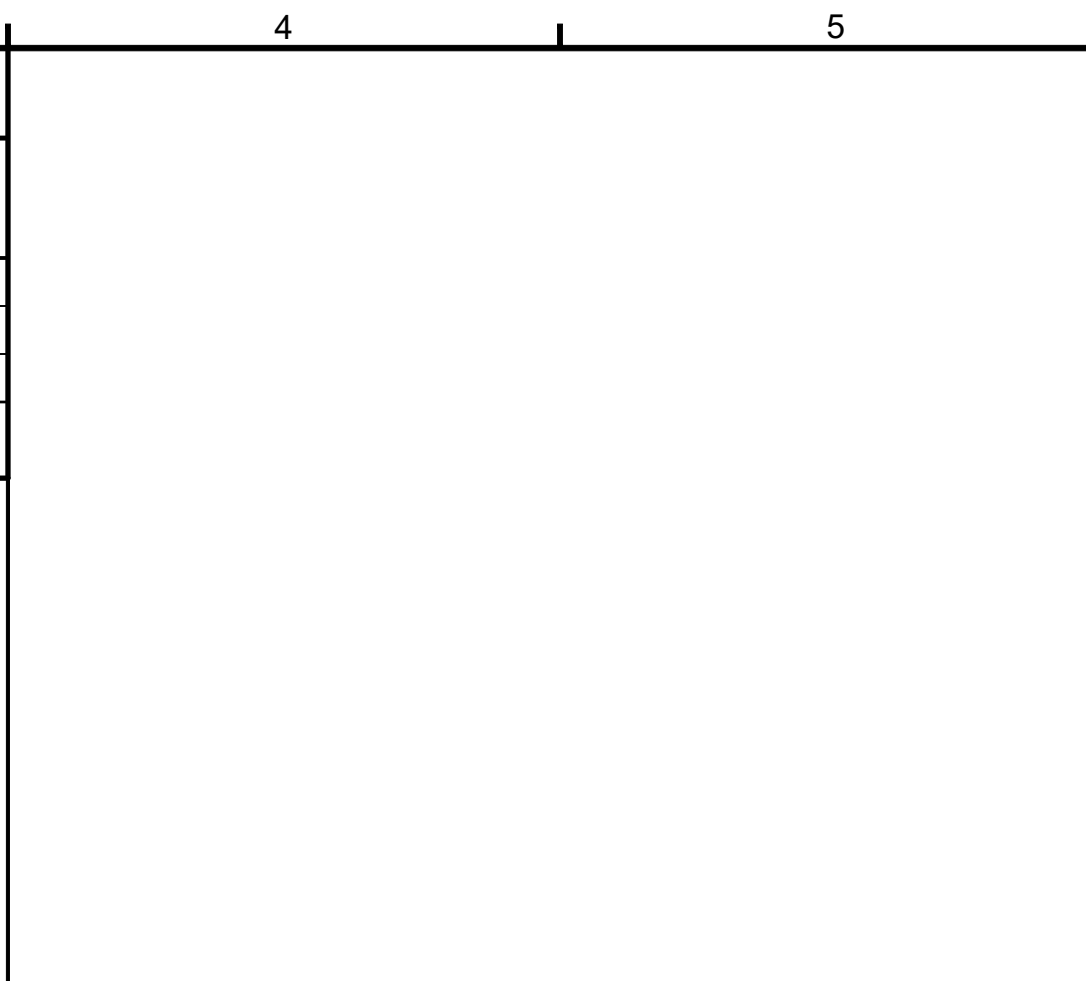


C4	Expanded PV Module Frame to Z-Purlin Connection Detail
SCALE: NONE	

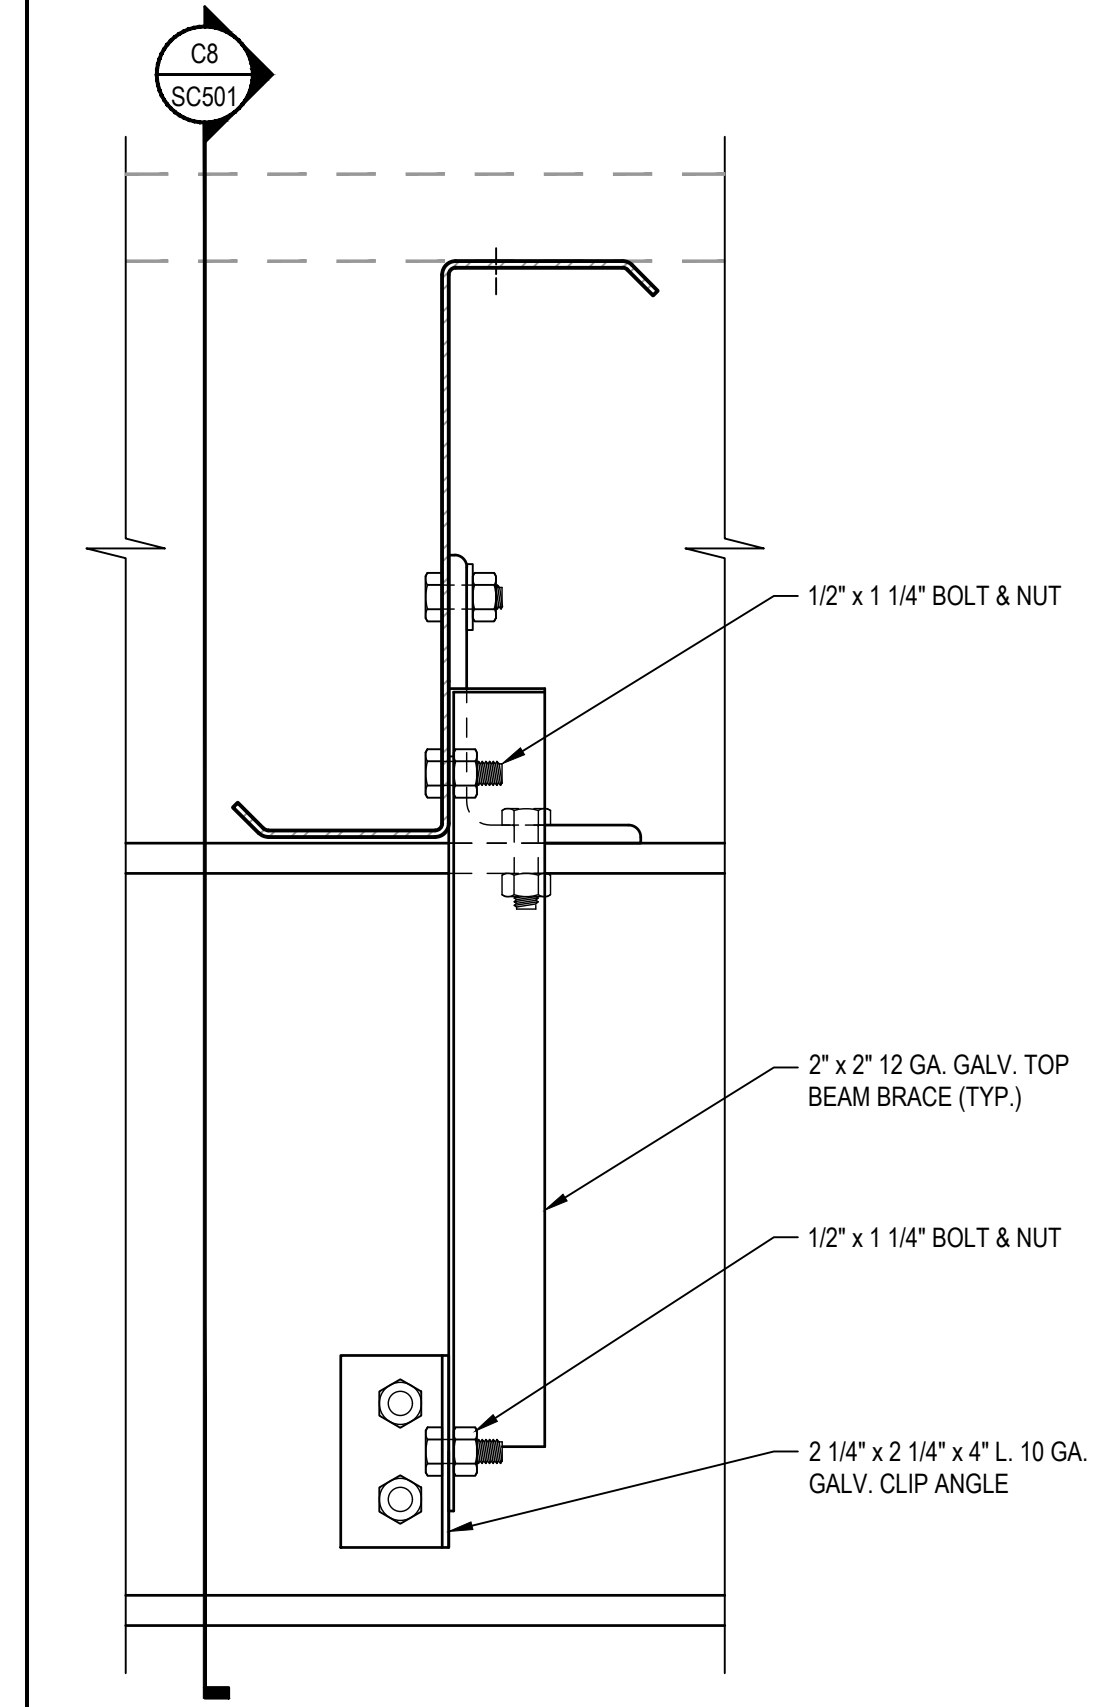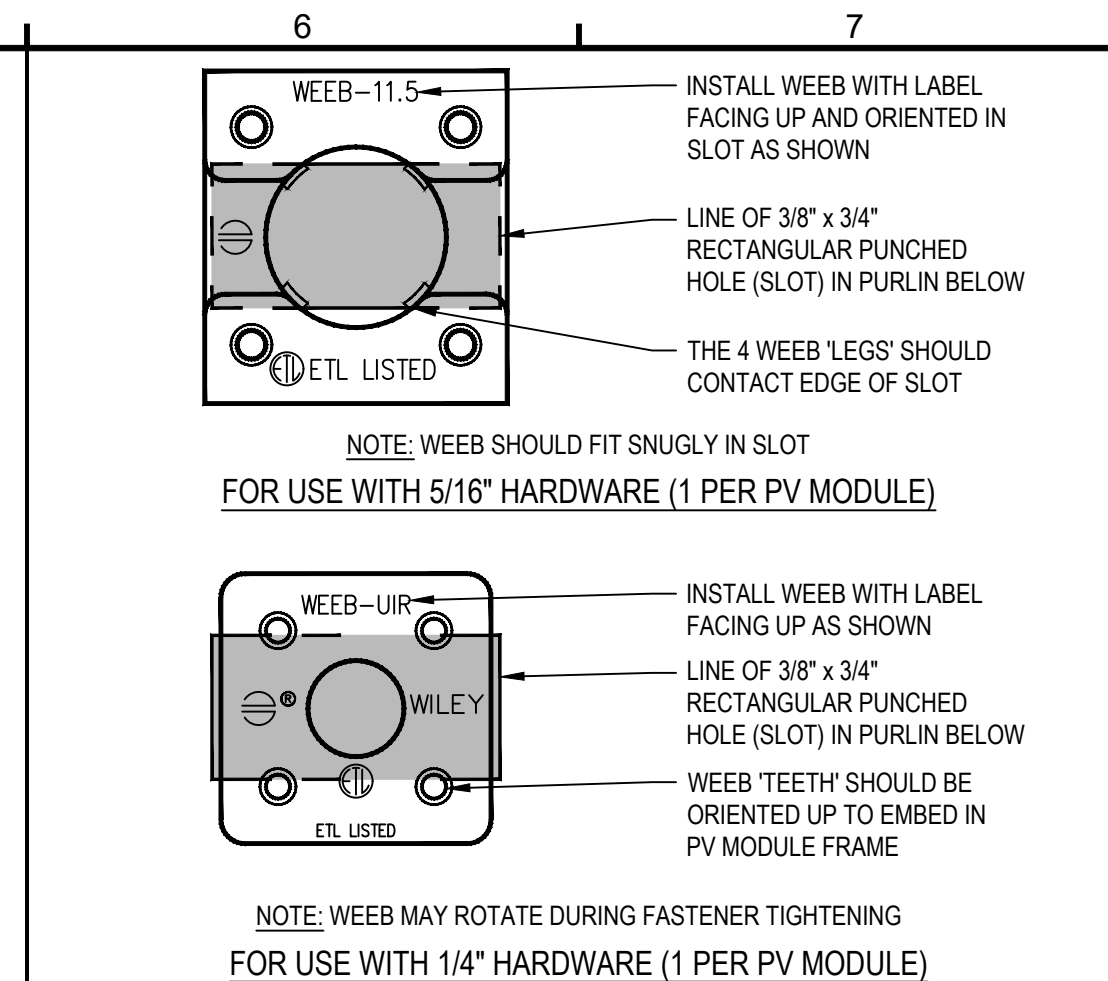

C6	Top Beam Flange Brace Connection Detail
SCALE: 3" = 1'-0"	

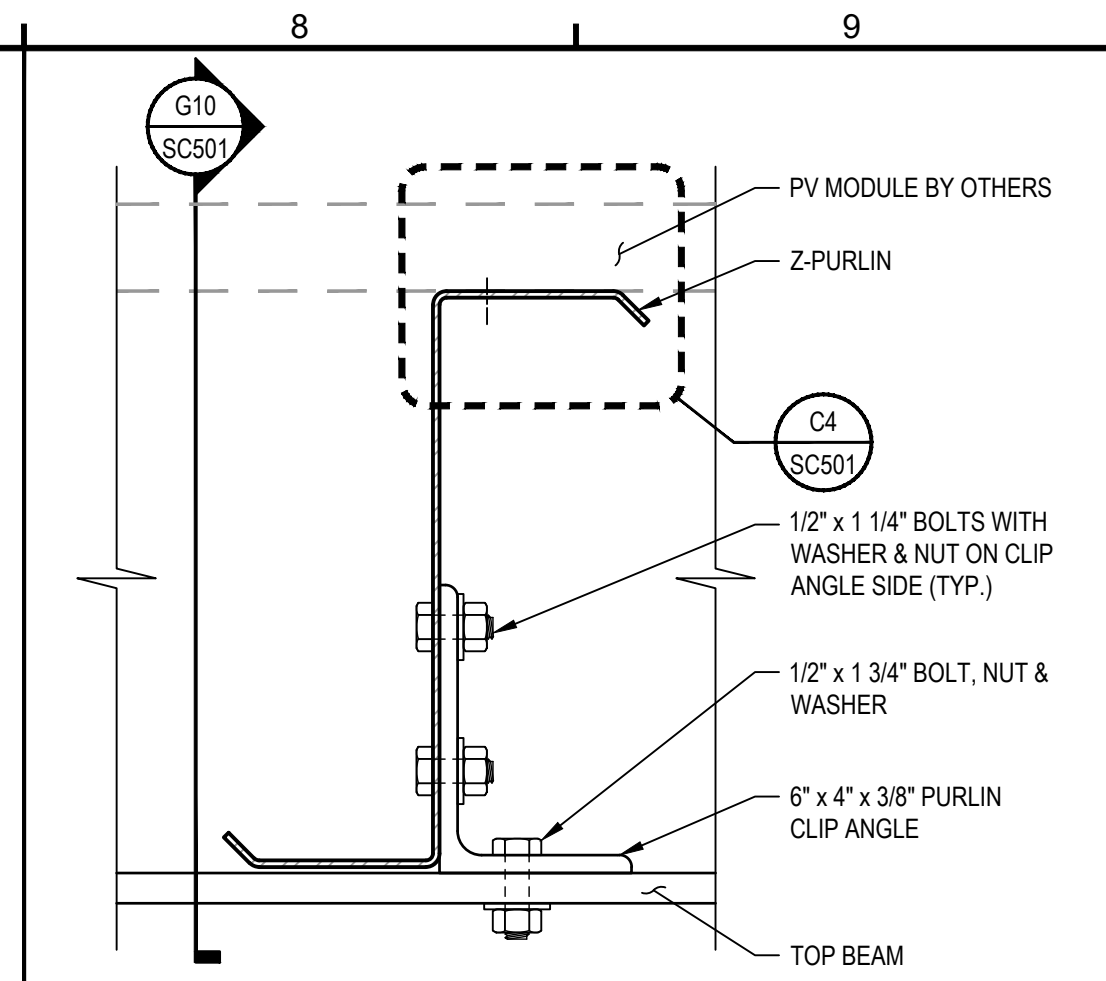


G8	Purlin Connection Transverse Detail
SCALE: 3" = 1'-0"	

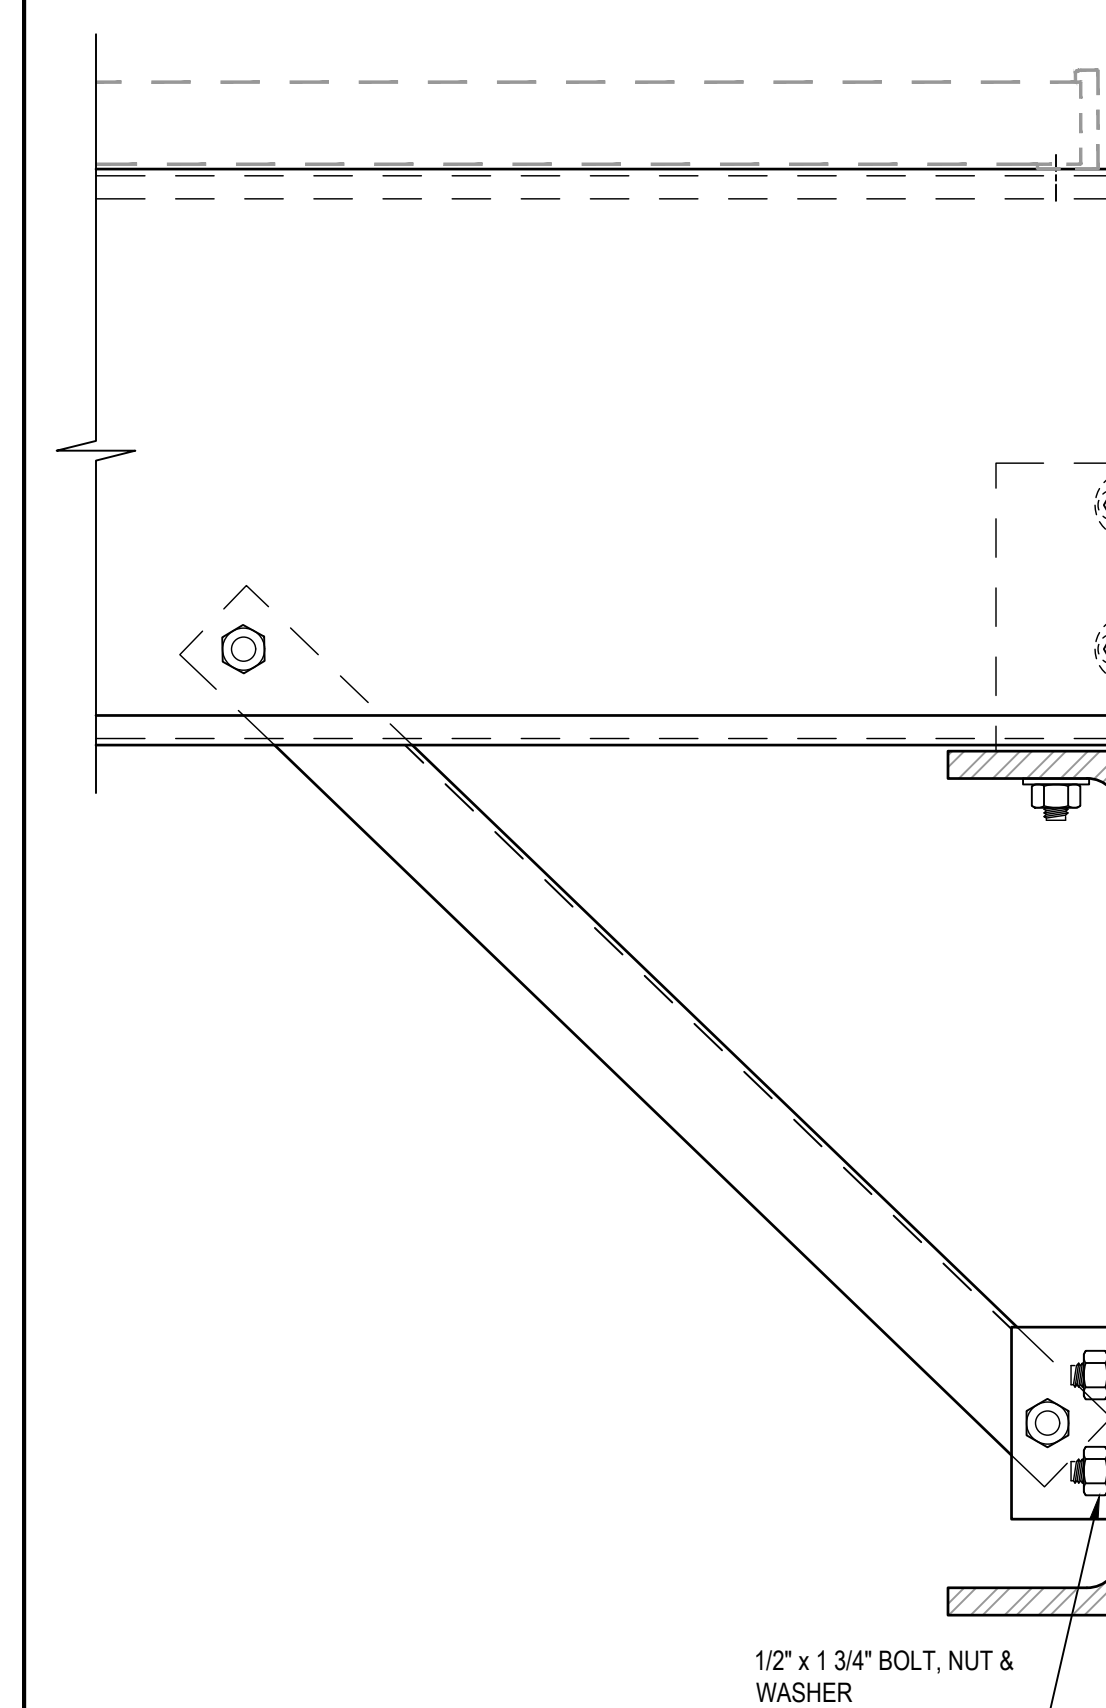


C8	Top Beam Flange Brace Connection Section
SCALE: 3" = 1'-0"	




A8	Purlin Bridging Splice Connection
SCALE: 3" = 1'-0"	

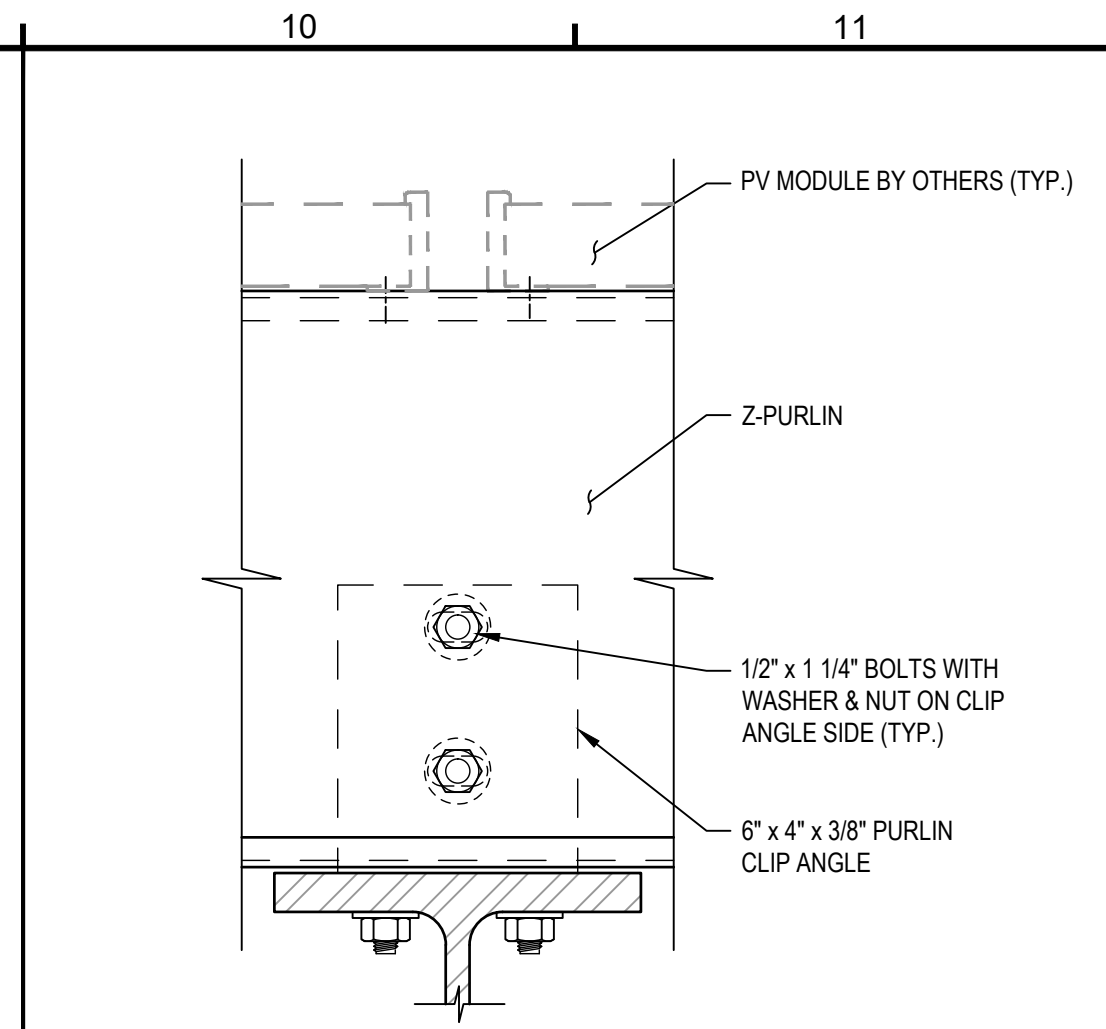


G10	Purlin Connection Longitudinal Section
SCALE: 3" = 1'-0"	

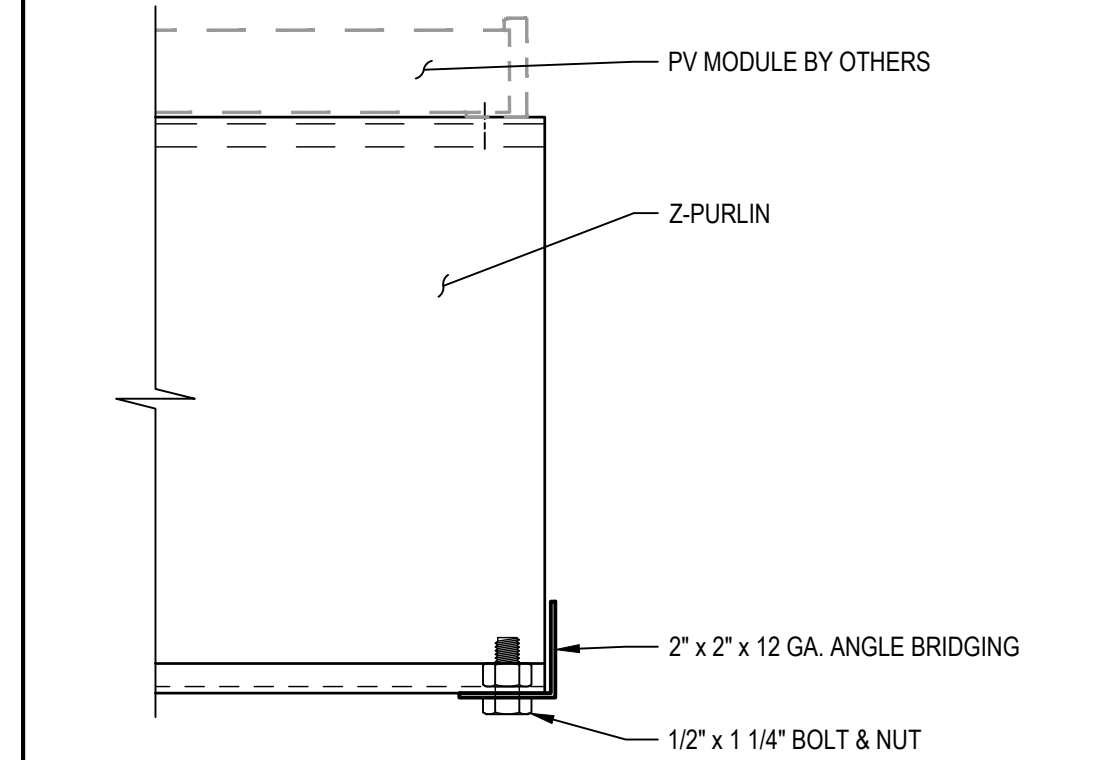

A10	Purlin Bridging End Condition
SCALE: 3" = 1'-0"	

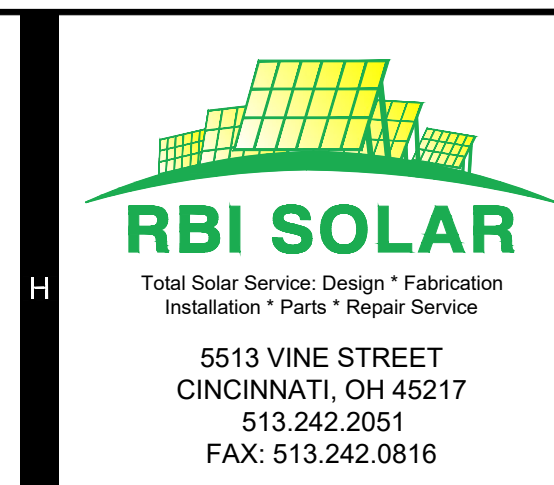

□ PROFESSIONAL SEAL

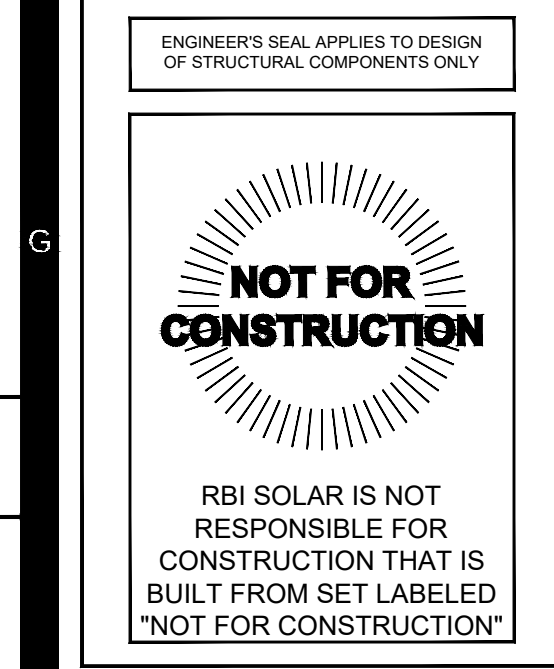

**SOLAR CANOPY
FOR
PARALLEL PRODUCTS**

□ RELEASE RECORD

[illegible]

PROJECT INFORMATION

B	TITLE & ADDRESS:
	GOYETTE'S AUTO PARTS

1200 SHAWMUT AVE
NEW BEDFORD, MA 02746

RBI SOLAR PROJECT No.:
2170063

DRAWN BY: WCC	REVIEWED BY: —
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SHEET TITLE:

SHEET No.: